



### DEMOLITION SITE PLAN

SCALE: 1/8" = 1'-0"

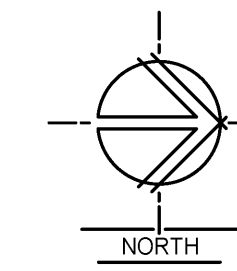


**KEYED NOTES:**

- 01 SAWCUT, REMOVE, & DISPOSE PORTION OF EXISTING SIDEWALK, CURB, & GUTTER.
- 02 EXISTING SIDEWALK, CURB, & GUTTER TO REMAIN.
- 03 SAWCUT, REMOVE, & DISPOSE PORTION OF EXISTING BUILDING APRON.
- 04 EXISTING BUILDING APRON TO REMAIN.
- 05 REMOVE & DISPOSE EXISTING HANDRAIL.
- 06 EXISTING STEPS TO REMAIN.
- 07 REMOVE EXISTING PAINTED ADA SYMBOL.
- 08 EXISTING PAINTED ADA SYMBOL TO REMAIN.
- 09 EXISTING PAINTED PARKING STRIPING TO REMAIN.
- 10 EXISTING TREE TO REMAIN.
- 11 EXISTING LIGHT POLE TO REMAIN.
- 12 EXISTING GAS METER TO REMAIN.
- 13 EXISTING LAWN TO REMAIN. REMOVE AS NECESSARY FOR NEW CONCRETE WORK.
- 14 EXISTING IRRIGATION VALVE BOXES TO REMAIN.

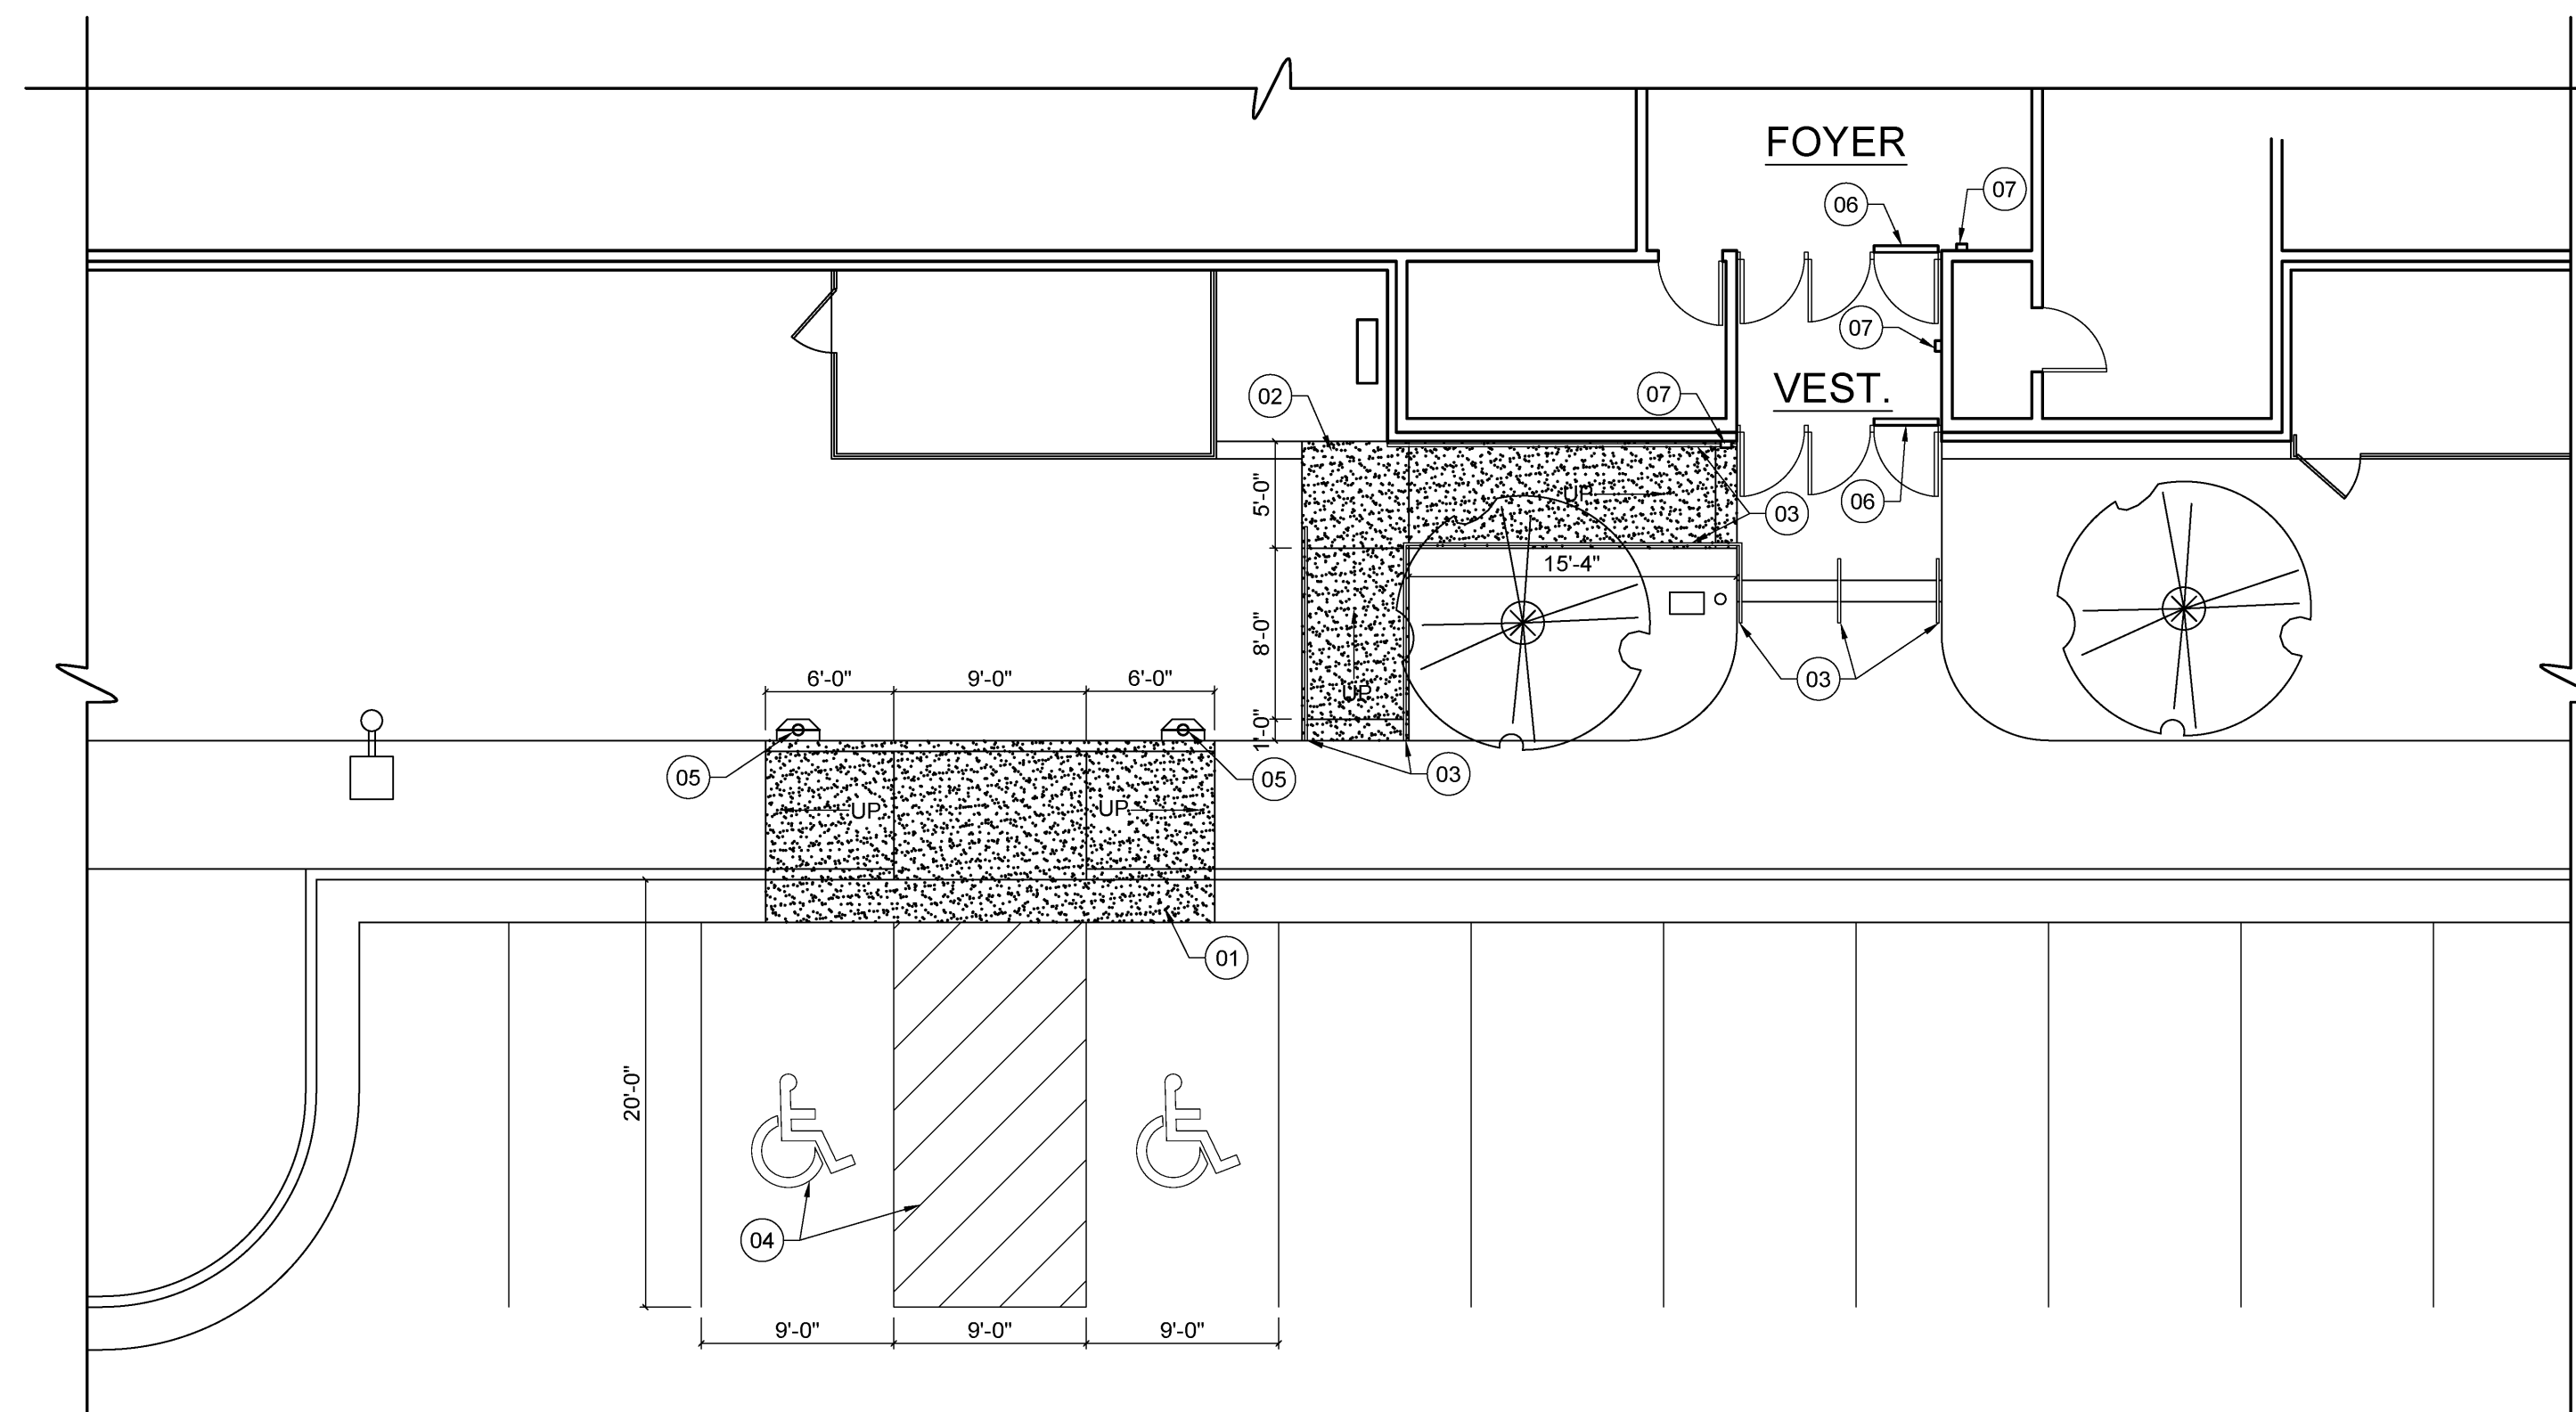

### REMODEL SITE PLAN & FLOOR PLAN

SCALE: 1/8" = 1'-0"

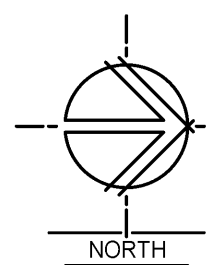


**KEYED NOTES:**

- 01 NEW CURB, GUTTER, & RAMP. SEE A, B & F/SD1.2.
- 02 NEW CONCRETE RAMP. SEE D/SD1.2. TOTAL RISE = 12" (APPROXIMATELY).
- 03 NEW STAINLESS STEEL HANDRAIL. SEE E & H/SD1.2.
- 04 NEW PAINTED PARKING STRIPING. MATCH EXISTING ADA SYMBOL. REPAINT EXISTING ADA SYMBOL.
- 05 NEW ADA PARKING SIGN. SEE G/SD1.2.
- 06 NEW AUTOMATIC DOOR OPENER. CONNECT TO AVAILABLE CIRCUIT IN PANEL "A" IN CHAPEL.
- 07 NEW SURFACE-MOUNT PUSH BUTTON FOR AUTOMATIC DOOR OPENER.

**GENERAL NOTES:**

1. REMOVE EXISTING DRYWALL AS NECESSARY TO ROUTE CONDUIT FOR AUTOMATIC DOOR OPENERS AND PUSH BUTTONS. PATCH, REPAIR, AND PAINT WALL SURFACE.
2. MODIFY EXISTING IRRIGATION SYSTEM AT NEW RAMPS AND SIGN POSTS. ADD SPRINKLER HEADS AND PIPING AS NECESSARY TO ENSURE FULL COVERAGE OF EXISTING LAWN.
3. PATCH & REPAIR LAWN WHERE DISTURBED FOR NEW WORK.
4. EXISTING LIGHT POLE ELECTRICAL CONDUIT MAY BE ENCOUNTERED WITHIN OR BEHIND SIDEWALK. PATCH & REPAIR IF CUT OR DAMAGED.

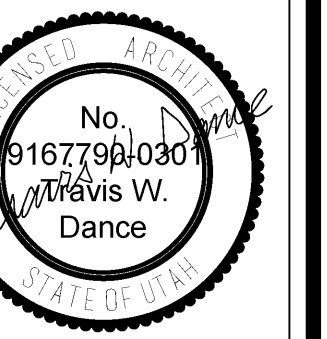


MARK	DATE (D/M/Y)	DESCRIPTION


PROJECT NUMBER: **17-04**  
 PLAN SERIES:  
 PROPERTY NUMBER: **532-6044**  
 DATE: **07/03/2018**

SHEET TITLE:  
**DEMOLITION AND  
 REMODEL SITE  
 PLANS**


SHEET:  
**SD1.1**

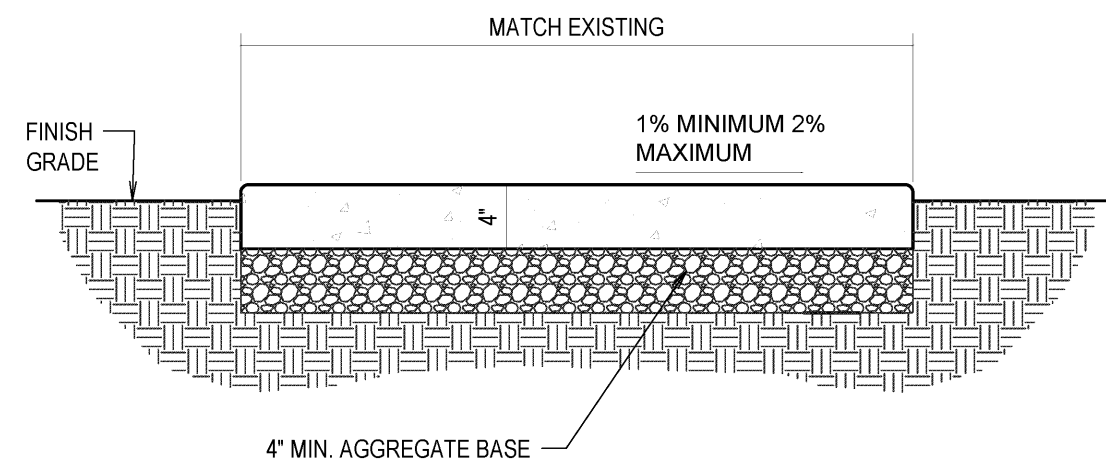


**A** SIDEWALK DETAIL  
SCALE: 1" = 1'-0"

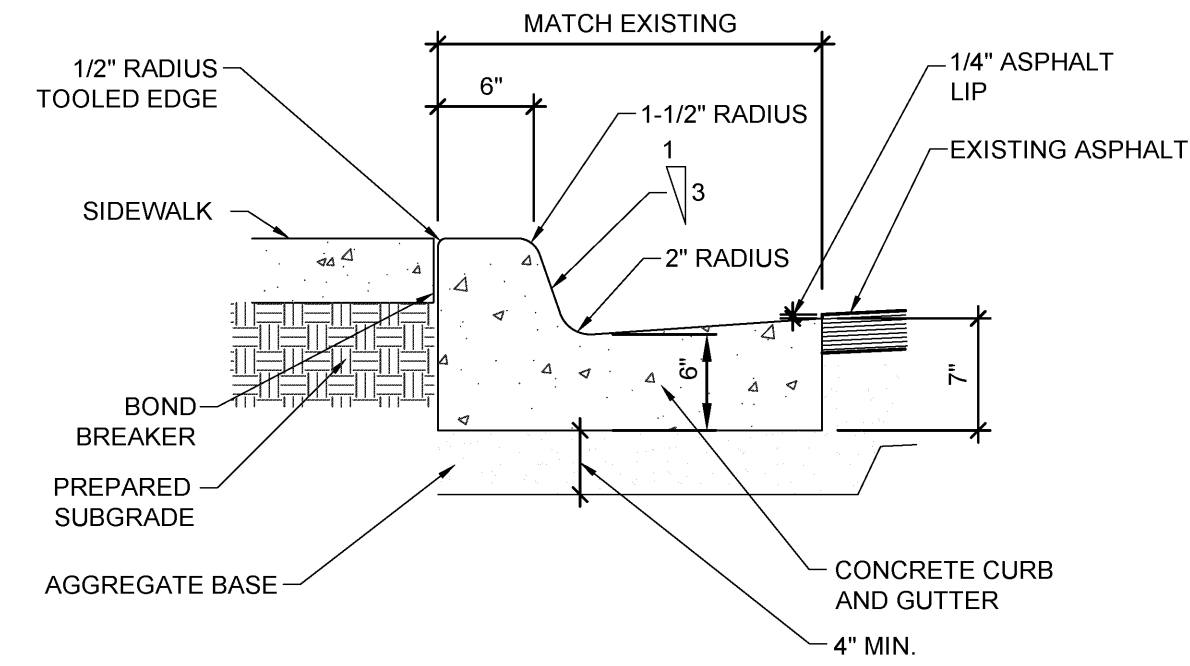


**B** OPEN FACE CURB & GUTTER - IN FLOW  
SCALE: 1" = 1'-0" ON SITE ONLY

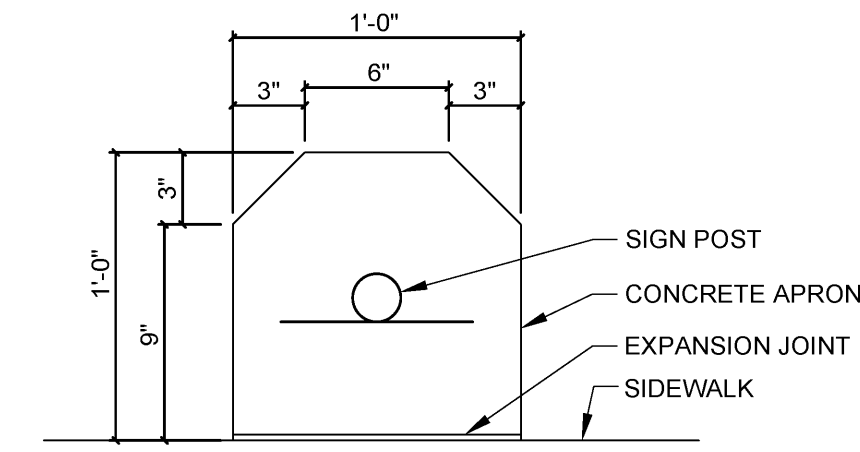


**C** APRON DETAIL  
SCALE: 1 1/2" = 1'-0"

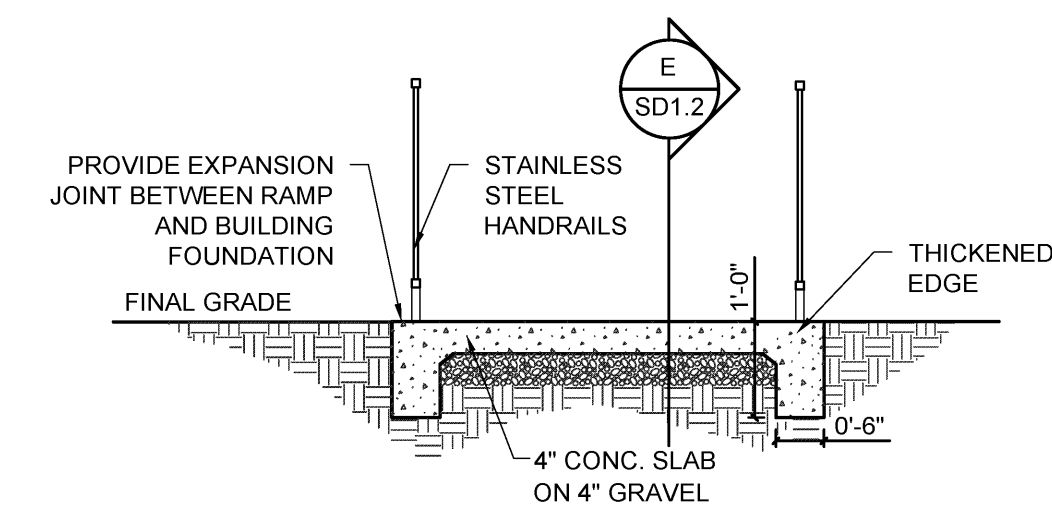

**D** RAMP SECTION  
SCALE: 1/2" = 1'-0"

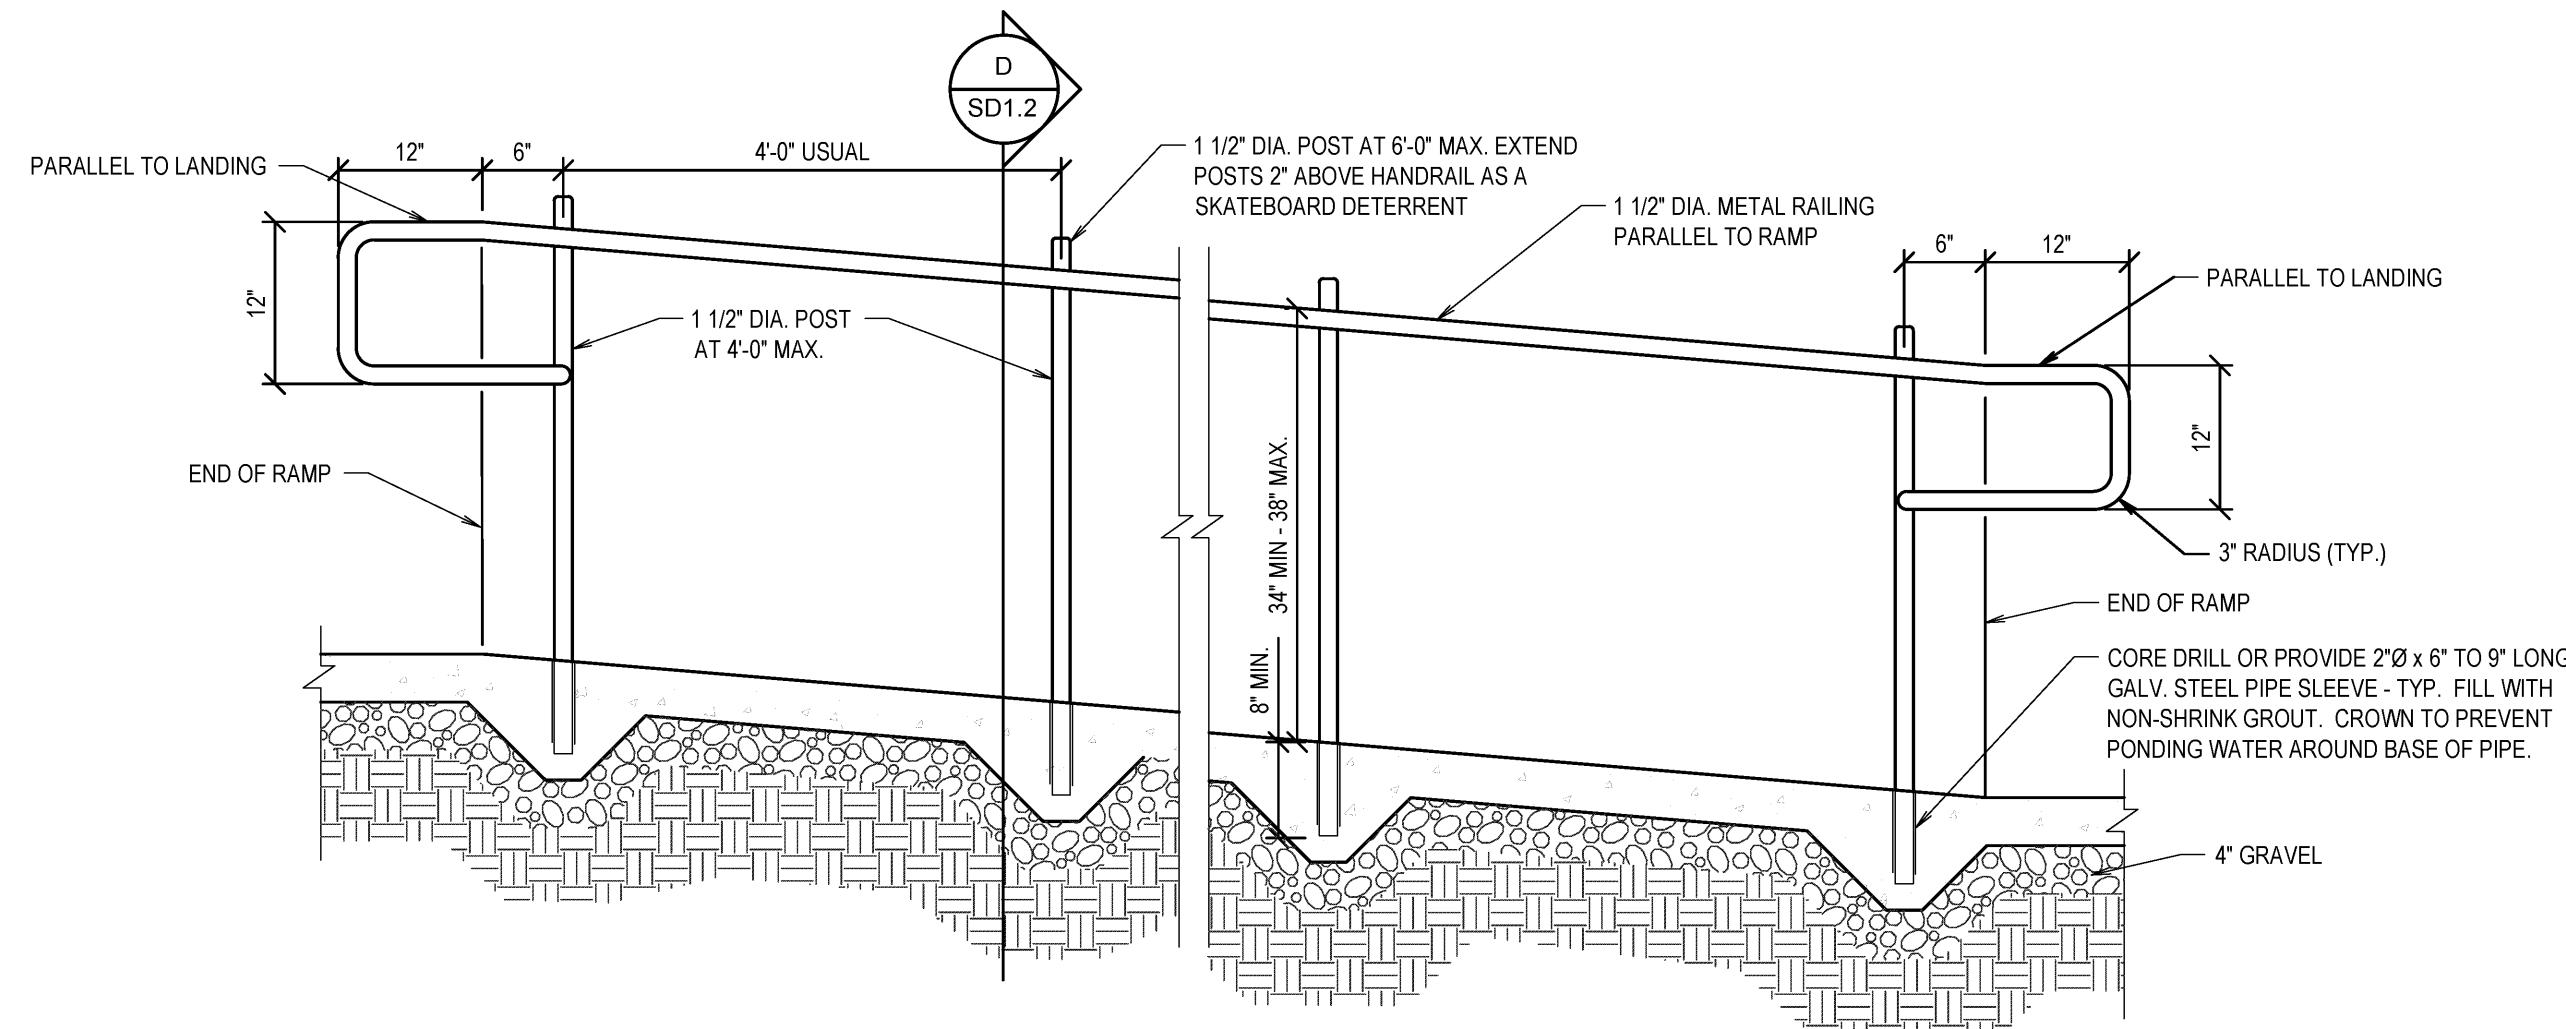

**E** RAMP SECTION  
SCALE: N.T.S.

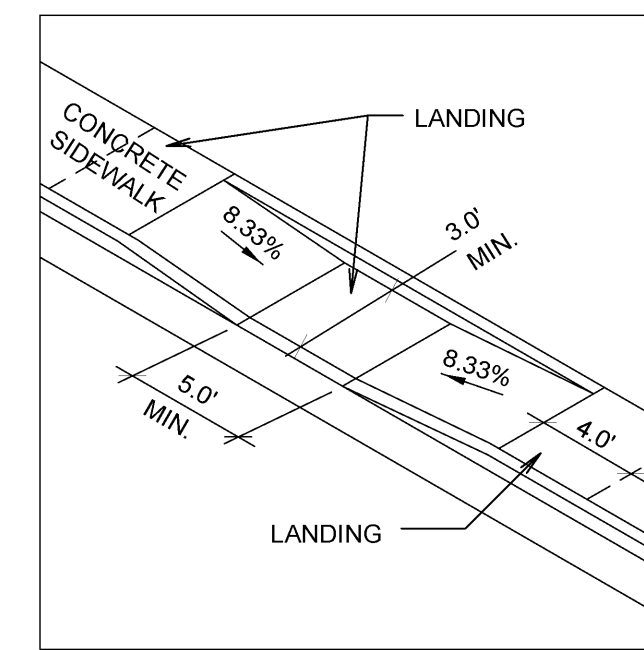


**F** CURB RAMP  
SCALE: N.T.S.

NOTES:


1. ALL LANDINGS MUST HAVE 1:48 CROSS SLOPE AND RUNNING SLOPE. LANDING MUST BE AS WIDE AS THE RAMP.
2. CROSS SLOPE ON RAMP MUST BE 1:48 OR LESS.
3. COUNTER SLOPES OF ADJOINING GUTTERS AND PAVING ADJACENT TO THE CURB RAMP SHALL NOT BE STEEPER THAN 1:20.

GENERAL NOTES

1. SEE SITE PLAN FOR APRON, AND SIDEWALK LOCATIONS AND WIDTHS.
2. CONTRACTOR TO INSTALL EXPANSION AND CONTRACTION JOINTS AS REQUIRED PER THE SPECIFICATIONS.
3. ALL AGGREGATES SHALL SATISFY ASTM AND DEPARTMENT OF TRANSPORTATION STRENGTH AND DURABILITY REQUIREMENTS. GRANITE AGGREGATES ARE PREFERRED BUT HIGH QUALITY LIMESTONE AGGREGATES ARE ACCEPTABLE. SEE SPECIFICATIONS.

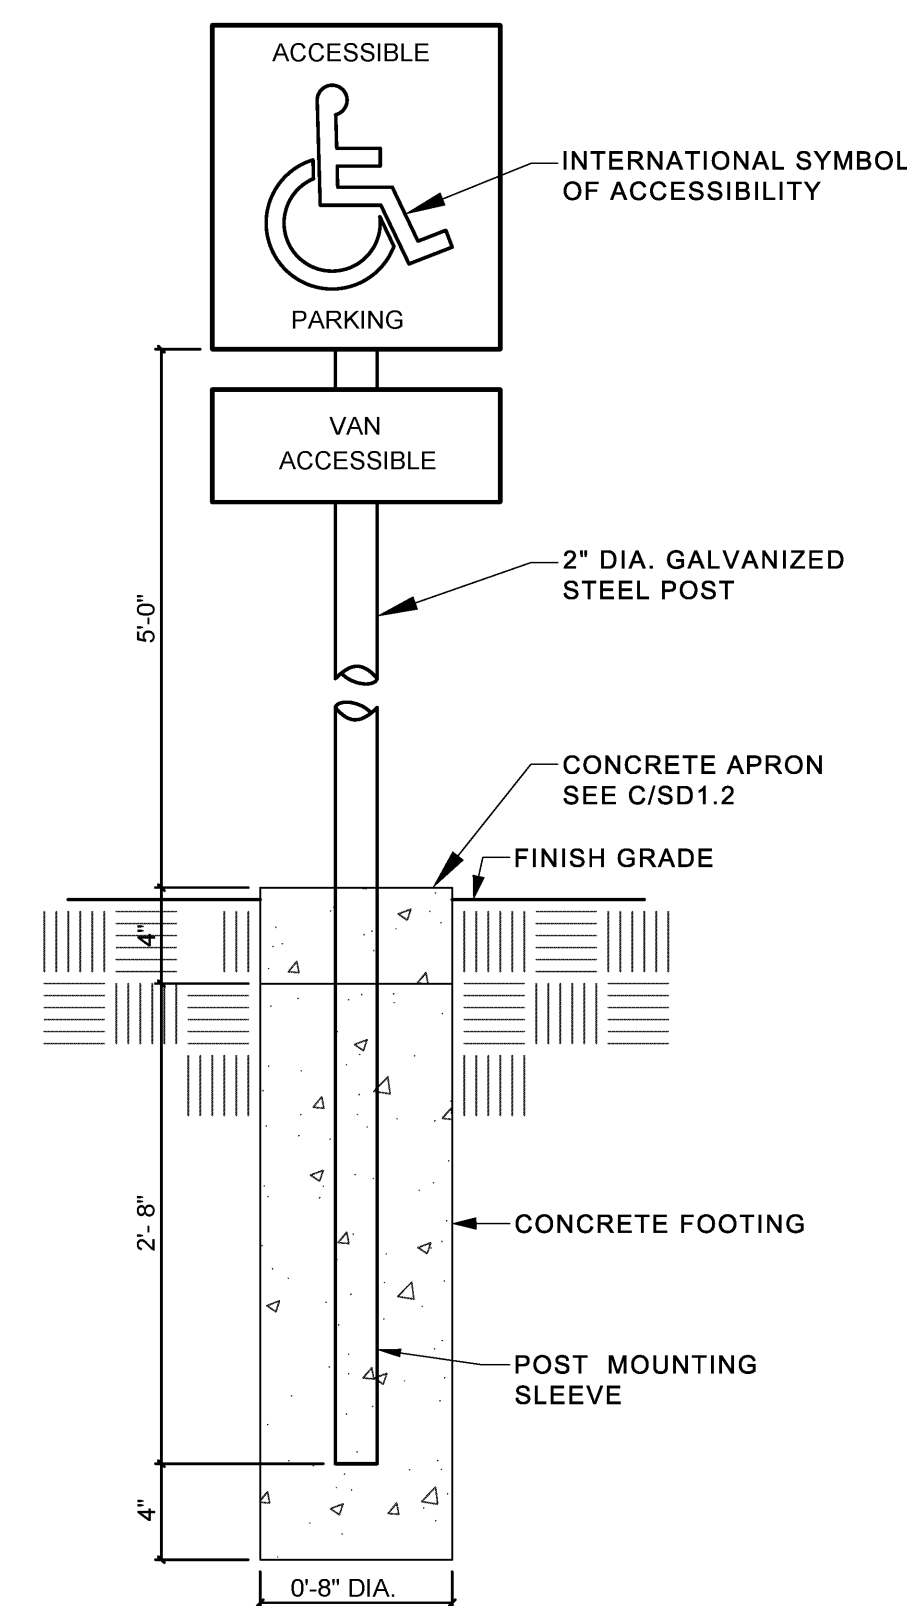

**G** ACCESSIBLE PARKING SIGN  
SCALE: N.T.S.

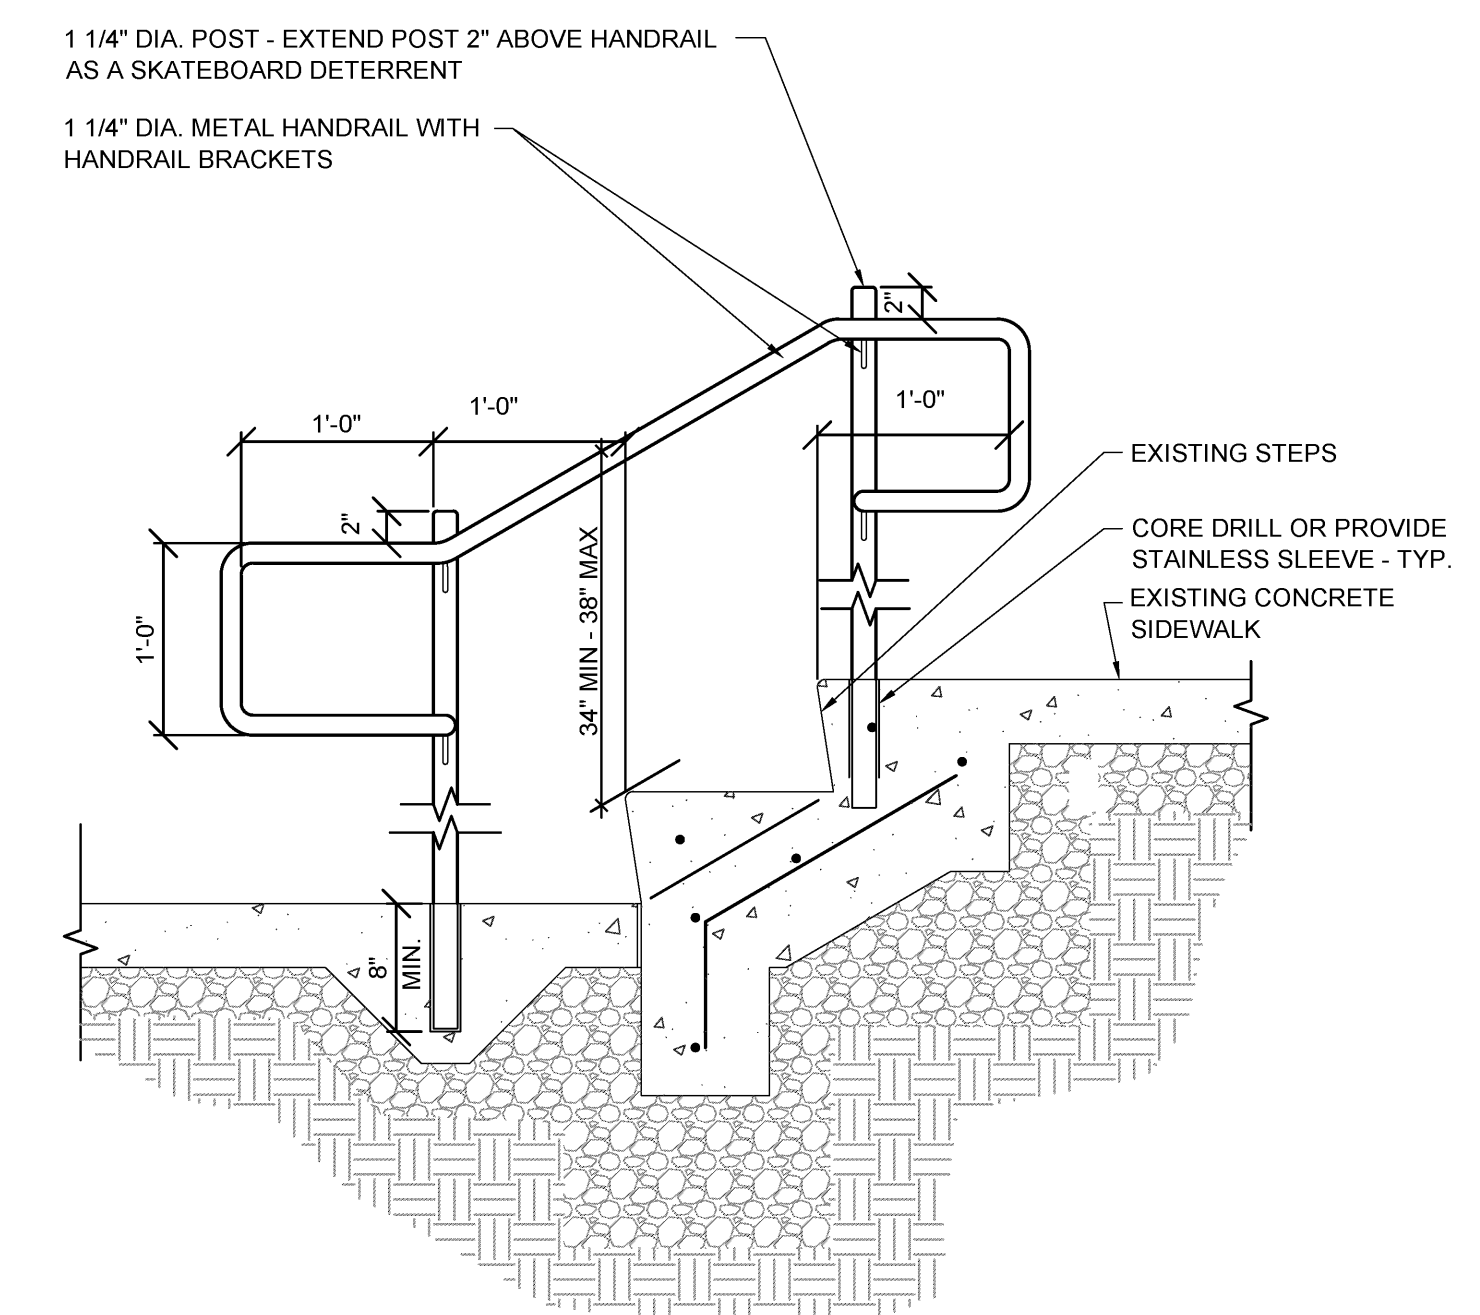

**H** SITE HANDRAIL DETAIL  
SCALE: 1" = 1'-0"

MARK	DATE (D.M.Y.)	DESCRIPTION

PROJECT NUMBER:  
17-04  
PLAN SERIES:  
PROPERTY NUMBER:  
532-6044  
DATE:  
07/03/2018

SHEET TITLE:  
DETAILS

SHEET:  
SD1.2