


# TAYLORSVILLE 12,25 TAYLORSVILLE UT SOUTH STAKE

SITE: 4505 SOUTH BRIANS WAY, TAYLORSVILLE, UTAH THE CHURCH OF JESUS CHRIST OF LATTER-DAY SAINTS PROJECT NUMBER: 5141710-19020101

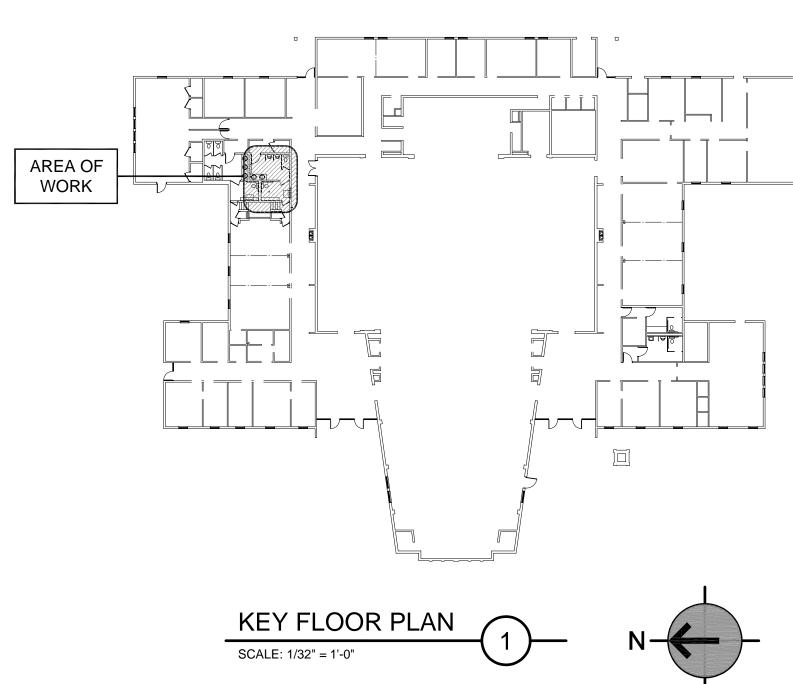

#### EXISTING AREAS: CONTRACTOR SHALL VERIFY LOCATION OF ALL EXISTING PIPING, WIRING, DUCT WORK AND OTHER EXISTING WORK IN EXISTING FRAMING AND ATTIC SPACES AND COORDINATE WITH NEW WORK. FILL HOLES AND PATCH CEILING WHERE EXISTING LIGHT FIXTURES, GRILLES, DIFFUSERS, FURRING OR OTHER WORK IS REMOVED OR WHERE NEW WORK DOES NOT COVER EXISTING OPENINGS COMPLETELY REMOVE AND REINSTALL EXISTING LIGHT FIXTURES, GRILLES, DIFFUSERS, SPEAKERS AND OTHER EXISTING WORK AS REQUIRED TO ACCOMMODATE PAINTING OF CEILING TILE AND OTHER NEW WORK.


#### **KEYED CEILING DEMOLITION NOTES**

**GENERAL CEILING NOTES** 

- EXISTING GYPSUM BOARD CEILING TO REMAIN. REMOVE PORTIONS AS REQUIRED TO ACCOMMODATE THIS NEW WORK.
- REMOVE AND SALVAGE EXISTING LIGHT FIXTURE AND CEILING SENSOR.

#### **CEILING KEYED NOTES**

- 1 EXISTING GYPSUM BOARD CEILING TO REMAIN. PATCH AND TEXTURE TO MATCH AS REQUIRED WHERE DISTURBED FOR THIS NEW WORK. PAINT CEILING ENTIRE ROOM. REINSTALL OR REPLACE DISTURBED EXISTING ATTIC INSULATION
- /2\ NEW EXHAUST FAN GRILLE. SEE MECHANICAL DRAWINGS.
- 73\ REINSTALL EXISTING SALVAGED LIGHT FIXTURE AND CEILING SENSOR. SEE ELECTRICAL DRAWINGS.

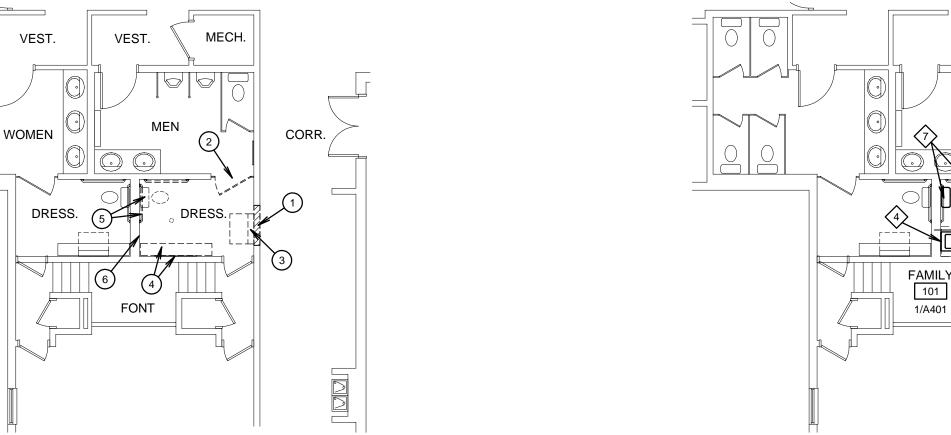


#### NORTHEAST RESTROOMS **DEMOLITION FLOOR PLAN**


SCALE: 1/8" = 1'-0"

## **KEYED DEMOLITION PLAN NOTES**

## REMOVE EXISTING WALL OR PORTION OF WALL WHERE SHOWN REMOVE EXISTING TOILET PARTITION AND SALVAGE TO OWNER. 3) REMOVE AND SALVAGE EXISTING BABY CHANGING STATION. 4) REMOVE AND SALVAGE EXISTING BENCH AND BRACKETS. EXISTING HOOK STRIP TO REMAIN. 5) REMOVE AND SALVAGE EXISTING WATER CLOSET AND GRAB 6) REMOVE PORTION OF EXISTING WALL TILE AND GYPSUM BOARD. SEE SHEET A401.

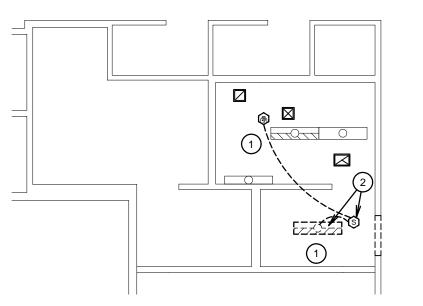


NORTHEAST RESTROOMS DEMOLITION REFLECTED CEILING PLAN SCALE: 1/8" = 1'-0"

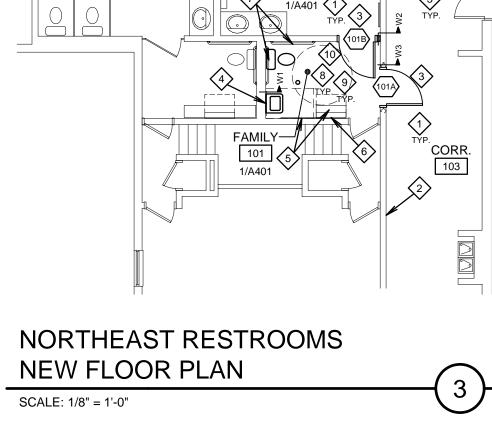

#### **KEYED FLOOR PLAN NOTES**

- PATCH EXISTING WALLS, FLOORS AND CEILINGS TO MATCH WHERE DISTURBED BY NEW WORK.
- CLEAN AND PATCH EXISTING CMU WALLS AND PAINT WALL FROM CORNER TO DOOR FRAME.
- NEW DOOR, FRAME AND HARDWARE. SEE SHEET A601.
- NEW PATCH EXISTING WALL TILE AND GYPSUM BOARD TO MATCH. SEE SHEET A401.
- SHORTEN EXISTING BENCH TO 2'-6" LONG AND REINSTALL WITH SALVAGED EXISTING BRACKETS. EXISTING HOOK STRIP TO REMAIN. SEE SHEET A401.
- REINSTALL EXISTING SALVAGED BABY CHANGING STATION IN NEW
- REINSTALL EXISTING SALVAGED GRAB BARS AND NEW VERTICAL GRAB BAR. SEE SHEET A401.
- (8) PLUMBING: REINSTALL EXISTING WATER CLOSET IN EXISTING LOCATION. PROTECT EXISTING FLOOR DRAIN TO REMAIN. INSTALL NEW WALL-MOUNTED LAVATORY WITH WALL CARRIERS. SEE SHEET P101.
- PROTECT EXISTING WALL AND FLOOR TILE AND BASE TO REMAIN. REMOVE EXISTING AND RECAULK ALL TILE JOINTS, WALL CORNERS AND WALL/CEILING CORNERS ENTIRE ROOM.
- CURB AND FLASHINGS ON ROOF FOR EXHAUST FAN OUTLET. SEE DETAILS D,E,F ON SHEET M101.

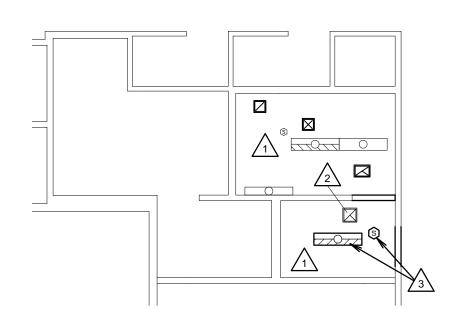

NORTHEAST RESTROOMS NEW REFLECTED CEILING PLAN SCALE: 1/8" = 1'-0"

## DRAWING INDEX COVER SHEET, FLOOR PLANS, REFLECTED CEILING **ENLARGED RESTROOMS** FINISH & DOOR SCHEDULES AND DETAILS PLUMBING PLANS

**MECHANICAL** 

**ELECTRICAL** 

**ELECTRICAL PLANS** 

## **GENERAL DEMOLITION NOTES**

MECHANICAL PLANS AND ROOFING DETAILS

#### **GENERAL NOTES**

- PATCH ALL WALLS, FLOORS AND CEILINGS TO MATCH WHERE DISTURBED BY DEMOLITION OR NEW WORK.

#### **INTERIOR - PATCHING/FINISHES:**

PATCH AND REPAIR ALL EXISTING WORK DISTURBED BY THIS NEW WORK. WALLS, CEILINGS, FLOORS, TRIM AND OTHER WORK SHALL BE FINISHED TO MATCH EXISTING FINISHES FOR SPACE WHERE EXISTING WORK IS TO BE REPLACED AND FURRED OUT. REMOVE AND REINSTALL/EXTEND EXISTING FIXTURES, DEVICES, CONVECTORS, GRILLES, LOUVERS, EQUIPMENT AND OTHER EXISTING WORK TO NEW LOCATION TO ACCOMMODATE NEW WORK.

#### **INSULATION:**

INSTALL EQUIVALENT TO R-38 INSULATION AT ALL NEW ATTIC OR DISTURBED ATTIC AREAS. PROVIDE COMPLETE ENVELOPE.

REPLACE REMOVED INSULATION WITH EQUIVALENT TO MATCH EXISTING AT EXISTING WALLS.

#### CAULKING:

CAULK ALL NEW AND EXISTING DOOR AND WINDOW FRAMES AT AREAS OF NEW WORK. ENTIRE PERIMETER - EXTERIOR AND INTERIOR. CAULK PRIOR TO PAINTING AND FINISH WORK.

#### FIRESTOPPING:

FIRESTOP ALL WALL, FLOOR AND CEILING PENETRATIONS TO COMPLY WITH CURRENT CODES.

#### STRUCTURAL:

MAINTAIN STRUCTURAL INTEGRITY OF EXISTING STRUCTURE. PROVIDE HEADERS, FRAMING OR STRUCTURAL SUPPORT TO ACCOMMODATE NEW OPENINGS, REMOVED STRUCTURE, ETC.

## WALL TYPES SCHEDULE


DESCRIPTION MARK EXISTING WOOD FRAMED WALL. REMOVE PORTIONS AS REQUIRED TO PROVIDE ACCESS FOR NEW PLUMBING WORK. EXTEND EXISTING 2x4 WOOD FRAMED WALL WITH 5/8" GYPSUM BOARD AND CERAMIC TILE EACH SIDE. FULL THICK ACOUSTIC

INSULATION AT ALL VOIDS.

EXISTING 6" CMU WALL. 8" HIGH CMU COURSES TO MATCH EXISTING. STACKED BOND. TOOTH-IN TO EXISTING.

ALL WALL TYPES: WHERE WALLS ARE TO RECEIVE CERAMIC WALL TILE, INSTALL 5/8" GLASS MAT GYPSUM TILE BACKER INSTEAD OF 5/8" GYPSUM BOARD.



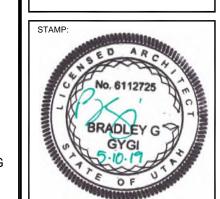




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> 5141710 CHECKED: BGG BGG


COVER SHEET, FLOOR PLANS. REFLECTED **CEILING PLANS** AND NOTES

A101

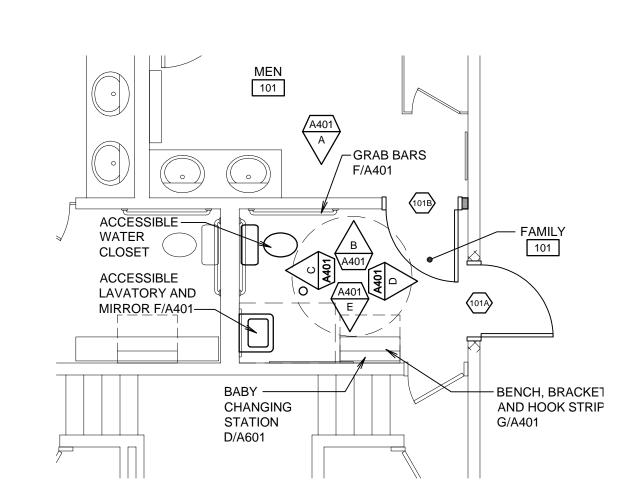

### ENLARGED MEN'S 101 PLAN

SCALE: 1/4" = 1'-0"

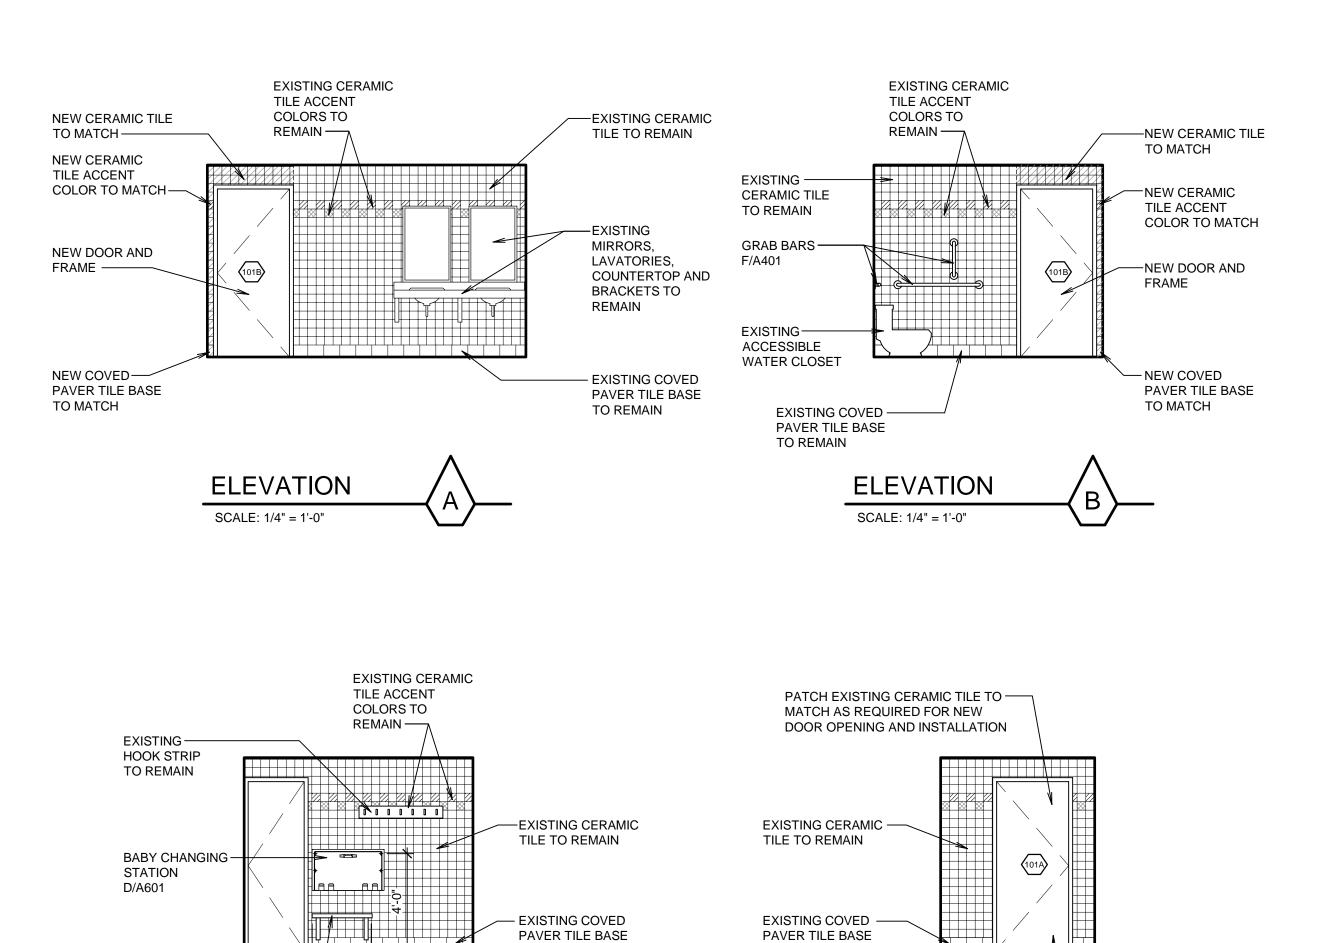

TO REMAIN

NEW DOOR AND

FRAME ----

**ELEVATION** 

SCALE: 1/4" = 1'-0"

TO REMAIN

2'-6" 4'-2" MIN.

**ELEVATION** 


SCALE: 1/4" = 1'-0"


MODIFIED —


G/A401

EXISTING BENCH

AND BRACKETS

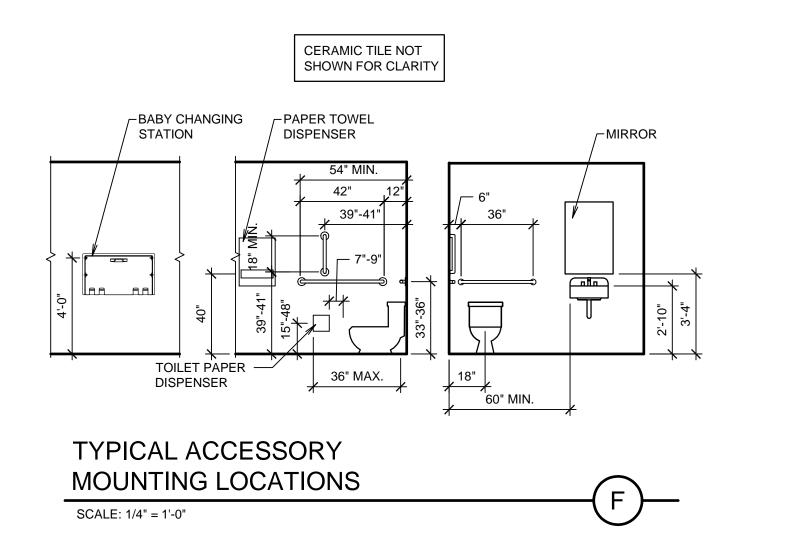


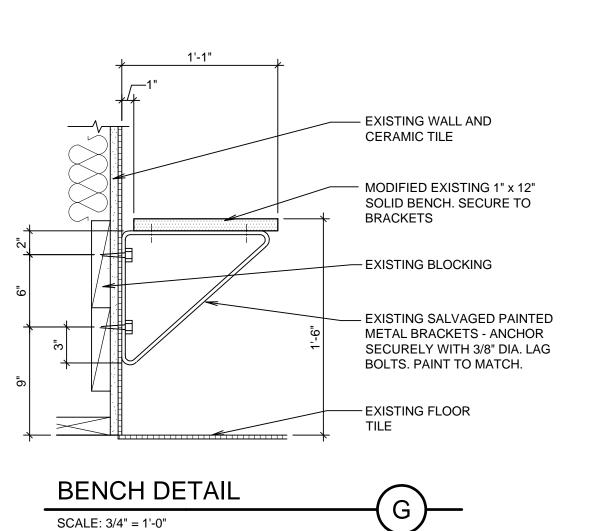

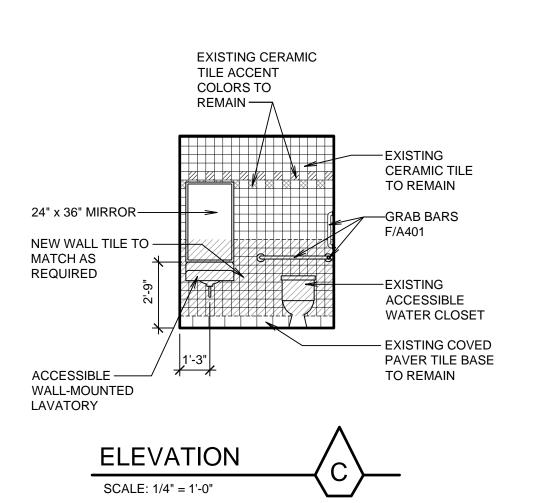

BRADLEY G

bradley gygi architec & associates, pllc

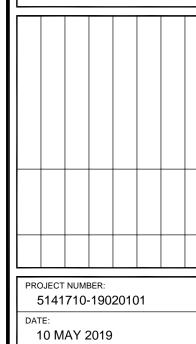



PROPERTY NUMBER:

5141710 DRAWN BY: BGG BGG


SHEET TITLE: ENLARGED RESTROOMS

A401

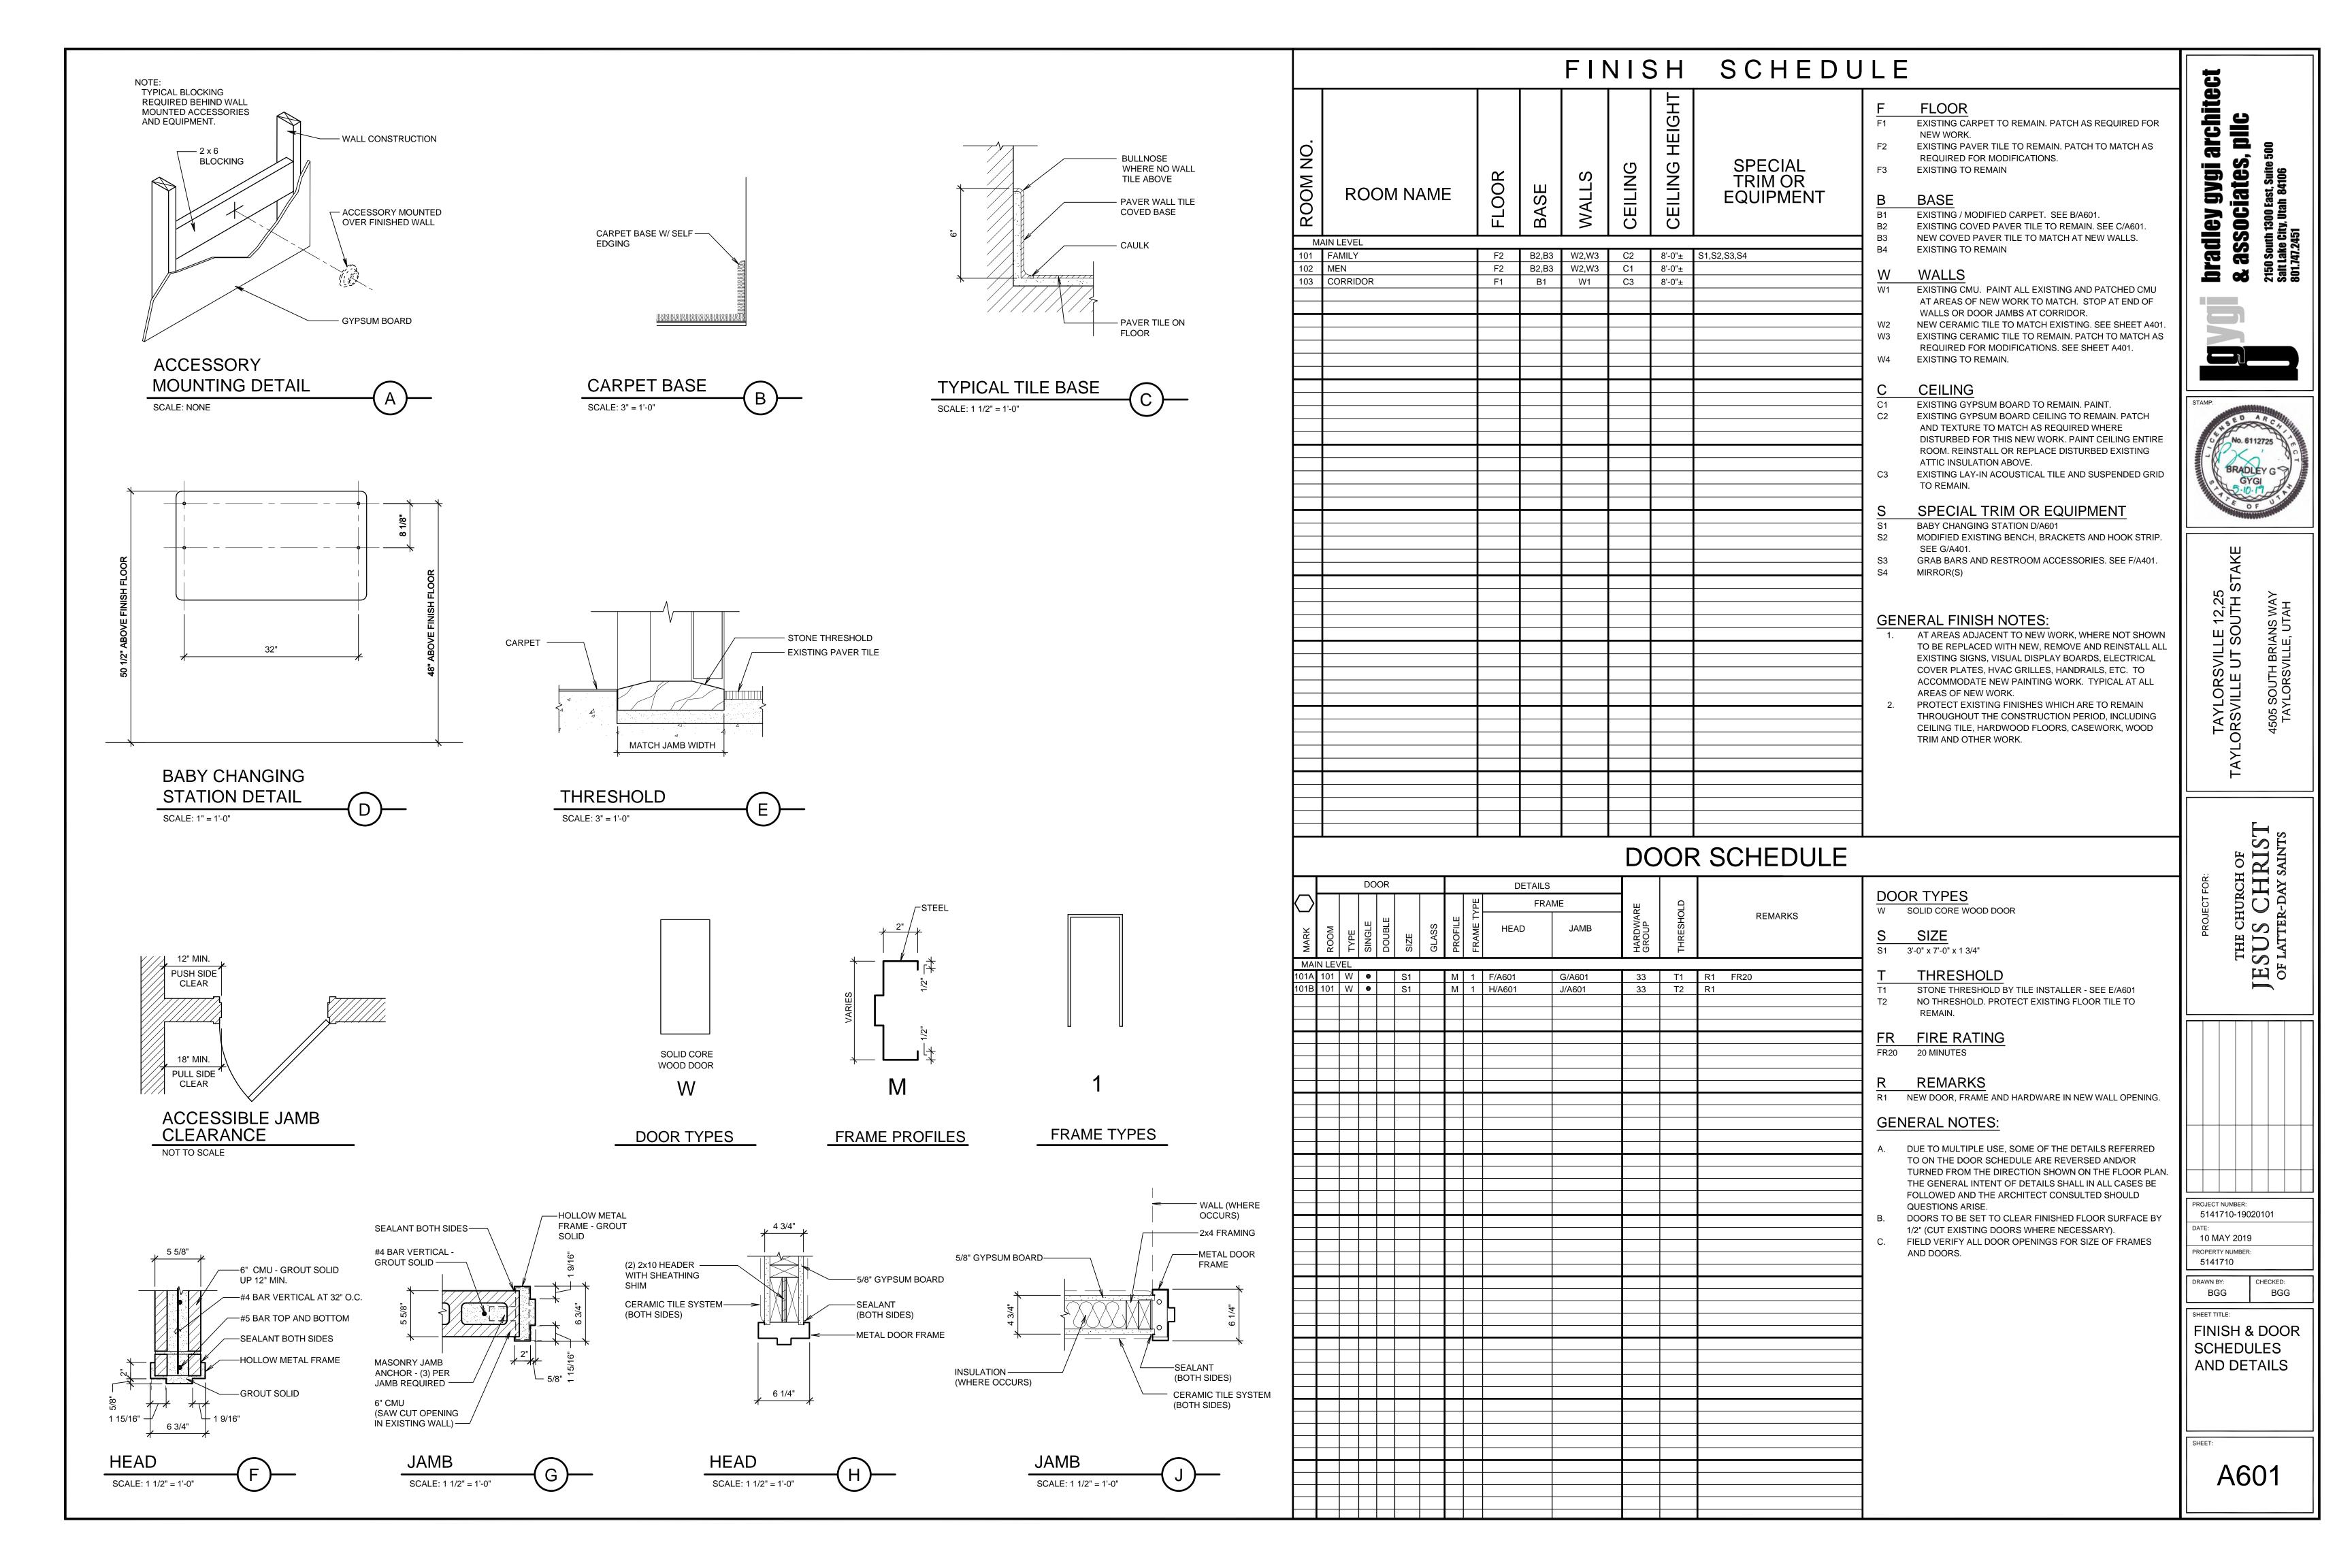

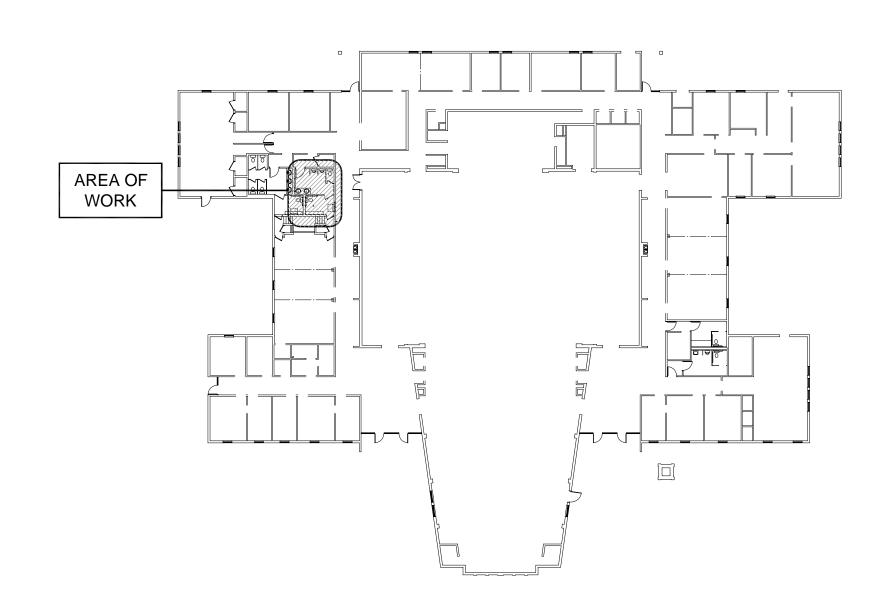

**KEY PLAN** 

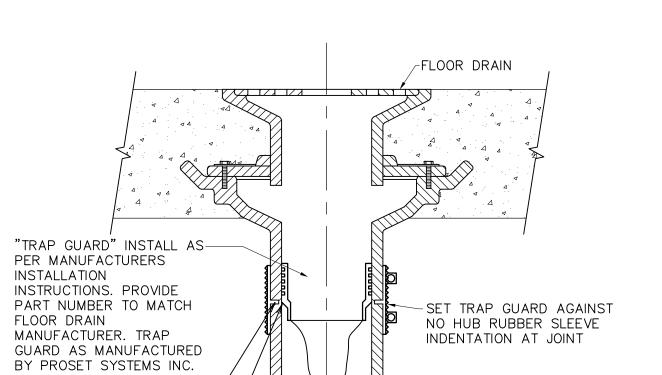


BEAD OF SILICON-TRAP GUARD TRAP SEAL SCALE: NONE


TEL. 800-262-5355

NO HUB FITTING ---


SCALE: NONE

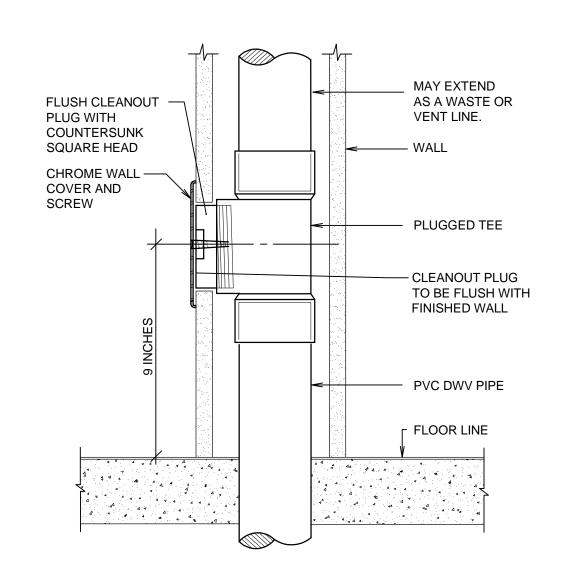

WALL CLEANOUT DETAIL

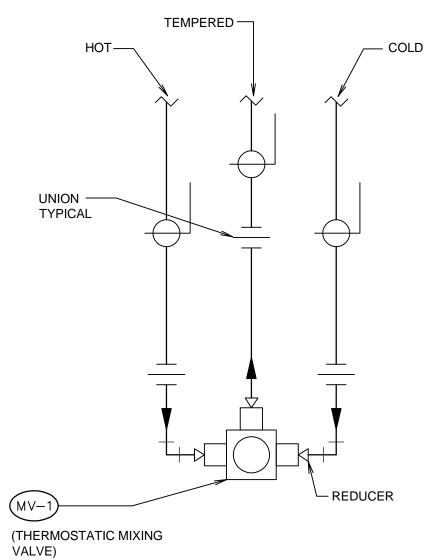


MIXING VALVE PIPING SCHEME (C)

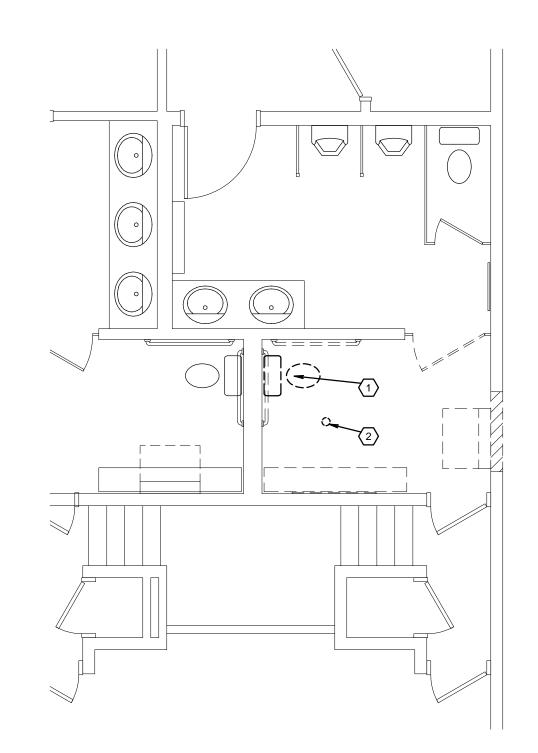

EXISTING / DEMOLITION PLUMBING PLAN

SCALE: 1/4" = 1'-0"

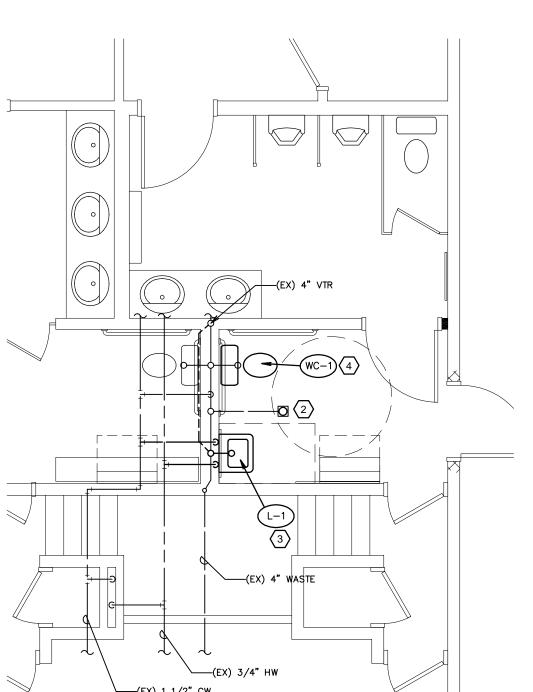

- 2) THERMOSTATIC MIXING VALVE MV-1, MOUNT UNDER LAVATORY, SEE C/P101

SCALE: 1/8" = 1'-0"

(3) SALVAGE AND REINSTALL EXISTING FIXTURE IN EXISTING LOCATION

#### **GENERAL PLUMBING NOTES**

- IF CONTRACTOR ENCOUNTERS MATERIAL THAT MAY CONTAIN ASBESTOS, HE SHALL IMMEDIATELY STOP WORK IN THIS AREA AND NOTIFY OWNER.
- EXISTING PIPE LOCATIONS AND PIPE SIZES SHOWN HAVE BEEN TAKEN FROM EXISTING DRAWINGS. CONTRACTOR IS TO FIELD DETERMINE EXACT SIZE, ELEVATION, AND LOCATION OF EXISTING PIPING INSIDE THE BUILDING AT SPECIFIED CONNECTION POINTS PRIOR TO STARTING ANY WORK.
- SAW CUT OR CORE DRILL ALL NEW PENETRATIONS THROUGH
- EXISTING MASONRY CONSTRUCTION. PATCH AND REPAIR ALL EXISTING SURFACES DAMAGED BY NEW CONSTRUCTION TO MATCH EXISTING.
- **DEMOLITION GENERAL:** a. REMOVE ALL RELATED PIPING AND APPURTENANCES.
- b. REMOVE BRANCH PIPING COMPLETELY AND CAP IN MAIN. c. PATCH AND REPAIR ALL EXISTING SURFACES (WALL, ROOF, FLOOR, CEILING, ETC.) TO MATCH EXISTING.
- REMODEL GENERAL: a. CONCEAL ALL PIPING, EQUIPMENT, AND APPURTENANCES UNLESS OTHERWISE NOTED.
- REMOVE EXISTING SURFACES (WALL, ROOF, FLOOR, CEILING, ETC.) AS REQUIRED AND REPLACE TO MATCH EXISTING.
- REFER TO MECHANICAL SHEETS FOR ANY ADDITIONAL WORK. ALL PLUMBING SHALL COMPLY WITH THE MOST STRINGENT OF APPLICABLE CODES, ORDINANCES, OR THE SPECIFICATIONS.
- ALL FIXTURES SHALL BE PROPERLY VENTED TO THE ATMOSPHERE. FOR INDIVIDUAL LINE SIZES TO FIXTURES, SEE SCHEDULE THIS
- DUE TO THE CLOSE PROXIMITY OF THE WATER, DRAIN, AND VENT PIPING AS WELL AS DUCTWORK, EQUIPMENT, AND HVAC PIPING, THE PLUMBING CONTRACTOR SHALL COORDINATE THE INSTALLATION WITH THE MECHANICAL AND SHEET METAL CONTRACTORS.

#### **KEYED PLUMBING NOTES**

- 1 REMOVE AND SALVAGE EXISTING WATER CLOSET. MAINTAIN EXISTING WATER SUPPLY AND WASTE CONNECTIONS.
- 2 PROTECT EXISTING FLOOR DRAIN TO REMAIN.
- NEW WALL-MOUNTED LAVATORY. ADD HOT AND COLD WATER

**LEGEND** 

MEANING

\_\_\_\_\_

\_\_\_\_\_

VTR

SYMBOL OR

CLEANOUT

BALL VALVE

UNION

**ABBREVIATION** 

WALL CLEANOUT

FLOOR CLEANOUT

MEANING

WCO

CO

FCO

<del>-----</del>|-----

SYMBOL OR

VENT LINE

WASTE LINE


ABBREVIATION


HOT WATER LINE

COLD WATER LINE

VENT THRU ROOF

- PIPING IN WALL FROM EXISTING PIPING. ADD AND CONNECT TO EXISTING WASTE AND VENT PIPING IN WALL. INSTALL WITH CARRIERS IN WALL. FIELD VERIFY LOCATIONS OF EXISTING PIPING FOR CONNECTIONS.
- 4 REINSTALL EXISTING SALVAGED WATER CLOSET WITH NEW SEAL IN EXISTING LOCATION AND CONNECT TO WATER SUPPLY AND WASTE PIPING.

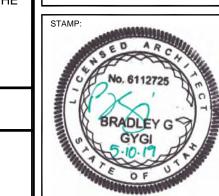

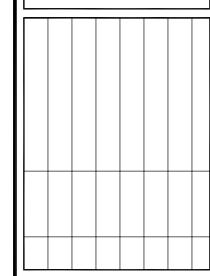


PROJECT NUMBER: 5141710-19020101 10 MAY 2019 PROPERTY NUMBER:

5141710 DRAWN BY: CHECKED: BGG BGG

**PLUMBING PLANS** 


P101

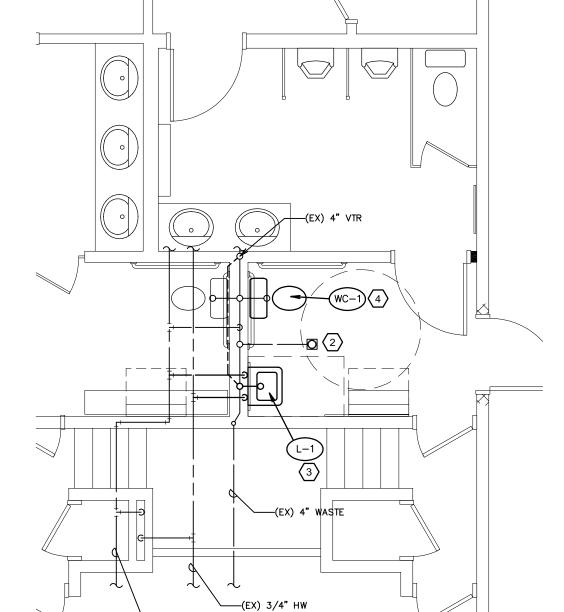

PARTIAL NEW PLUMBING PLAN

	PLUMBING FIXTURE SCHEDULE								
MARK	FIXTURE	PIPE SIZE					REMARKS		
		TRAP	WASTE	VENT	C.W.	H.W.	KLIWAKKS		
WC-1	WATER CLOSET	INT.	4"	2"	1/2"	-	FLUSH TANK, 18" RIM HEIGHT (ACCESSIBLE FIXTURE) 1 3		
L-1	LAVATORY	1-1/4"	1-1/4"	1-1/2"	1/2"	1/2"	SELF-SUPPORTING 20"x18"		

- (1) WHEN MOUNTED PER ARCHITECTURAL ELEVATIONS, ADA ACCESSIBILITY REQUIREMENTS ARE SATISFIED.

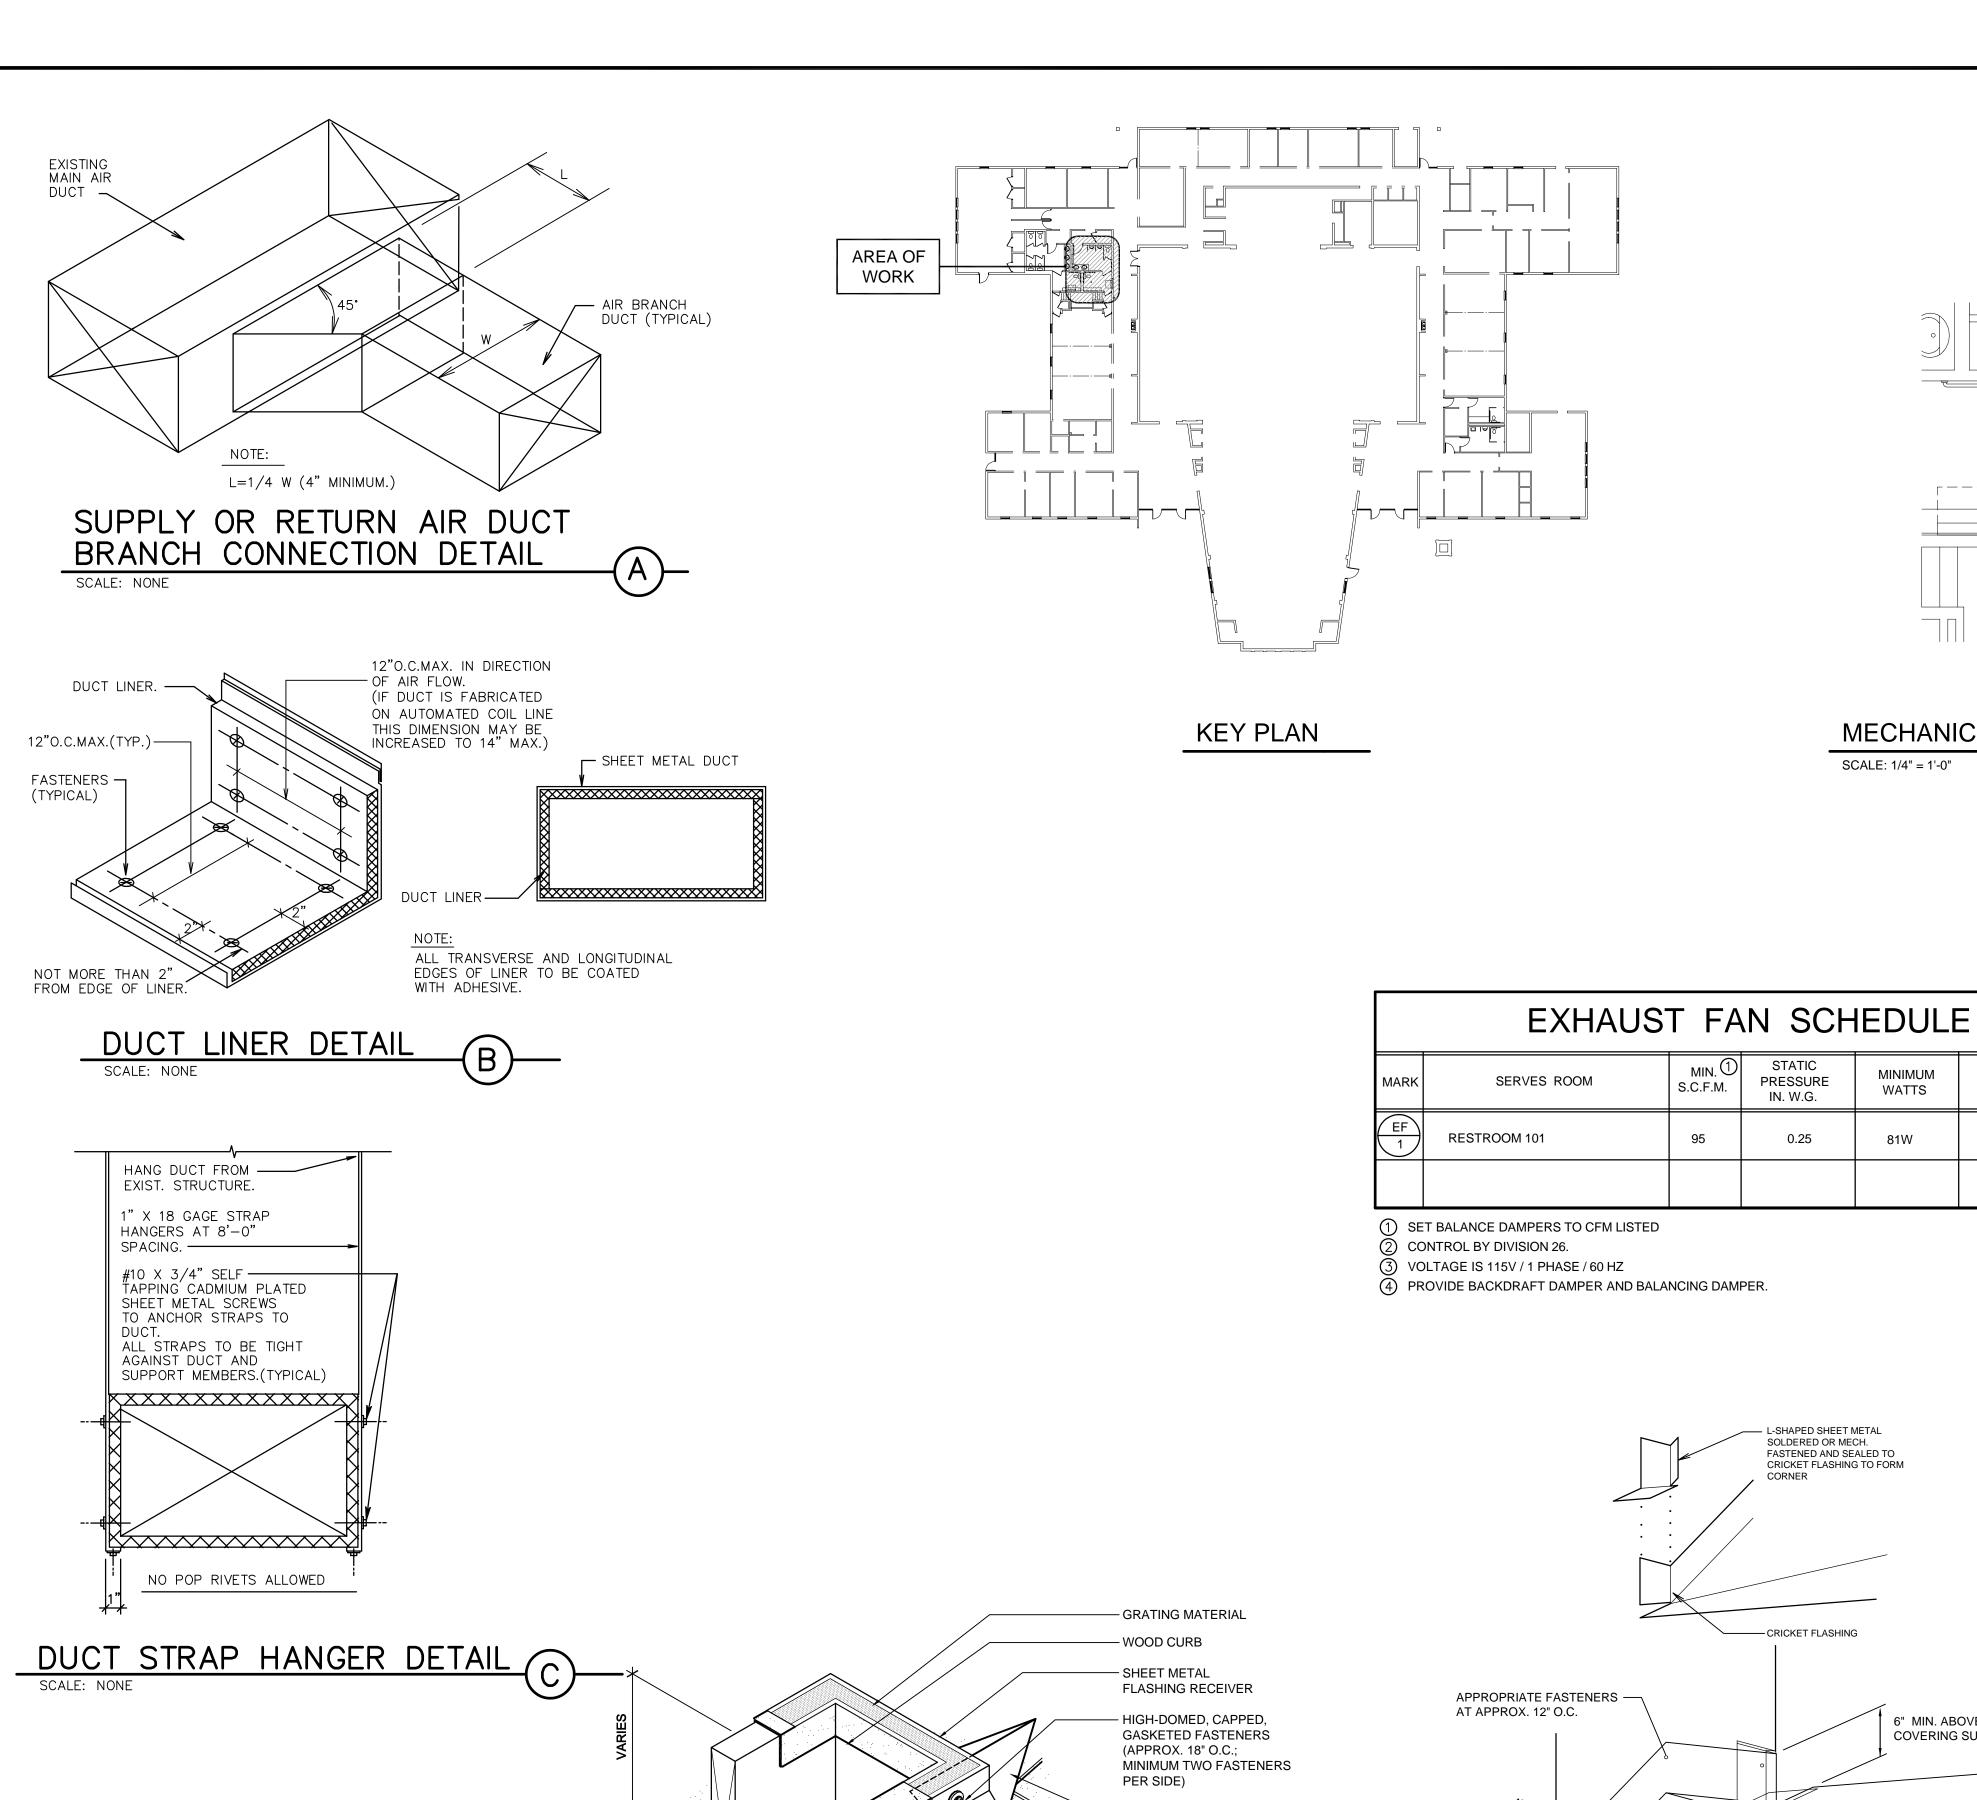

- MECHANICAL UNIT, HOOD, ETC.

-BASE OF UNIT EXTENDS 1/2"

-SEALING MATERIAL - MUST BE CONTINUOUS ON TOP

MINIMUM BEYOND

BELOW TOP OF CURB

- FLASHING RECEIVER

-COUNTERFLASHING

— FLASHING MEMBRANE

TOP OF CURB

OF THE CURB

1" MINIMUM

-FASTENERS

— WOOD CURB

RAISED CURB DETAIL

NOT TO SCALE

METAL SADDLE AT TOP

- REMOVABLE SHEET

- SHINGLES

SIDE OF CURB. SEE E/M101

METAL COUNTERFLASHING

BACKER FLASHING - EXTEND

UPSLOPE UNDER SHINGLES A

STEPPED FLASHING SEE D/A128

- SECONDARY UNDERLAYMENT

- PLYWOOD ROOF DECK

FIGURE ABOVE)

SCALE: NONE

CRICKET FLASHING

MINIMUM OF (3) LAYERS)

#### GENERAL MECHANICAL NOTES EXISTING DUCTWORK, SIZES, AND EQUIPMENT SHOWN FOR

- CONTRACTOR'S REFERENCE. FIELD DETERMINE EXACT SIZE, ELEVATION, AND LOCATION OF EXISTING ITEMS, INCLUDING THEIR RELATIONSHIP WITH INTENDED WORK PRIOR TO STARTING ANY
- DRAWINGS SHOW GENERAL ARRANGEMENT OF PIPING, DUCTWORK EQUIPMENT, ETC. FOLLOW AS CLOSELY AS ACTUAL BUILDING CONSTRUCTION AND WORK OF OTHER TRADES WILL PERMIT. BECAUSE OF THE SMALL SCALE OF THE DRAWINGS, IT IS NOT POSSIBLE TO INDICATE ALL OFFSETS, FITTINGS, AND ACCESSORIES THAT MAY BE REQUIRED. INVESTIGATE STRUCTURAL AND FINISH CONDITIONS AFFECTING THIS WORK AND ARRANGE WORK ACCORDINGLY. PROVIDE SUCH FITTINGS, VALVES, AND ACCESSORIES REQUIRED TO MEET CONDITIONS.

archit

BRADLEY G

- PATCH AND REPAIR ALL EXISTING SURFACES DAMAGED BY NEW CONSTRUCTION TO MATCH EXISTING.
- BALANCE SYSTEMS BEING REVISED COMPLETELY TO CFM'S SHOWN MAKE ADJUSTMENTS NECESSARY TO ACHIEVE AIR FLOW QUANTITIES SHOWN ON DRAWINGS.
- DUCT DIMENSIONS ARE CLEAR DIMENSIONS INSIDE DUCT LINER. DO NOT ROUTE PIPES ABOVE ELECTRICAL PANELS. MAINTAIN CLEAR ACCESS SPACE IN FRONT OF ALL ELECTRICAL PANELS 4'-0" DEEP ANI 6'-6" HIGH.
- SAW CUT OR CORE DRILL ALL NEW PENETRATIONS THROUGH EXISTING MASONRY CONSTRUCTION.
- IF CONTRACTOR ENCOUNTERS MATERIAL THAT MAY CONTAIN ASBESTOS, HE SHALL IMMEDIATELY STOP WORK IN THIS AREA AND NOTIFY THE OWNER.
- DEMOLITION GENERAL: a. REMOVAL OF EQUIPMENT, PIPING, OR DUCTWORK TO INCLUDE REMOVAL OF ALL RELATED APPURTENANCES SUCH AS WIRING,
- CONDUIT, SUPPORTS, ETC. AND MODIFICATIONS REQUIRED FOF A COMPLETE OPERATING SYSTEM. REMOVE BRANCH CONDUIT AND WIRE COMPLETELY.
- PATCH AND REPAIR ALL EXISTING SURFACES (WALL, ROOF, FLOOR, CEILING, ETC.) TO MATCH EXISTING. 10. REMODEL - GENERAL:


TERMINATE AT JUNCTION BOX.


- a. ALL NEW CONDUIT, PIPING, DUCT, EQUIPMENT, AND APPURTENANCES TO BE CONCEALED UNLESS OTHERWISE
- EXISTING SURFACES (WALL, ROOF, FLOOR, CEILING, ETC.) TO BE REMOVED AS REQUIRED AND REPLACED TO MATCH EXISTING.

#### **KEYED MECHANICAL NOTES**

 $\left\langle \overline{1} \right
angle$  NEW EXHAUST FAN. NEW DUCTWORK PIPING THROUGH ATTIC TO NEW ROOF CURB WITH PENTHOUSE OR MANUFACTURER'S ROOF TERMINATION KIT. PER MANUFACTURER'S RECOMMENDATIONS.

LEGEND							
SYMBOL	DESCRIPTION	SYMBOL	DESCRIPTION				
	BRANCH DUCT TAKE-OFF. SEE DETAIL E/M3.1		MANUAL VOLUME DAMPER				
	SINGLE THICKNESS TURNING VANES	<del>                                      </del>	BACKDRAFT DAMPER (INSTALL AT EACH EXHAUST DISCHARGE DUCT)				
	DUCT TRANSITION		EXISTING DUCT TO BE REMOVED				
SA SUPPLY AIR			EXISTING DUCT TO REMAIN				
D.4	DETURN AIR	1]	LAISTING DOCT TO INLIVIATIN				

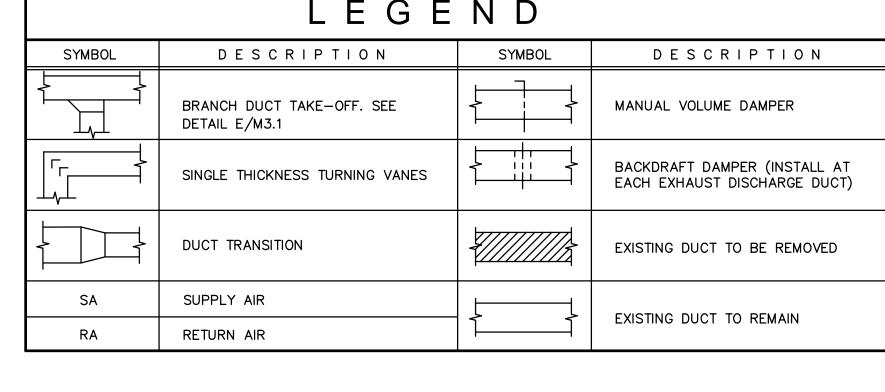

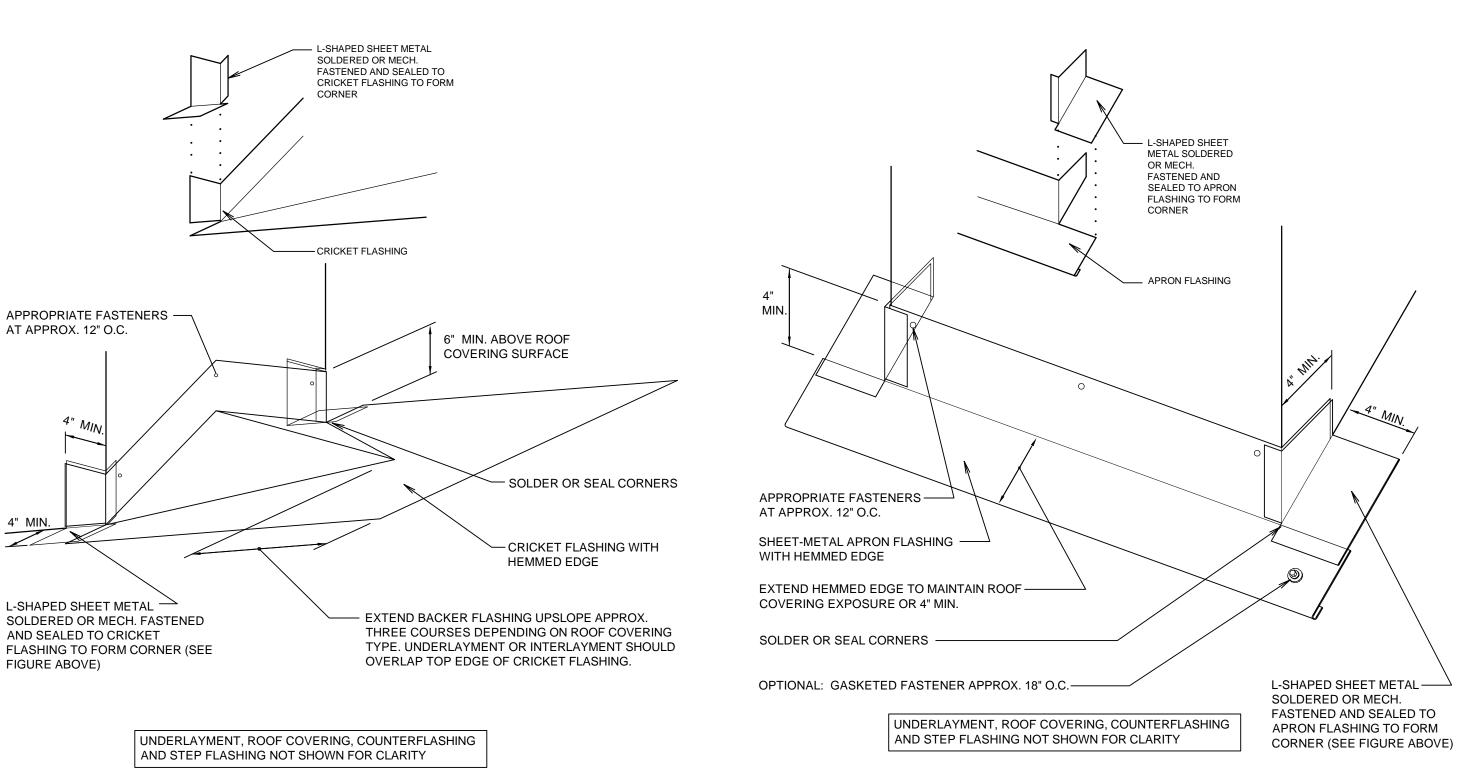

SCALE: NONE

MECHANICAL PLAN

SCALE: 1/4" = 1'-0"

MINIMUM

WATTS


REMARKS

2 3 4

PRESSURE

0.25

IN. W.G.

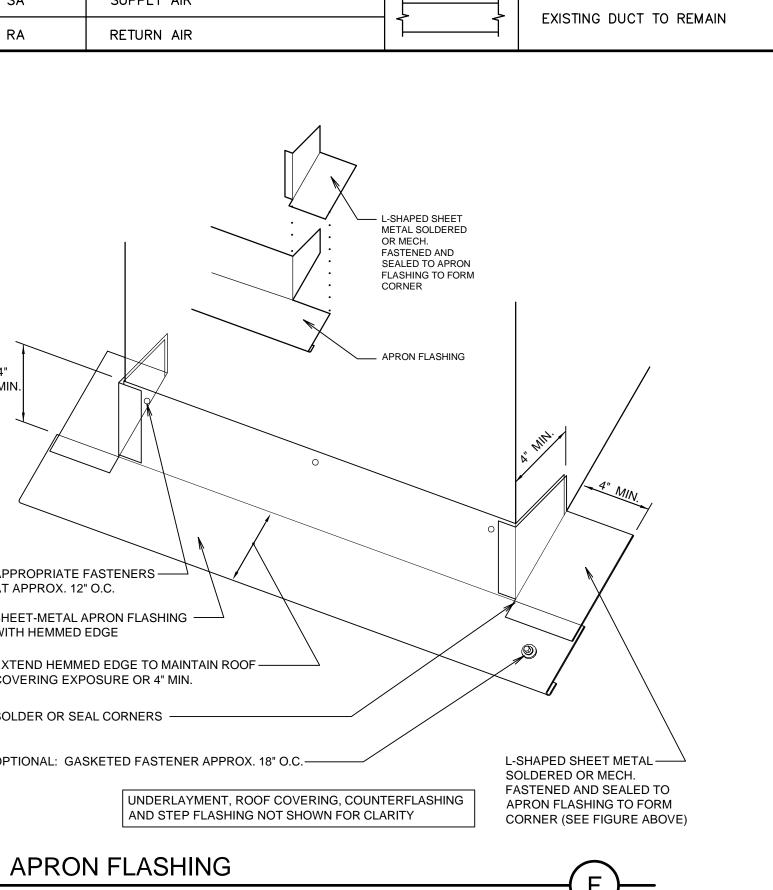

PLANS AND ROOFING **DETAILS** 

PROJECT NUMBER:

10 MAY 2019

PROPERTY NUMBER:

5141710

BGG

DRAWN BY:


5141710-19020101

**MECHANICAL** 


CHECKED:

BGG

M101

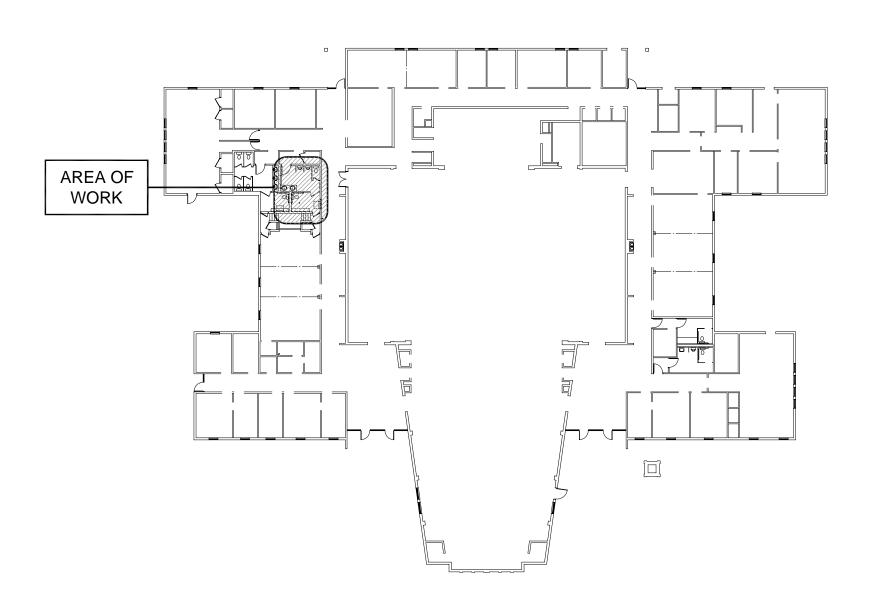

KEY PLAN

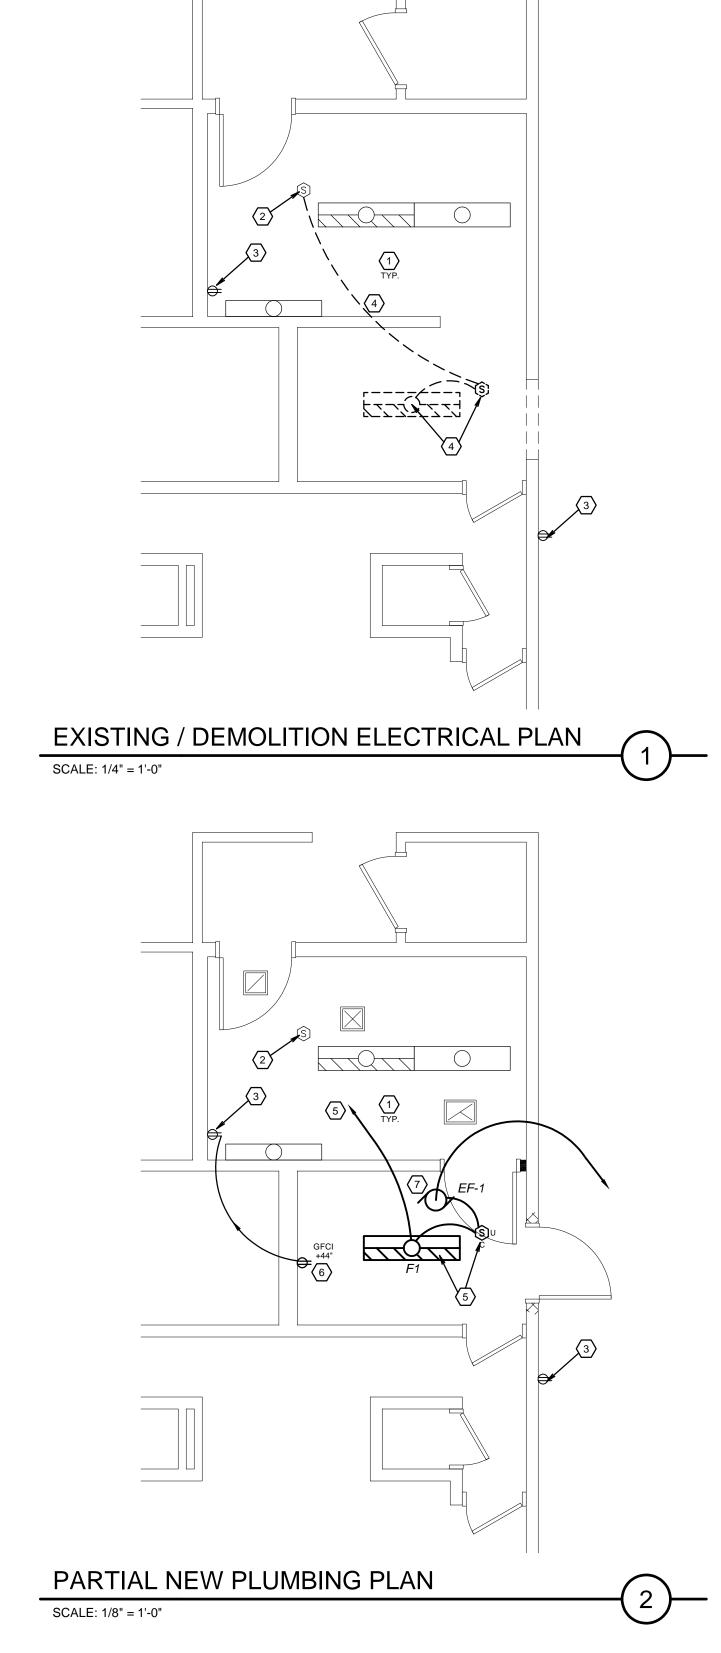

	EXHAUST FAN SCHEDULE								
SYM	DESCRIPTION	CIRCUIT	FEEDER	VOLTS / PHASE	DISCONNECT	HP/WATTS			
EF-1	EXHAUST FAN	NEW	2 #12, #12 GR	120 / 1 (VERIFY EXISTING)	INCLUDED	100W			

FIXTURE SCHEDULE							
SYM	MANUFACTURER		LOAD	LAMPS	MOUNTING	REMARKS	
	NAME	CATALOG NUMBER	(VA)	TYPE			
F1						SALVAGE AND REINSTALL EXISTING FIXTURE SEE SPEC. 265100	
						*EMERGENCY BATTERY PACK WHERE SHOWN HATCHED ON PLAN	

#### GENERAL ELECTRICAL NOTES

- WHERE AFFECTED BY DEMOLITION OR NEW CONSTRUCTION, RELOCATE, EXTEND OR REPAIR RACEWAYS, CONDUCTORS, OUTLETS AND APPARATUS TO ALLOW CONTINUED USE OF ELECTRICAL SYSTEM. USE METHODS AND MATERIALS AS SPECIFIED FOR NEW CONSTRUCTION.
- REROUTE ANY EXISTING CONDUIT OR ELECTRICAL FIXTURES OR DEVICES WHICH ARE ENCOUNTERED DURING THE DEMOLITION OR WHICH ARE CONFLICTING WITH NEW CONSTRUCTION FOR THIS PROJECT. REROUTE THE CONDUIT AND MAINTAIN THE SERVICE OR MOVE FIXTURES AND APPLIANCES AS REQUIRED TO ACCOMMODATE THE WORK OF OTHER TRADES DURING THIS CONSTRUCTION. MOVE OR REMOVE FIXTURES AND DEVICES TO ACCOMMODATE OTHER TRADES DURING THIS CONSTRUCTION AND REINSTALL THE SAME AT THE CONCLUSION OF THE
- 3. CIRCUIT NEW LIGHT FIXTURES, DEVICES, MOTORS AND FIXTURES TO EXISTING PANEL. PROVIDE NEW BREAKERS, CONDUIT AND WIRE AS REQUIRED FOR INSTALLATION.
- 4. PROVIDE RACEWAYS AND BOXES CALLED OUT IN MECHANICAL DRAWINGS. SEE MECHANICAL DRAWINGS AND COORDINATE WITH MECHANICAL CONTRACTOR.
- NO SURFACE-MOUNTED CONDUIT WILL BE ALLOWED ON PROJECT. PATCH AND REPAIR WALLS AND CEILINGS THAT ARE DAMAGED BY ELECTRICAL DEMOLITION AND INSTALLATION. SAW-CUT THROUGH WALLS AS REQUIRED TO CONCEAL ALL CONDUIT. FIELD VERIFY EXISTING CONDITIONS.
- 6. AT REMODELED ROOMS, REPLACE ALL EXISTING OUTLETS, SWITCHES, COVER PLATES AND OTHER DEVICES WHICH ARE NOT REMOVED FOR THIS WORK WITH NEW. ALL NEW DEVICES AND COVER PLATES TO BE WHITE COLOR.
- 7. MAINTAIN POWER AND SWITCHES FOR EXISTING LIGHTING AND OUTLETS AT ALL ADJACENT AREAS.

#### ELECTRICAL KEYED NOTES

 $igl \langle$  1 igr 
angle EXISTING LIGHT FIXTURES TO REMAIN - TYPICAL.

 $\langle 3 \rangle$  EXISTING OUTLET(S) TO REMAIN. TYPICAL.


 $\langle 2 \rangle$  EXISTING CEILING SENSOR TO REMAIN.

MODIFICATION.


- 4 REMOVE AND SALVAGE EXISTING LIGHT FIXTURE. REMOVE EXISTING CEILING SENSOR. MAINTAIN EXISTING WIRING FOR
- 5 REINSTALL EXISTING SALVAGED LIGHT FIXTURE. WIRE WITH NEW CEILING SENSOR(S). MODIFY EXISTING WIRING TO SEPARATE FROM EXISTING MEN'S LIGHT FIXTURES AND SENSOR. CIRCUIT TO EXISTING LIGHT FIXTURE CIRCUIT.
- 6 NEW GROUND FAULT OUTLET. CIRCUIT TO NEW 20A SINGLE PHASE BREAKER IN NEAREST EXISTING PANEL.
- 7 NEW EXHAUST FAN. SWITCH WITH NEW LIGHT FIXTURE SENSOR. CONNECT TO NEW 20A CIRCUIT BREAKER FOR EXHAUST FAN IN NEAREST PANEL.





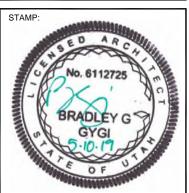



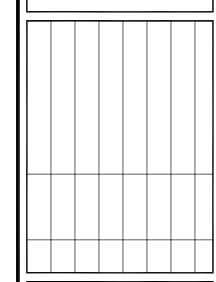

PROJECT NUMBER: 5141710-19020101

10 MAY 2019

5141710

BGG

PLANS

ELECTRICAL

DRAWN BY:

## ELECTRICAL SYMBOLS LEGEND

FLUORESCENT LIGHT FIXTURE

FLUORESCENT LIGHT FIXTURE WITH EMERGENCY BATTERY PACK

EXHAUST FAN (MOTOR OUTLET)

OCCUPANCY SENSOR CEILING MOUNT, ULTRASONIC OCCUPANCY SENSOR
WALL SWITCH, PASSIVE INFRARED

SINGLE POLE SWITCH

DUPLEX RECEPTACLE OUTLET

GFCI DUPLEX RECEPTACLE OUTLET

E101

BGG