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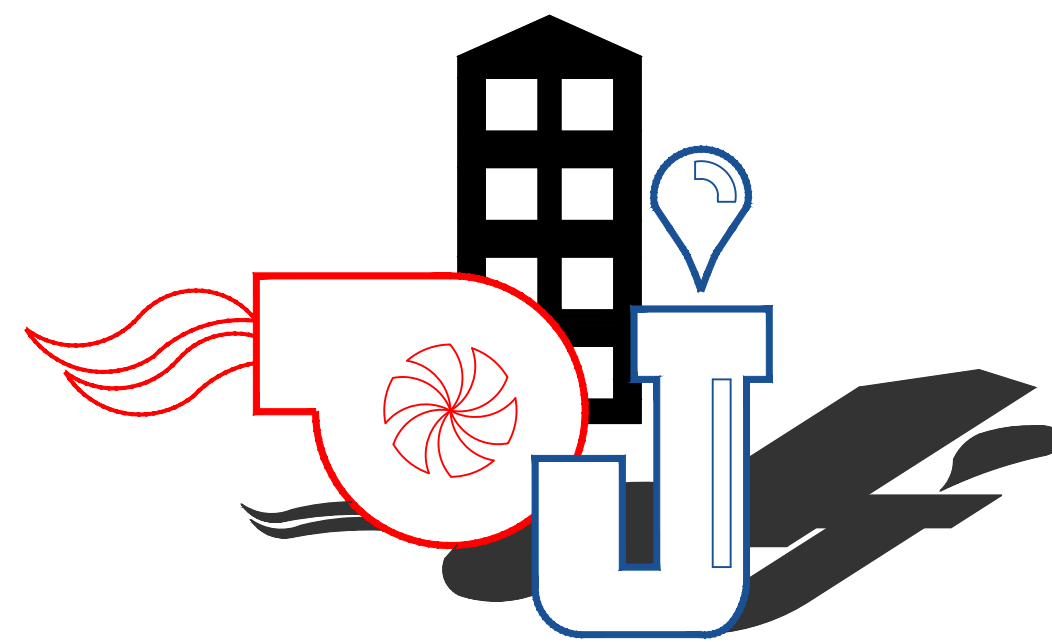
SALEM 1, 2 & 9 WARDS

SALEM UTAH WEST STAKE


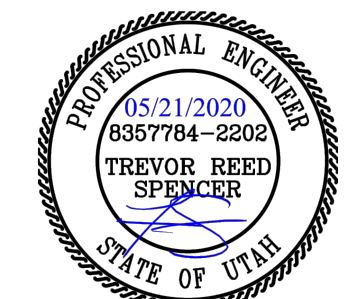
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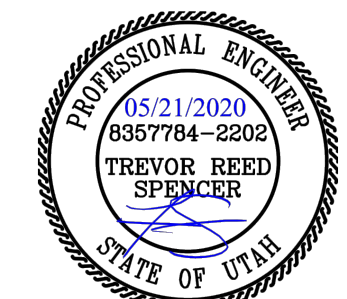
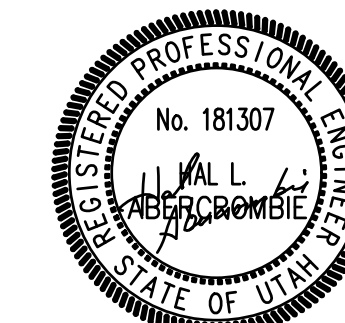
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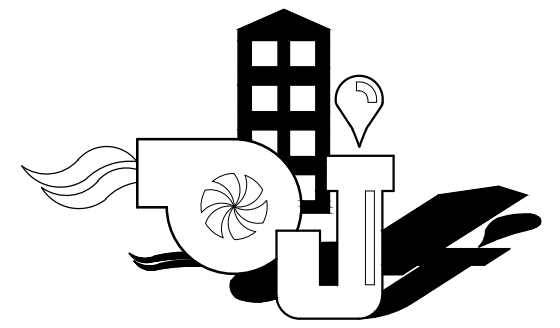
SALEM, UTAH



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CONSULTANT	CONSULTANT	<table border="1"> <thead> <tr> <th>MARK</th> <th>DATE</th> <th>DESCRIPTION</th> </tr> </thead> <tbody> <tr> <td> </td> <td> </td> <td> </td> </tr> </tbody> </table>	MARK	DATE	DESCRIPTION			
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<p>ARCHITECT: LESTER VAN NOSDOL, AIA 150 SOUTH MAIN SALEM, UTAH 84653 PHONE: 801-374-2100 CONTACT: LESTER VAN NOSDOL EMAIL: lester@rvassoc.com</p> 	<p>ELECTRICAL ENGINEER: ENVISION ENGINEERING 240 EAST MORRIS AVENUE #200 SALT LAKE CITY, UTAH 84115 PHONE: 801-924-5544 CONTACT: TREVOR SPENCER EMAIL: TSpencer@envisioneng.com</p> 	<table border="1"> <thead> <tr> <th>MARK</th> <th>DATE</th> <th>DESCRIPTION</th> </tr> </thead> <tbody> <tr> <td> </td> <td> </td> <td> </td> </tr> </tbody> </table>	MARK	DATE	DESCRIPTION			
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		<h1>G101</h1>						






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STAMP



PROJECT FOR

SALEM 1, 2 & 9 WARDS

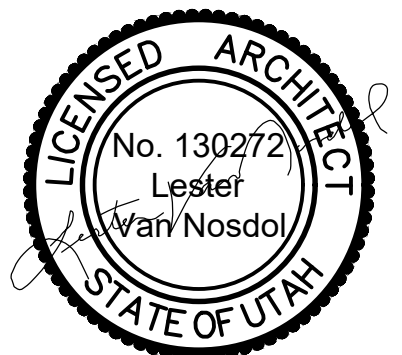SALEM UT WEST STAKE
 PROPERTY NUMBER: 505056119010101
 60 SOUTH MAIN STREET
 SALEM, UTAH 84653

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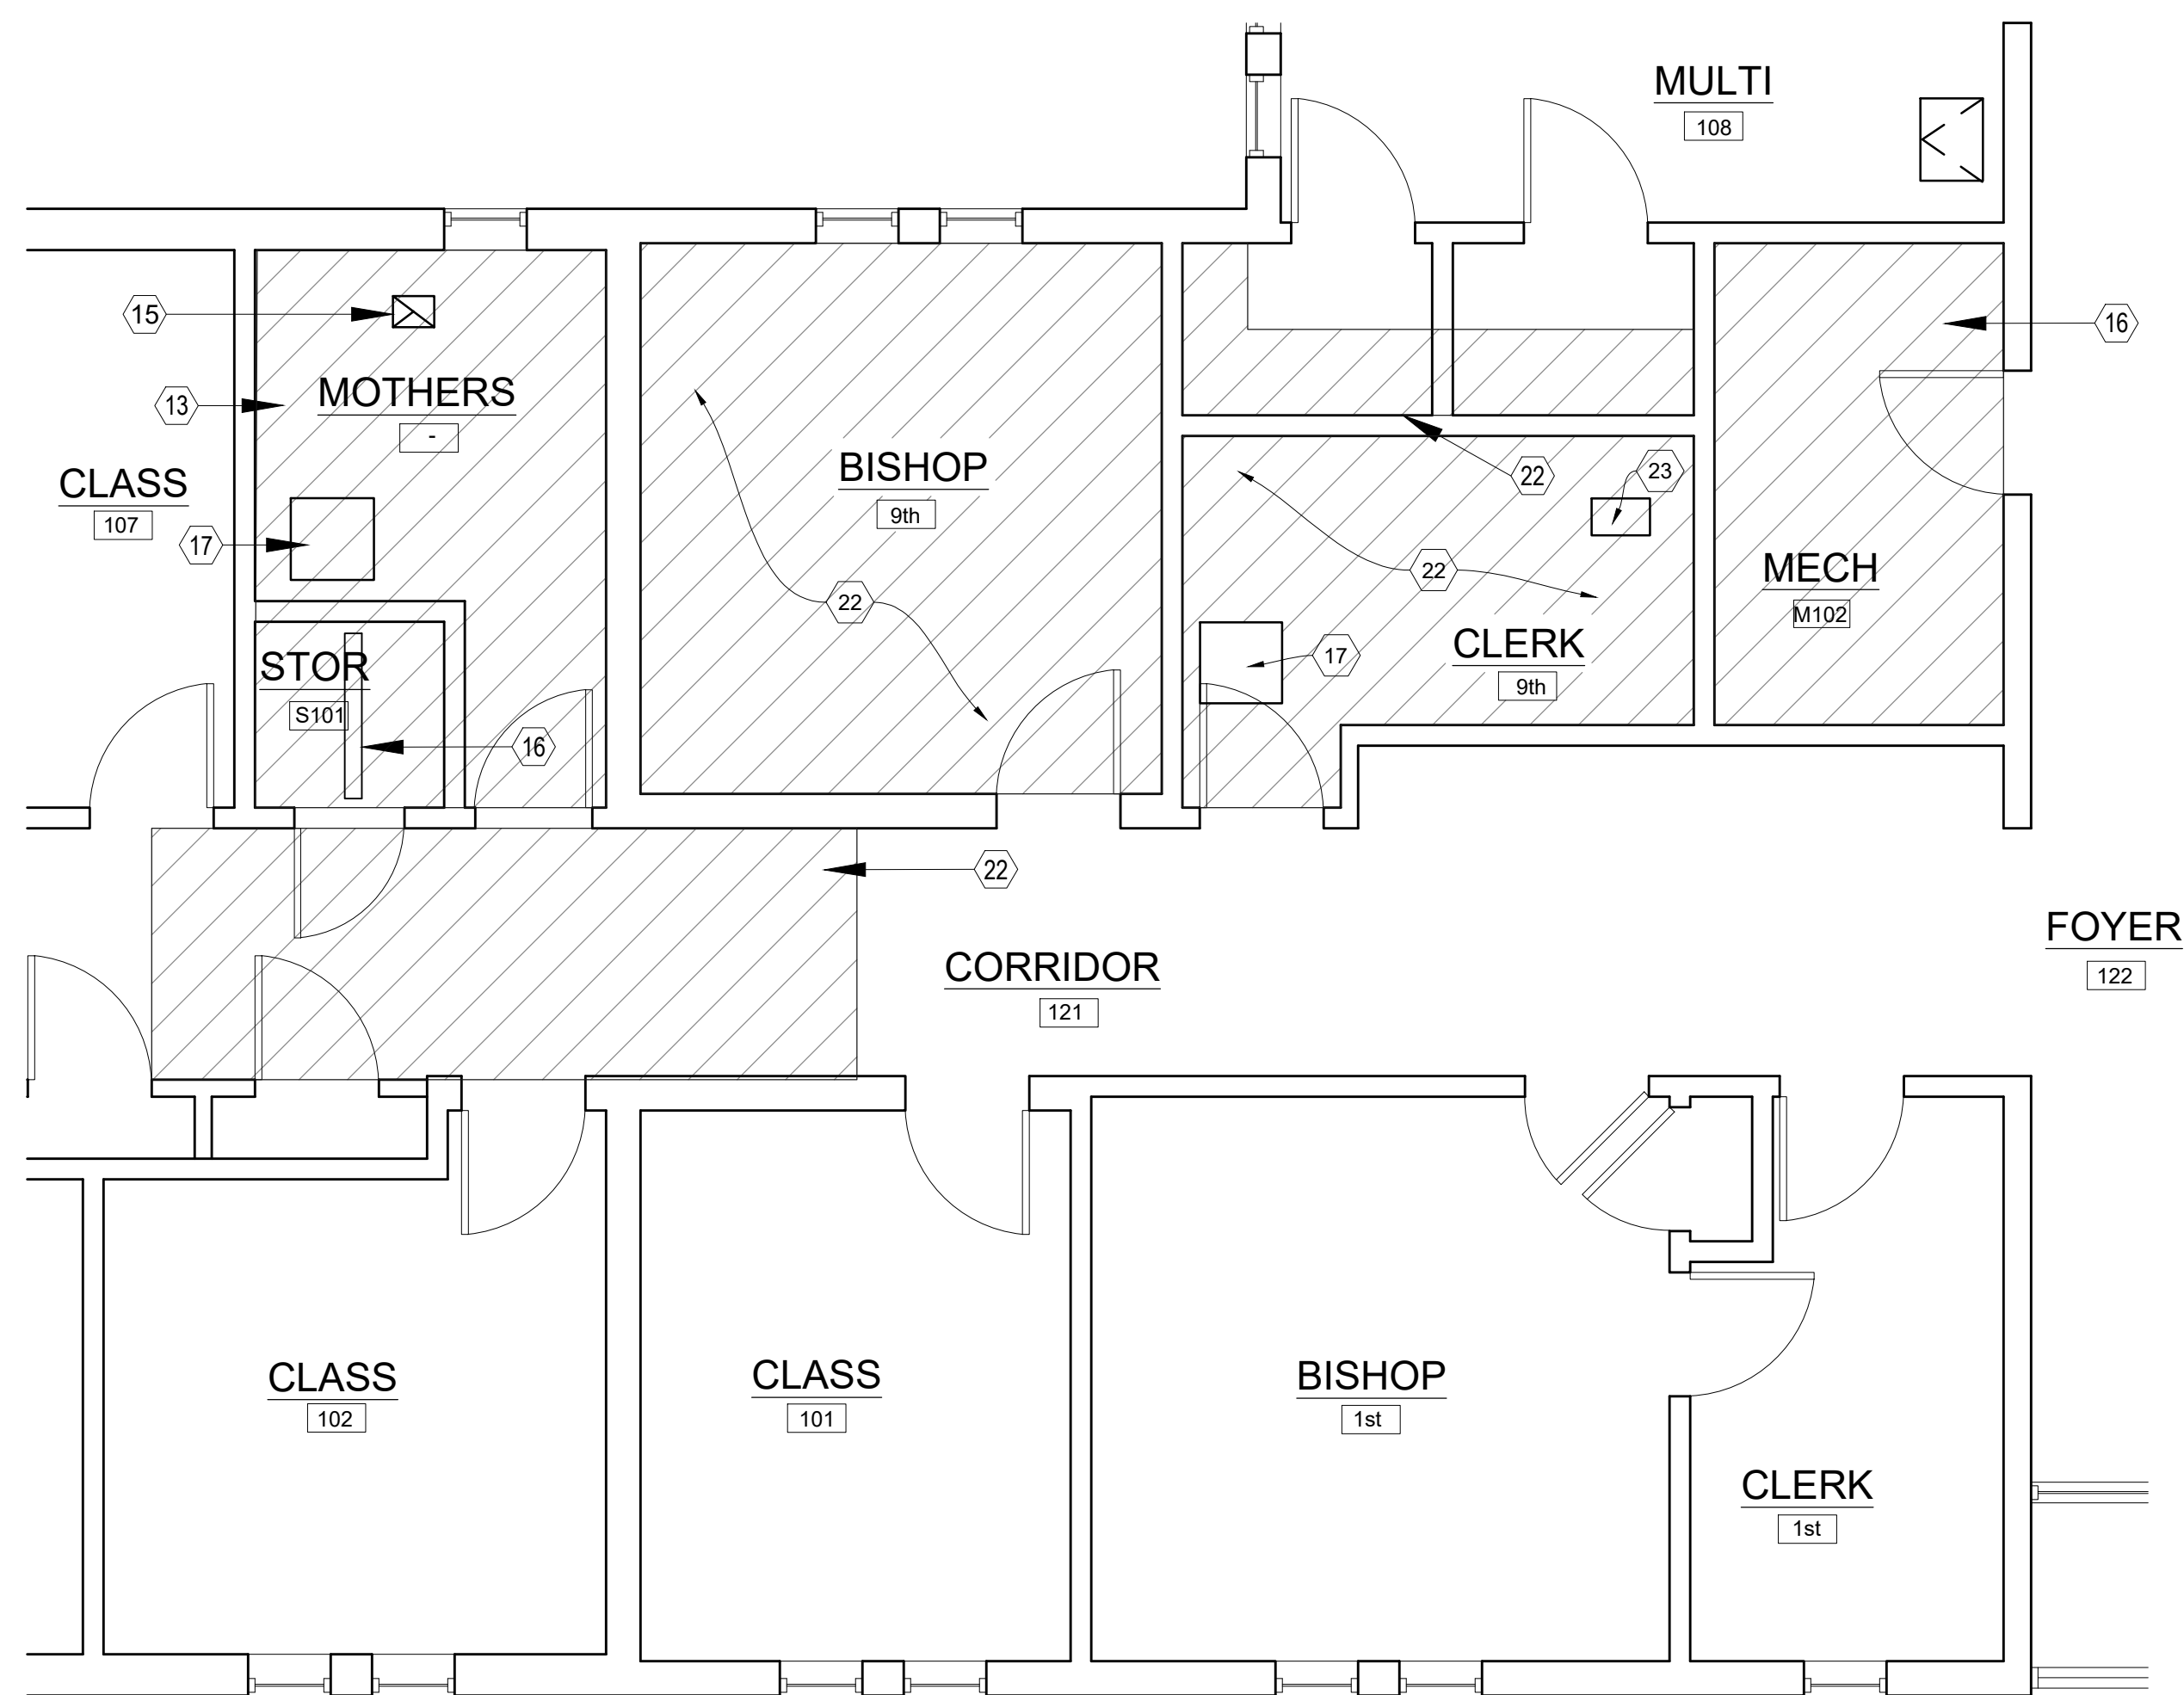
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SHEET TITLE

DEMOLITION PLANS

SHEET NUMBERS

AD101




DEMO REFLECTED CEILING PLAN

SCALE: 1/2" = 1'-0"

DEMOLITION NOTES:


- 1) REMOVE EXISTING CARPET TO ALLOW FOR SAW CUTTING OF EXISTING CONCRETE FLOOR FOR NEW RETURN AIR TUNNEL.
- 2) REMOVE EXISTING CARPET AND CARPET GLUE IN PREPARATION FOR PAINTING. FLOOR TO BE SMOOTH. REMOVE DOOR THRESHOLD.
- 3) REMOVE STORAGE SHELVEING & BRACKETS AND DISPOSE.
- 4) EXISTING PLANTER BED. MODIFY SPRINKLERS LINES AND HEADS. REROUTE SPRINKLER LINES AND CONTROL WIRING.
- 5) EXISTING CONCRETE MOW STRIP. SAW CUT EDGE AT HATCHED AREA TO BE REMOVED.
- 6) EXISTING LAWN.
- 7) EXISTING CONCRETE SIDEWALK. MODIFY AS NEEDED FOR NEW CONDENSING UNIT.
- 8) REMOVE EXISTING SHRUBS & PLANTS. PORTION OF MOW STRIP, LAWN AND ASSOCIATED SPRINKLER PIPING IN THIS AREA SHOWN HATCHED.
- 9) NEW 4" CONCRETE PAD ON 4" GRAVEL BASE.
- 10) NEW FLOOR CLEAN OUT.
- 11) NOTE FLOOR TO BE PAINTED PRIOR TO NEW EQUIPMENT INSTALLED.
- 12) NEW 30" X 30" TUNNEL ACCESS DOOR WITH LATCH IN FLOOR OF MECHANICAL ROOM.
- 13) REMOVE LIGHTS AND OTHER CEILING MOUNTED DEVICES. COORDINATE WITH ELECTRICAL DRAWINGS. REMOVE GYP. BD. CEILING. STORE FIXTURES AND DEVICES FOR REINSTALLATION. REMOVE CEILING/ROOF INSULATION AND DISPOSE.
- 14) EXISTING CONCRETE HVAC MECHANICAL PAD.
- 15) EXISTING EXHAUST FAN.
- 16) REMOVE EXISTING DRYWALL CEILING. REMOVE CEILING/ROOF INSULATION AND DISPOSE. COORDINATE WITH ELECTRICAL DRAWINGS.
- 17) EXISTING CEILING ACCESS TO BE REMOVED AND REMODELED DURING REINSTALLATION.
- 18) REMOVE EXISTING CARPET IN CLASS ROOM. SAW CUT CONCRETE FLOOR AND REMOVE SOIL FOR NEW TUNNEL. DO NOT ALLOW MASONRY WALLS TO BE DAMAGED DURING EXCAVATION.
- 19) REMOVE MINIMAL AMOUNT OF CARPET IN CORRIDOR. SAW CUT CONCRETE FLOOR AND REMOVE SOIL FOR NEW TUNNEL.
- 20) EXCAVATE TO APPROXIMATELY 42" DEPTH. FINISHED TUNNEL FLOOR TO MATCH EXISTING TUNNEL FLOOR HEIGHT.
- 21) SAW CUT CONCRETE TUNNEL WALL. SEE SHEET M401 FOR PARTIAL SECTION.
- 22) REMOVE LIGHTS AND OTHER CEILING MOUNTED DEVICES. STORE FOR REINSTALLATION. REMOVE CEILING TILE/DRYWALL IN HATCHED AREA. START & STOP TILE REMOVAL AT TILE JOINTS IN AREAS WHERE ALL CEILING TILE IS NOT BEING REMOVED. REMOVE INSULATION AND DISPOSE.
- 23) REMOVE EXISTING DIFFUSER.
- 24) SAW CUT EXISTING TUNNEL WALL AND FLOOR TO BOTTOM OF TUNNEL. NEW OPENING FOR DUCTWORK TO FURNACE SYSTEM. SEE SHEET M401 FOR SIZING.

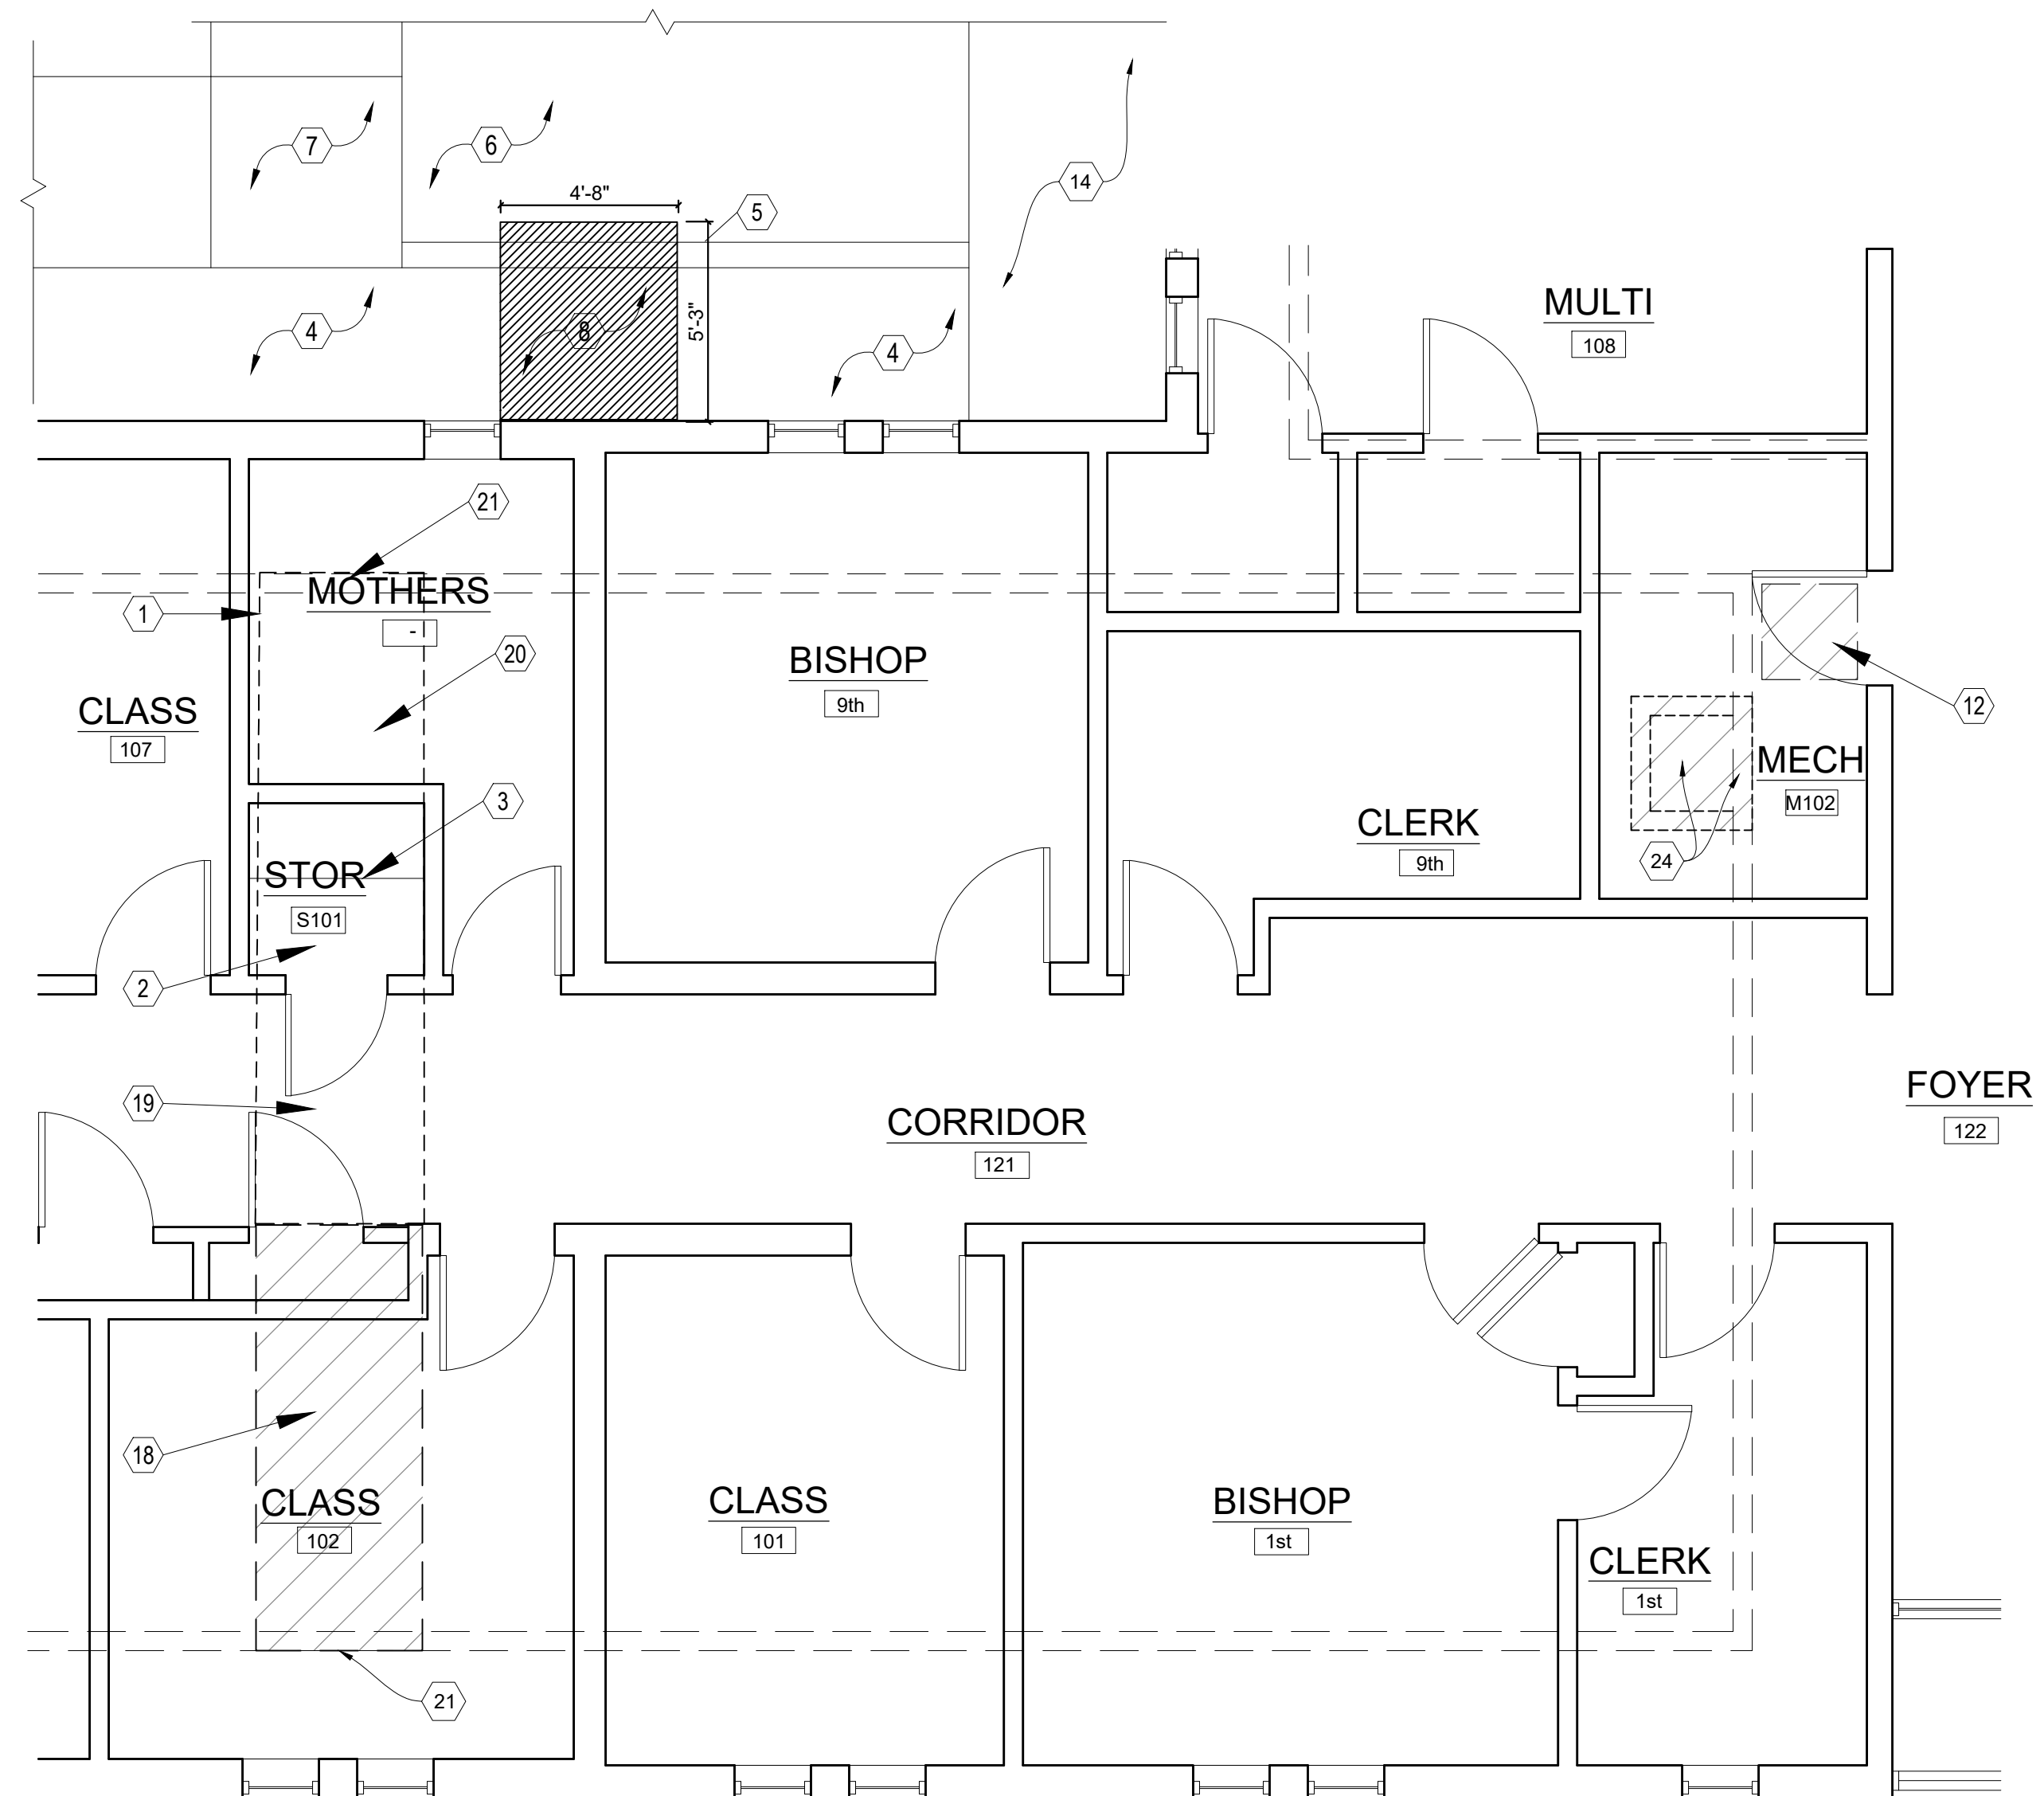


DEMO FLOOR PLAN


SCALE: 1/2" = 1'-0"

CONTRACTOR IS RESPONSIBLE FOR MEMBERS SAFETY AND SHALL PROVIDE RAMP FOR SAFE PASSAGE ACROSS CORRIDOR FOR THE LENGTH OF THE PROJECT WHILE TUNNEL IS OPEN.
 CONTRACTOR IS TO CLEAN DAILY AND ENSURE MEMBERS SAFETY IN ALL AREAS OF THE BUILDING DURING CONSTRUCTION.

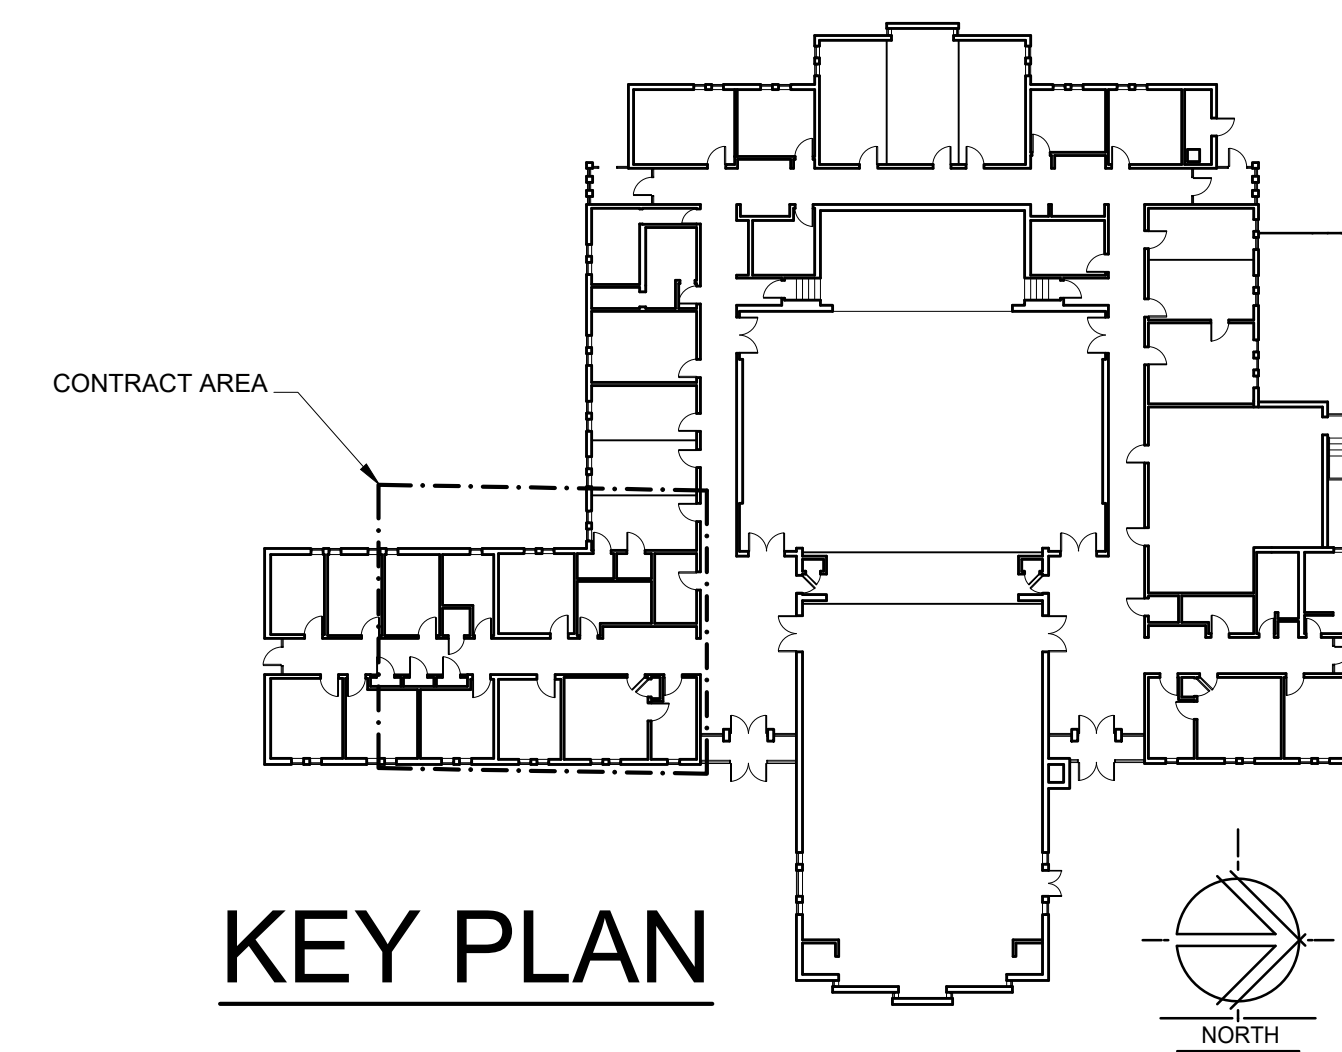


KEY PLAN

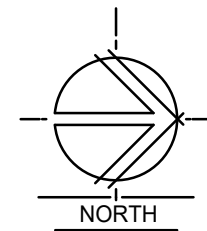


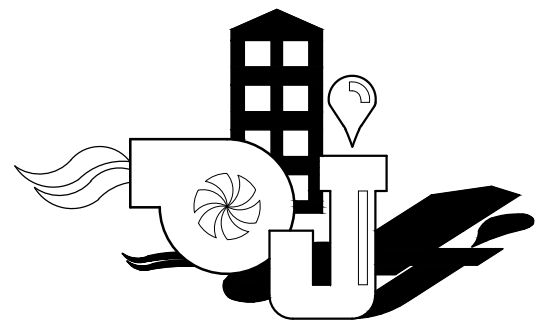


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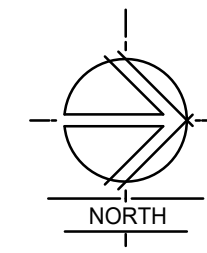
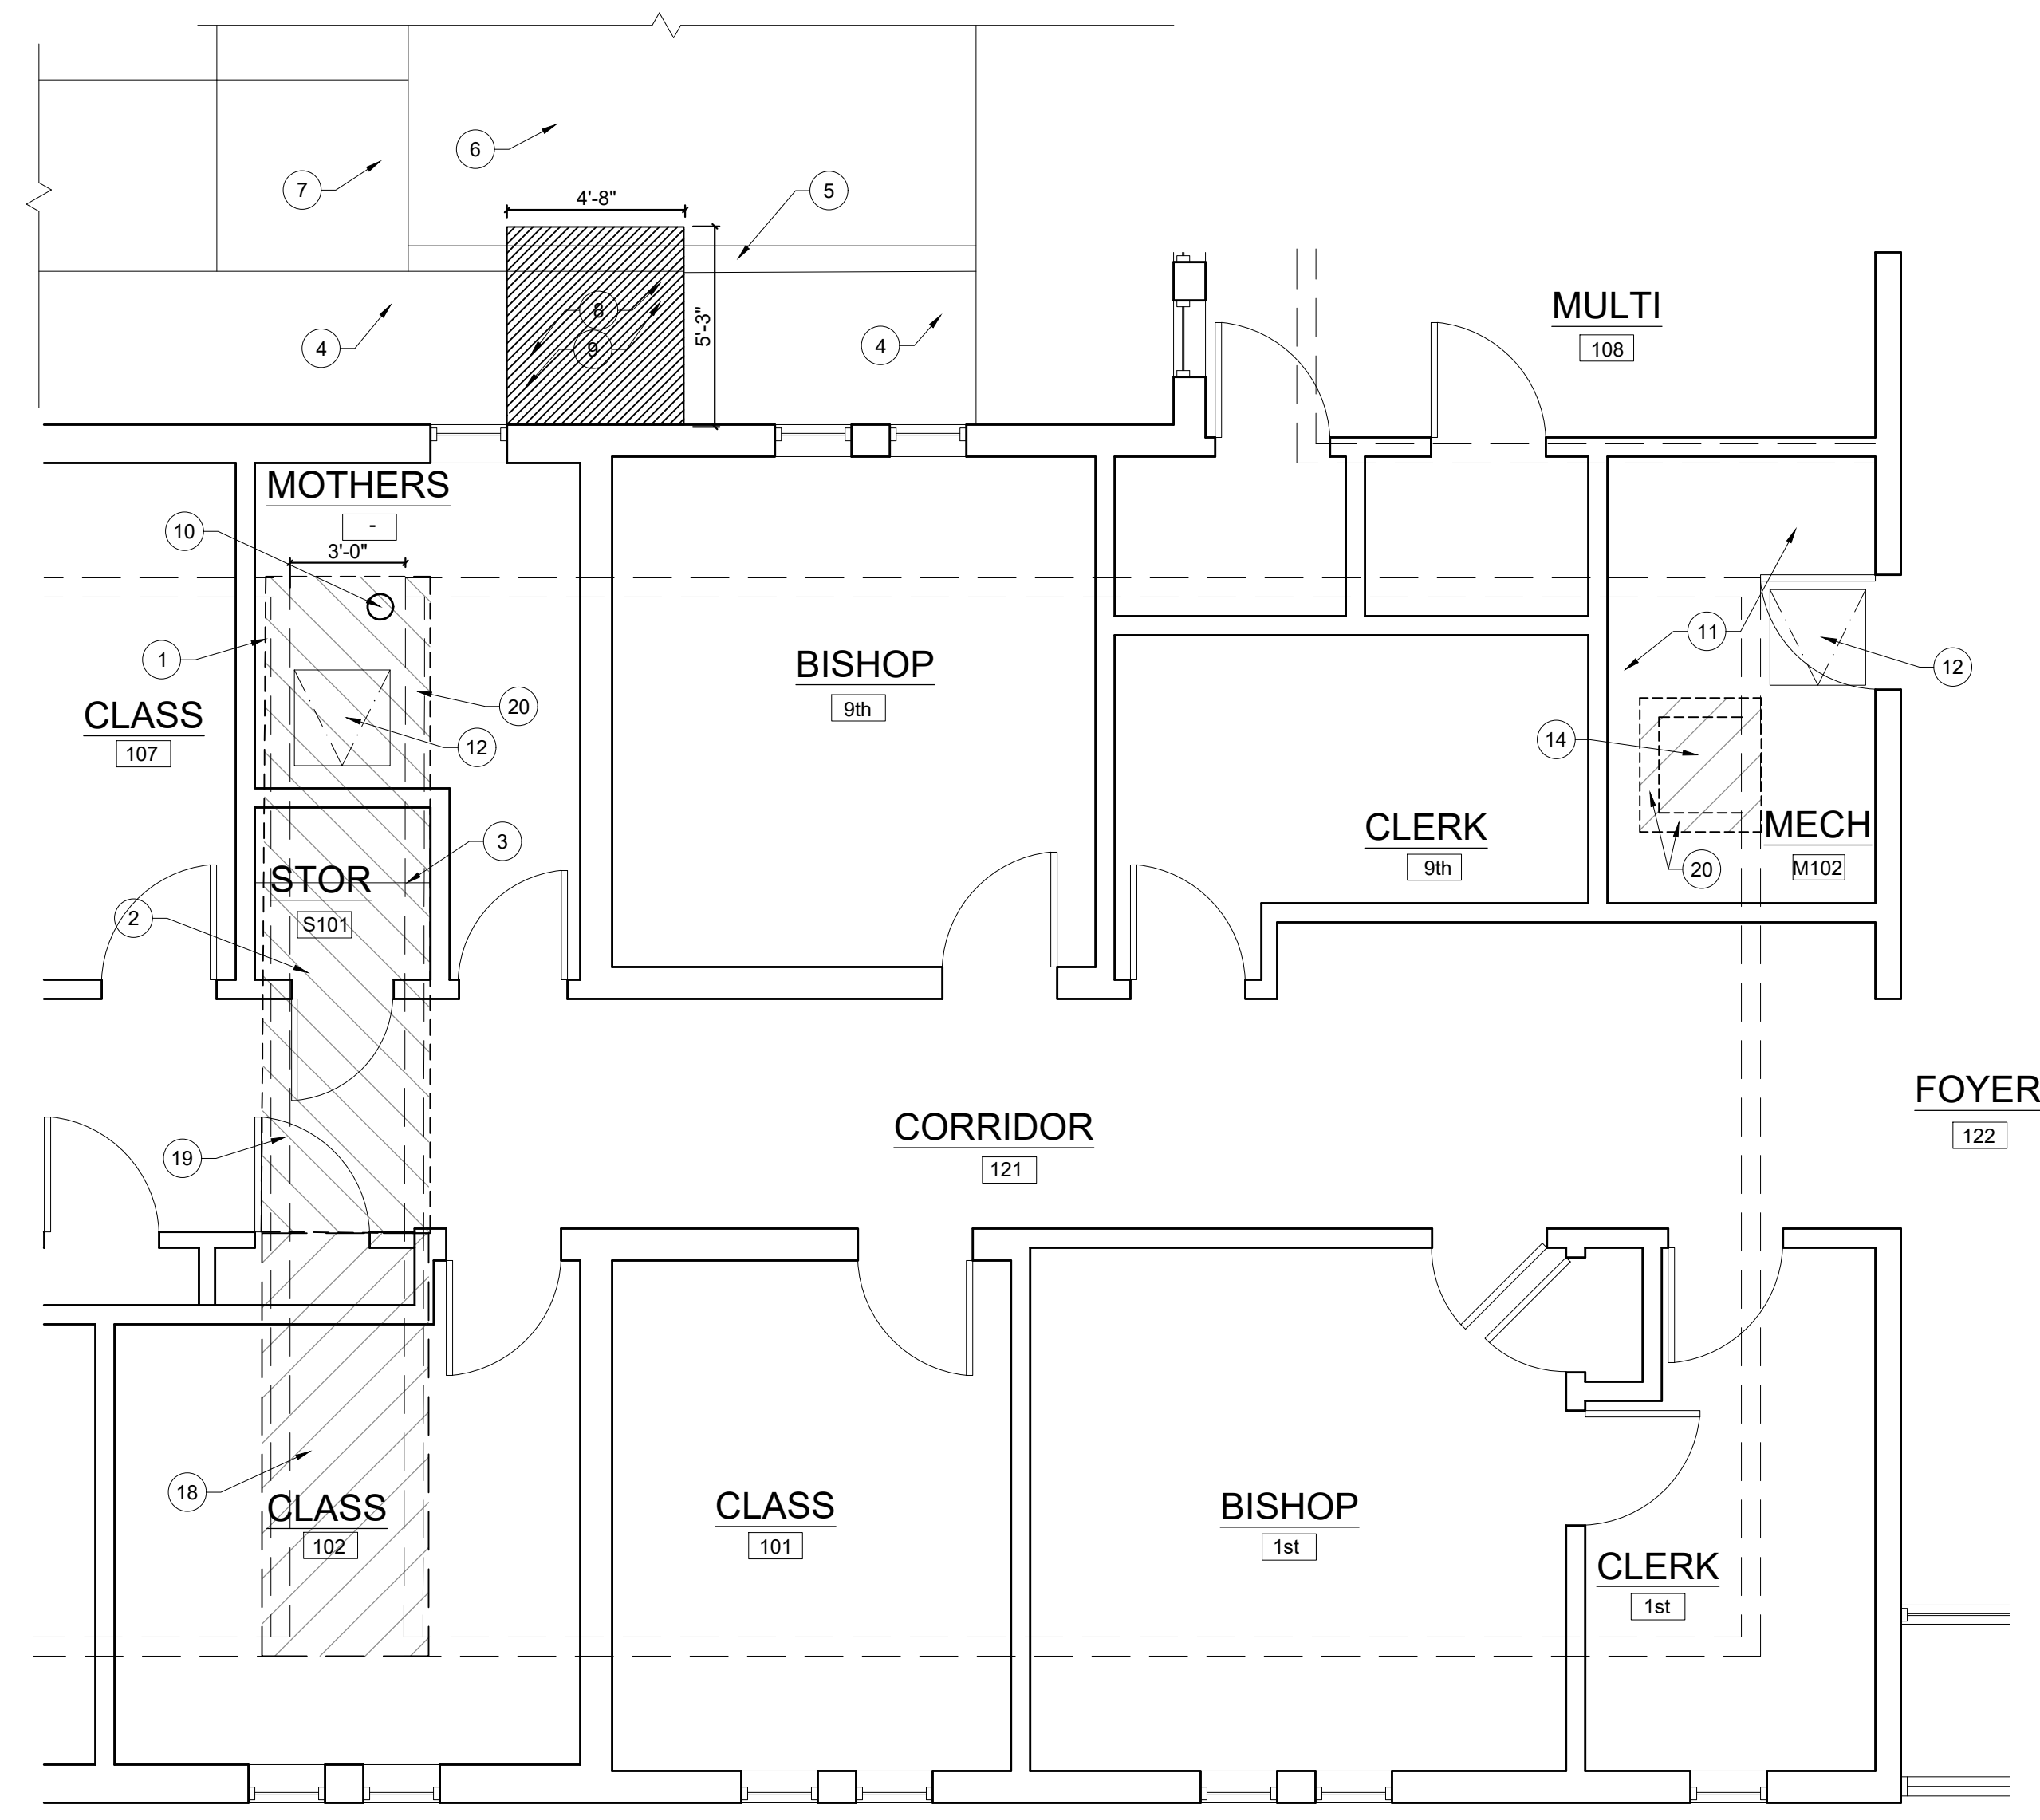


REFLECTED CEILING PLAN

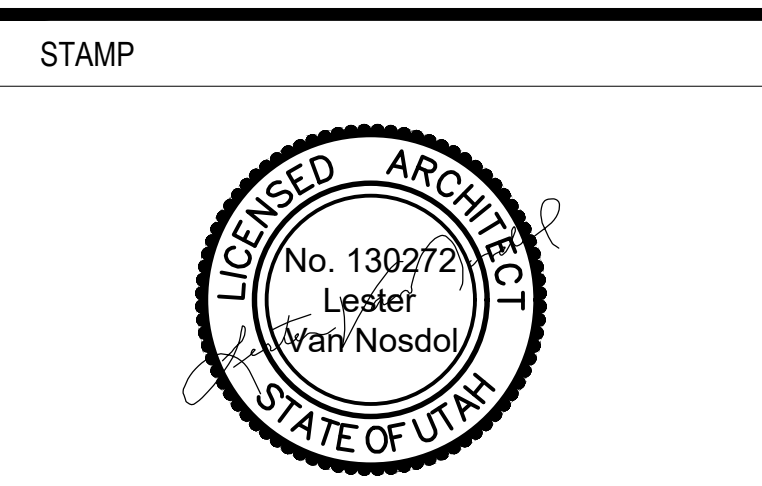SCALE: 1/4" = 1'-0"


NOTES:

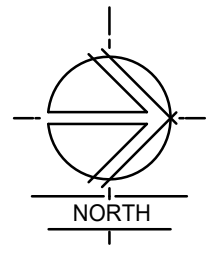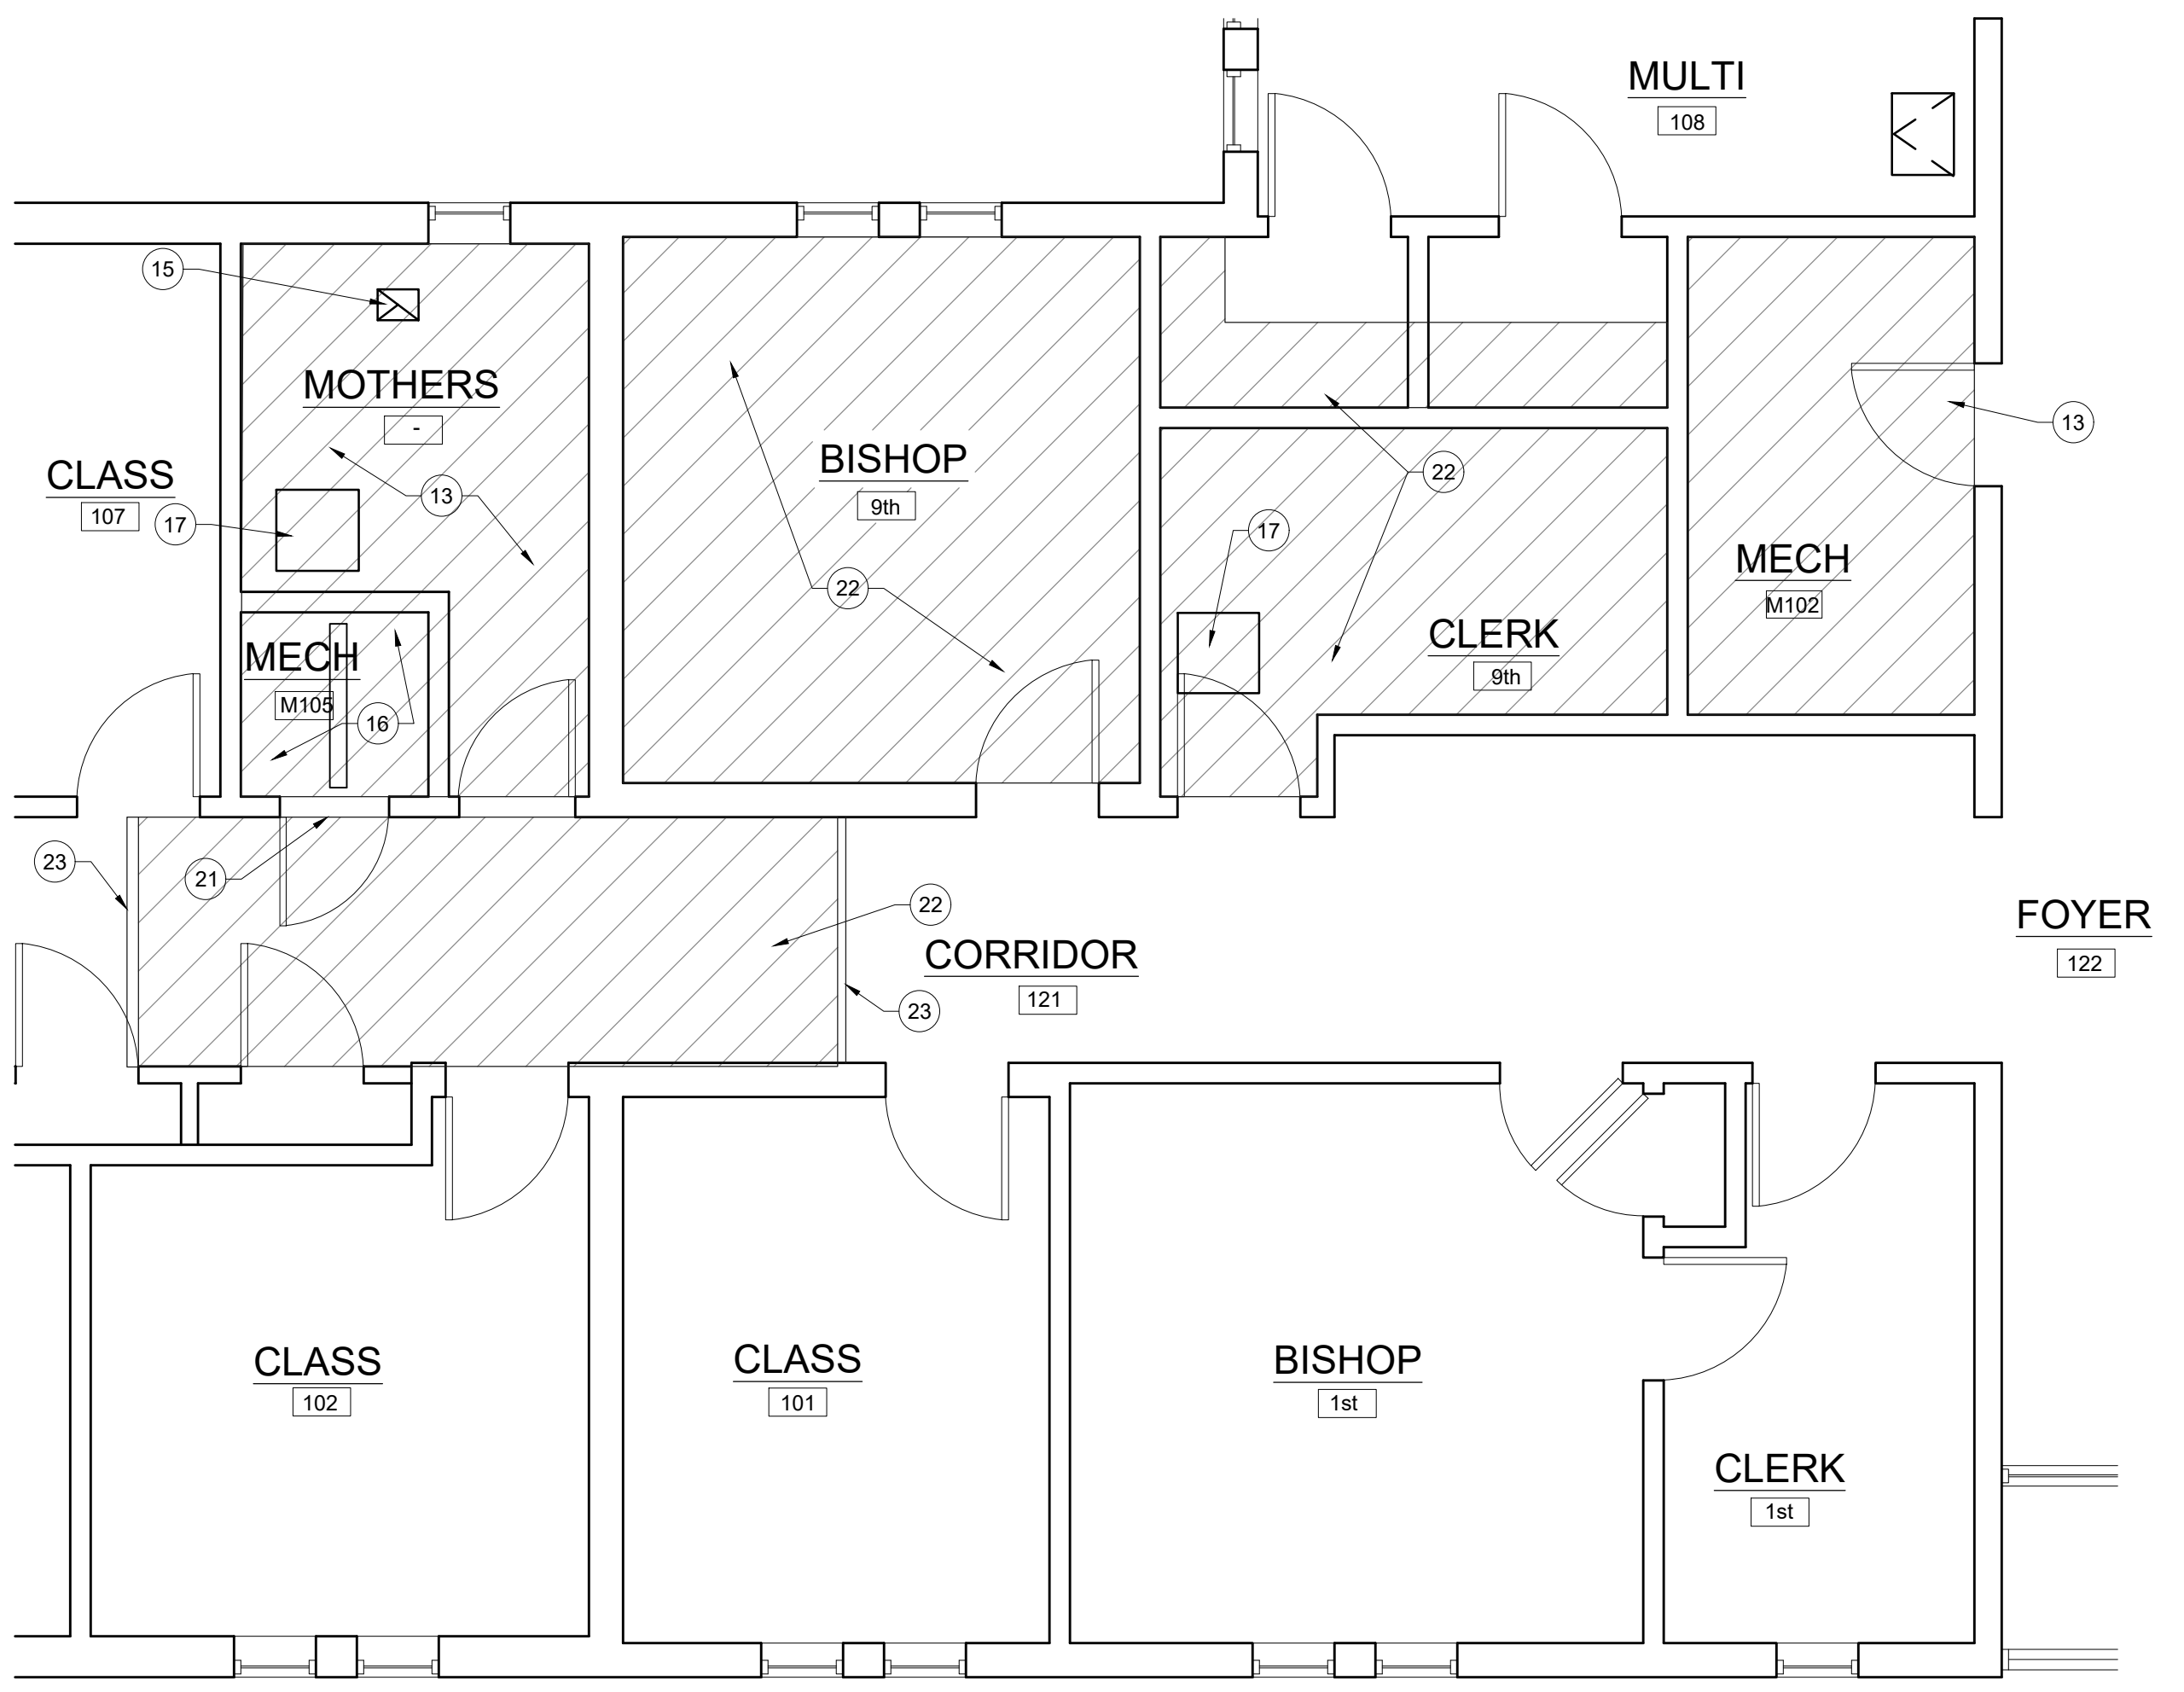1. 4" CONCRETE SLAB ON 'B' DECK. TO BE LEVEL WITH EXISTING CONCRETE FLOOR. PREPARED FOR CARPET INSTALLATION.
2. PAINT FLOOR PRIOR TO EQUIPMENT INSTALLATION. PROVIDE A NEW DOOR THRESHOLD.
3. PATCH ALL HOLES IN WALLS AND PAINT WALLS. COLOR TO MATCH EXISTING.
4. REPLACE DAMAGED PLANTS IN EXISTING PLANTER BED. PLANTS/SHRUBS SHALL MAINTAIN A MINIMUM 36" CLEARANCE BETWEEN THEM AND THE NEW CONDENSING UNIT. REPAIR AND MODIFY SPRINKLER LINES AND HEADS. REROUTE SPRINKLER LINES AROUND NEW CONC. PAD.
5. EXISTING CONCRETE MOW STRIP. REPAIR OR REPLACE ANY DAMAGED MOW STRIP. WHERE MOW STRIP IS INDICATED TO BE REMOVED THE MOW STRIP SHOULD BE SAW CUT FOR A CLEAN CONNECTION WITH NEW CONC. PAD.
6. REPLACE DAMAGED LAWN WITH NEW SOD.
7. REPAIR SIDEWALKS DAMAGED DURING CONSTRUCTION.
8. SEAL SPRINKLER LINES NO LONGER USED. RELOCATE HEADS AS NEEDED. REROUTE SPRINKLER LINES AND CONTROL WIRING IF ANY.
9. NEW 4" CONCRETE PAD ON 4" GRANULAR FILL.
10. NEW CLEAN OUT. COORDINATE WITH PLUMBING CONTRACTOR.
11. PAINT FLOOR WHILE ALL EQUIPMENT HAS BEEN REMOVED.
12. NEW 30" X 30" TUNNEL ACCESS DOOR WITH LATCH IN FLOOR OF MECHANICAL ROOM.
13. INSTALL CEILING/ROOF INSULATION WHERE REMOVED W/R=38. INSTALL NEW GYP. BD. CEILING. TO BE TEXTURED & PAINTED. PAINT TO MATCH EXISTING PAINT COLOR. REINSTALL EXISTING LIGHT FIXTURES AND DEVICES.
14. 4" CONCRETE SLAB ON 'B' DECK. TO BE LEVEL WITH EXISTING CONC. FLOOR.
15. EXISTING EXHAUST FAN TO BE REINSTALLED. SEE MECH. & ELEC. DRAWINGS.
16. INSTALL CEILING/ROOF INSULATION WHERE REMOVED W/R=38. INSTALL NEW GYP. BD. CEILING. TO BE TEXTURED & PAINTED. PAINT TO MATCH EXISTING PAINT COLOR. REINSTALL NEW LIGHT FIXTURES AND DEVICES. SEE ELECTRICAL PLANS.
17. REMODEL AND REINSTALLED CEILING ACCESS.
18. NEW CARPET IN CLASS ROOM. PAINT ALL WALLS AND CEILING. COLOR TO MATCH EXISTING.
19. PREPARE FOR INSTALLATION OF NEW CARPET IN CORRIDOR.
20. 6" FOUNDATION WALL W/ #4 BARS AT 16" O.C. BOTHWAYS.
21. INSTALL NEW DOOR SEAL AROUND EXISTING DOOR.
22. INSTALL CEILING/ROOF INSULATION W/ MIN. R=38 INSULATION. INSTALL NEW CEILING TILE. TILE TO MATCH AS CLOSE AS POSSIBLE. REINSTALL EXISTING LIGHTS AND CEILING MOUNTED DEVICES. COORDINATE WITH ELEC. DRAWINGS.
23. PROVIDE 3 1/2" PAINTED TRIM TO DIVIDE OLD CEILING TILE FROM NEW CEILING TILE.



FLOOR PLAN

SCALE: 1/4" = 1'-0"

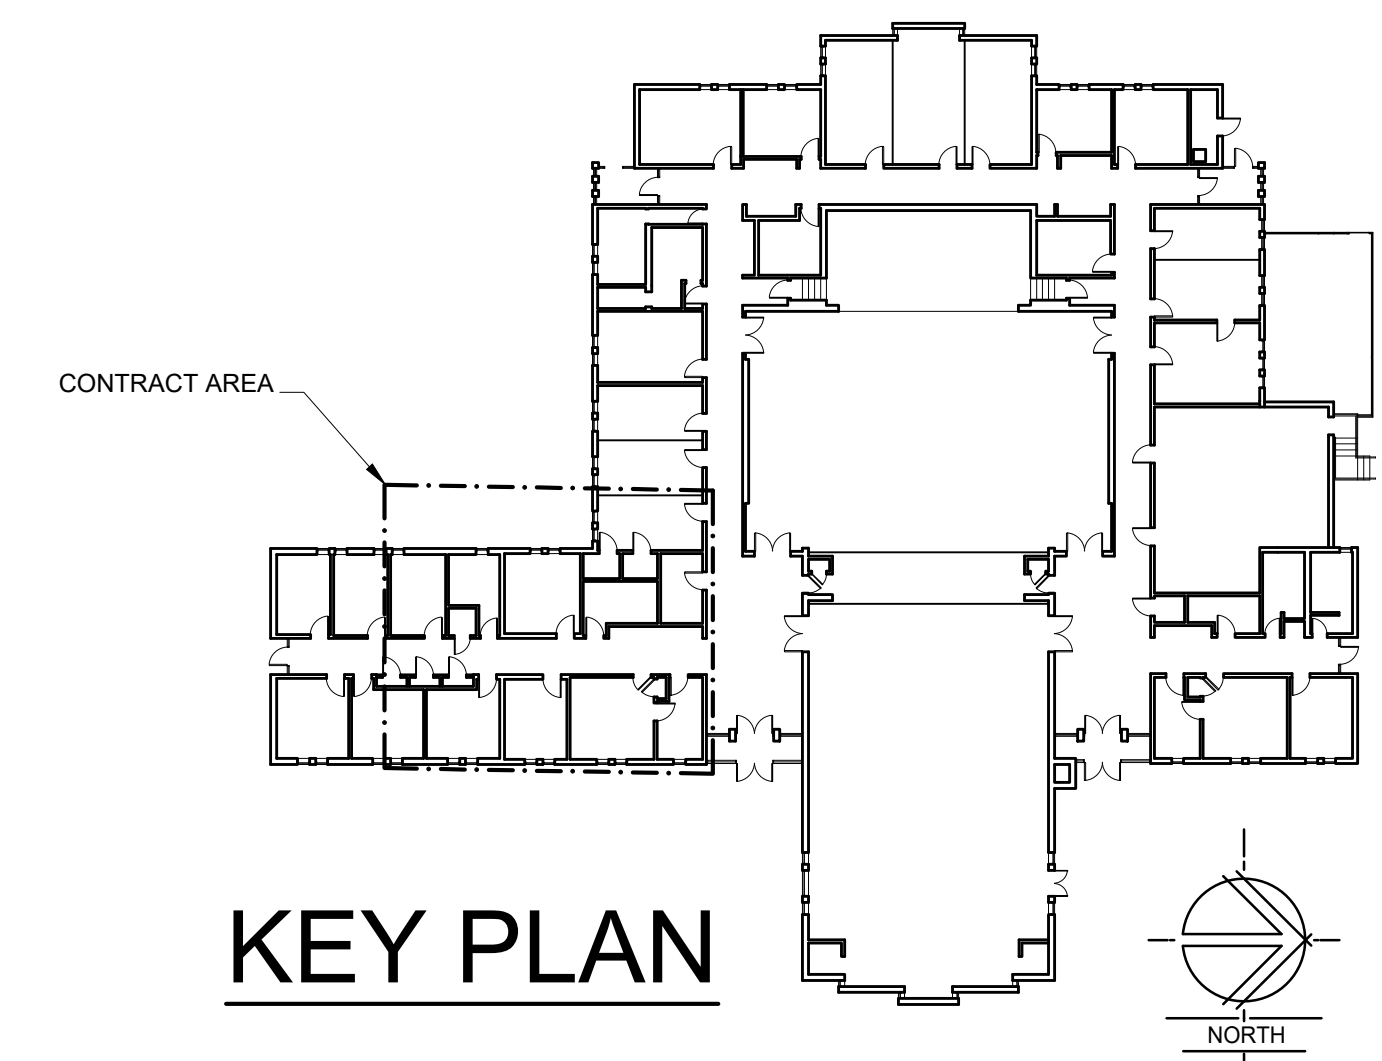

KEY PLAN


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SHEET TITLE
CEILING/FLR PLANS

SHEET NUMBERS
A101




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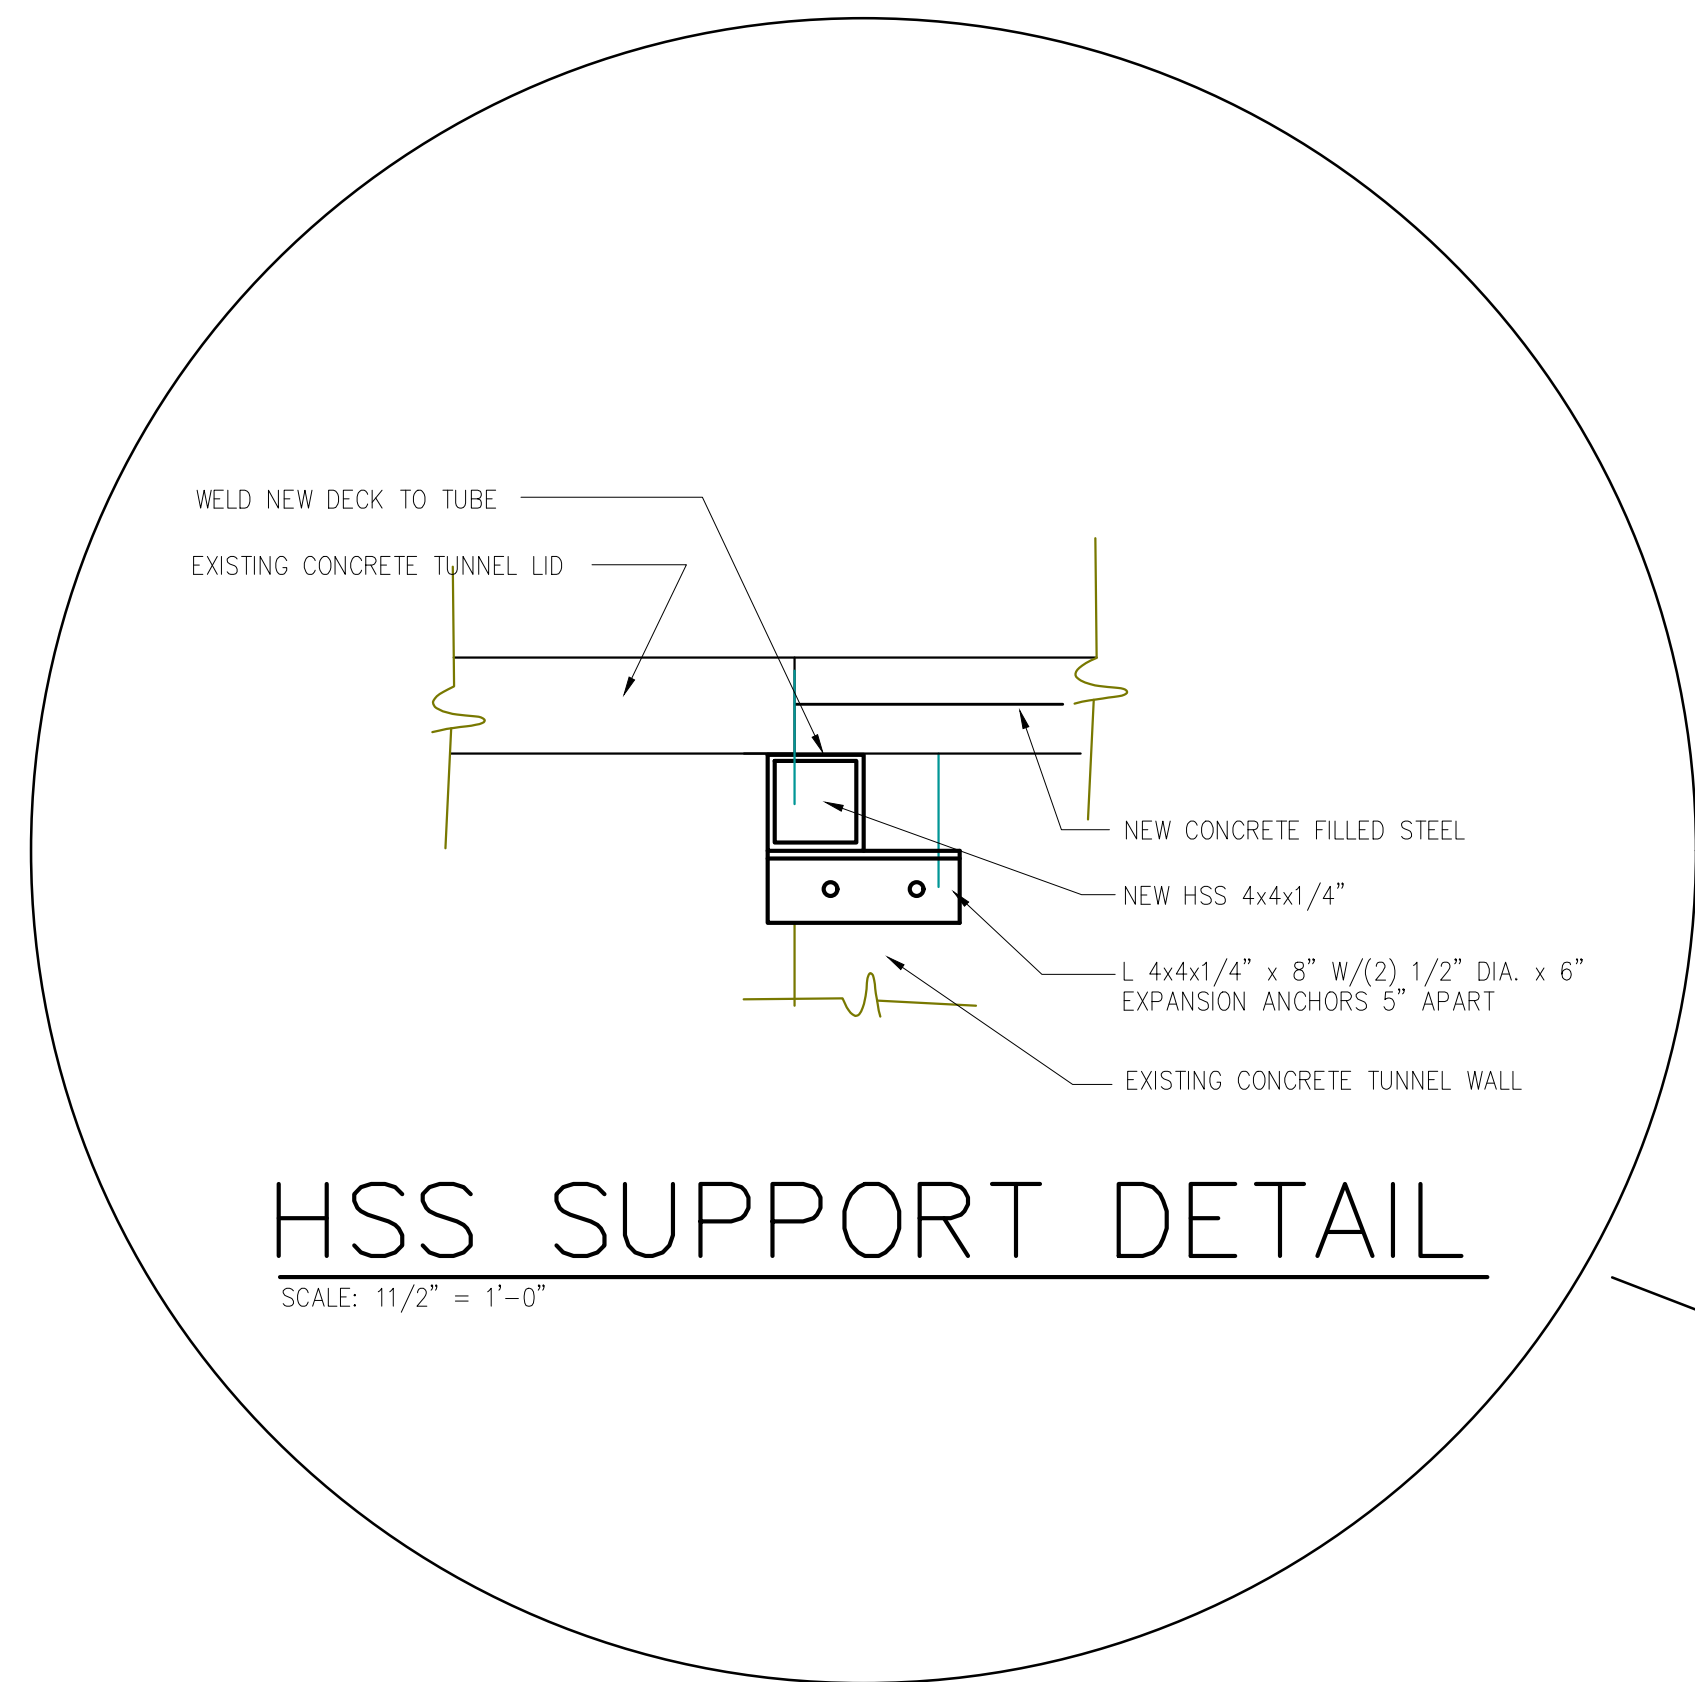
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DETAILS


SHEET NUMBERS

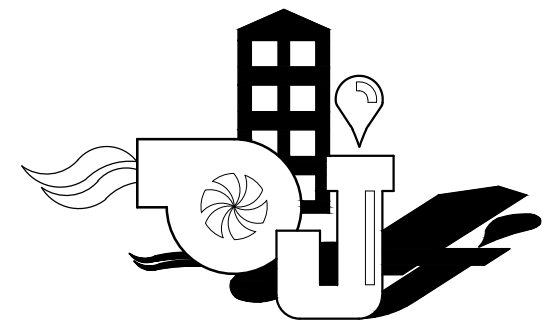A501

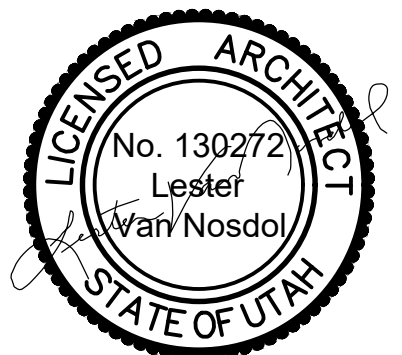

HSS SUPPORT DETAIL

SCALE: 1 1/2" = 1'-0"

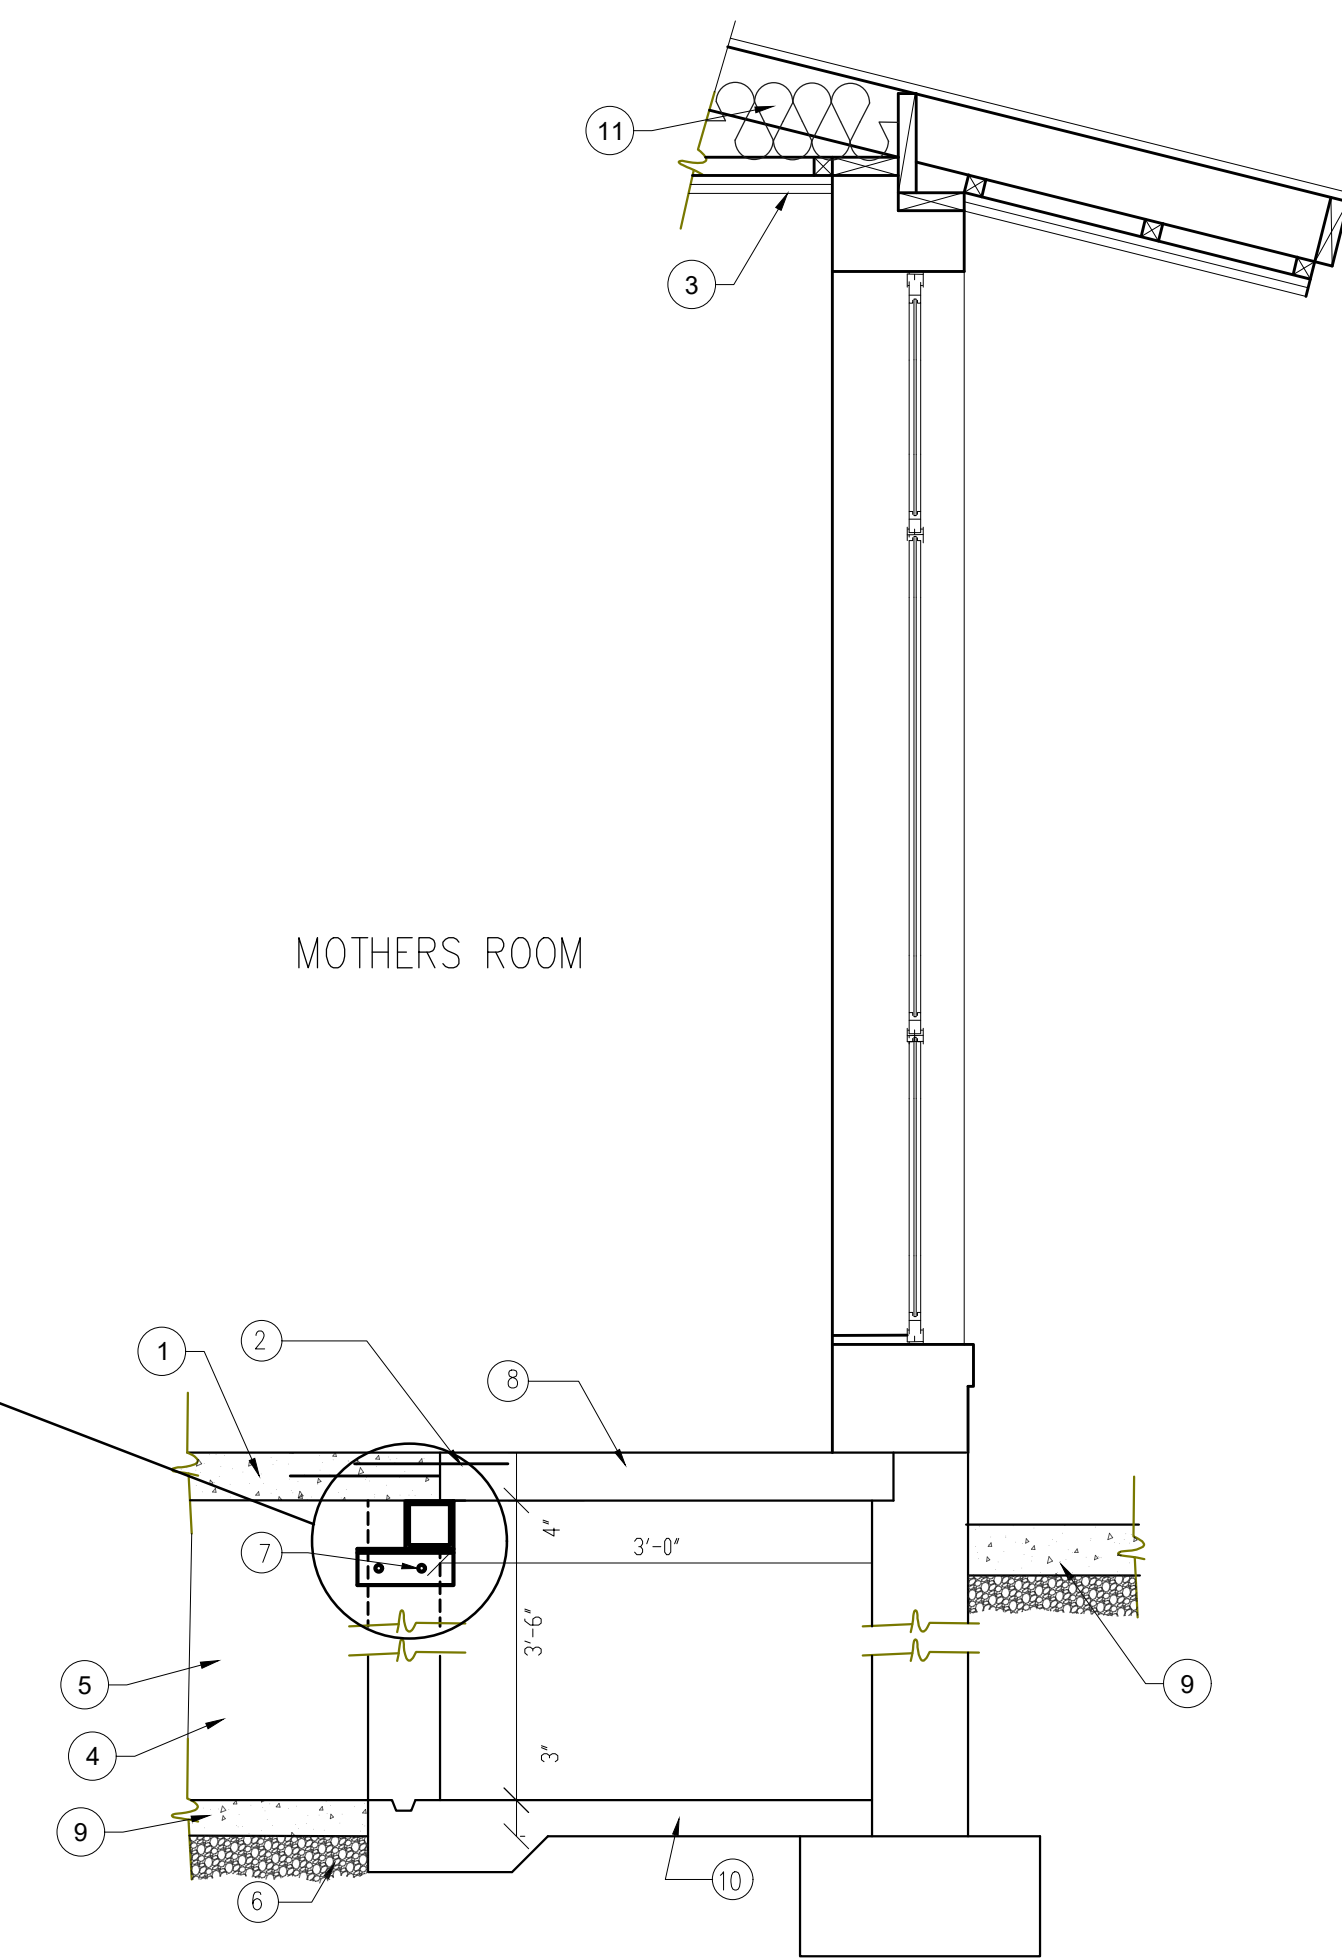


MOTHERS ROOM

SCALE: 3/4" = 1'-0"




GENERAL NOTES:

- 1 4" CONCRETE SLAB ON 2"x18 GA GALVANIZED DECK W/#3 DOWELS @ 15" O.C. B.W.
- 2 #3 BARS DOWELED AND EPOXED INTO EXISTING FOUNDATION WALL @ 18" O.C.
- 3 5/8" TYPE 'X' DRYWALL, TEXTURED AND PAINTED.
- 4 COMPACT SOIL BEHIND NEW 6" FOUNDATION WALL.
- 5 6" FOUNDATION WALL W/#5 BAR AT TOP AND BOTTOM.
- 6 NEW 4" GRANULAR FILL UNDER NEW 4" CONC. TUNNEL FLOOR.
- 7 L3x3x1/4" DECK SUPPORT. ATTACH TO CONCRETE WALL W/1/2" DIA. x 6" EXPANSION ANCHORS AT 24" O.C.
- 8 REMOVE AND REPLACE EXISTING SLAB AS NEEDED FOR CONSTRUCTION OF NEW 6" WALL. DOWEL ALL SLAB EDGES AS PER NOTE(2) ALONG THREE SIDES OF NEW DECK.
- 9 NEW UNREINFORCED 4" SLAB ON GRADE.
- 10 EXISTING TUNNEL FLOOR TO REMAIN
- 11 PROVIDE NEW INSULATION WHERE CEILINGS HAVE BEEN REMOVED. MIN. R=38 OR MAX. VOID WILL ALLOW
- 12 EXISTING CONC. BLOCK WALLS.
- 13 SAW CUT EXISTING CONC. SLAB AND REMOVE.

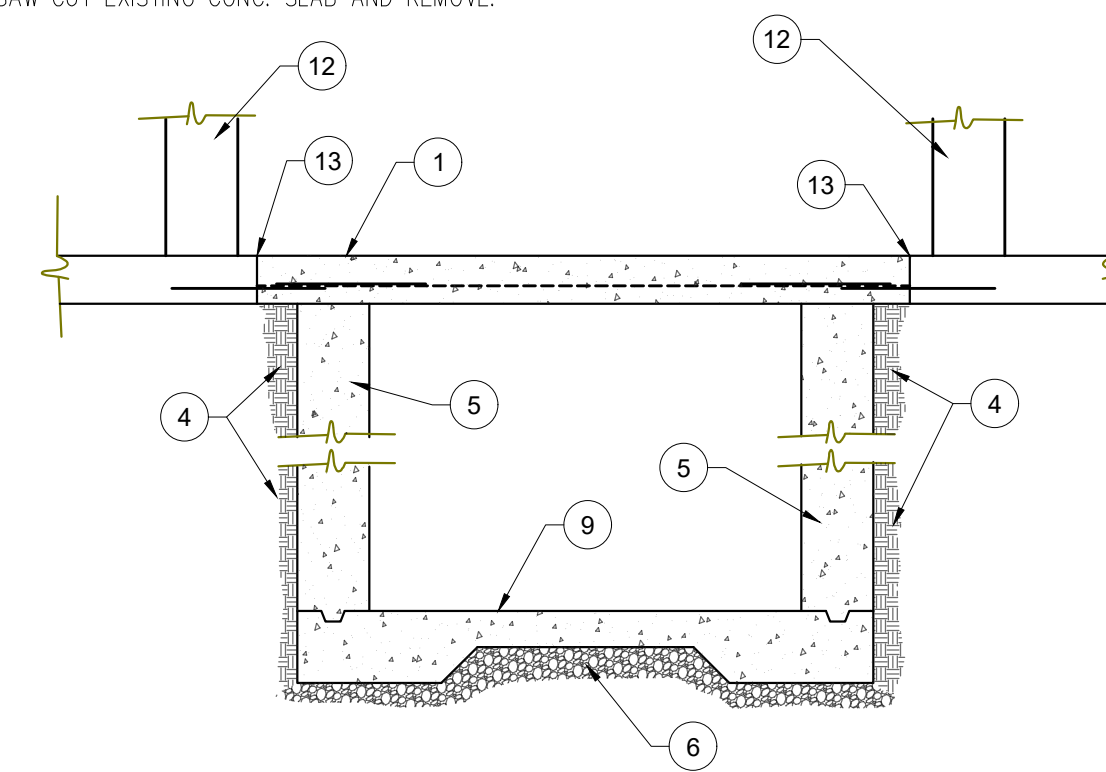

NEW TUNNEL CROSS SECTION

SCALE: 3/4" = 1'-0"

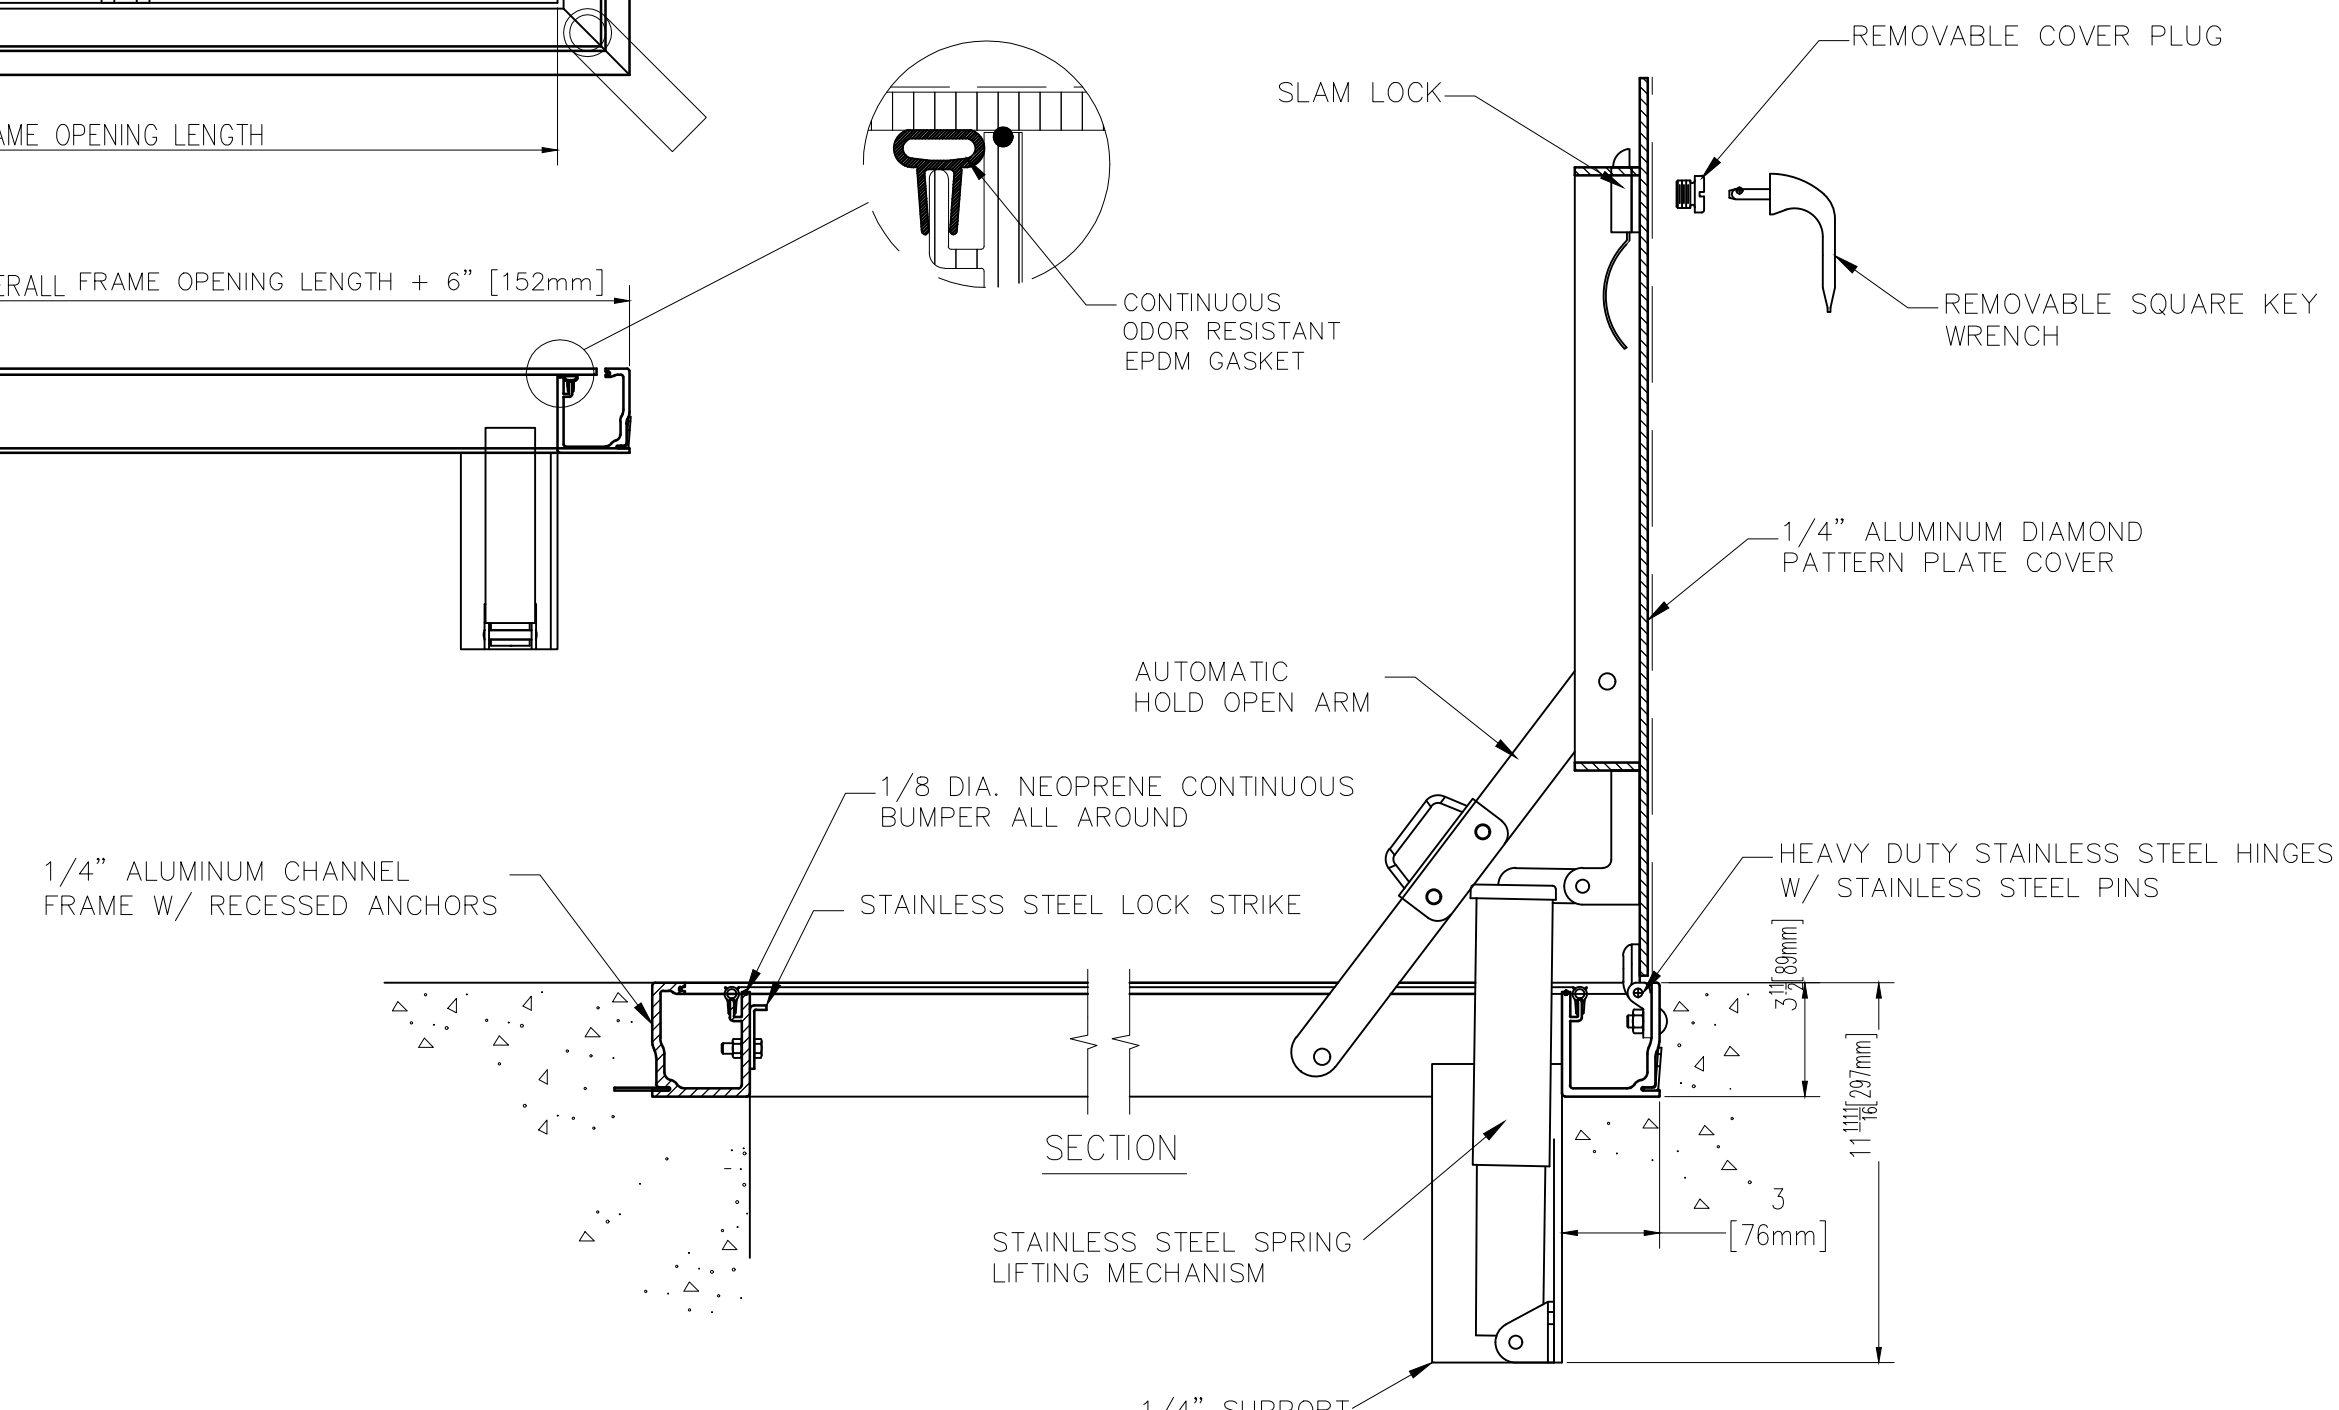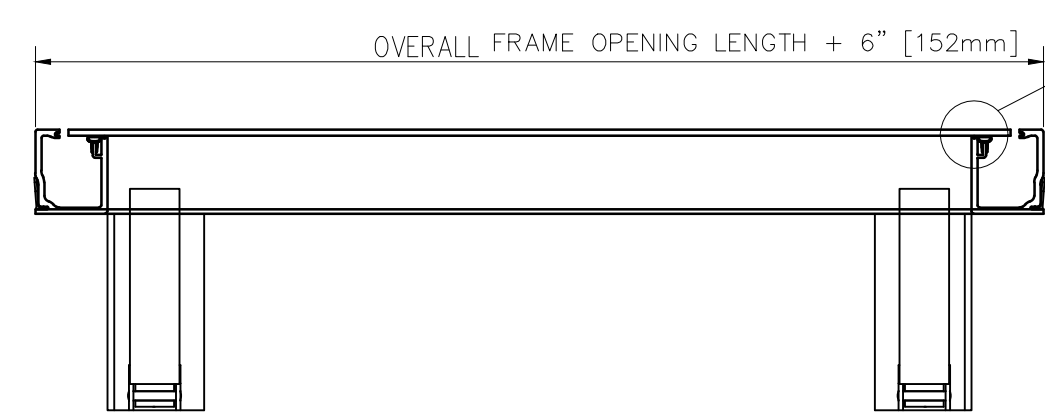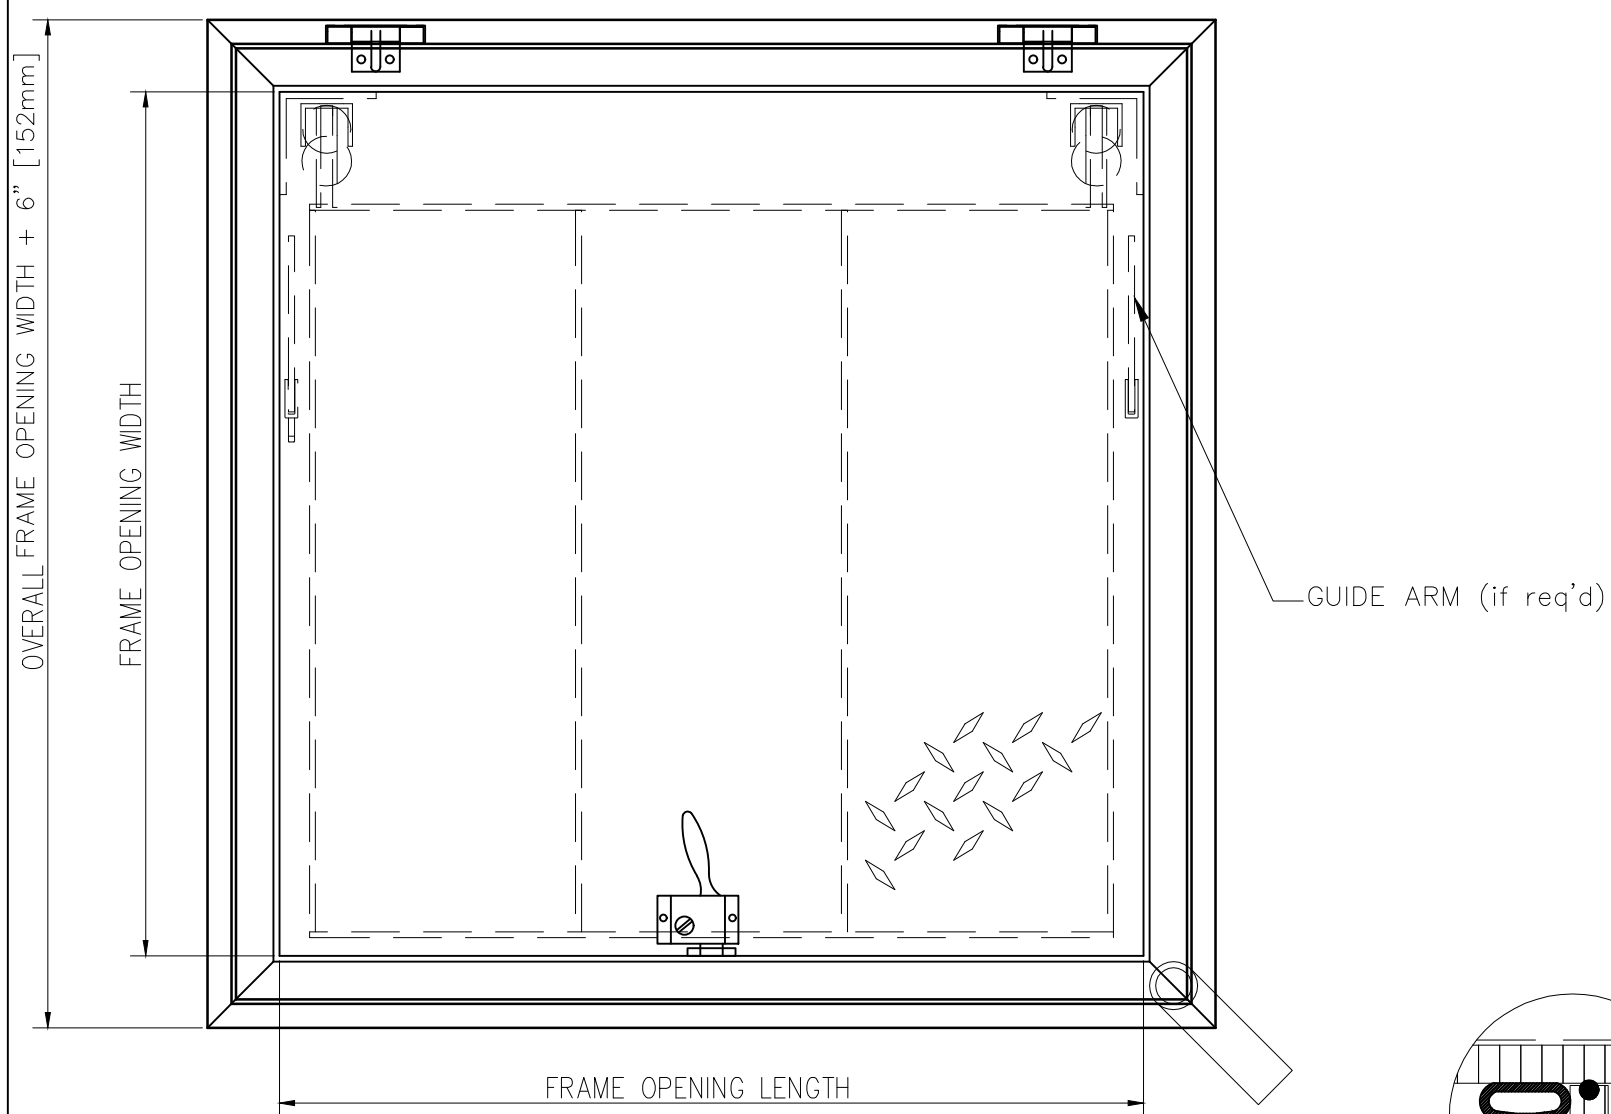

FLOOR ACCESS DOOR

SCALE: 1 1/2" = 1'-0"

HVAC GENERAL NOTES

- CONTRACTOR SHALL FURNISH AND INSTALL ALL ITEMS WHICH ARE OBVIOUSLY AND REASONABLY NECESSARY TO COMPLETE THE INSTALLATION.
- BIDDERS SHALL VISIT THE SITE AND BECOME FAMILIAR WITH EXISTING CONDITIONS SURROUNDING THE PROJECT PRIOR TO BIDDING.
- DRAWINGS ARE DIAGRAMMATIC AND INTENDED TO SHOW APPROXIMATE LOCATIONS.
- ALL MECHANICAL HVAC WORK SHALL BE PERFORMED IN STRICT ACCORDANCE WITH THE LATEST EDITION OF THE PREVAILING STATE MECHANICAL/PLUMBING AND BUILDING CODES AS WELL AS ALL REGULATIONS THAT MAY APPLY. IN CASE OF CONFLICT BETWEEN THE CONTRACT DOCUMENTS AND A GOVERNING CODE OR ORDINANCE THE MORE STRINGENT SHALL APPLY.
- ALL RECTANGULAR SUPPLY DUCT ELBOWS SHALL HAVE TURNING VANES.
- RECTANGULAR DUCT SIZES SHOWN INDICATE REQUIRED AIRFLOW SIZES. SHEETMETAL CONTRACTOR SHALL INCREASE SIZES TO ALLOW FOR LINER.
- NO DUCTWORK SHALL BE FABRICATED WITHOUT FIRST FIELD VERIFYING THAT THE AVAILABLE SPACE UNDER ACTUAL JOB CONDITIONS WILL PERMIT INSTALLATION OF THE DUCTWORK WITHOUT STRUCTURAL OR OTHER CONFLICTS. DUCT SIZES THAT REQUIRE ON THE JOB MODIFICATION DUE TO UNFORESEEN OBSTRUCTIONS SHALL BE MADE WITHOUT ANY ADDITIONAL COST TO THE OWNER.


MECHANICAL ABBREVIATIONS

AD	ACCESS DOOR	DEMO	DEMOLITION	HTG	HEATING	PRV	PRESSURE REDUCING VALVE
AFF	ABOVE FINISHED FLOOR	DET	DETAIL	HVAC	HEATING, VENTILATING & AIR CONDITIONING	PSI	POUNDS PER SQUARE INCH QUANTITY
AHU	AIR HANDLING UNIT	DH	DUCT HEATER	HW	HOT WATER	RA	RETURN AIR
ALT	ALTERNATE	DIA	DIAMETER	HWR	HOT WATER HEATING RETURN	RAD	RADIATED
AMB	AMBIENT	DIM	DIMENSION	HWS	HOT WATER HEATING SUPPLY	RCP	RECIRCULATION PUMP
AMP	AMPERE	DIV	DIVISION	HZ	HERTZ	REF	ROOFTOP EXHAUST FAN
ANSI	AMERICAN NATIONAL STANDARDS INSTITUTE	DMPR	DAMPEN	IN	INCHES	REQD	REQUIRED
APD	AIR PRESSURE DROP	DN	DOWN	INWC	INCHES OF WATER COLUMN	REV	REVISION
APPROX	APPROXIMATE	DS	DOWNSPOUT	INWG	INCHES OF WATER GAUGE	RH	RELATIVE HUMIDITY
ASME	AMERICAN SOCIETY OF MECHANICAL ENGINEERS	EA	EXHAUST AIR	IU	INDOOR UNIT	RL	REFRIGERANT LIQUID
ASL	ABOVE SEA LEVEL	EAT	ENTERING AIR TEMPERATURE	KW	KILOWATT	RS	REFRIGERANT SUCTION
AVG	AVERAGE	EF	EXHAUST FAN	LAT	LEAVING AIR TEMPERATURE	RPBP	REDUCED PRESSURE BACKFLOW PREVENTER
B	BOILER	EFF	EFFICIENCY	LB	POUND	RPM	REVOLUTIONS PER MINUTE
BOD	BOTTOM OF DUCT	EQ	EQUAL	LPC	LOW PRESSURE CONDENSATE	SA	SUPPLY AIR
BOP	BOTTOM OF PIPE	EQUIP	EQUIPMENT	LPS	LOW PRESSURE STEAM	SCHE	SCHEDULE
BTU	BRITISH THERMAL UNIT	ERV	ENERGY RECOVERY VENTILATION	LVT	LEAVING WATER TEMPERATURE	SEN	SENSIBLE
BTUH	BTU PER HOUR	ESP	EXTERNAL STATIC PRESSURE	MAU	MAKEUP AIR UNIT	SL	SEA LEVEL
C	COMMON	ET	EXPANSION TANK	MAX	MAXIMUM	SSHP	SPLIT SYSTEM HEAT PUMP
C	CONVECTOR	EWT	ENTERING WATER TEMPERATURE	MBH	THOUSAND BRITISH THERMAL UNITS/HOUR	STD	STANDARD
CA	COMBUSTION AIR	EXH	EXHAUST	MECH	MECHANICAL	TEMP	TEMPERATURE
CAP	CAPACITY	EXT	EXISTING	MECH RM	MECHANICAL ROOM	TSP	TOTAL STATIC PRESSURE
CC	COOLING COIL	F	FAHRENHEIT	MFR	MANUFACTURER	TSTAT	THERMOSTAT
CEF	CEILING MTD EXHAUST FAN	F	FURNACE	MIN	MINIMUM	TW	TEMPERED WATER
CFM	CUBIC FEET PER MINUTE	FCU	FAN COIL UNIT	MISC	MISCELLANEOUS	TYP	TYPICAL
CHWR	CHILLED WATER RETURN	FLR	FLOOR	MTD	MOUNTED	UH	UNIT HEATER
CHWS	CHILLED WATER SUPPLY	FLEX	FLEXIBLE	NC	NOISE CRITERIA	V	VOLT
CO2	CARBON DIOXIDE	FO	FLAT OVAL	NOM	NOMINAL	VAV	VARIABLE AIR VOLUME
COMB	COMBUSTION	FPM	FEET PER MINUTE	NTS	NOT TO SCALE	VD	VOLUME DAMPER
CONTR	CONTRACTOR	FPVAV	FAN POWERED VAV	OA	OUTSIDE AIR	VERT	VERTICAL
CU	CONDENSING UNIT	FT	FEET	OBD	OPPOSED BLADE DAMPER	VFD	VARIABLE FREQUENCY DRIVE
CU FT	CUBIC FEET	GALV	GALVANIZED	OU	OUTDOOR UNIT	VOL	VOLUME DAMPER
CU YD	CUBIC YARDS	GPM	GALLONS PER MINUTE	P	PUMP	W	WITH
CUH	CABINET UNIT HEATER	GHR	GLYCOL HEATING RETURN	PCF	POUNDS PER CUBIC FEET	W/O	WITHOUT
CV	CONSTANT VOLUME	GHS	GLYCOL HEATING SUPPLY	PD	PRESSURE DROP	WB	WET BULB
CW	COLD WATER	H	FUME HOOD	PERF	PERFORATE(D)	WPD	WATER PRESSURE DROP
CWR	CONDENSOR WATER RETURN	HORIZ	HORIZONTAL	PH	PHASE		
CWS	CONDENSOR WATER SUPPLY	HP	HIGH PRESSURE	PLUM	PLUMBING		
DB	DRY BULB	HP	HORSEPOWER	PPM	PARTS PER MILLION		
DD	DUAL DUCT BOX	HP	HEAT PUMP				
DEG	DEGREE FAHRENHEIT	HPS	HIGH PRESSURE STEAM				
		HR	HOUR				

MECHANICAL LEGEND

NOTE: NEW ITEMS SHOWN DARK, EXISTING ITEMS SHOWN LIGHT. ALL ITEMS MAY NOT APPEAR ON DRAWINGS.


SYMBOL	DESCRIPTION	SYMBOL	DESCRIPTION	SYMBOL	DESCRIPTION
	AUTOMATIC 2-WAY VALVE		IMMERSION WELL		BRANCH DUCT TAKE-OFF WITH MANUAL DAMPER
	AUTOMATIC 3-WAY VALVE		INLINE PUMP		DUCT FLEXIBLE CONNECTION
	AUTOMATIC BALL FLOAT VENT		MANUAL VENT WITH BALL VALVE		TURNING VANES
	BALL VALVE		P & T PLUG IN IMMERSION WELL		DUCT TEE CONNECTION
	CAPPED END W/BALL VALVE		PIPE DROP		DUCT TRANSITION
	CHECK VALVE		PIPE INLINE DROP		SQUARE TO ROUND DUCT TRANSITION
	COMBINATION BALANCING VALVE/ SHUTOFF		PIPE INLINE RISE		AUTOMATIC DAMPER
	DEVICE IN DROP		PIPE RISER		VOLUME DAMPER
	DIRECTION OF SLOPE		PNEUMATIC 2-WAY VALVE		BACK-DRAFT DAMPER
	FLANGED BUTTERFLY VALVE		PRESSURE GAUGE		DUCT ACCESS DOOR
	FLANGED ECCENTRIC REDUCER		PRESSURE GAGE W/BALL VALVE		RETURN AIR, RISE AND DROP
	FLANGED UNION		RELIEF VALVE		SUPPLY AIR, RISE AND DROP
	FLEXIBLE CONNECTION		SCREWED CONCENTRIC REDUCER		EXHAUST AIR, RISE AND DROP
	FLOW DIRECTION		STEAM TRAP		OUTSIDE AIR, RISE AND DROP
	FLOW METER		STRAINER		RELIEF AIR, RISE AND DROP
	GATE VALVE		THERMOMETER		ROUND DUCT, RISE AND DROP
	GLOBE VALVE		THREADED HOSE CONNECTION		FLAT OVAL DUCT, RISE AND DROP
	REFRIGERANT PIPING - LIQUID		UNION		FLAT OVAL DUCT
	REFRIGERANT PIPING - SUCTION		VENTURI		FIRE DAMPER
	REFRIGERANT SHUT-OFF VALVE		WATER FLOW SWITCH		FIRE SMOKE DAMPER
	EXPANSION VALVE		CONDENSER WATER SUPPLY		THERMOSTAT
	MOISTURE INDICATING SIGHT GLASS		CONDENSER WATER RETURN		SENSOR
	FLEXIBLE CONNECTION		CHILLED WATER SUPPLY		J-BOX
	FILTER DRIER		CHILLED WATER RETURN		AIR DEVICE
	PIPE SUPPORT		HOT WATER HTG. SUPPLY		AIR DEVICE CFM
	EXTERIOR PIPE SUPPORT		HOT WATER HTG. RETURN		KEYED NOTE
	EXTERIOR PIPE SUPPORT		HIGH PRESSURE STEAM PIPING		EQUIPMENT CALLOUT
	DIRECTION OF SLOPE DOWN		LOW PRESSURE STEAM PIPING		DETAIL NUMBER SHEET DETAIL APPEARS
	SUCTION LINE		LOW PRESSURE CONDENSATE PIPING		LARGE SCALE NUMBER SHEET LARGE SCALE APPEARS
	LIQUID LINE		GLYCOL HEATING SUPPLY PIPING		AIR FLOW DIRECTION
	TRAP. ONE PIECE FACTORY FABRICATED		GLYCOL HEATING RETURN PIPING		SECTION LETTER SHEET NUMBER
			WASTE PIPING (ABOVE GRADE OR FLOOR)		ROOM NAME ROOM NUMBER
			WASTE PIPING (BELOW GRADE OR FLOOR)		REVISION DELTA
					NEW CONNECTION
					ACCESS DOOR

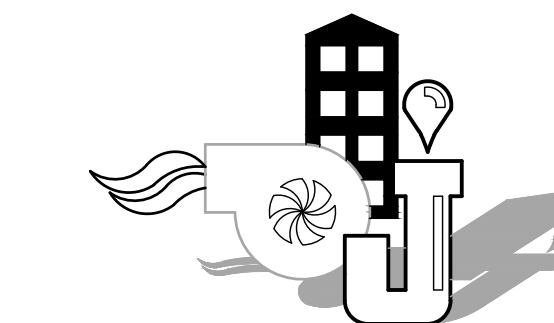

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CONSULTANTS

STAMP

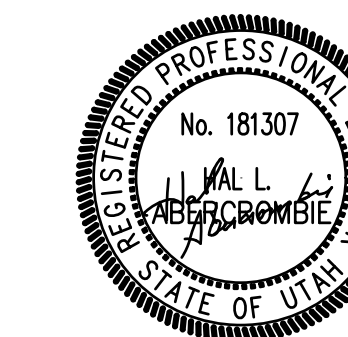

PROJECT FOR

SALEM 1, 2 & 9 WARDS

SALEM UT WEST STAKE

PROPERTY NUMBER: 505056119010101

60 SOUTH MAIN STREET

SALEM, UTAH 84653

MARK	DATE	DESCRIPTION
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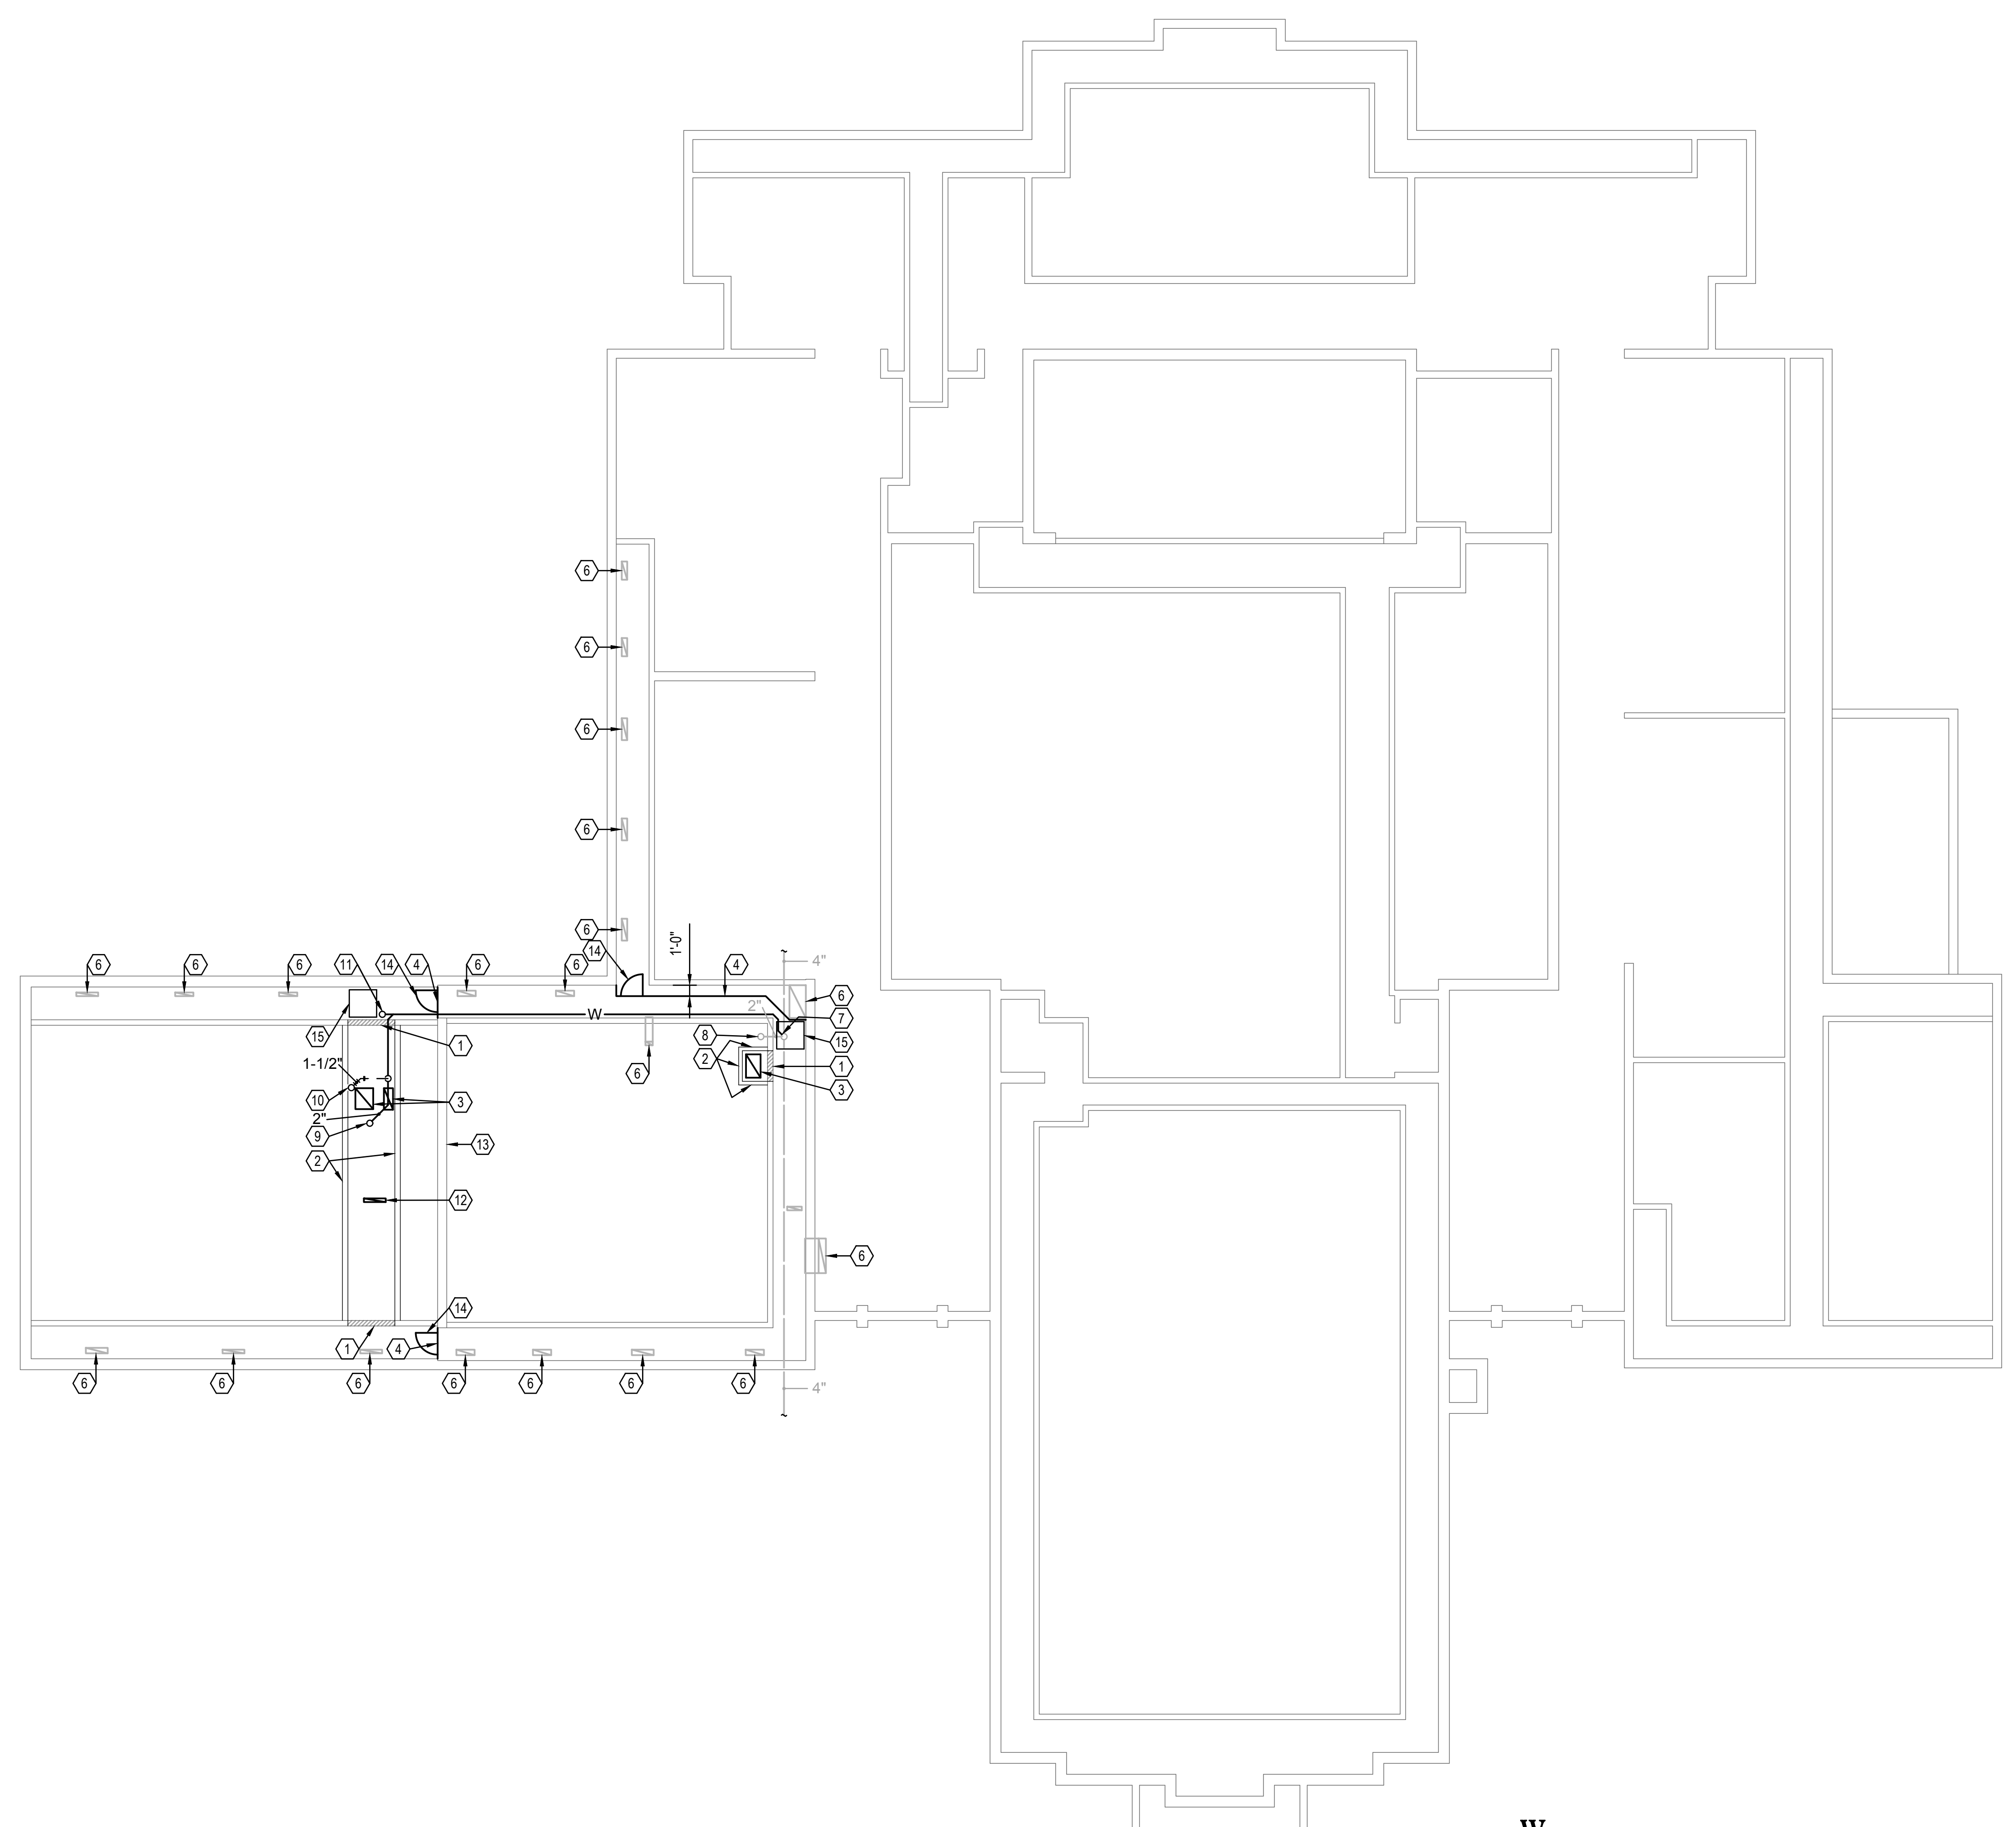
ISSUE TYPE: **CONSTRUCTION DOCUMENTS**
ISSUE DATE: JUNE 18, 2020
PROJECT NO: 18107
CAD DWG FILE: I:\JOBS2018\18107\CAD\SCM001.DWG
DRAWN BY: BDA
CHECKED BY: HLA

SHEET TITLE

MECHANICAL LEGEND AND GENERAL NOTES


SHEET NUMBERS

M001



KEYED NOTES FOR SHEET M101

- ① SAW CUT EXISTING TUNNEL WALL FROM FLOOR LEVEL TO BOTTOM OF TUNNEL AT LOCATION SHOWN HATCHED. SEE ARCHITECTS PLANS FOR FURTHER DETAIL.
- ② NEW TUNNEL LOCATION, MATCH EXISTING TUNNEL HEIGHT. SEE ARCHITECTS PLANS FOR FURTHER DETAIL.
- ③ NEW OPENINGS IN FLOOR FOR DUCTWORK TO FURNACE SYSTEM. SEE SHEET M401 FOR SIZING.
- ④ INSTALL NEW SHEET METAL PARTITION IN TUNNEL SEALED AIR TIGHT.
- ⑤ OMIT.
- ⑥ EXISTING OPENING IN FLOOR INTO TUNNEL.
- ⑦ CONTRACTOR TO FIELD VERIFY THIS LOCATION FOR PROPER SLOPE AND CONNECTION TO EXISTING WASTE PIPING BEFORE PROCEEDING WITH ORDERING OF MATERIALS OR BEGINNING WORK. CONTACT ENGINEER WITH FINDINGS.
- ⑧ EXISTING WASTE PIPE UP TO FLOOR DRAIN IN MECHANICAL ROOM.
- ⑨ NEW WASTE PIPE RISE UP TO FLOOR DRAIN.
- ⑩ NEW VENT PIPING RISE UP TO MECHANICAL ROOM.
- ⑪ NEW WASTE PIPING RISE UP TO FLOOR CLEAN OUT.
- ⑫ NEW OPENING IN CONCRETE FLOOR FOR NEW GRILLE, SEE SHEET M401 FOR SIZING AND ARCHITECTS PLANS FOR FURTHER DETAIL.
- ⑬ ORIGINAL FOUNDATION WALL.
- ⑭ 24"X24" SHEET METAL LOCKING DOOR IN PARTITION.
- ⑮ INSTALL NEW 30X30 ACCESS DOOR INTO TUNNEL WITH LATCH. SEE ARCHITECTS PLANS FOR FURTHER DETAIL.

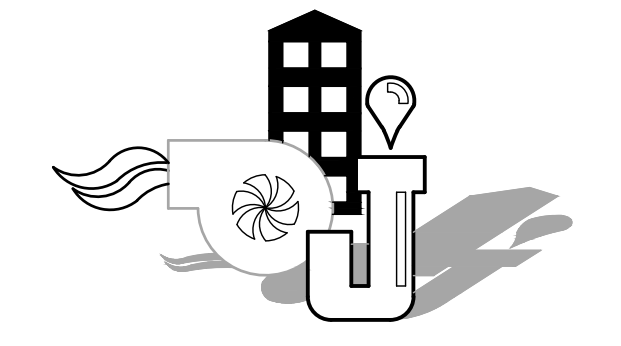

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 PROPERTY NUMBER: 505056119010101
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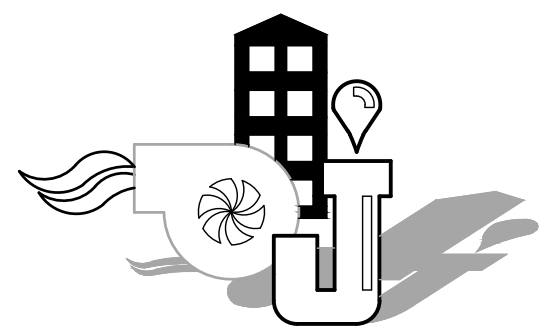
MECHANICAL TUNNEL PLAN

SHEET NUMBERS

M101

1 MECHANICAL TUNNEL PLAN
 SCALE: 1/8"=1'-0"





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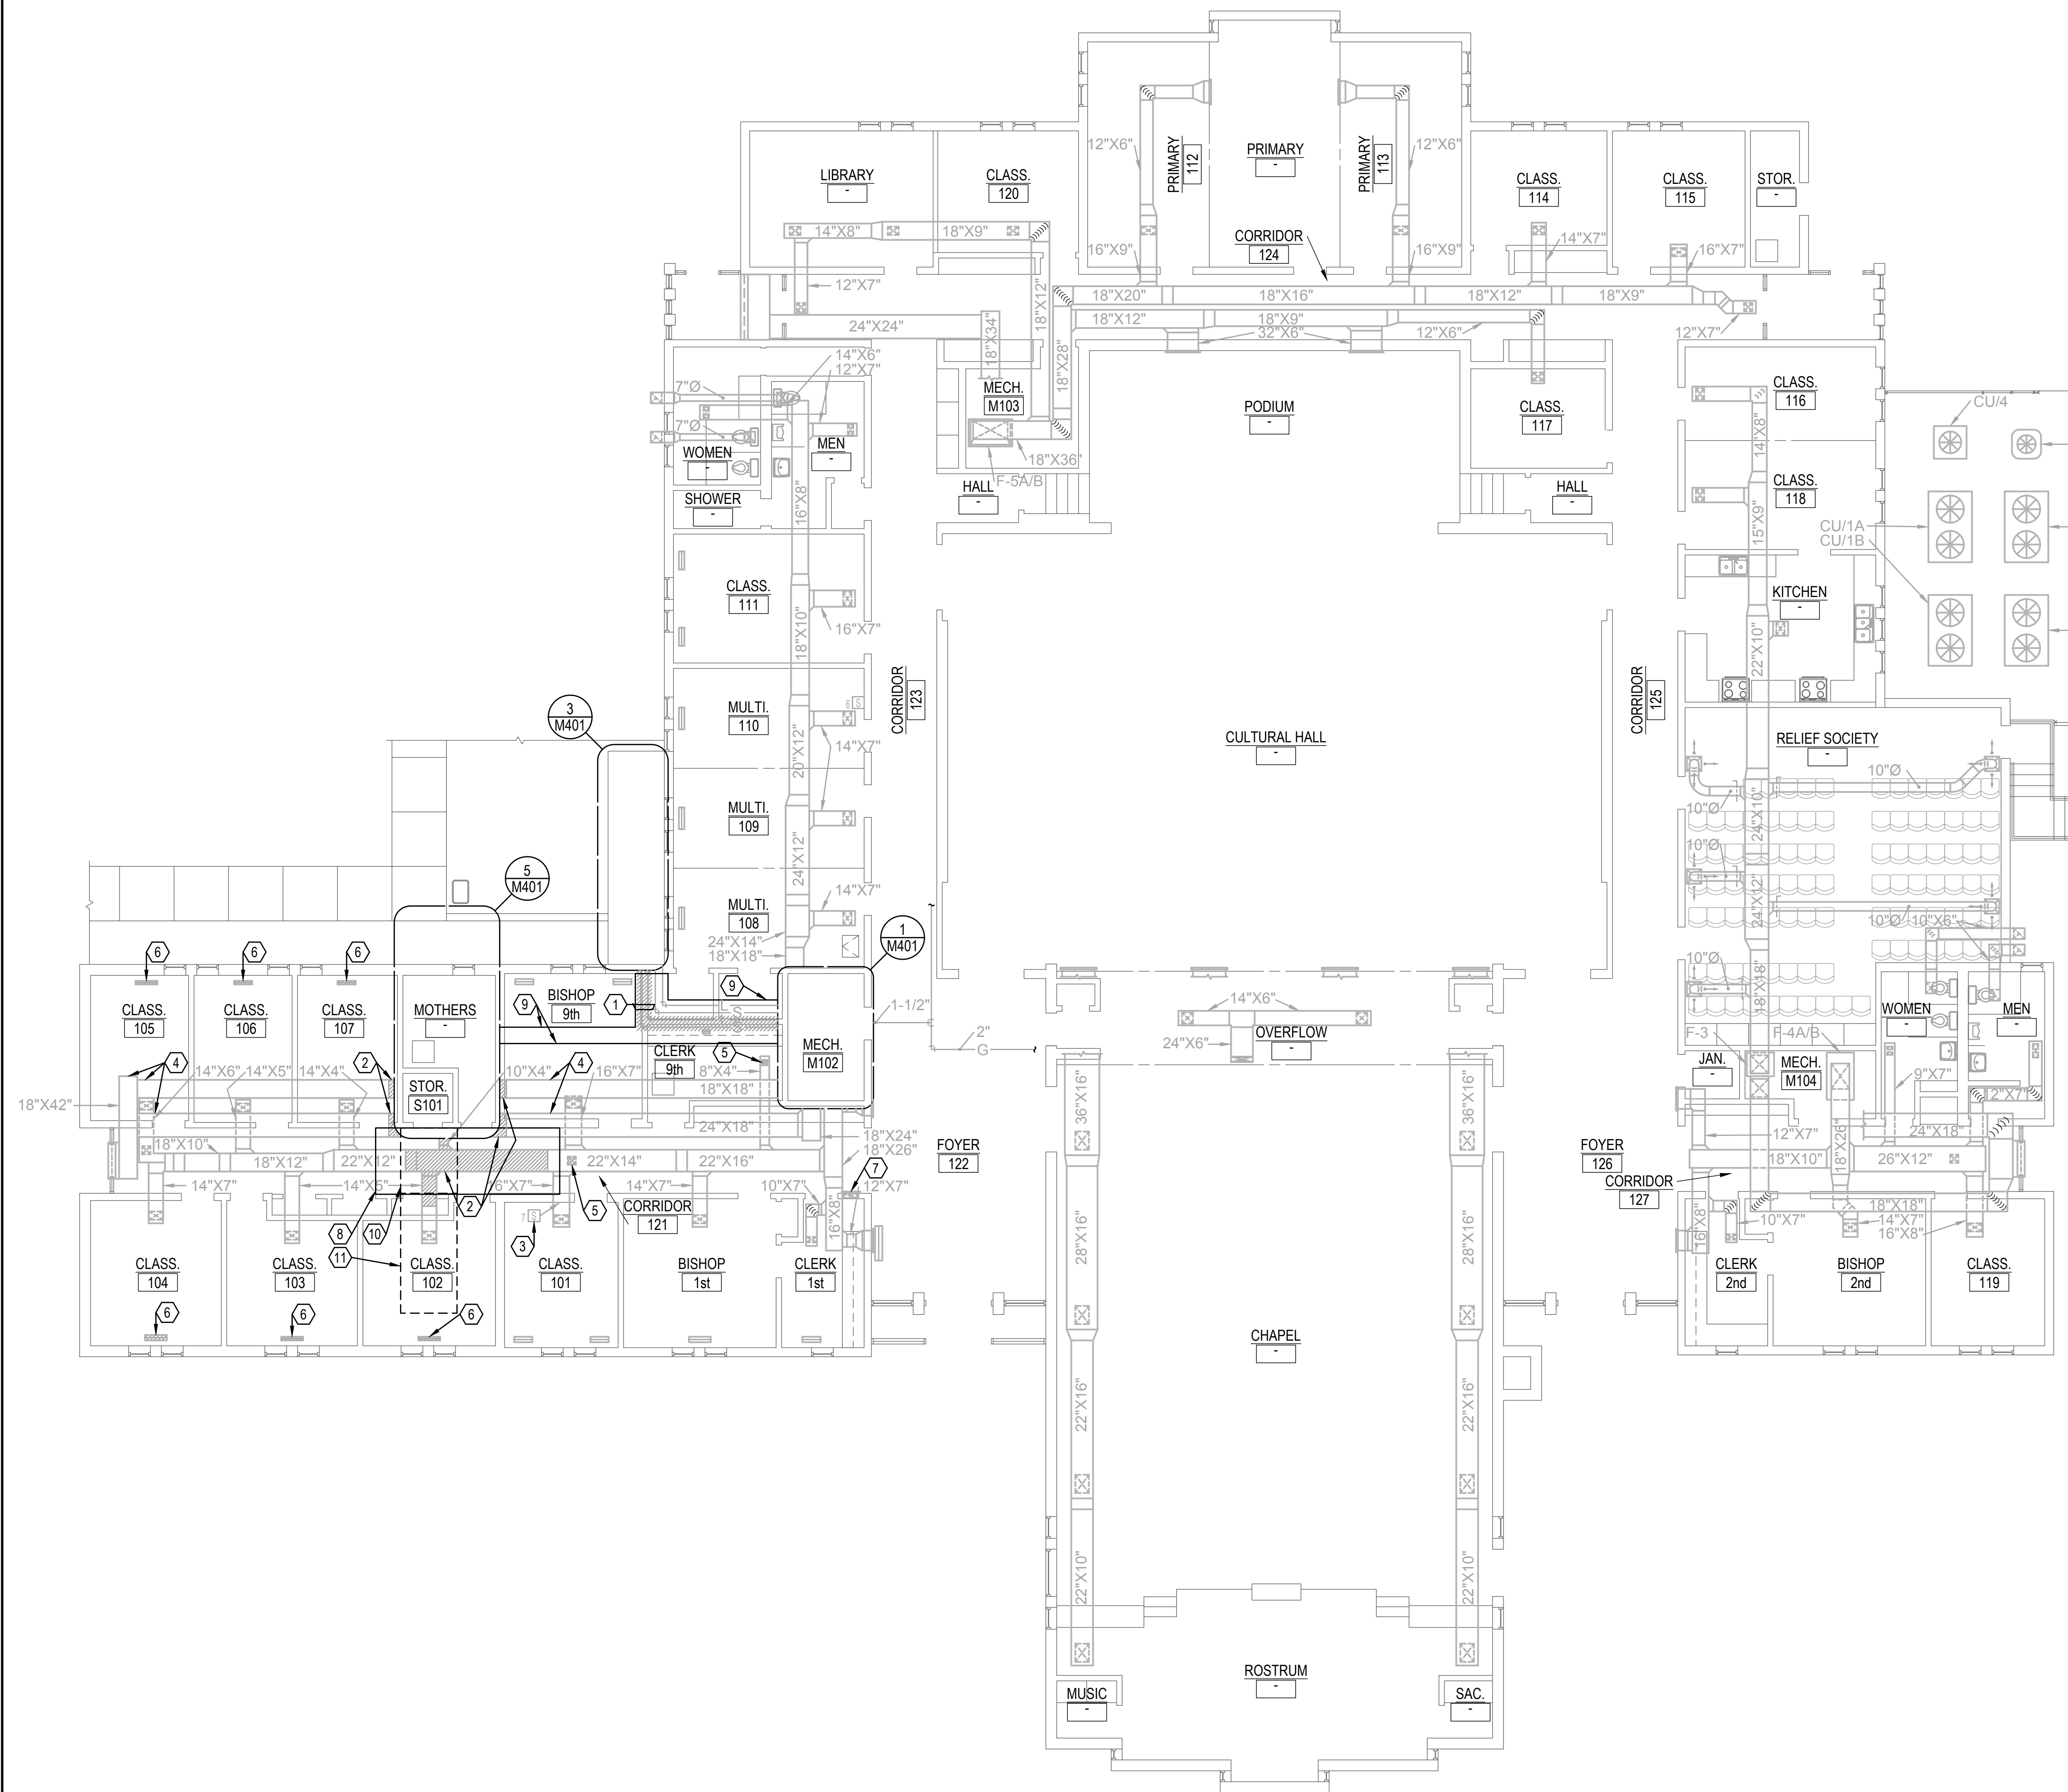
**MECHANICAL
 DEMOLITION FLOOR
 PLAN**

SHEET NUMBERS


MD102

KEYED NOTES FOR SHEET MD102

- ① REMOVE REFRIGERANT PIPING SHOWN HATCHED..
- ② REMOVE DUCTWORK SHOWN HATCHED.
- ③ EXISTING SENSOR TO REMAIN.
- ④ EXISTING OUTSIDE AIR DUCTWORK TO BE ABANDON IN PLACE.
- ⑤ REMOVE EXISTING DIFFUSER SHOWN HATCHED.
- ⑥ REMOVE EXISTING FLOOR GRILLE AND ASSOCIATED OPPOSED BLADE DAMPER.
- ⑦ REMOVE WALL GRILLE SHOWN HATCHED.
- ⑧ REMOVE LIGHTS AND OTHER CEILING MOUNTED DEVICES IN THIS PORTION OF CORRIDOR. REMOVE EXISTING GLUE ON TILE CEILING FOR DEMOLITION AND REMODEL ACCESS. UPON COMPLETION OF REMODEL INSTALL NEW GLUE ON TILE CEILING TO MATCH EXISTING AND RE-INSTALL EXISTING LIGHTS AND OTHER CEILING MOUNTED DEVICES. SEE ARCHITECT AND ELECTRICAL DRAWINGS FOR FURTHER DETAILS.
- ⑨ REMOVE LIGHTS AND OTHER CEILING MOUNTED DEVICES IN THE PORTION OF THIS ROOM SHOWN. REMOVE EXISTING CEILING FOR DEMOLITION AND REMODEL ACCESS. UPON COMPLETION OF REMODEL, INSTALL NEW CEILING TO MATCH EXISTING AND RE-INSTALL EXISTING LIGHTS AND OTHER CEILING MOUNTED DEVICES. SEE ARCHITECT AND ELECTRICAL DRAWINGS FOR FURTHER DETAILS.
- ⑩ REMOVE EXISTING CARPET IN CORRIDOR TO ALLOW FOR SAW CUTTING OF EXISTING FLOOR AND INSTALLATION OF NEW PORTION OF TUNNEL. RE-INSTALL OR REPLACE CARPET IN CORRIDOR UPON COMPLETION OF WORK TO MATCH EXISTING. SEE ARCHITECT DRAWINGS FOR FURTHER DETAIL.
- ⑪ REMOVE EXISTING CARPET IN CLASSROOM TO ALLOW FOR SAW CUTTING OF EXISTING FLOOR AND INSTALLATION OF NEW PORTION OF TUNNEL. RE-INSTALL OR REPLACE CARPET IN CLASSROOM UPON COMPLETION OF WORK TO MATCH EXISTING. SEE ARCHITECT DRAWINGS FOR FURTHER DETAIL.



1 MECHANICAL DEMOLITION FLOOR PLAN
 SCALE: 1/8"=1'-0"

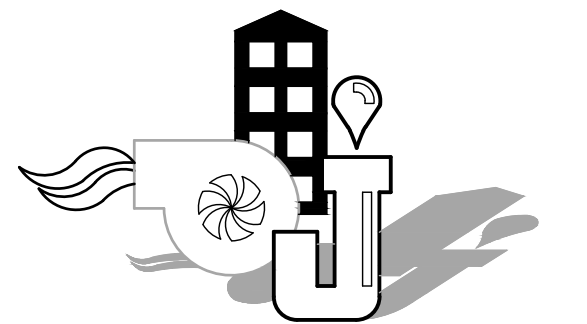

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SHEET TITLE


**MECHANICAL
 REMODEL FLOOR
 PLAN**

SHEET NUMBERS

MH102


KEYED NOTES FOR SHEET MH102

- 1 NEW REFRIGERANT PIPING.
- 2 CAP DUCTWORK AIRTIGHT AT THIS LOCATION.
- 3 NEW CONTROLS SENSOR.
- 4 EXISTING OUTSIDE AIR DUCTWORK TO BE ABANDON.
- 5 EXISTING CEILING ACCESS LOCATION.
- 6 TRANSITION DUCTWORK AS REQUIRED.
- 7 CONNECT NEW DUCTWORK TO EXISTING AT THIS LOCATION.
- 8 OMIT.
- 9 SEAL ALL EXISTING SUPPLY AIR DUCTWORK IN ATTIC BY CRAWLING THROUGH ATTIC SPACE FROM THE FOUR ATTIC ACCESS LOCATIONS IDENTIFIED AS PER NOTE 5 (TYPICAL).
- 10 SEAL ALL EXISTING SUPPLY, RETURN AND OUTSIDE AIR DUCTWORK IN MECHANICAL ROOMS (TYPICAL).
- 11 SEAL ALL EXISTING OUTSIDE AIR DUCTWORK IN ATTIC BY CRAWLING THROUGH ATTIC SPACE FROM THE FOUR ATTIC ACCESS LOCATIONS IDENTIFIED AS PER NOTE 5 (TYPICAL).
- 12 EXISTING FLOOR GRILLE TO REMAIN.
- 13 SAW CUT EXISTING FLOOR TO ALLOW FOR INSTALLATION OF NEW FLOOR GRILLE. SEE ARCHITECTS DRAWINGS FOR FURTHER DETAIL.

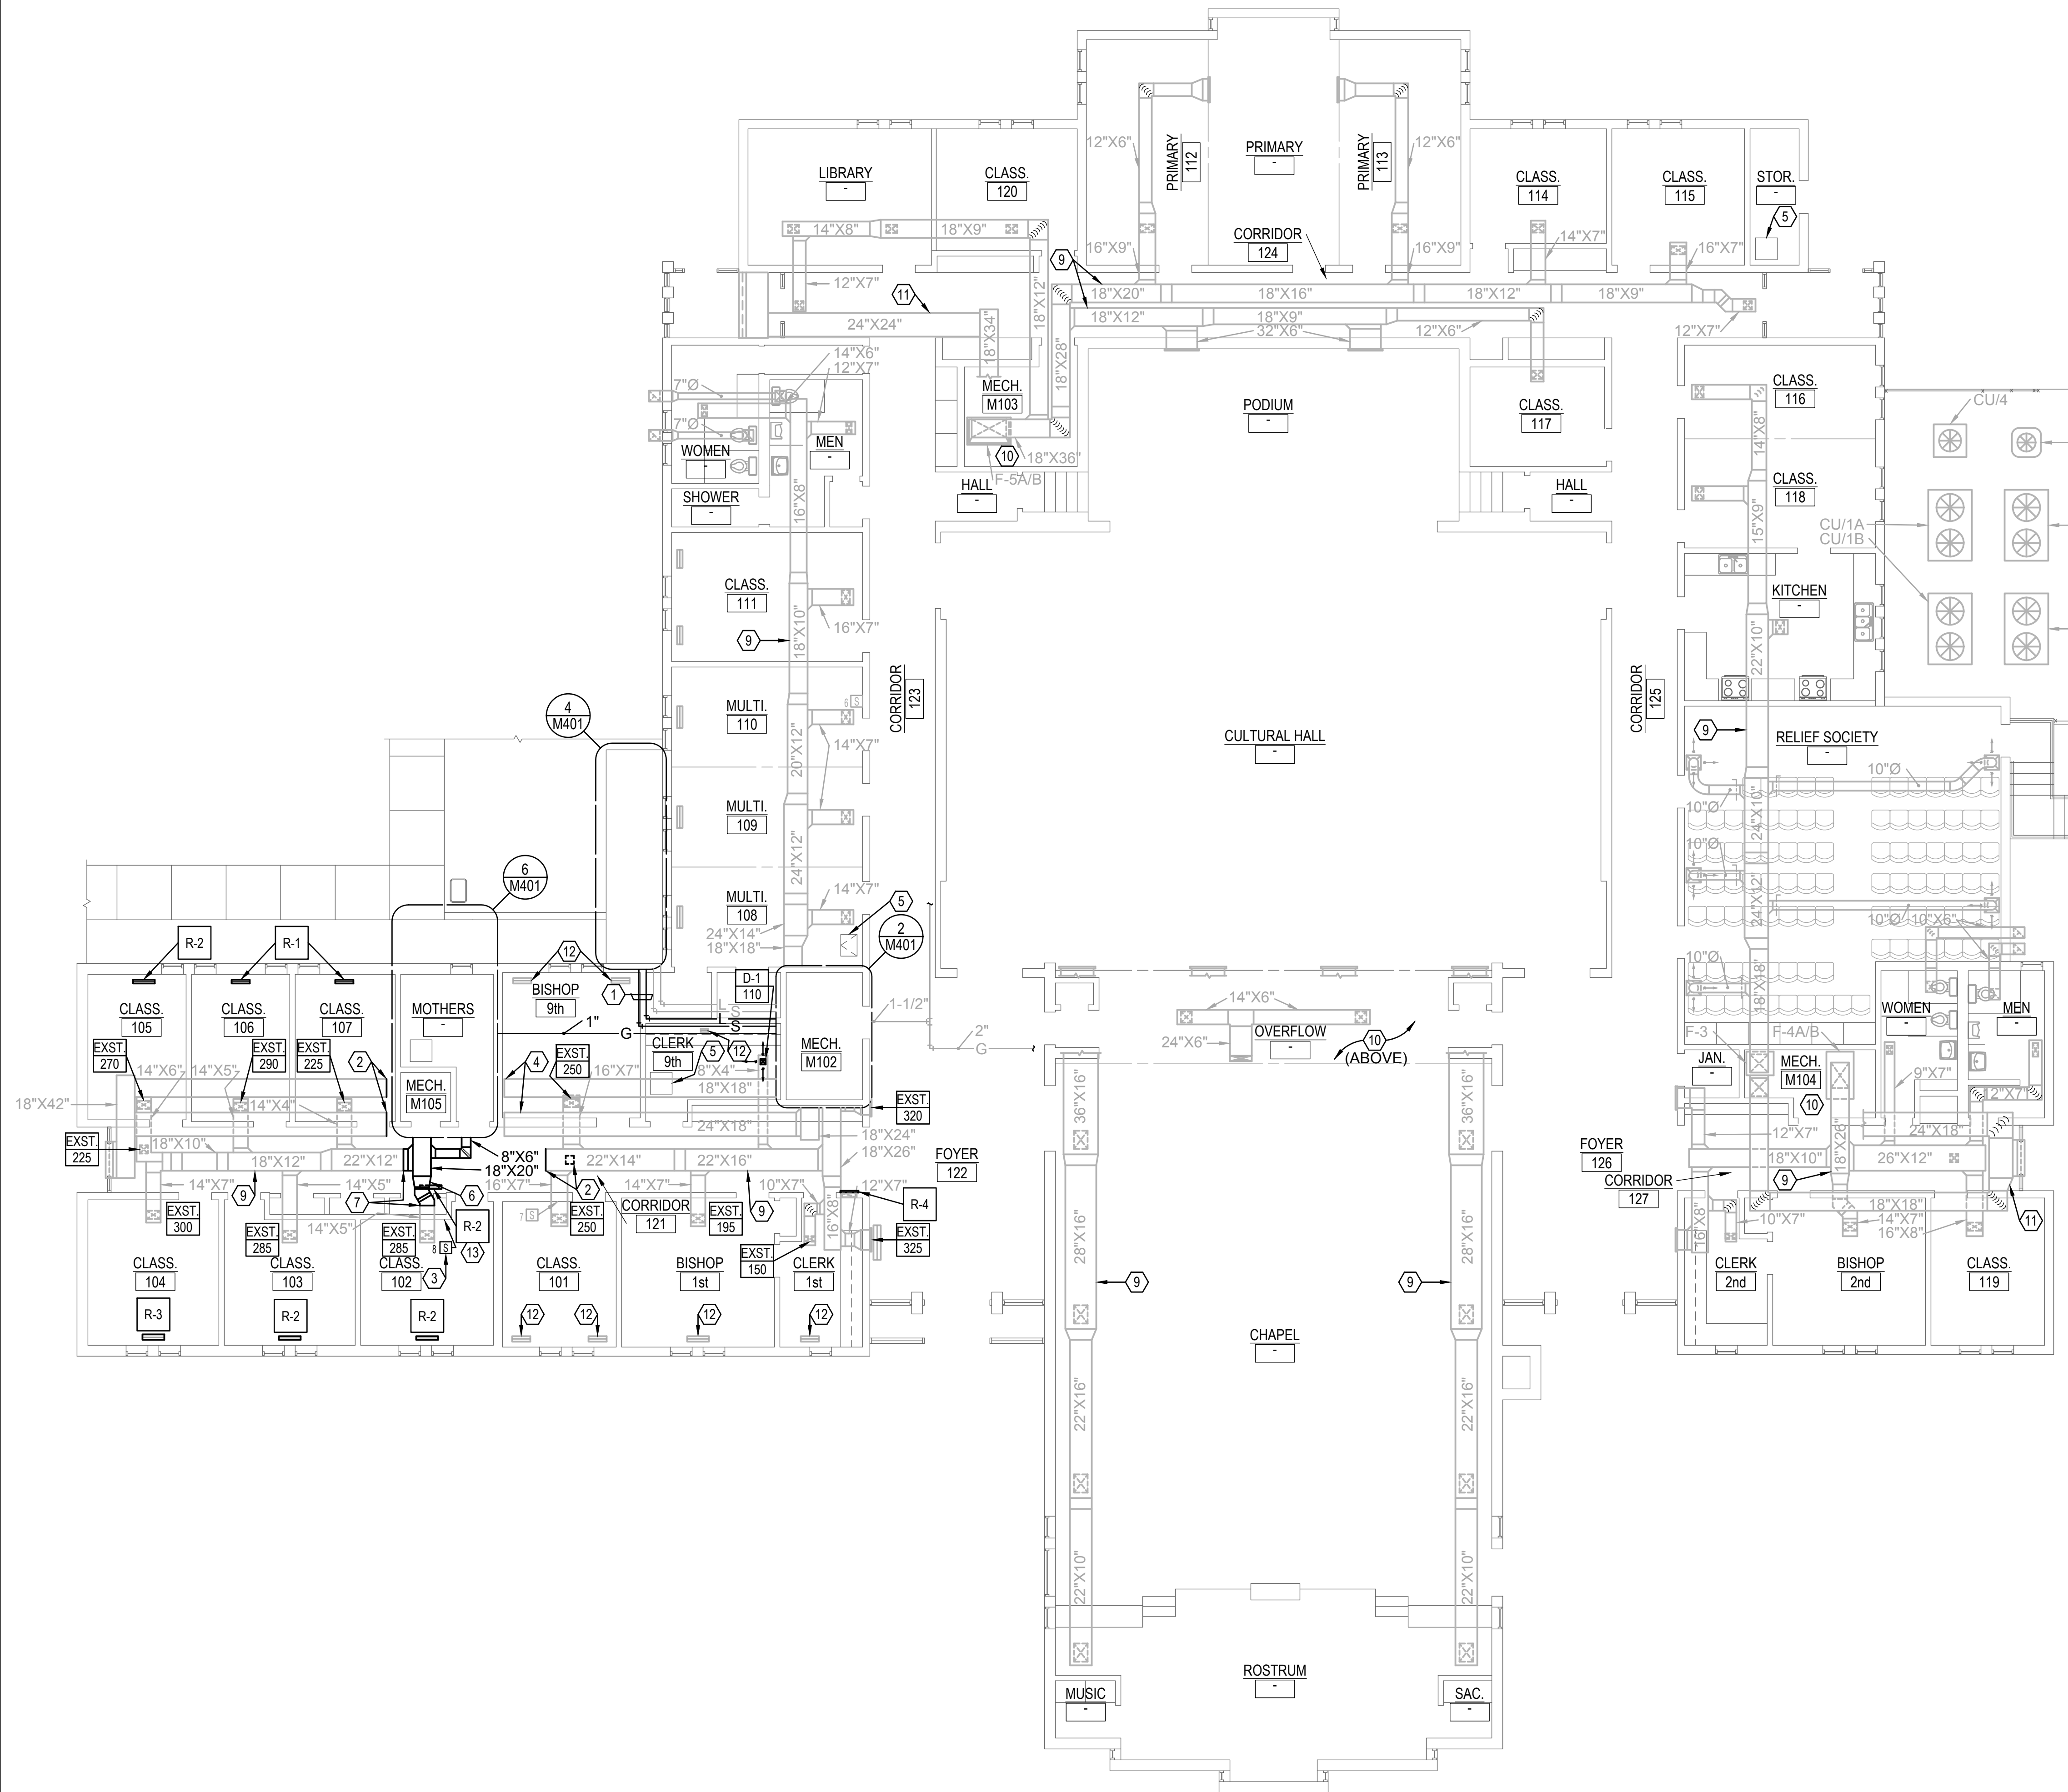

1 MECHANICAL REMODEL FLOOR PLAN
 SCALE: 1/8"=1'-0"




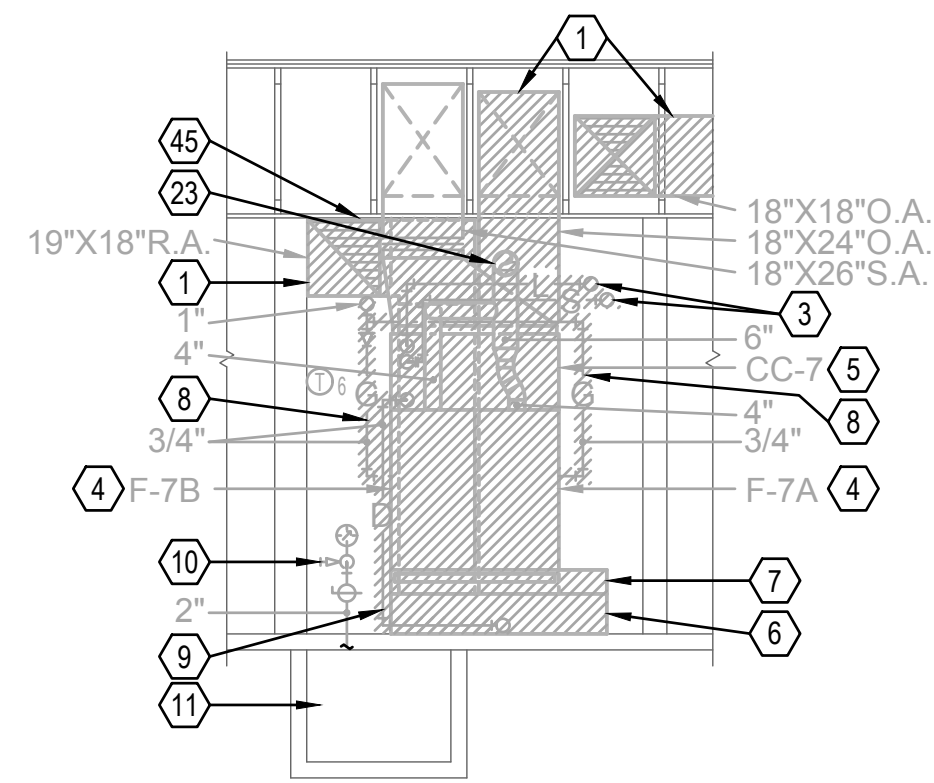

MECHANICAL ROOM DEMOLITION SECTION

A


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MECHANICAL ROOM DEMOLITION PLAN

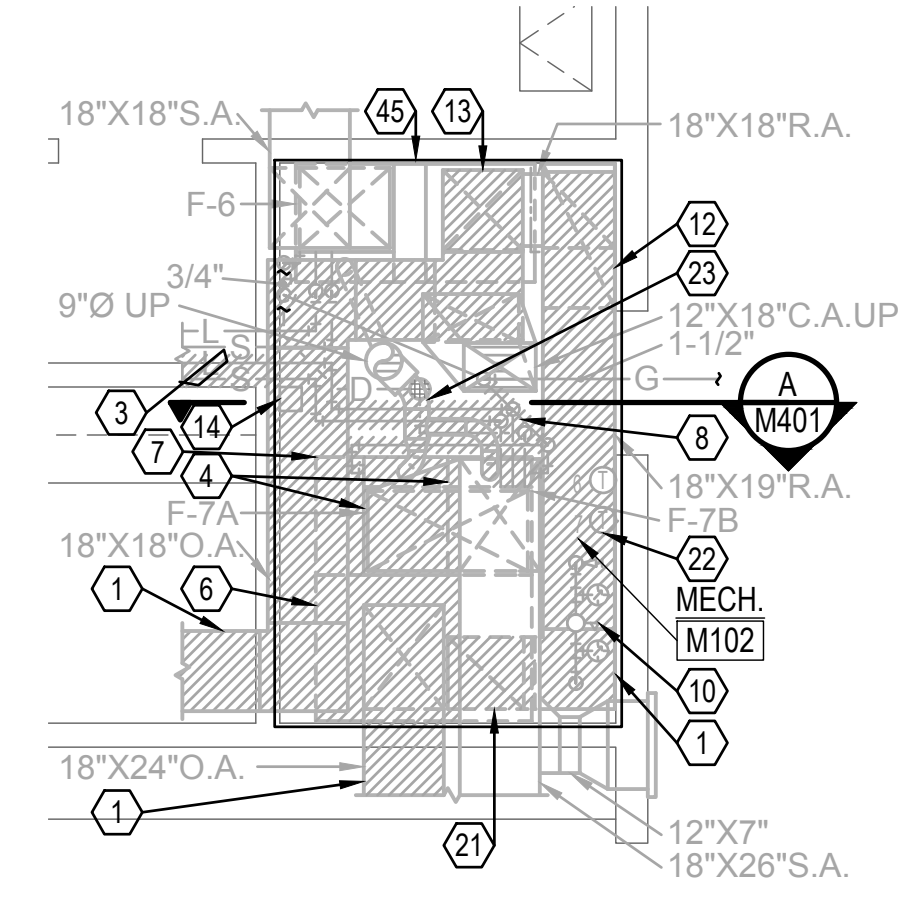1


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MECHANICAL ROOM REMODEL PLAN

2


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MECHANICAL ROOM REMODEL SECTION

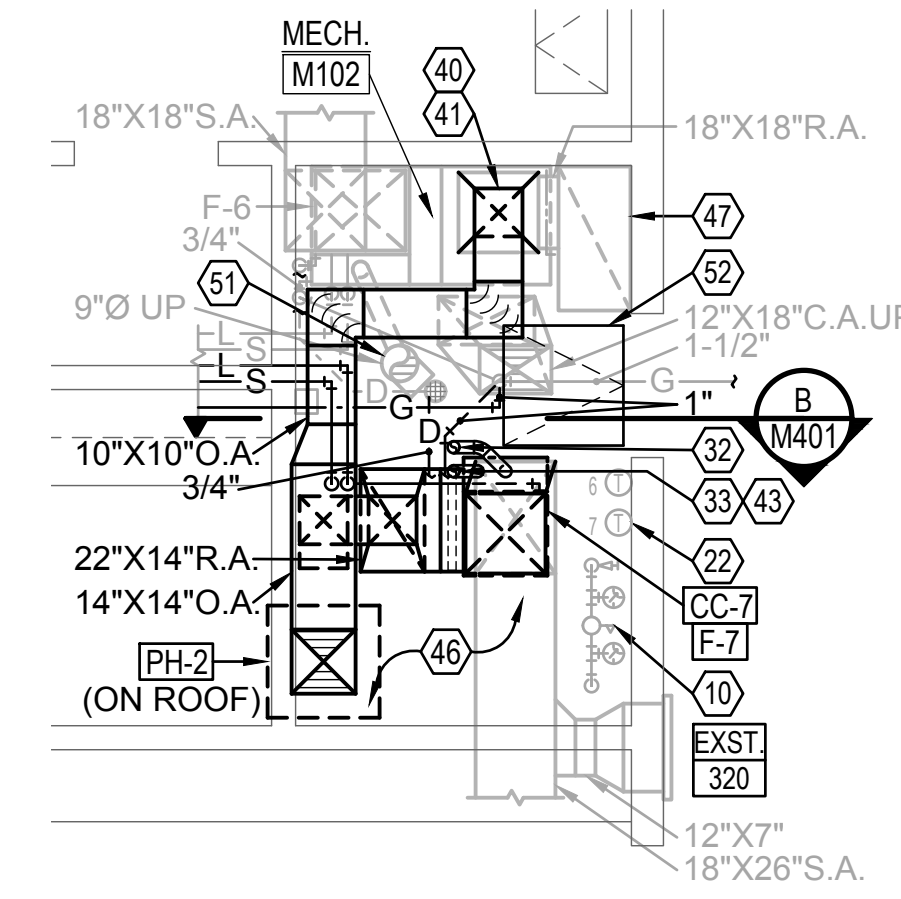B


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MECHANICAL PAD DEMOLITION PLAN

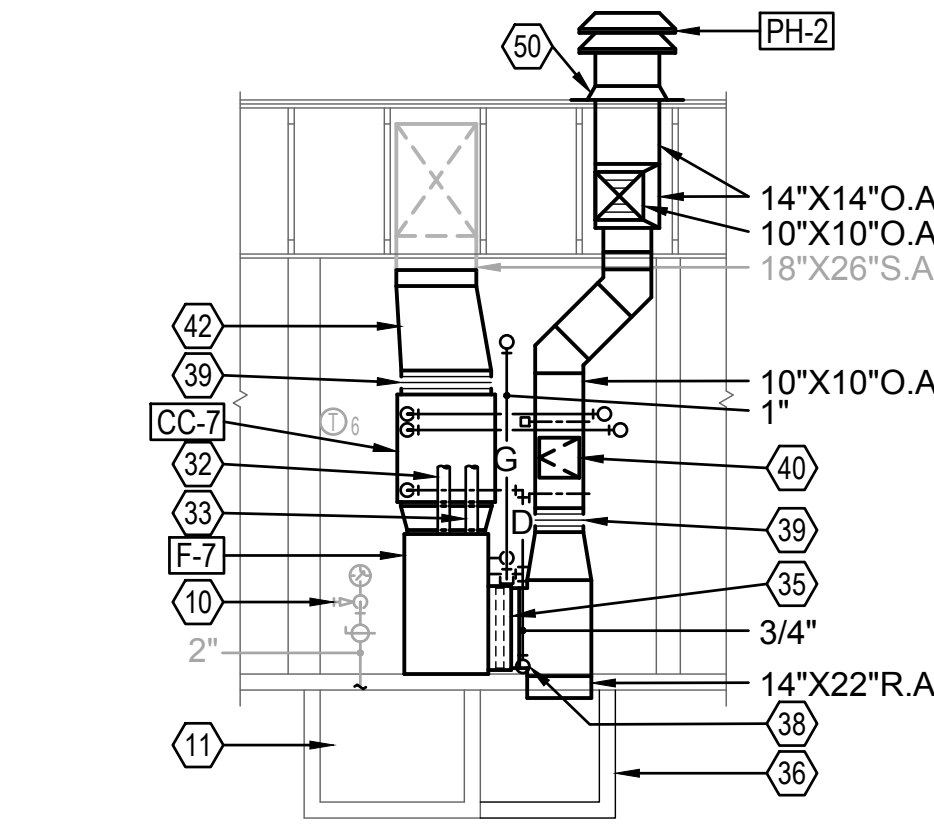3


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MECHANICAL PAD REMODEL PLAN

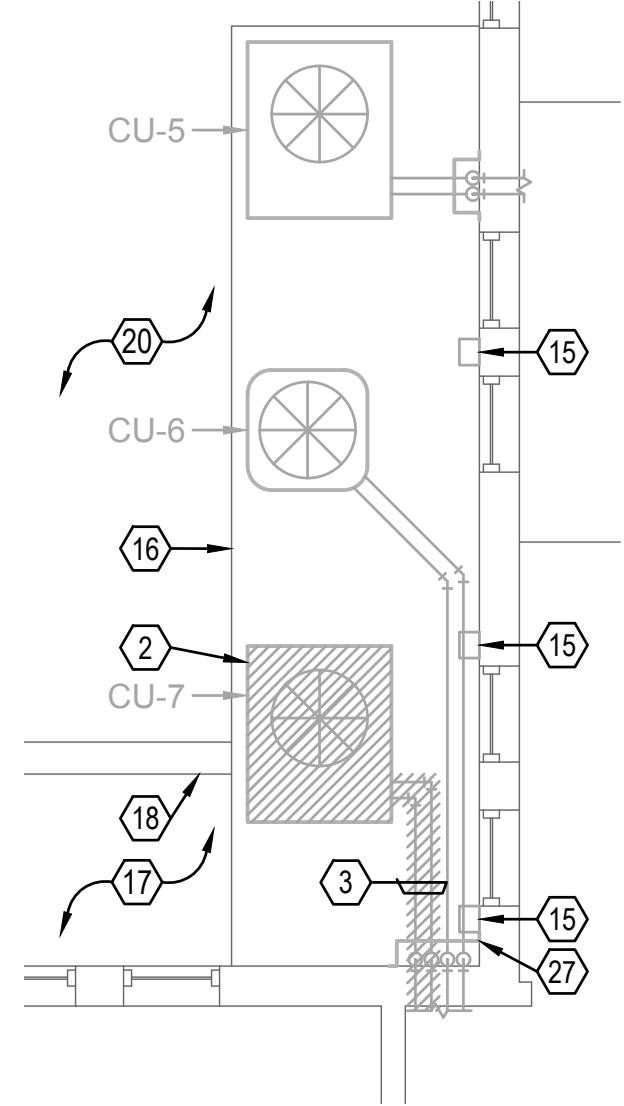4


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MECHANICAL ROOM REMODEL SECTION

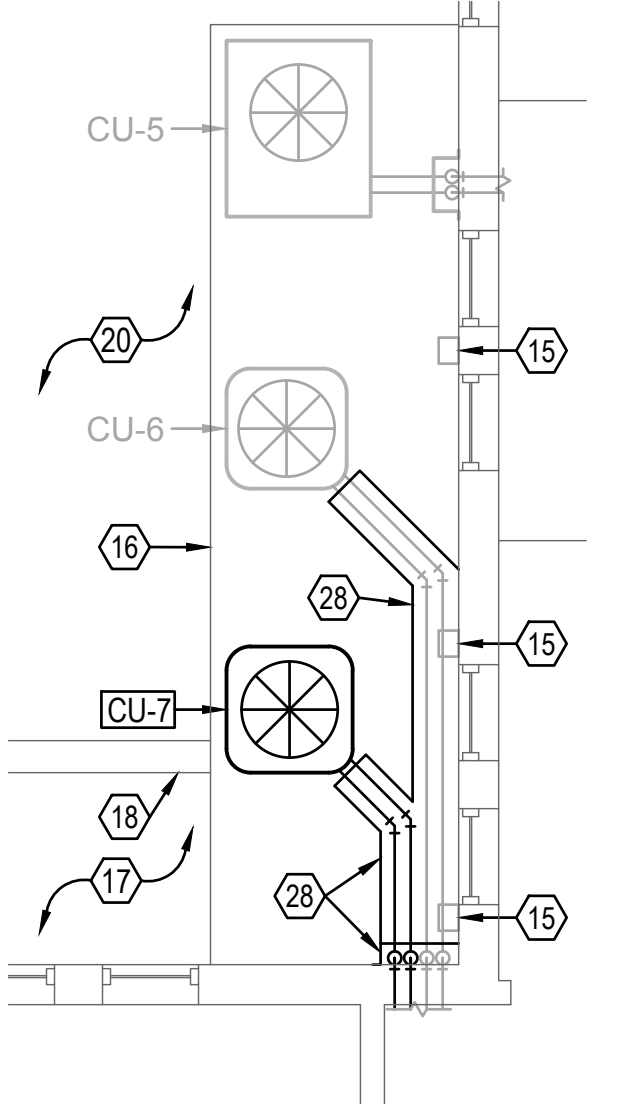C


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MECHANICAL ROOM DEMOLITION PLAN

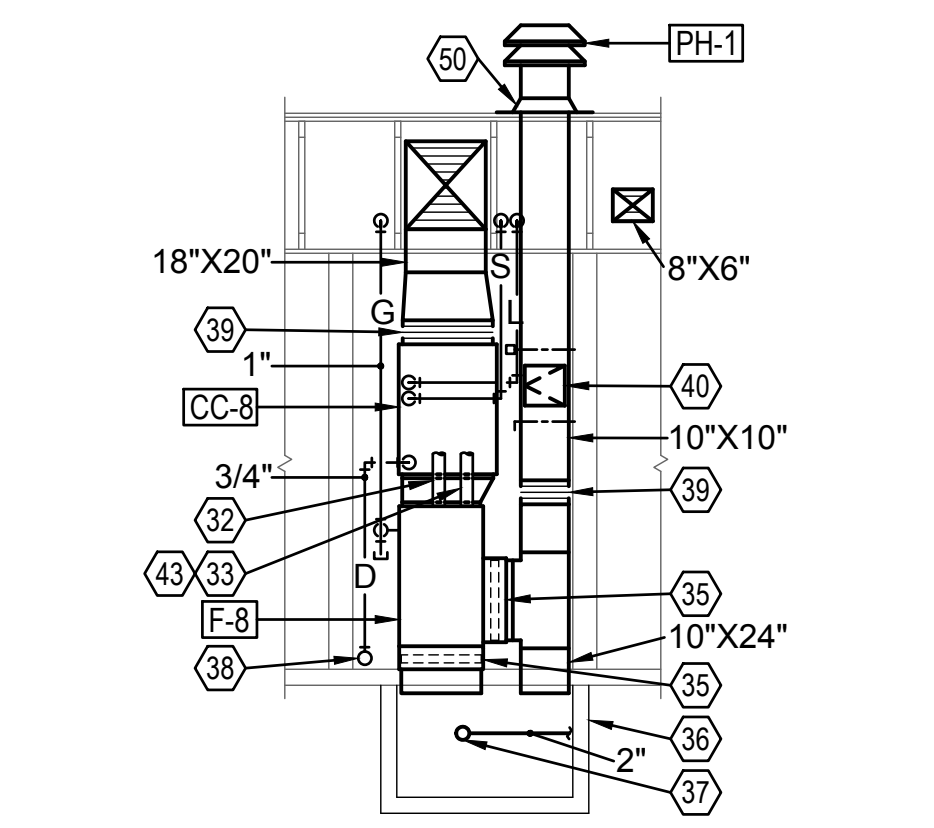5

SCALE: 1/4"=1'-0"

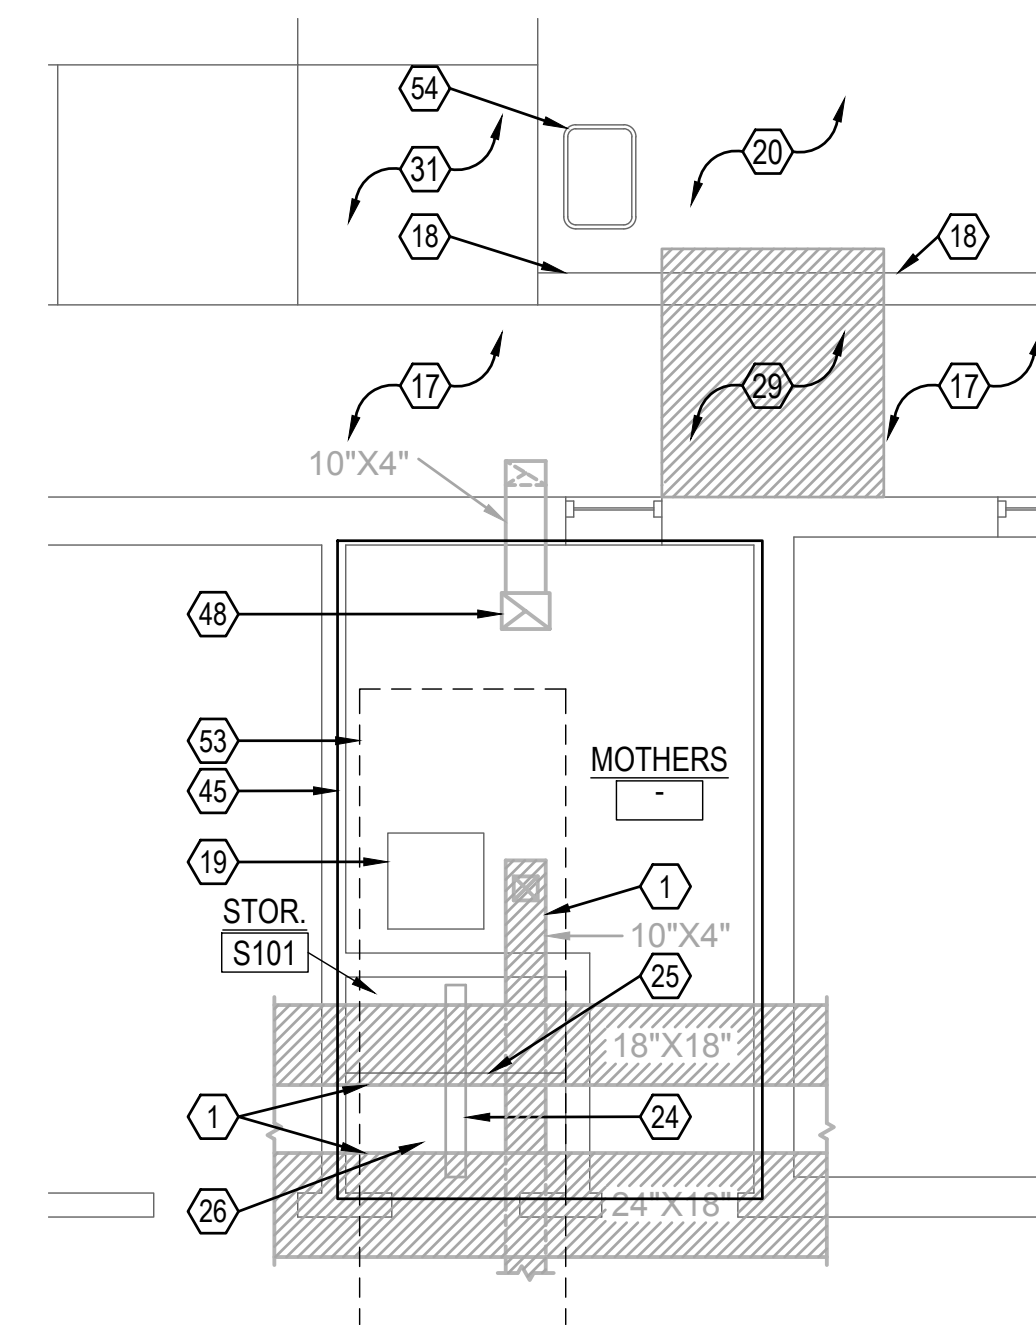


MECHANICAL ROOM REMODEL PLAN

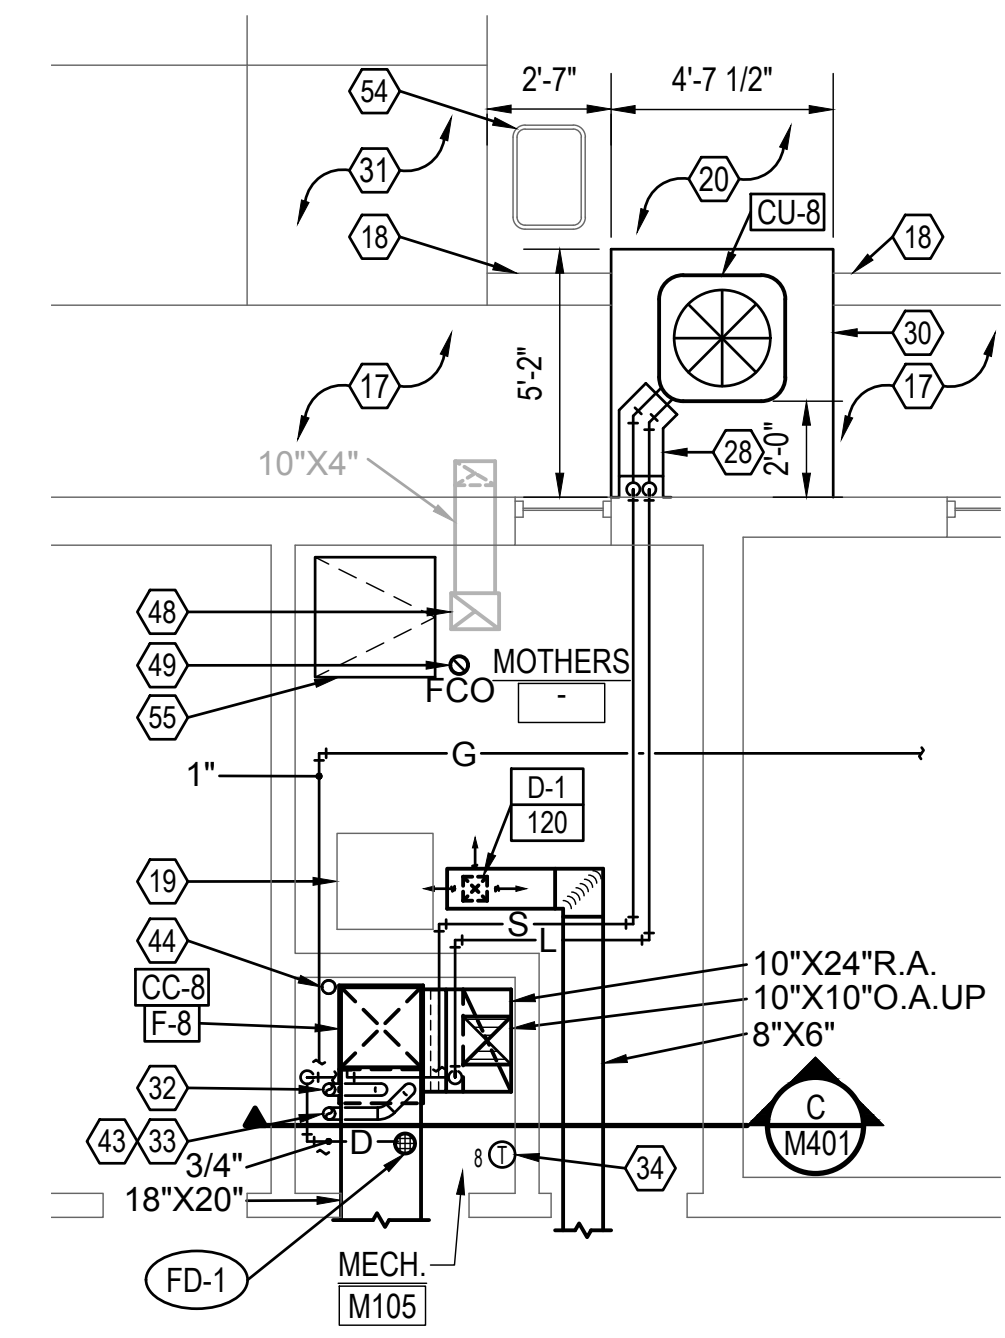6

SCALE: 1/4"=1'-0"

KEYED NOTES FOR SHEET M401


- ① REMOVE DUCTWORK SHOWN HATCHED.
- ② REMOVE CONDENSING UNIT SHOWN HATCHED.
- ③ REMOVE REFRIGERANT PIPING SHOWN HATCHED.
- ④ REMOVE FURNACE SHOWN HATCHED.
- ⑤ REMOVE COOLING COIL SHOWN HATCHED.
- ⑥ REMOVE FURNACE STAND SHOWN HATCHED.
- ⑦ REMOVE FURNACE FILTER SECTION SHOWN HATCHED.
- ⑧ REMOVE GAS PIPING SHOWN HATCHED.
- ⑨ REMOVE DRAIN PIPING SHOWN HATCHED.
- ⑩ EXISTING 2" DOMESTIC WATER PRESSURE REDUCING STATION TO REMAIN.
- ⑪ EXISTING RETURN AIR TUNNEL.
- ⑫ EXISTING 36"X18" R.A. DUCTWORK THAT ROUTES FROM RETURN AIR TUNNEL UP TO 18"X18" BRANCH TO FURNACE SYSTEM F-6. AFTER BRANCH, DUCTWORK CONTINUES VERTICAL AT 18"X19" SIZE AND ROUTES TO FURNACE SYSTEM F-7 STAND AS SHOWN.
- ⑬ REMOVE 18"X18" O.A. DUCTWORK DROP FROM ATTIC SPACE DOWN TO ELEVATION OF 18"X18" R.A. CONNECTION. O.A. DUCTWORK TO REMAIN FROM RETURN AIR CONNECTION ELEVATION DOWN TO FURNACE STAND CONNECTION.
- ⑭ EXISTING DISCONNECT FOR ALL 3 FURNACES IN THIS ROOM, SEE ELECTRICAL DRAWINGS FOR FURTHER DETAIL.
- ⑮ EXISTING CONDENSING UNIT DISCONNECT, SEE ELECTRICAL DRAWINGS FOR FURTHER DETAIL.
- ⑯ EXISTING CONCRETE CONDENSING UNIT PAD.
- ⑰ EXISTING PLANTER BED.
- ⑱ EXISTING CONCRETE MOW STRIP.
- ⑲ EXISTING CEILING ACCESS POINT.
- ⑳ EXISTING LAWN AREA.
- ㉑ REMOVE EXISTING RETURN AIR DUCTWORK DROP TO FURNACE STAND.
- ㉒ REMOVE EXISTING TWIN FURNACE CONTROL WIRING FROM THIS THERMOSTAT F-7. THERMOSTAT TO REMAIN FOR REUSE.
- ㉓ REMOVE FURNACE FLUES SHOWN HATCHED, TYPICAL. CAP REMAINING FLUE AIR TIGHT.
- ㉔ REMOVE EXISTING LIGHT FROM STORAGE ROOM. PROVIDE NEW LIGHT FOR THE NEW MECHANICAL ROOM, COORDINATE LOCATION WITH MECHANICAL DUCTWORK LOCATIONS. SEE ELECTRICAL DRAWINGS FOR FURTHER DETAIL.
- ㉕ REMOVE ALL STORAGE SHELVING AND BRACKETS FROM THIS ROOM. PATCH WALLS AS NEEDED AND PAINT TO MATCH EXISTING, SEE ARCHITECTURAL DRAWINGS FOR FURTHER DETAIL.
- ㉖ REMOVE EXISTING CARPET AND CARPET GLUE FROM CONCRETE FLOOR. PROVIDE NEW THRESHOLD AT DOORWAY. PAINT FLOOR, SEE ARCHITECTURAL DRAWINGS FOR FURTHER DETAIL.
- ㉗ REMOVE EXISTING REFRIGERANT PIPE COVER TO ALLOW FOR REFRIGERANT PIPING REMOVAL AND REPLACEMENT.
- ㉘ INSTALL NEW REFRIGERANT VERTICAL AND HORIZONTAL PIPE COVERS OVER PIPING, SEE DETAILS.
- ㉙ REMOVE EXISTING SHRUBS AND OR PLANTS, PORTION OF THE EXISTING MOW STRIP, LAWN AREA AND ASSOCIATED SPRINKLER PIPING IN THIS AREA SHOWN HATCHED TO ALLOW FOR NEW CONCRETE PAD. SEE ARCHITECTURAL DRAWINGS FOR FURTHER DETAIL.
- ㉚ NEW CONCRETE MECHANICAL EQUIPMENT PAD. MODIFY SPRINKLER PIPING SUCH THAT IS IT NOT RUN UNDER CONCRETE PAD AND PATCH LAWN AROUND NEW CONCRETE PAD TO MATCH EXISTING. SHRUBS LOCATED IN PLANTED BED TO BE A MINIMUM OF 3' FROM NEW CONDENSING UNIT. SEE ARCHITECTURAL DRAWINGS FOR FURTHER DETAIL.
- ㉛ EXISTING CONCRETE SIDEWALK.
- ㉜ COMBUSTION AIR THROUGH ROOF.
- ㉝ GAS VENT THROUGH ROOF.
- ㉞ NEW THERMOSTAT.
- ㉟ NEW MEDIA FILTER CABINET BY FURNACE MANUFACTURER.
- ㊱ NEW CONCRETE RETURN AIR TUNNEL, SEE ARCHITECTS DRAWINGS FOR DETAILS.
- ㊲ NEW 2" WASTE PIPING FROM FLOOR DRAIN ROUTED THROUGH TUNNEL TO CONNECT TO EXISTING WASTE PIPING BELOW MECH. M102 IN TUNNEL. CONTRACTOR TO FIELD VERIFY CONNECTION LOCATION BEFORE ORDERING AND MATERIALS.
- ㊳ ROUTE FURNACE AND COOLING COIL DRAIN PIPING TO FLOOR DRAIN.
- ㊴ FLEXIBLE EQUIPMENT CONNECTION.
- ㊵ 10"X10" DUCT ACCESS DOOR, MANUAL DAMPER AND AUTOMATIC DAMPER IN O.A. DUCT.
- ㊶ DROP 10"X10" AND CONNECT TO EXISTING, BALANCE TO 385 CFM.
- ㊷ TRANSITION DUCTWORK AND CONNECT TO EXISTING.
- ㊸ EXTEND CONCENTRIC VENT KIT TO BE 3' ABOVE PENTHOUSE, INSTALL GUY WIRE SUPPORTS. PAINT EXTERIOR PIPING TO MATCH ROOFING COLOR.
- ㊹ 1-1/2" VENT PIPING FROM TUNNEL UP THROUGH ROOF TO EXTEND 3' ABOVE NEW OUTSIDE AIR INTAKE. PAINT EXTERIOR PIPING TO MATCH ROOFING COLOR.
- ㊺ REMOVE LIGHTS AND OTHER CEILING MOUNTED DEVICES IN THESE ROOMS. REMOVE EXISTING SHEET ROCK CEILING IN THESE ROOMS FOR DEMOLITION AND REMODEL ACCESS. UPON COMPLETION OF REMODEL INSTALL NEW SHEET ROCK CEILING AND RE-INSTALL EXISTING LIGHTS AND OTHER CEILING MOUNTED DEVICES, SEE ARCHITECT AND ELECTRICAL DRAWINGS FOR FURTHER DETAILS.
- ㊻ PAINT FLOOR IN THIS ROOM AFTER EXISTING EQUIPMENT REMOVAL TO MATCH EXISTING, SEE ARCHITECTS DRAWINGS FOR FURTHER DETAILS.
- ㊼ CAP 36"X18" R.A. DUCTWORK AIR TIGHT AFTER THE REMOVAL OF 18"X19" BRANCH DUCTWORK.
- ㊽ EXISTING EXHAUST FAN.
- ㊾ INSTALL NEW FLOOR CLEAN OUT IN THIS LOCATION.
- ㊿ FLASH AND COUNTER FLASH NEW ROOF CURB TO PATCH ROOFING INTO EXISTING, SEE ARCHITECTURAL DRAWINGS FOR FURTHER DETAIL.
- 1 EXTEND EXISTING FLUE TO BE A MINIMUM OF 3 FEET ABOVE OUTSIDE AIR INTAKE. PAINT TO MATCH EXISTING ROOFING COLOR.
- 2 INSTALL NEW 30"X30" TUNNEL ACCESS DOOR WITH LATCH IN FLOOR OF MECHANICAL ROOM, SEE ARCHITECTURAL DRAWINGS FOR FURTHER DETAIL.
- 3 REMOVE EXISTING CARPET IN THIS AREA TO ALLOW FOR SAW CUTTING OF EXISTING FLOOR AND INSTALLATION OF NEW PORTION OF TUNNEL. RE-INSTALL OR REPLACE CARPET IN MOTHERS ROOM UPON COMPLETION OF WORK TO MATCH EXISTING. SEE ARCHITECTS PLANS FOR FURTHER DETAIL.
- 4 EXISTING IRRIGATION SPRINKLER BOX IN EXISTING LAWN AREA. MODIFY ALL SPRINKLER PIPING TO ROUTE AROUND NEW MECHANICAL CONCRETE PAD. SEE ARCHITECTS DRAWINGS FOR FURTHER DETAIL.
- 5 INSTALL NEW 30"X30" TUNNEL ACCESS DOOR WITH LATCH IN FLOOR OF MOTHERS ROOM, SEE ARCHITECTURAL DRAWINGS FOR FURTHER DETAIL.

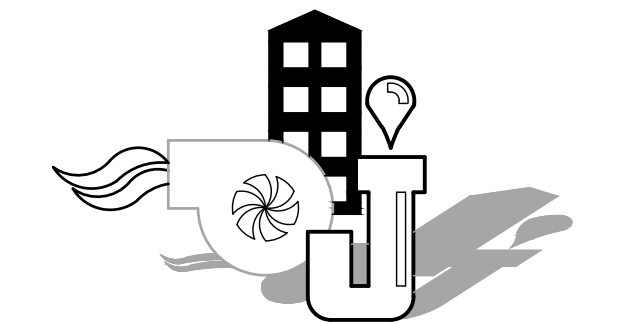

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CONSULTANTS

STAMP

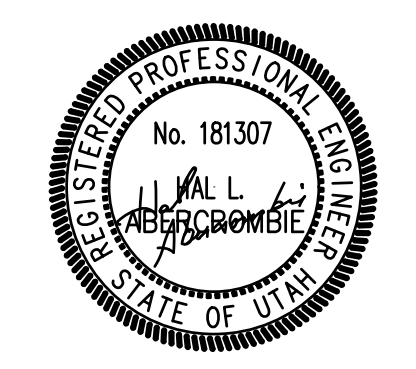

PROJECT FOR

SALEM 1, 2 & 9 WARDS
 SALEM UT WEST STAKE

PROPERTY NUMBER: 505056119010101
 60 SOUTH MAIN STREET
 SALEM, UTAH 84653

MARK	DATE	DESCRIPTION
1		
2		
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ISSUE TYPE:	CONSTRUCTION DOCUMENTS
ISSUE DATE:	JUNE 18, 2020
PROJECT NO:	18107
CAD DWG FILE:	I:\JOBS\2018\18107\CAD\SCM401.DWG
DRAWN BY:	BDA
CHECKED BY:	HLA

SHEET TITLE

MECHANICAL LARGE SCALE PLANS AND SECTIONS

SHEET NUMBERS


M401

DIMENSION OF LONGEST SIDE, INCHES	SHEET METAL GAUGE (ALL FOUR SIDES)	MINIMUM REINFORCING ANGLE SIZE AND MAXIMUM LONGITUDINAL SPACING BETWEEN TRANSVERSE JOINTS &/OR INTERMEDIATE REINFORCING	TRANSVERSE REINFORCING (1)				
			AT JOINTS				
			MIN. H. IN.	DRIVE SLIP PLAIN S SLIP	HEMMEDED S SLIP	ALTER'NT BAR SLIP	REIN- FORCED BAR SLIP
UP THRU 12	26	NONE REQUIRED	1	26	26	24	24
13 - 18	24	NONE REQUIRED	1	24	24	24	24
19 - 30	24	1"X1"X1/8" @ 60 IN (3)	1	-	24	24	24
31 - 36	22	1"X1"X1/8" @ 60 IN (3)	1	-	-	22	22

- (1) TRANSVERSE REINFORCING SIZE IS DETERMINED BY DIMENSION OF SIDE TO WHICH ANGLE IS APPLICABLE.
 (2) LONGITUDINAL JOINTS TO BE PITTSBURGH OR SNAP LOCK TYPE.
 (3) IF BAR SLIP OR REINFORCED BAR SLIP JOINTS ARE USED, ANGLE IRON REINFORCING SHALL NOT BE REQUIRED.


7 DUCT CONSTRUCTION DETAIL

SCALE: N.T.S.

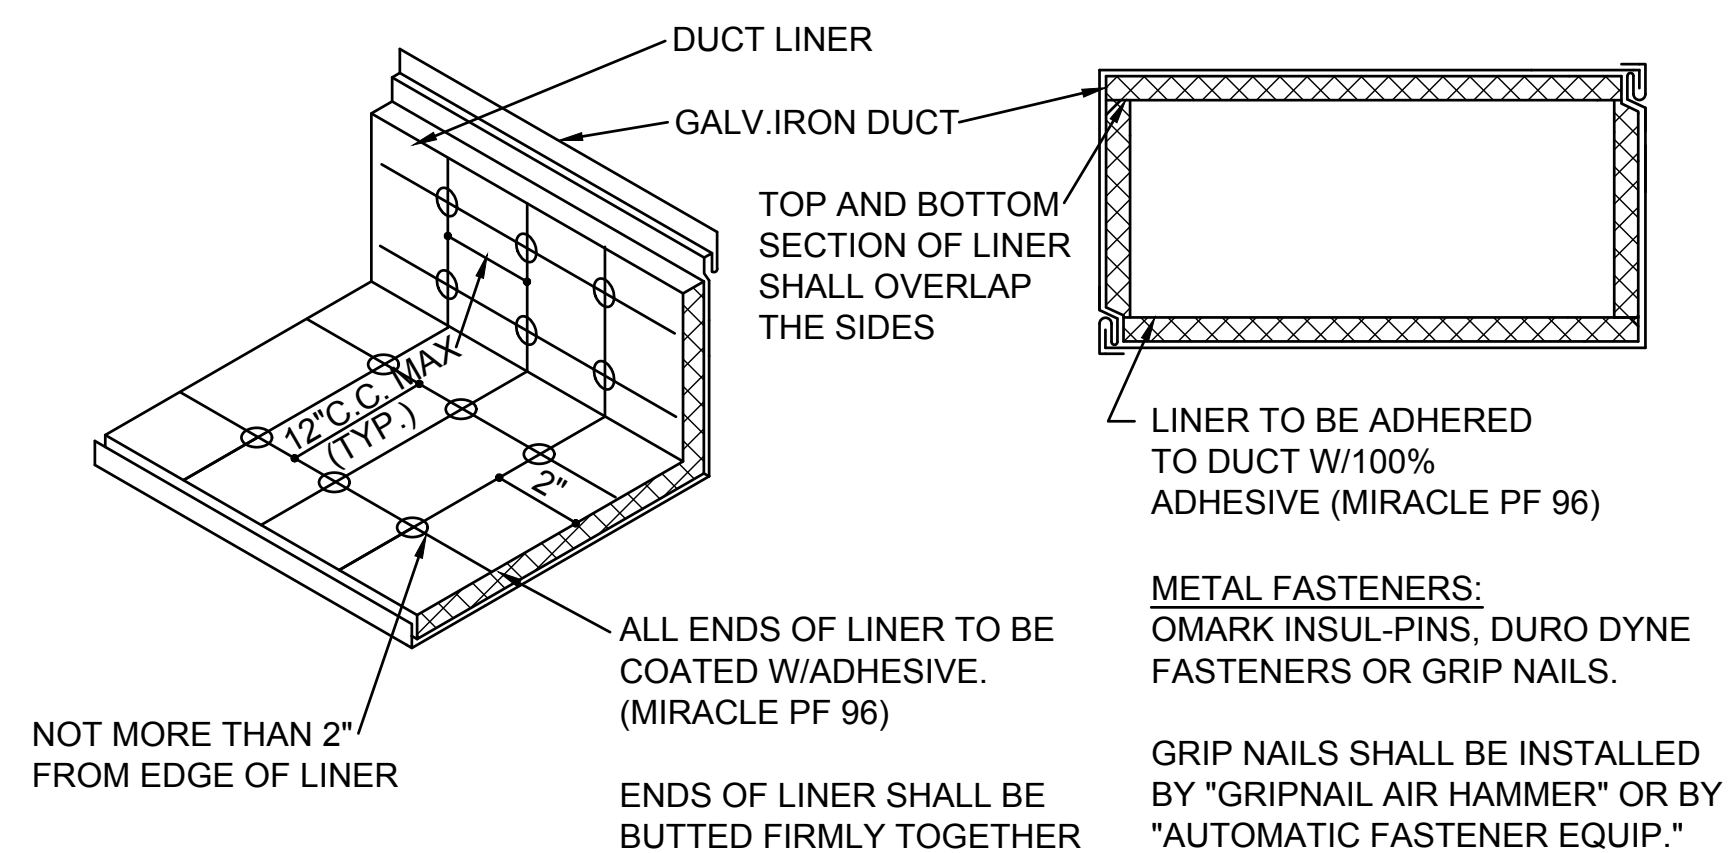


8 DUCT LINER DETAIL

SCALE: N.T.S.

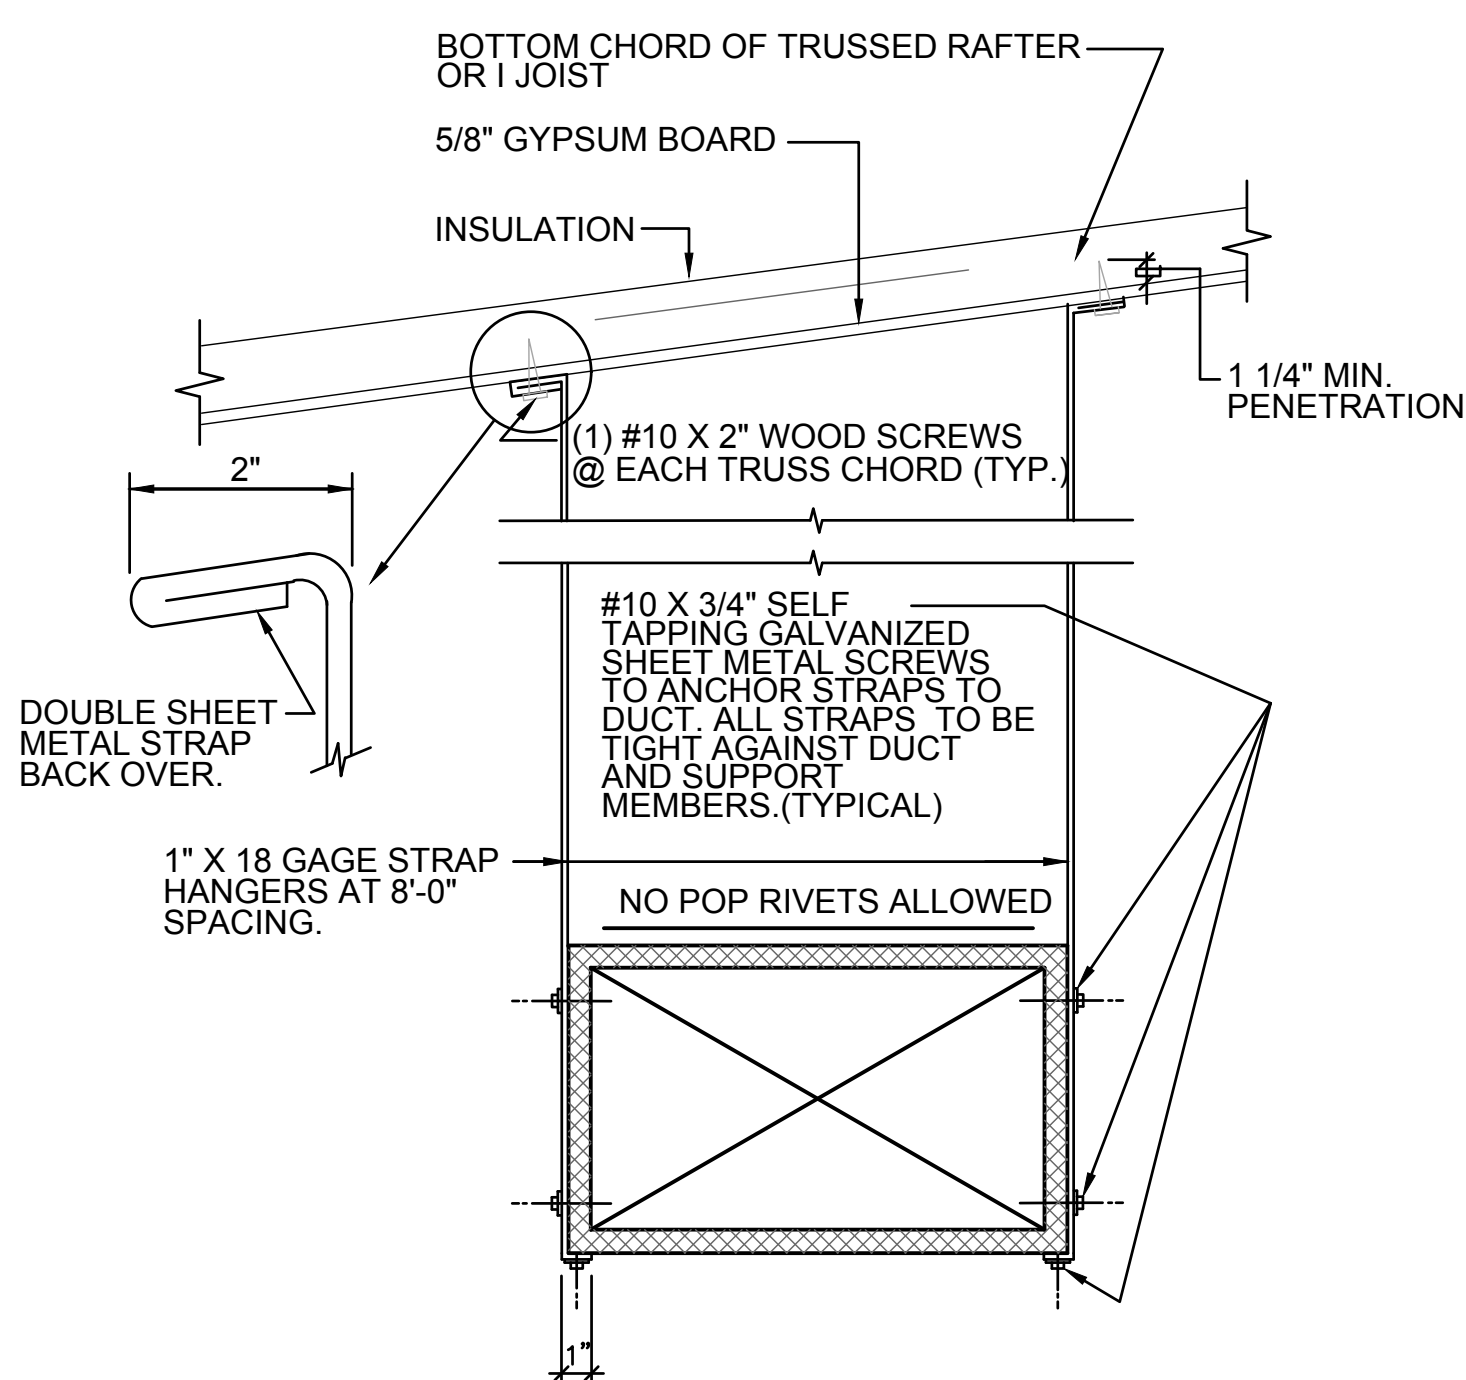


9 DUCT STRAP HANGER DETAIL

SCALE: N.T.S.

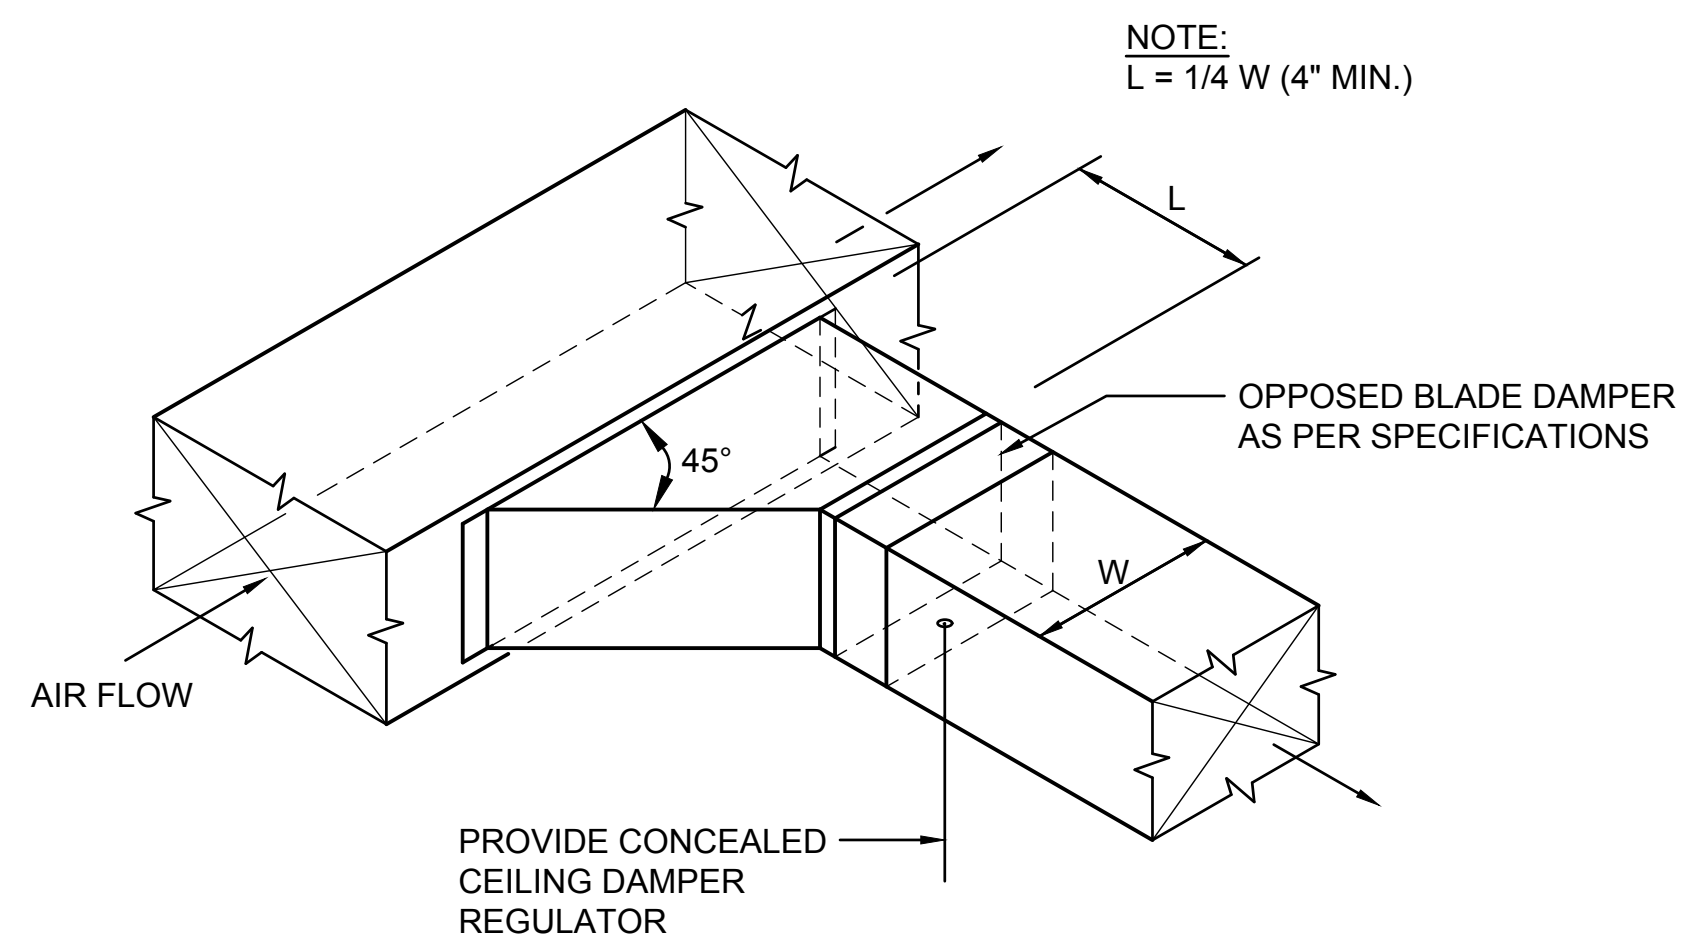


4 BRANCH DUCT TAKE-OFF & DAMPER DETAIL

SCALE: N.T.S.

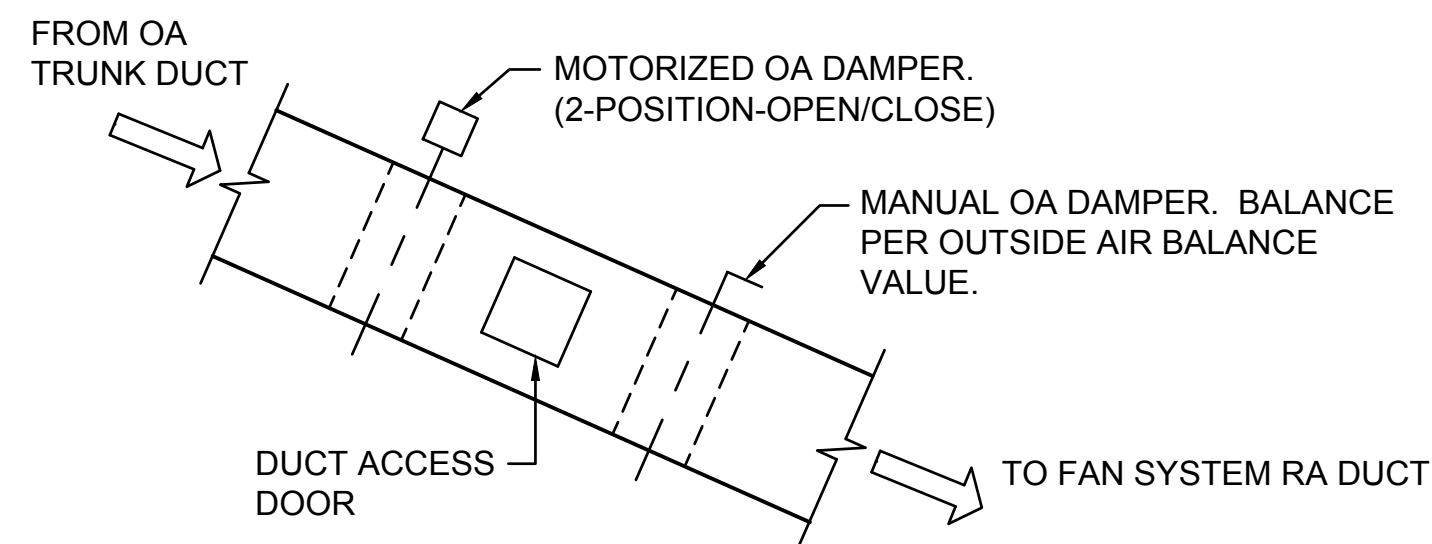


5 TYPICAL MINIMUM OUTSIDE AIR DUCT DETAIL

SCALE: N.T.S.

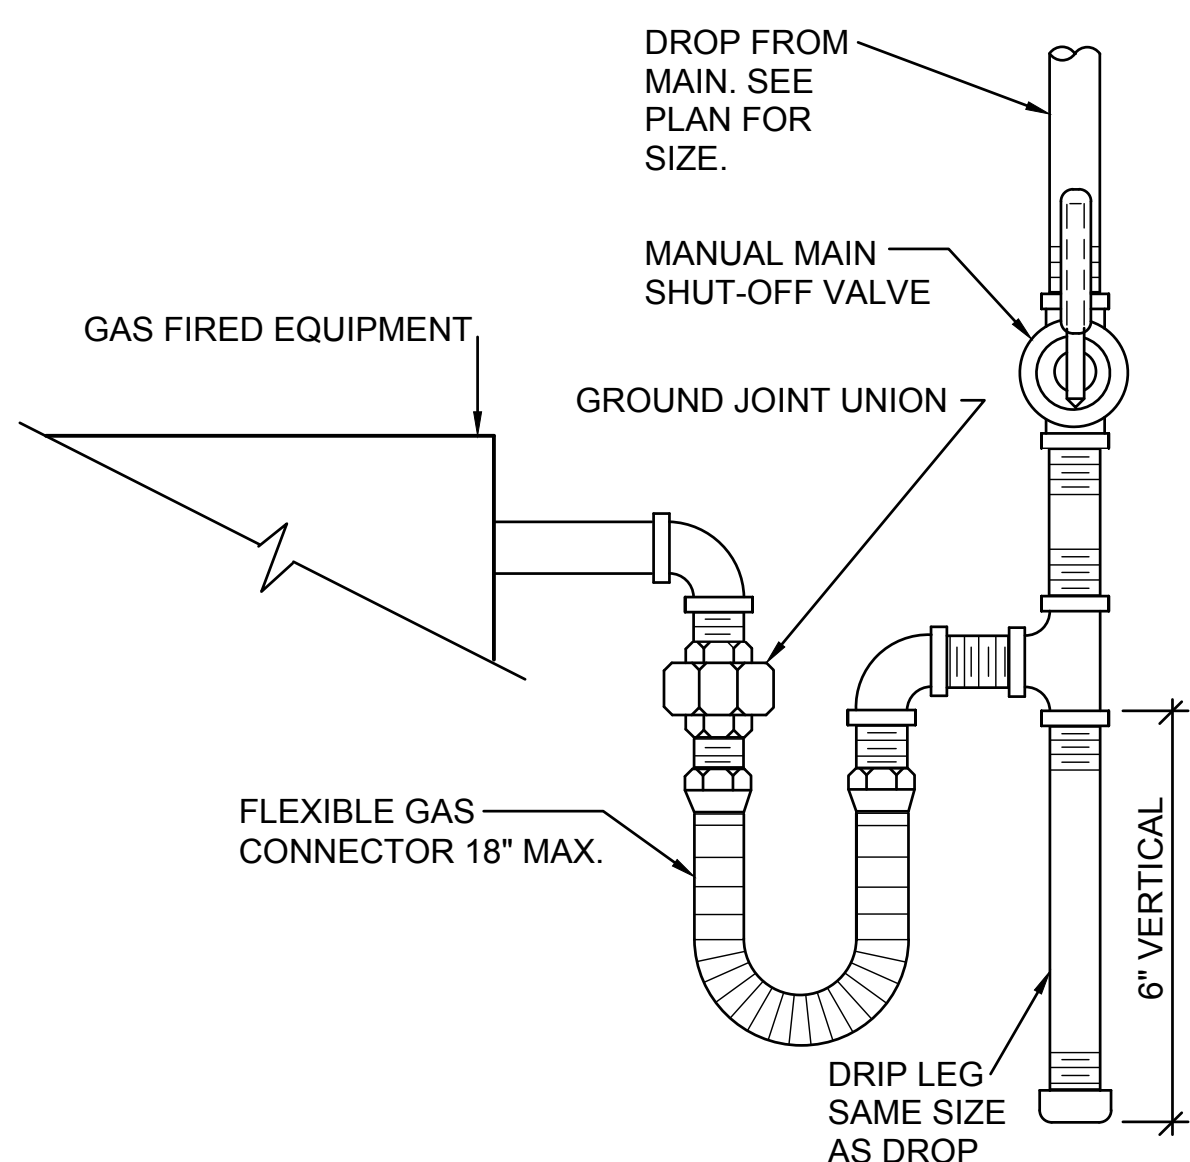


6 GAS LINE CONNECTION DETAIL

SCALE: N.T.S.

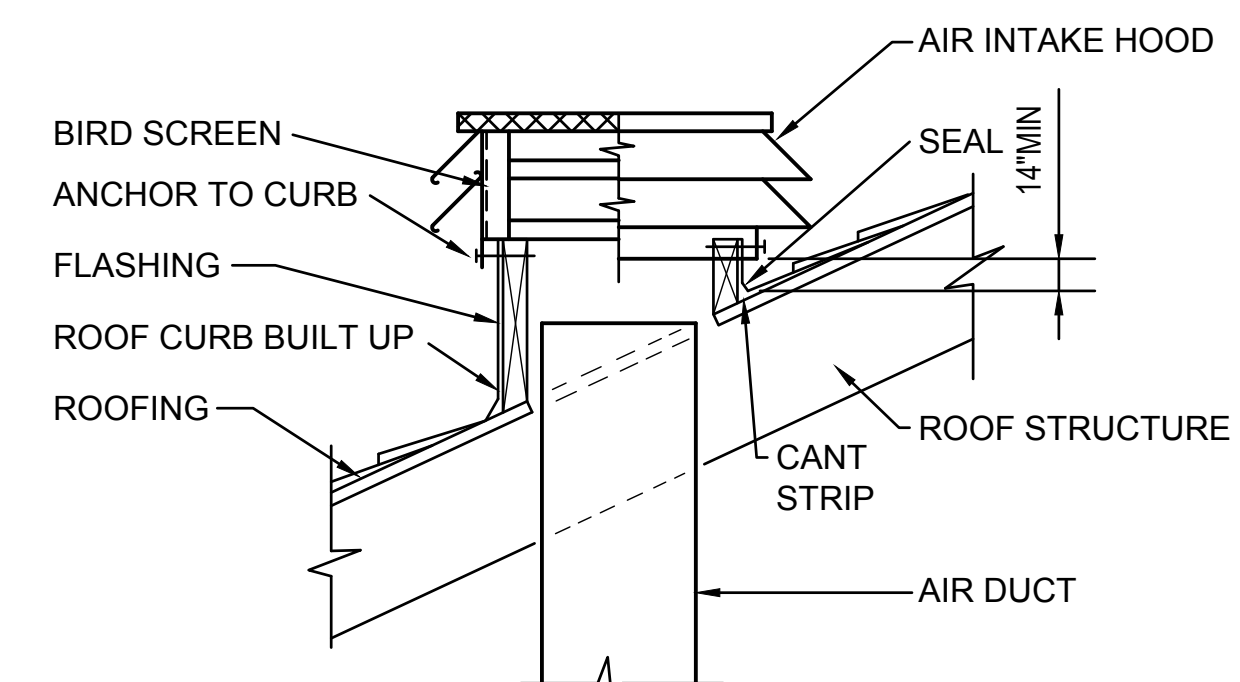

1 PENTHOUSE DETAIL


SCALE: N.T.S.

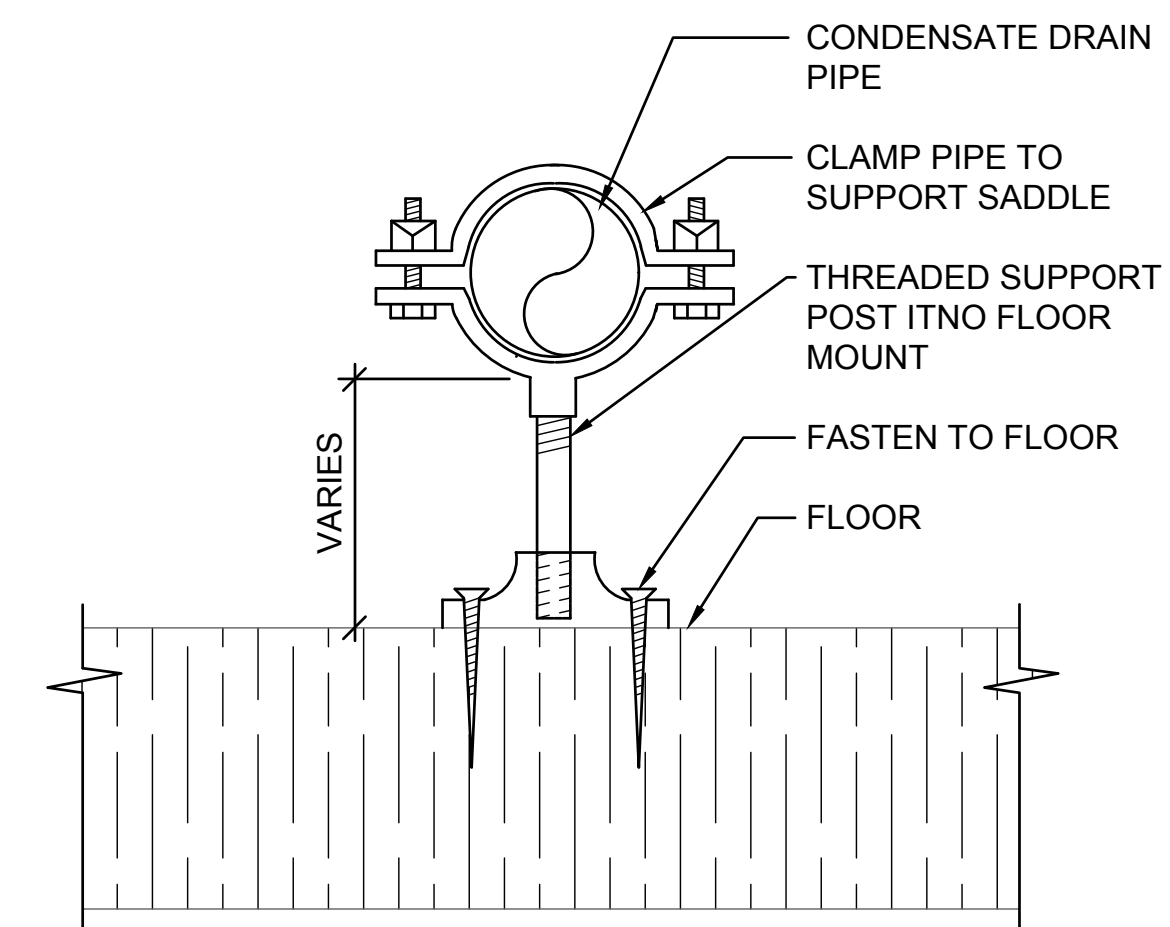

NOTE:
 SUPPORT MAY BE MADE FROM ANGLE IRON OR CHANNELS FASTENED SECURELY TO FLOOR. PIPE MUST BE CLAMPED SECURELY TO SADDLE OR CROSS MEMBER OF PIPE SUPPORT.


2 CONDENSATE DRAIN PIPE SUPPORT DETAIL

SCALE: N.T.S.

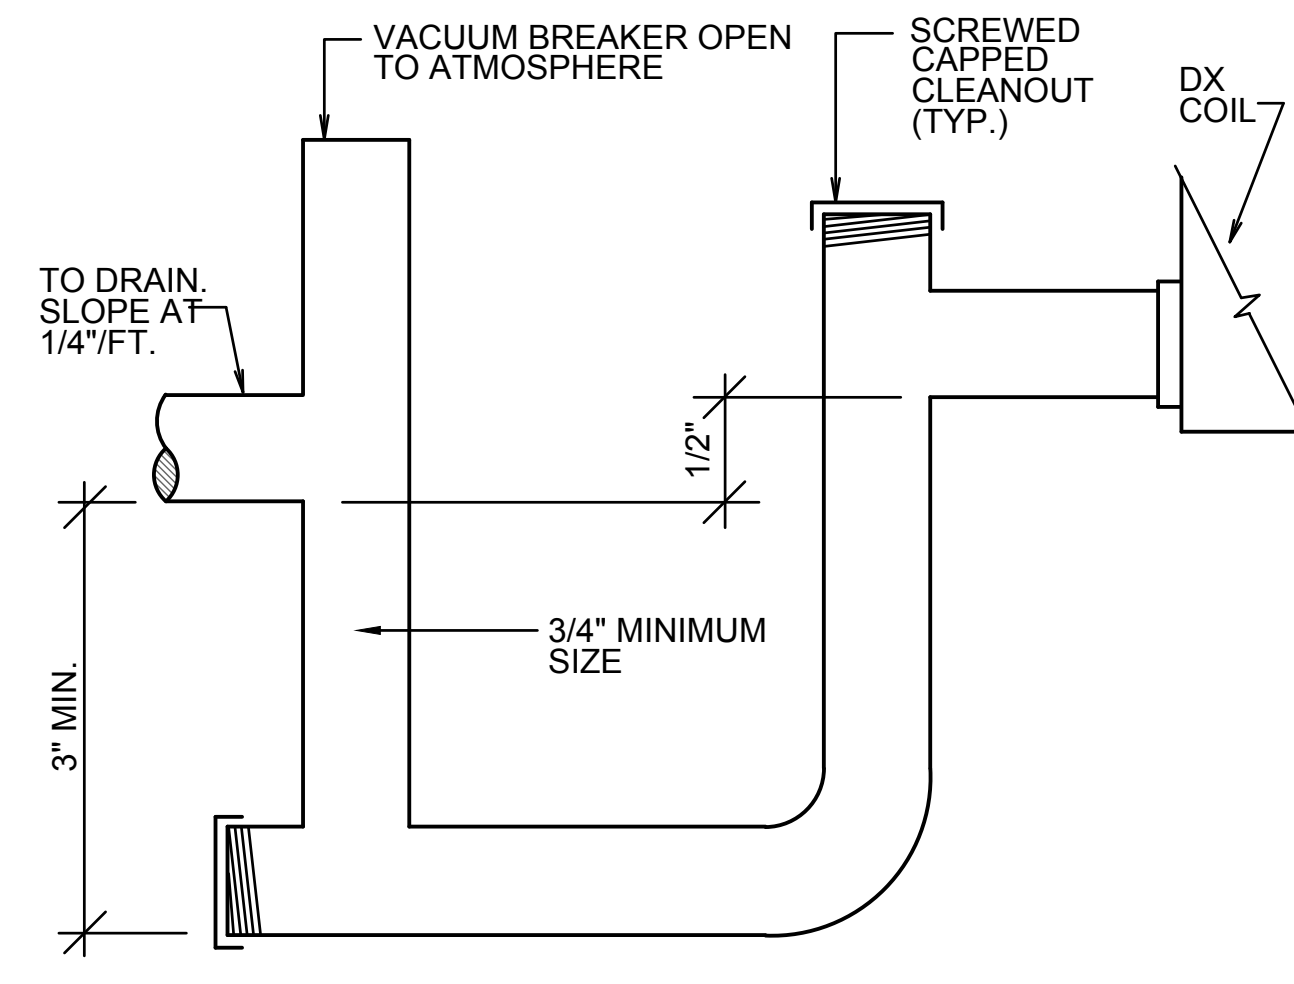

3 DX COIL CONDENSATE DRAIN DETAIL


SCALE: N.T.S.

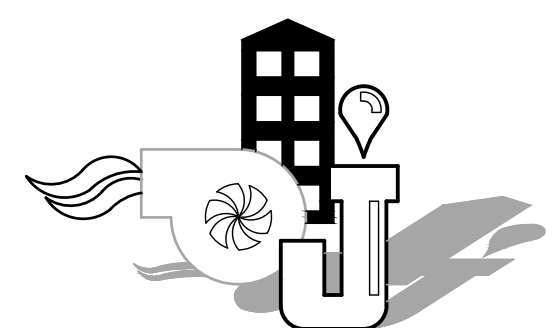

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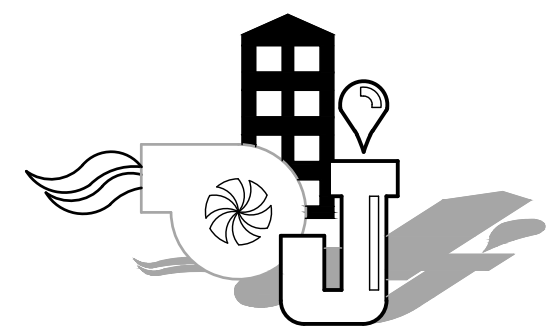
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 ISSUE DATE: JUNE 18, 2020
 PROJECT NO: 18107
 CAD DWG FILE: I:\JOBS\2018\18107\CAD\SCM501.DWG
 DRAWN BY: BDA
 CHECKED BY: HLA

SHEET TITLE

MECHANICAL DETAILS

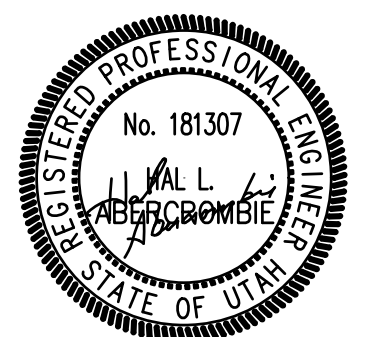SHEET NUMBERS

M501



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PROJECT FOR

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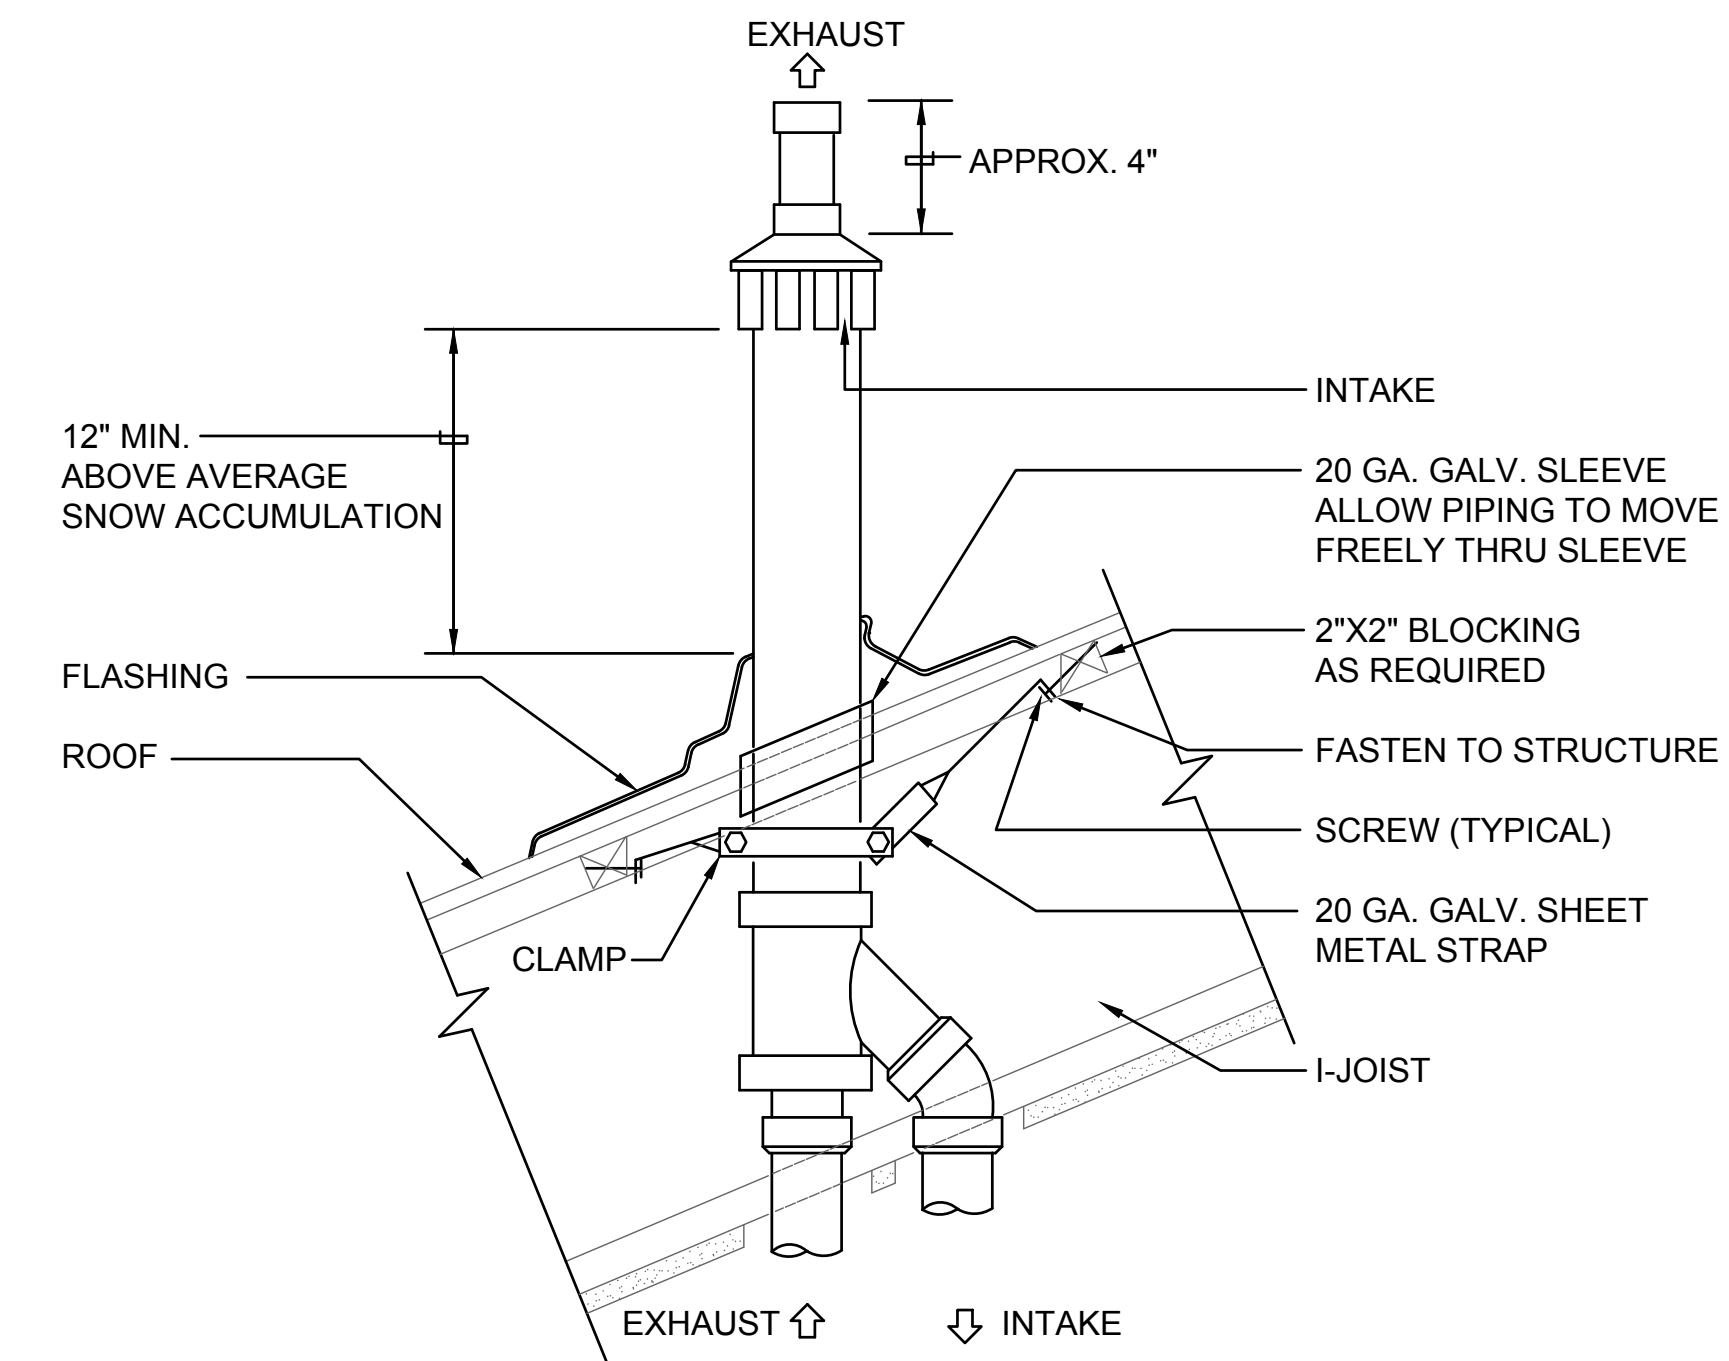
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 DRAWN BY: BDA
 CHECKED BY: HLA

SHEET TITLE

MECHANICAL DETAILS


SHEET NUMBERS

M502




NOTE:
USE EXTENSION KIT NECESSARY TO ACHIEVE CLEARANCE ABOVE SNOW LEVEL.

1 CONCENTRIC ROOF TERMINATION DETAIL
SCALE: N.T.S.

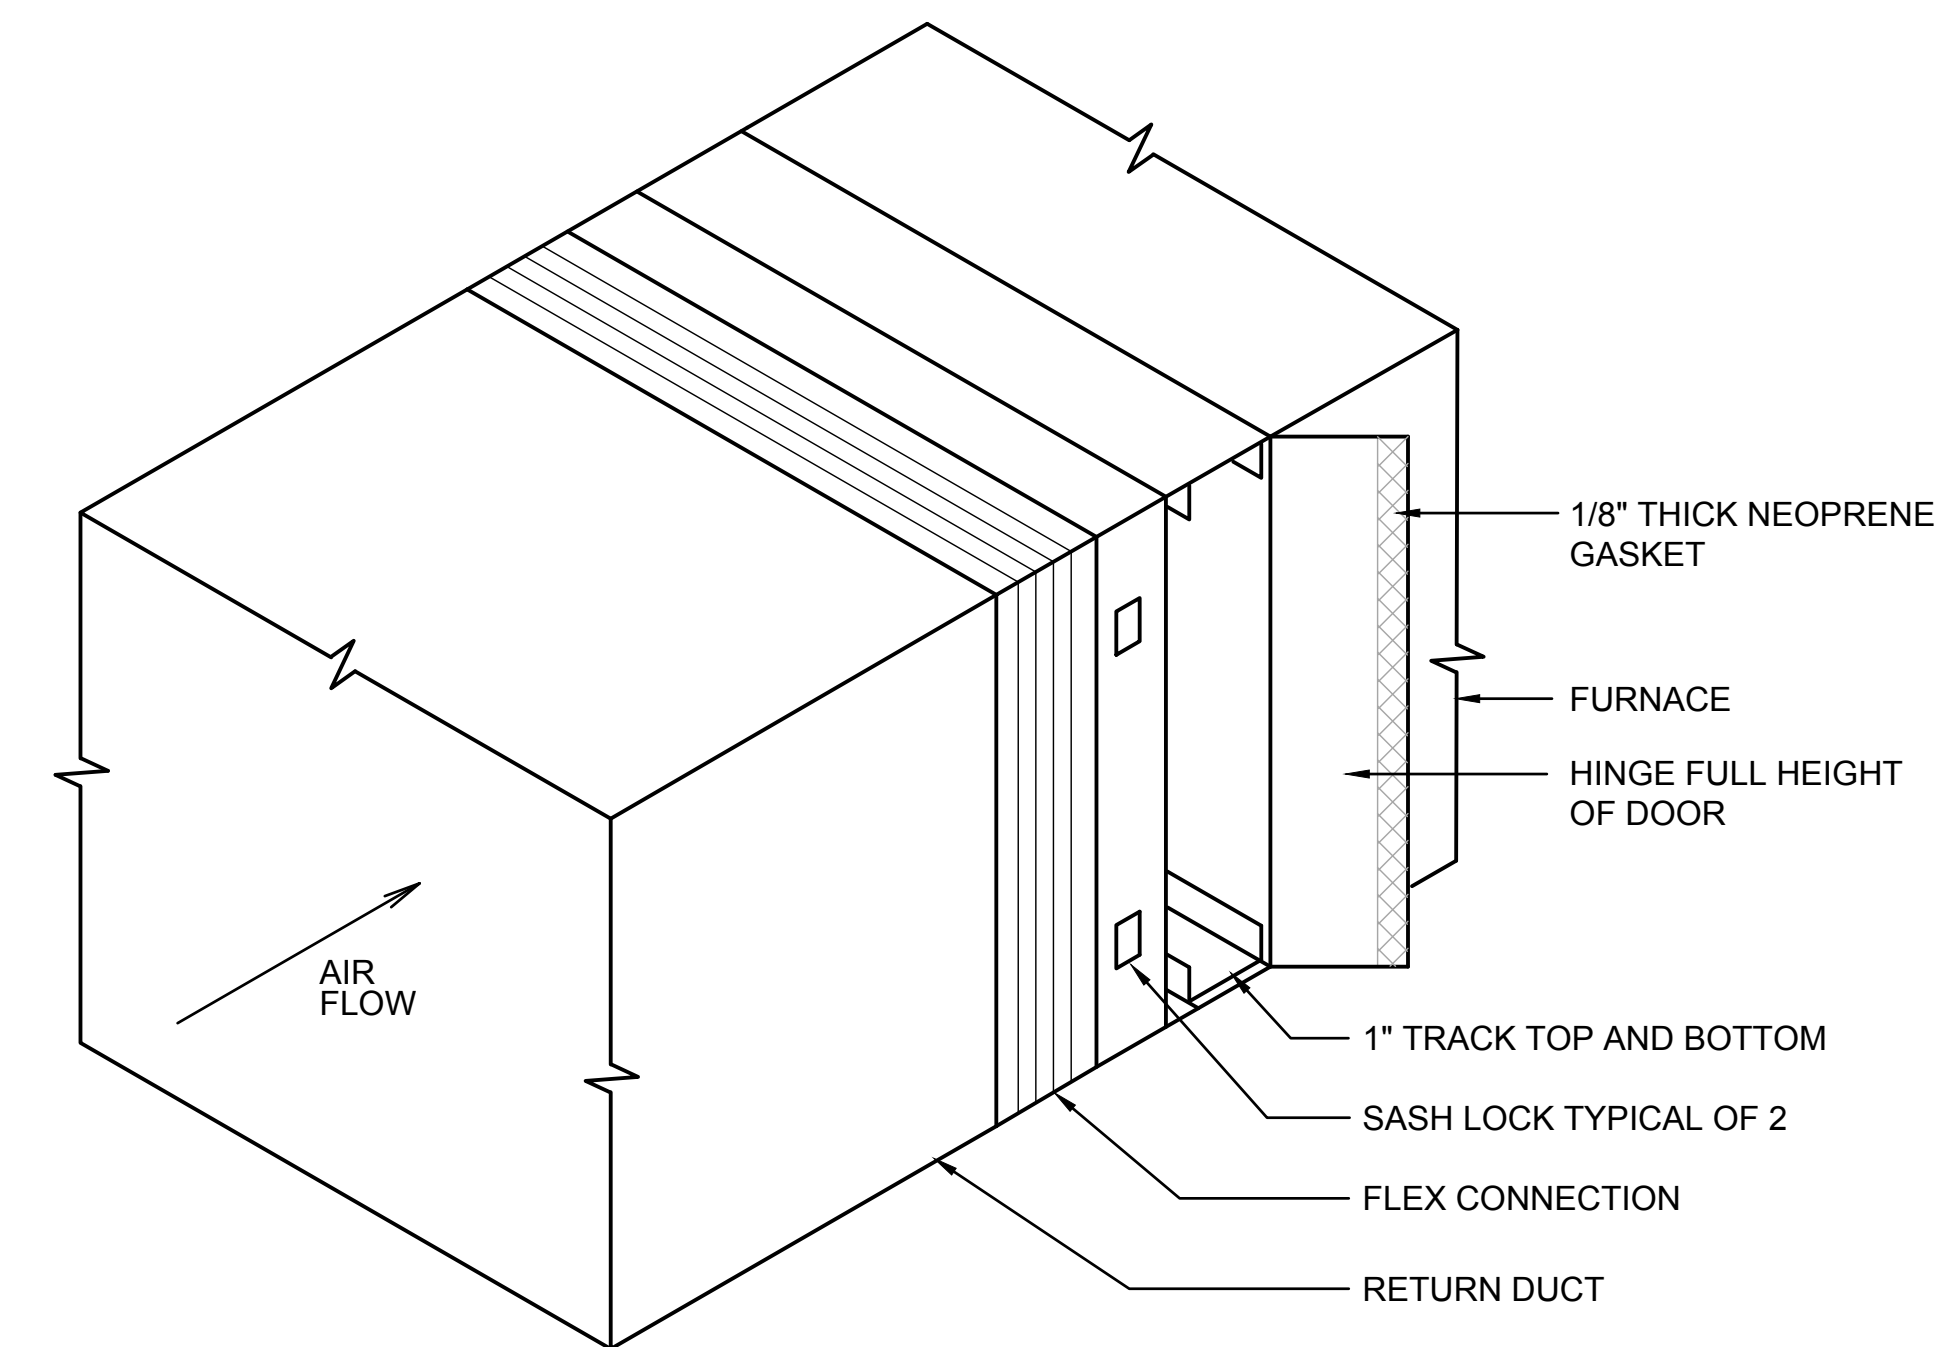

2 EXTERNAL FILTER SECTION DETAIL
SCALE: N.T.S.

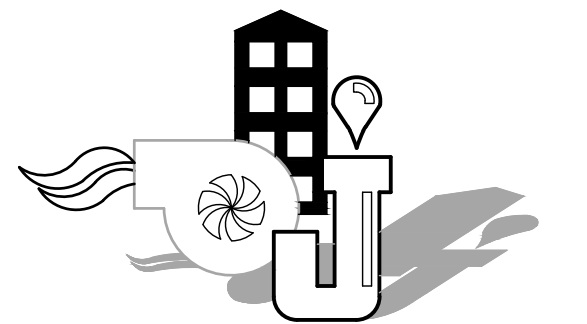

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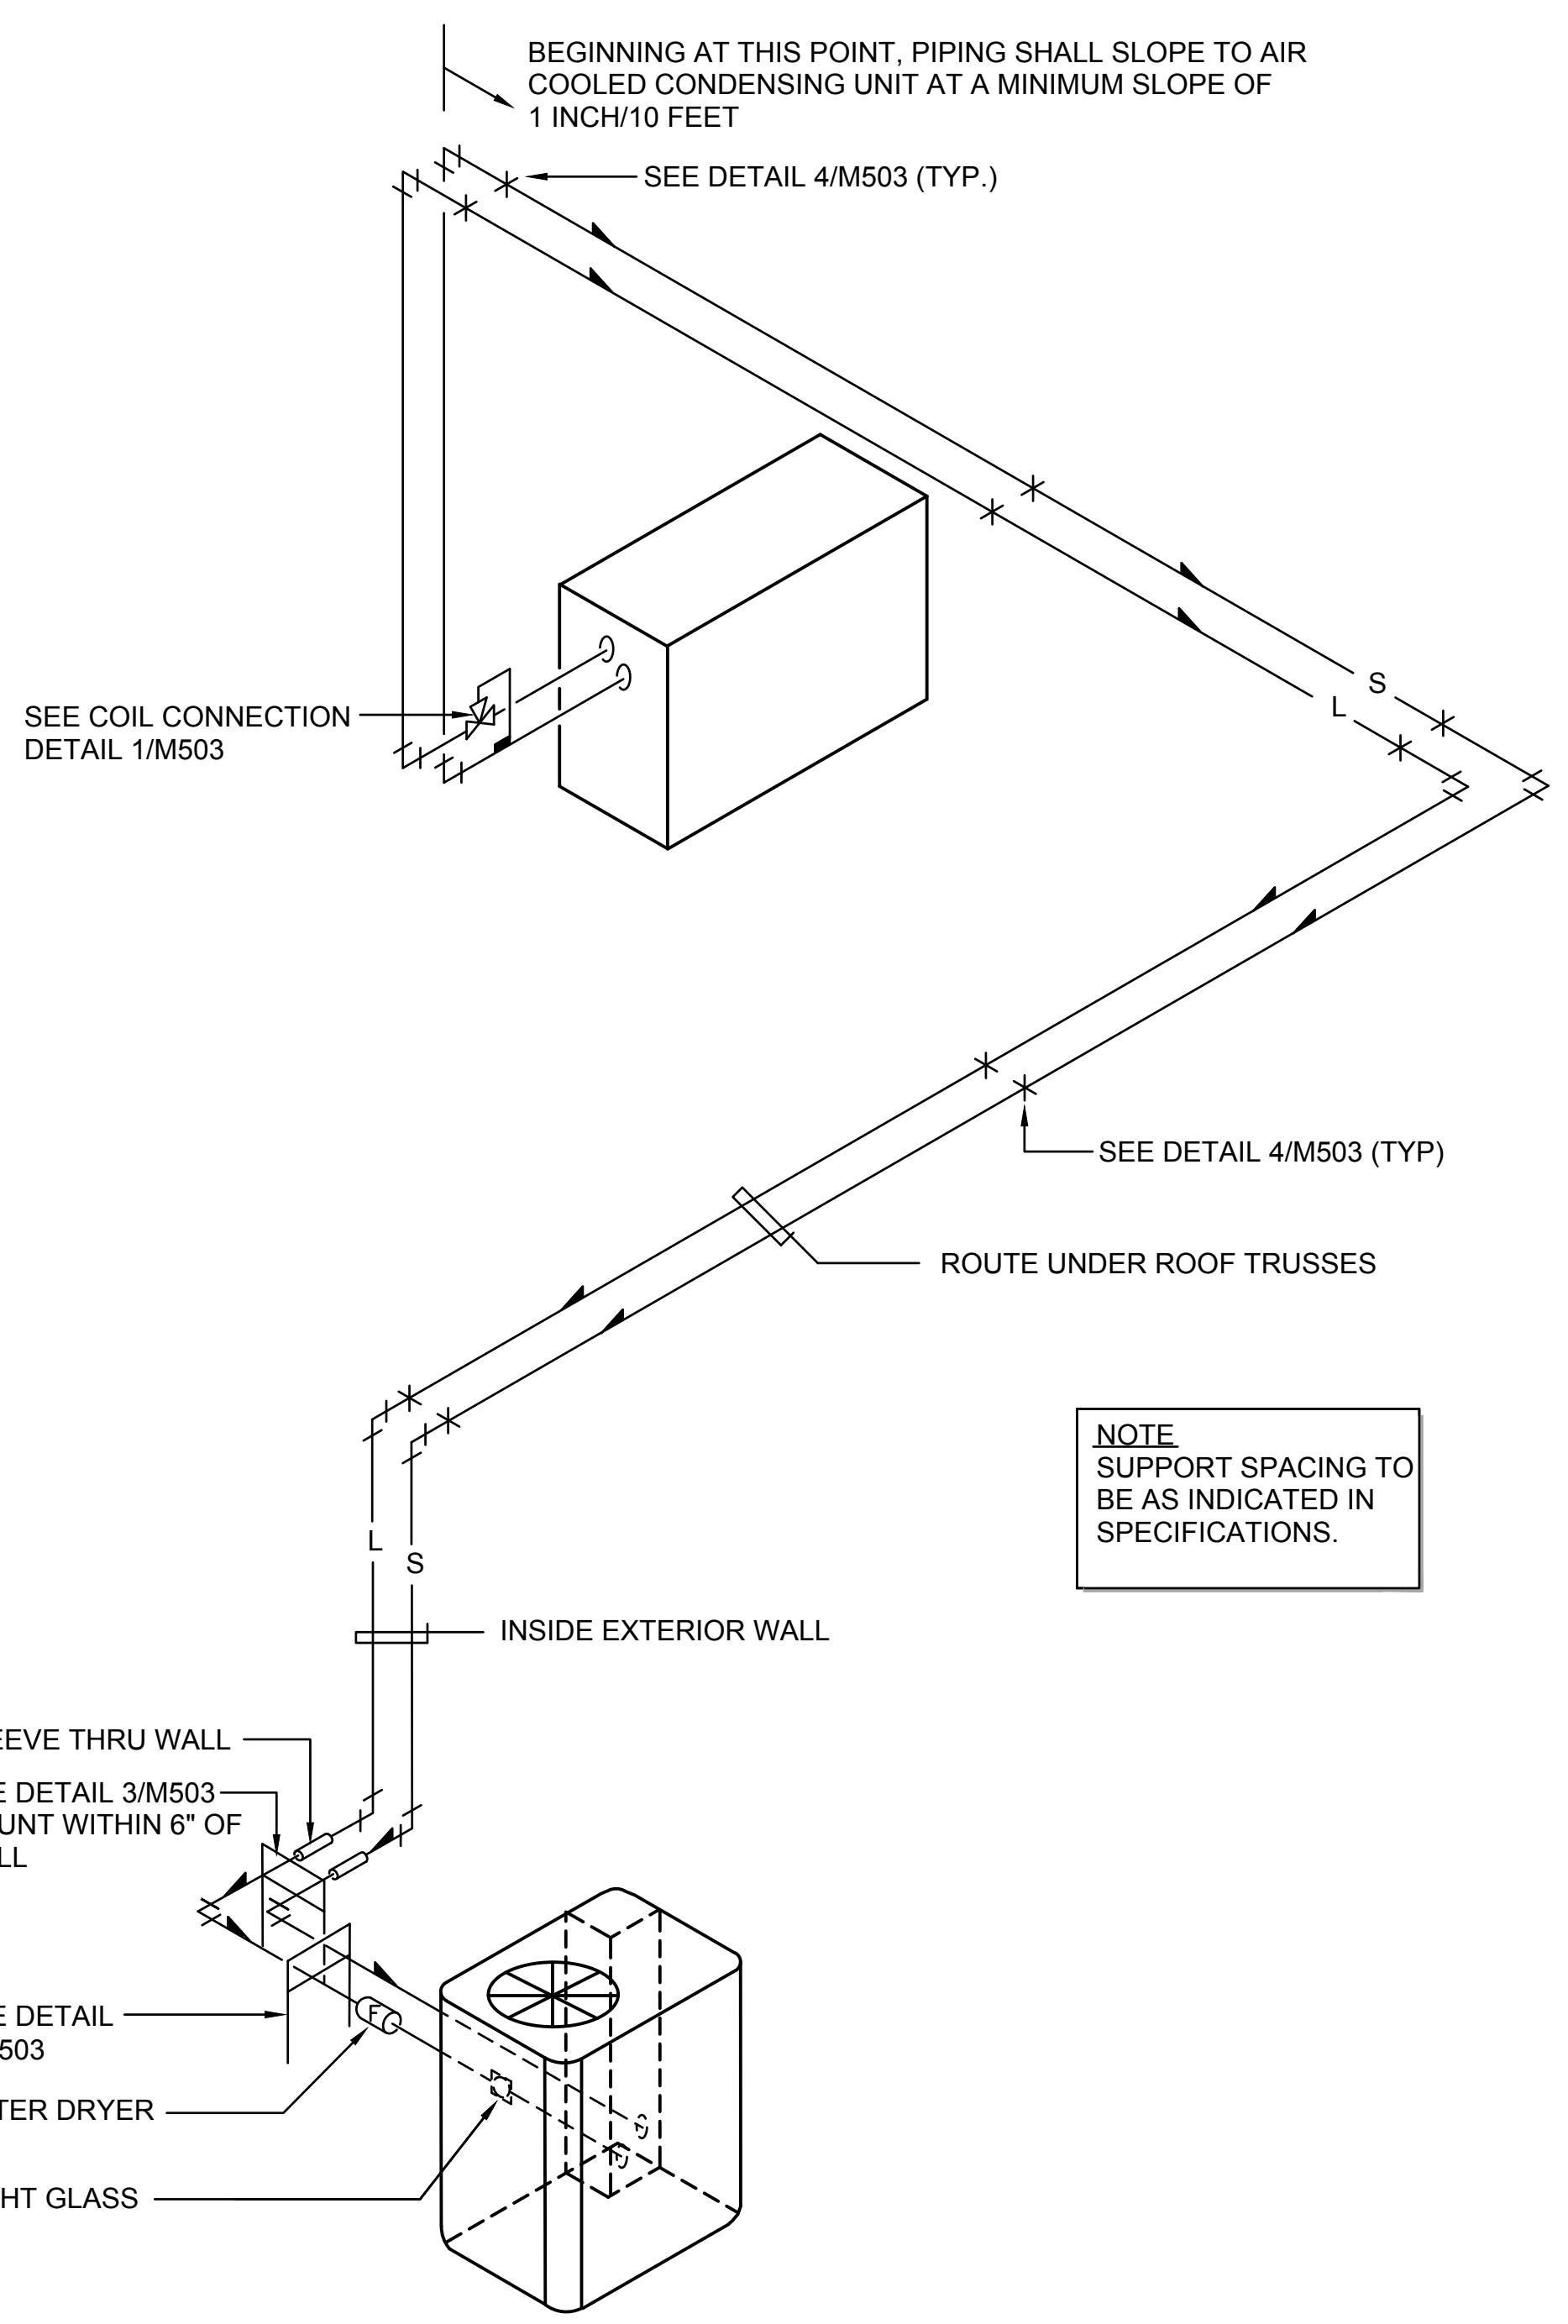
SHEET TITLE

REFRIGERANT
 DETAILS

SHEET NUMBERS


M503

REFRIGERANT PIPING LEGEND	
SYMBOL	DESCRIPTION
	EXPANSION VALVE. SEE DETAIL B/M503
	MOISTURE INDICATING SIGHT GLASS
	FLEXIBLE CONNECTION
	FILTER DRIER
	PIPE SUPPORT. SEE DETAILS C/M503 AND D/M503
	EXTERIOR PIPE SUPPORT. SEE DETAIL E/M503
	DIRECTION OF SLOPE DOWN
	SUCTION LINE
	LIQUID LINE




6 TYPICAL REFRIGERANT SCHEME
 SCALE: N.T.S.


REFRIGERANT PIPING SCHEDULE		
NOTES:		
(1)	REFRIGERANT R-410A	
(2)	SIZES LISTED ARE FOR PIPE WITH EQUIVALENT LENGTHS UP TO 80 FEET AND LESS THAN 20 FEET VERTICAL. FOR LONGER PIPE, REFER TO MANUFACTURER'S GUIDELINES	
SYSTEM SIZE	LIQUID PIPE, DIA	SUCTION PIPE, DIA
4 TONS	3/8	7/8
5 TONS	3/8	1-1/8

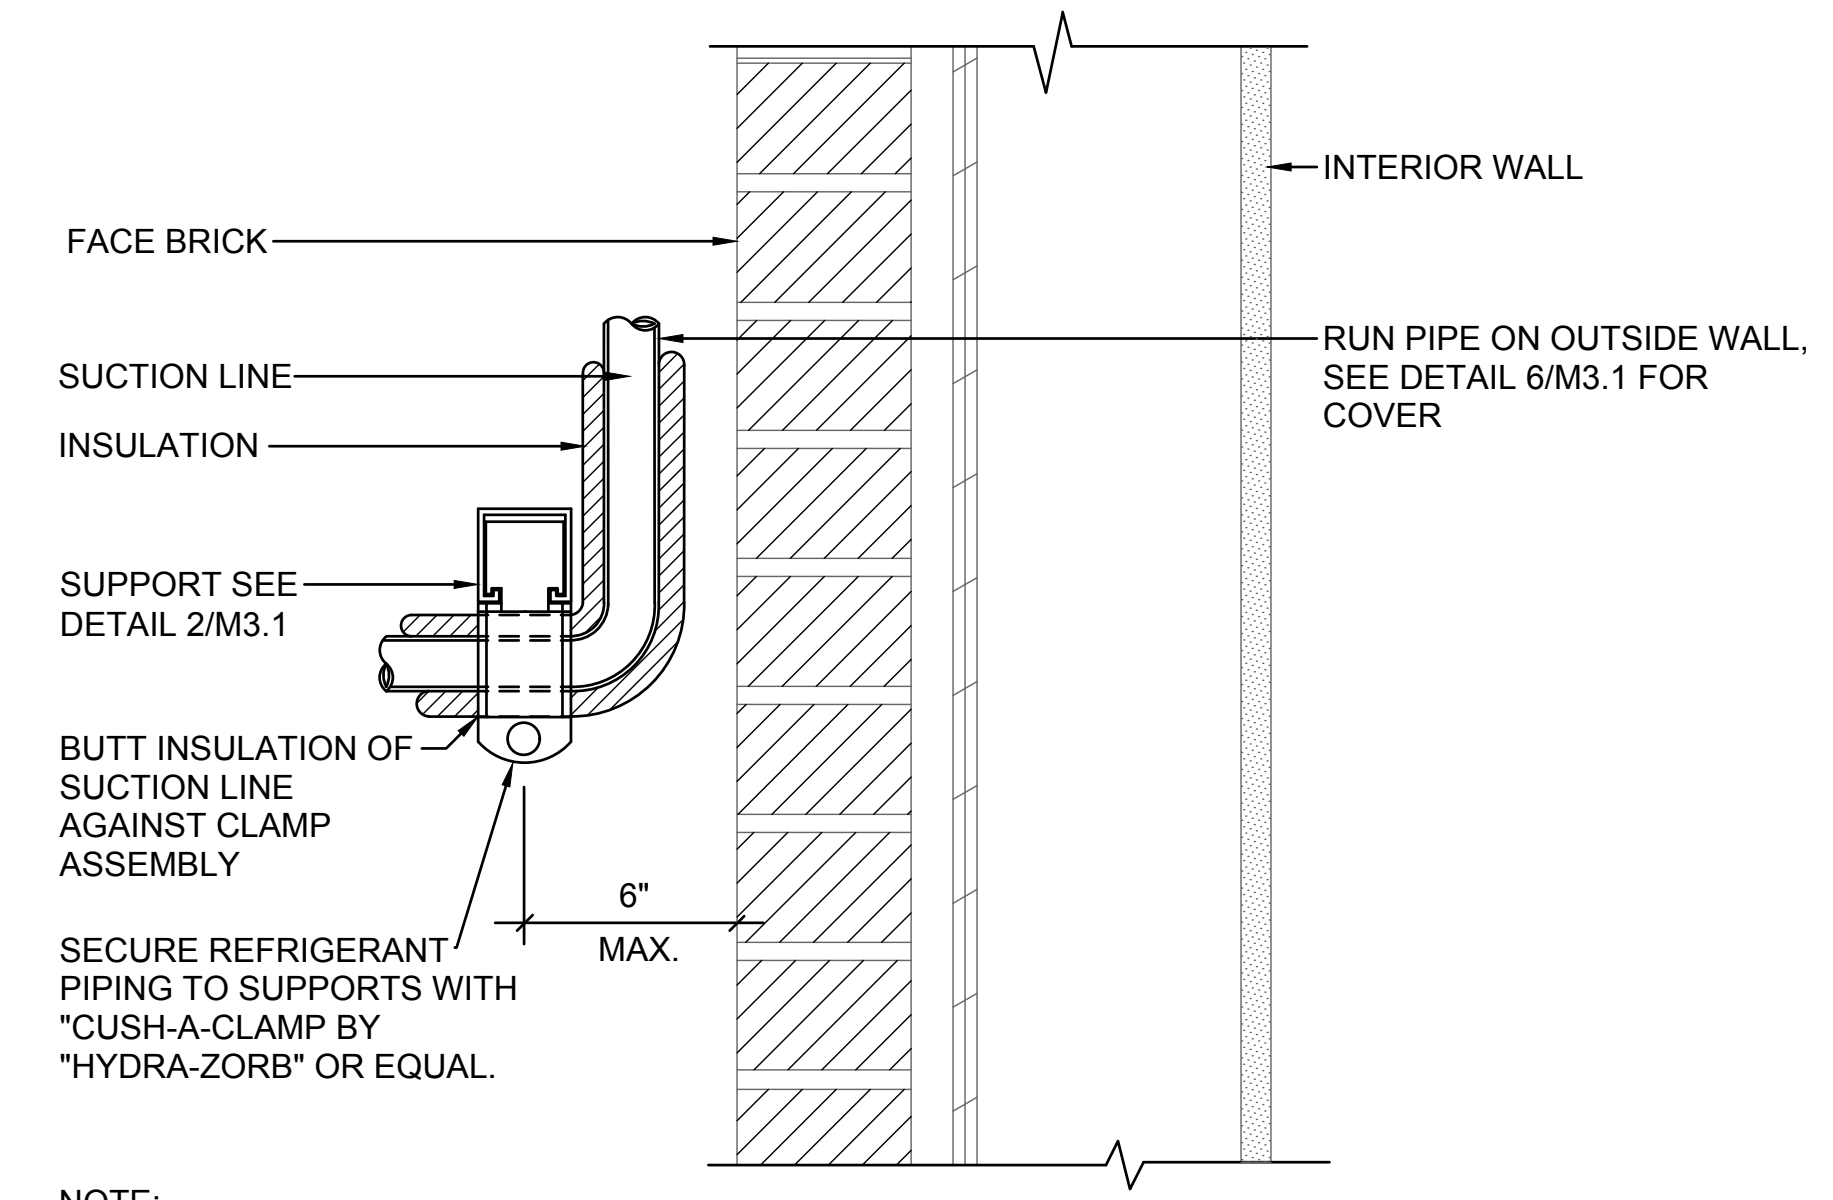


NOTE: LIQUID LINE SIMILAR
3 REFRIGERANT PIPE SUPPORT AT WALL
 SCALE: N.T.S.

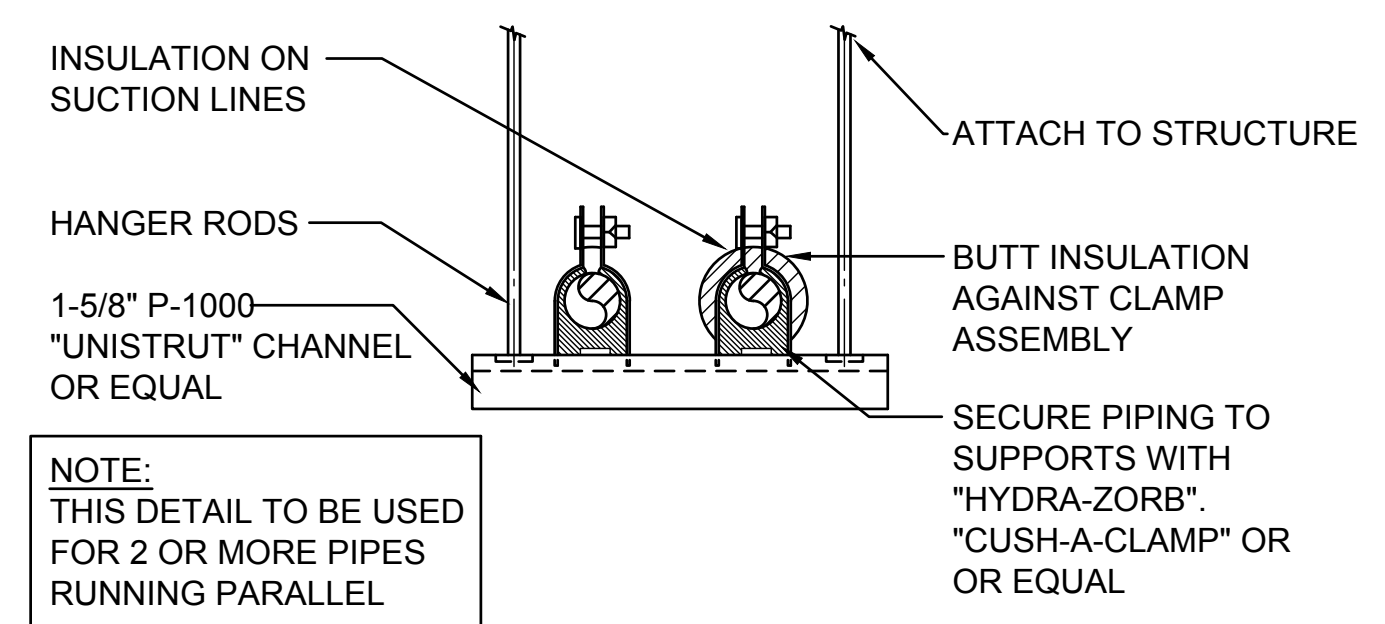


NOTE: THIS DETAIL TO BE USED FOR 2 OR MORE PIPES RUNNING PARALLEL
4 SUSPENDED REFRIGERANT PIPE SUPPORT AT CEILING DETAIL
 SCALE: N.T.S.

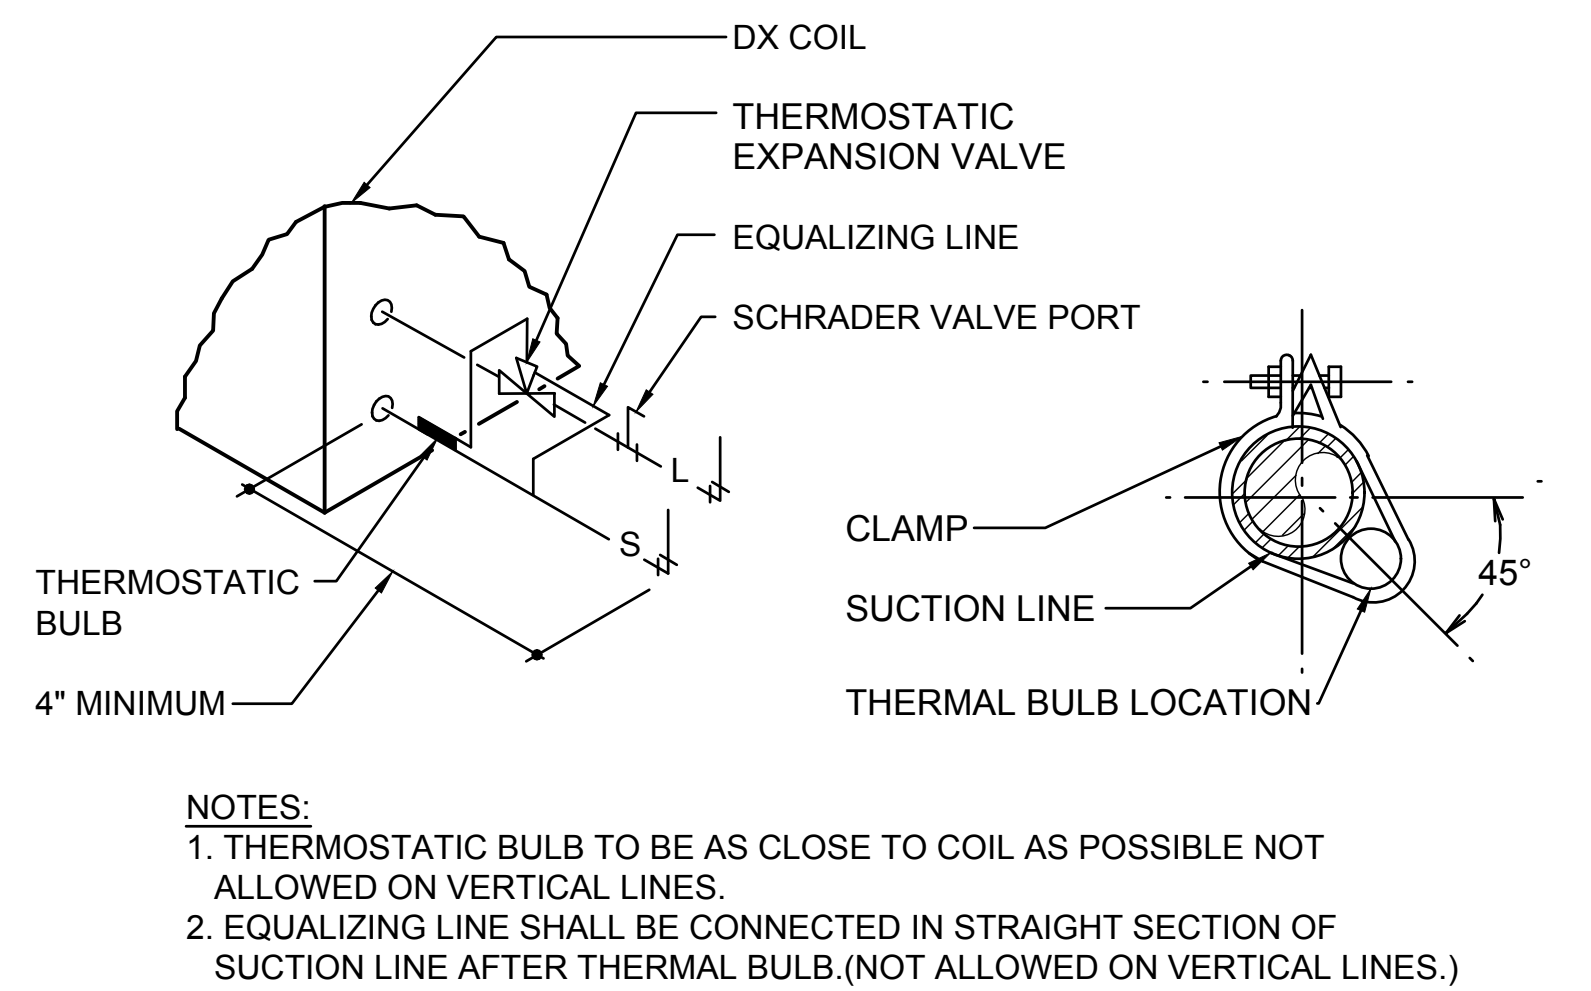


NOTES:
 1. THERMOSTATIC BULB TO BE AS CLOSE TO COIL AS POSSIBLE NOT ALLOWED ON VERTICAL LINES.
 2. EQUALIZING LINE SHALL BE CONNECTED IN STRAIGHT SECTION OF SUCTION LINE AFTER THERMAL BULB. (NOT ALLOWED ON VERTICAL LINES.)
1 REFRIGERANT COIL CONNECTION DETAIL
 SCALE: N.T.S.

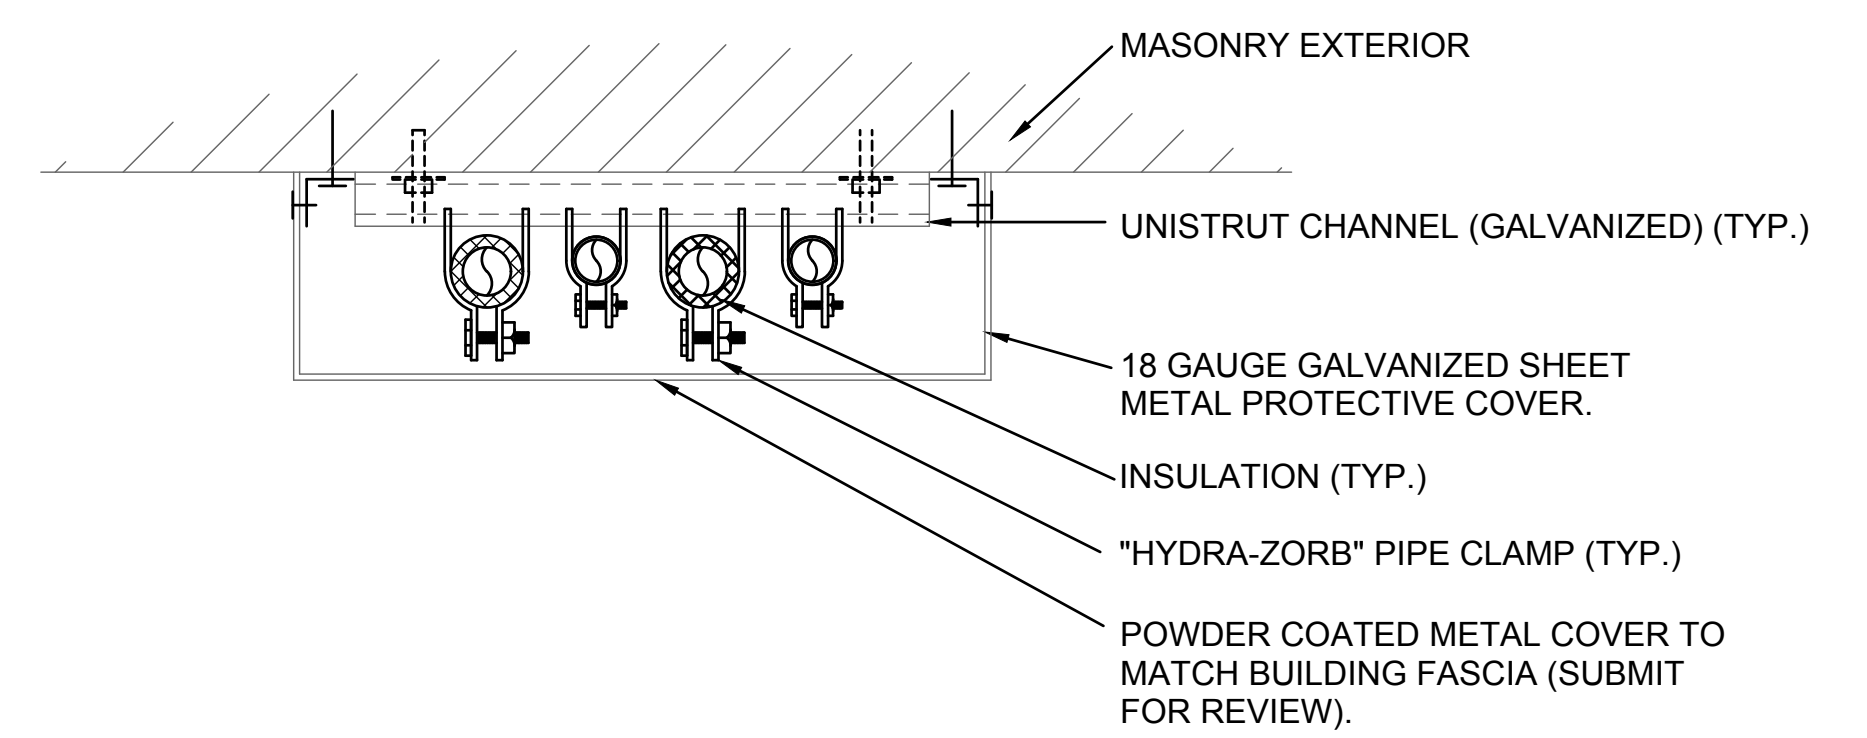

5 REFRIGERANT PIPE COVER AT WALL DETAIL (PC)
 SCALE: N.T.S. OUTSIDE BUILDING

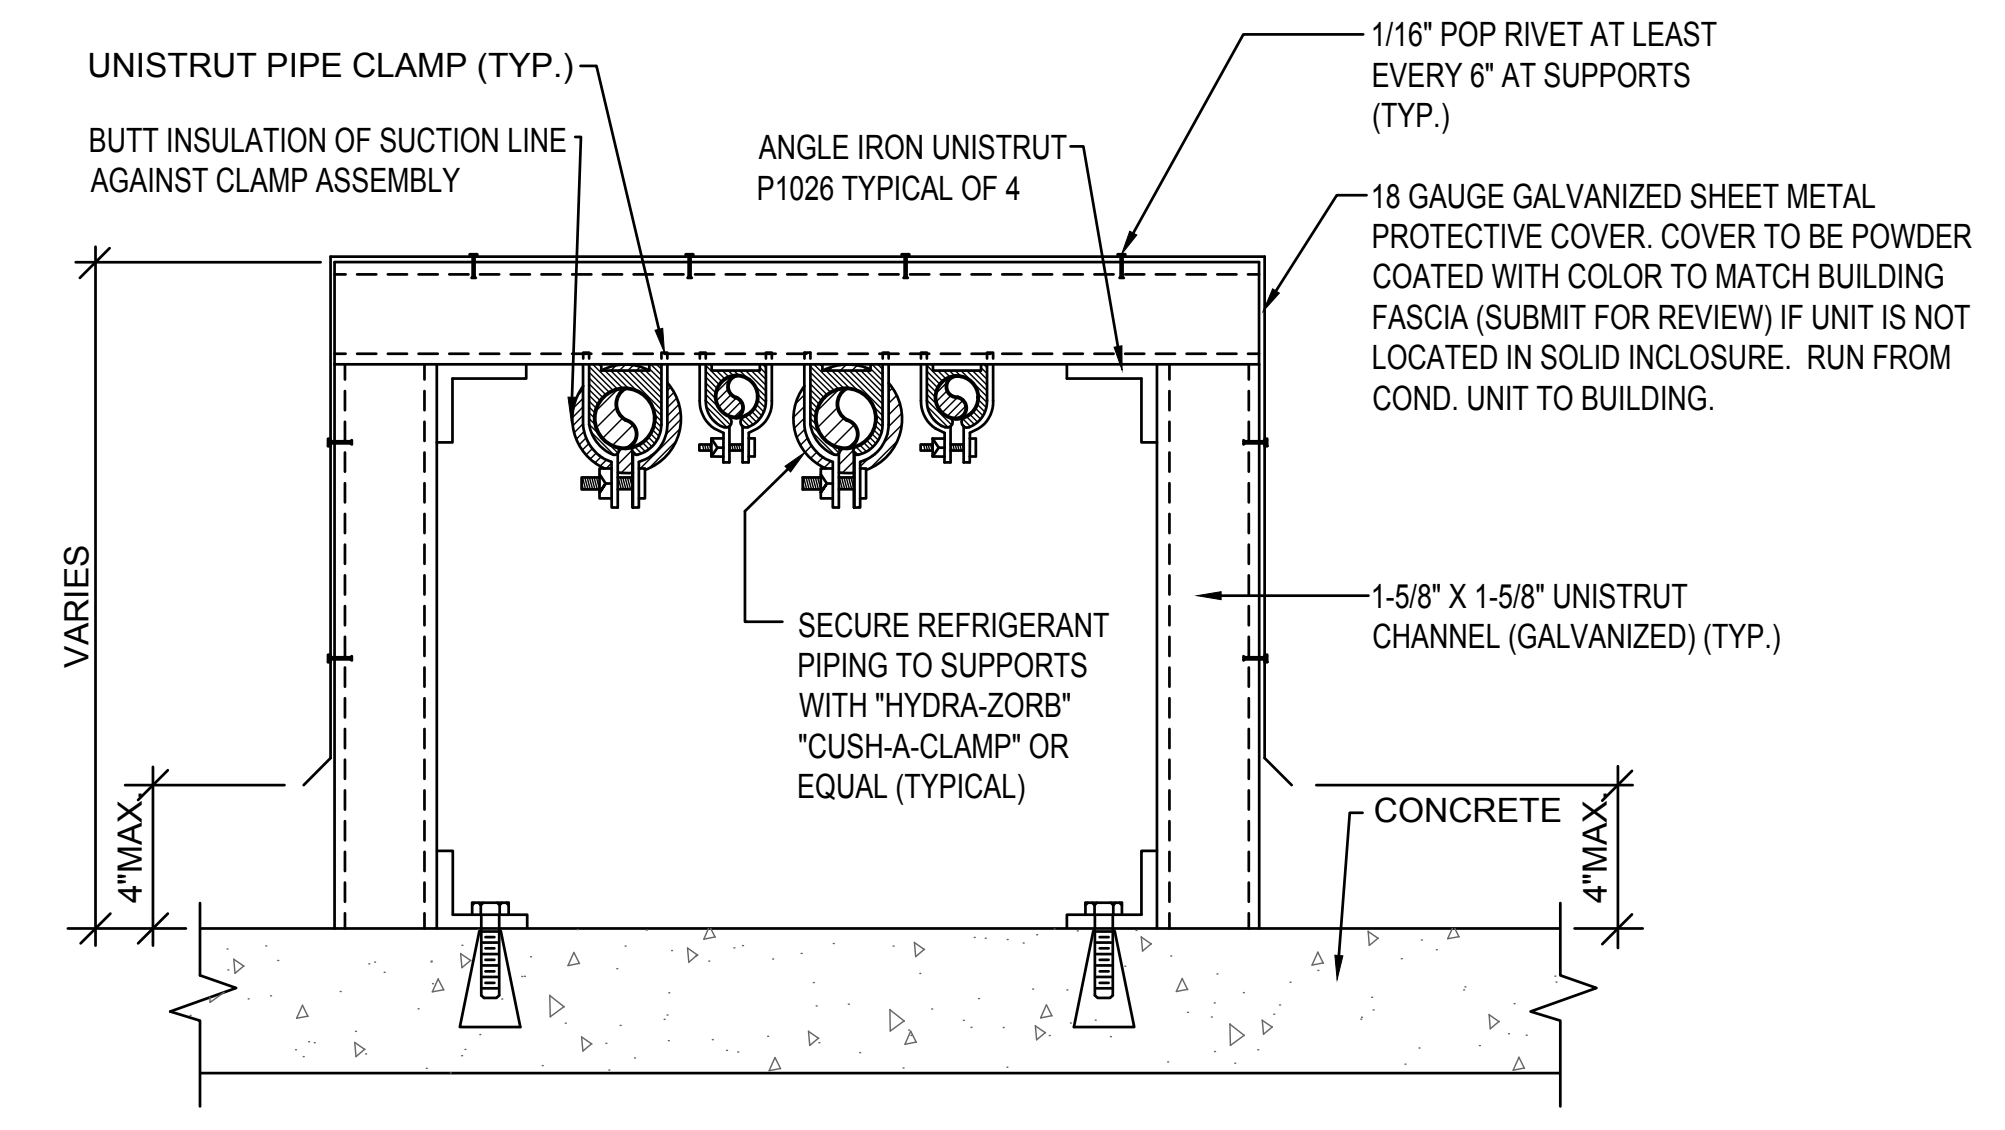


2 EXTERIOR REFRIGERANT PIPE SUPPORT DETAIL
 SCALE: N.T.S.

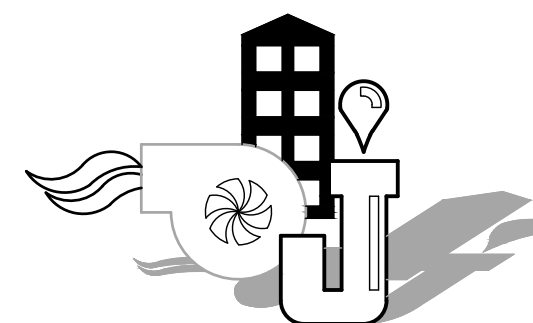

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PROJECT FOR

SALEM 1, 2 & 9 WARDS

SALEM UT WEST STAKE

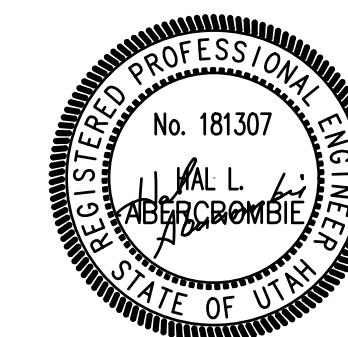PROPERTY NUMBER: 505056119010101

60 SOUTH MAIN STREET

SALEM, UTAH 84653

FURNACE SCHEDULE

NOTES:
 (1) VERTICAL FURNACE
 (2) CONDENSING TYPE, 96% EFFICIENT
 (3) SITE ELEVATION IS 4,250 FT

MARK	MIN. INPUT CAPACITY, BTU/HR	OUTPUT CAPACITY, BTU/HR	AIRFLOW, CFM	ESP. INCHES	ELECTRICAL REQUIREMENTS		OUTSIDE AIR CFM	CARRIER MODEL	REMARKS
					VOLTS/HERTZ/PHASE	HP			
F-7	80,000	78,000	1,600	0.7	120 / 60 / 1	1	235	59SC5B080S211316	
F-8	100,000	97,000	2,000	0.7	120 / 60 / 1	1	370	59SC5B100S211020	

CONDENSING UNIT SCHEDULE

NOTES:
 (1) MOUNT ON GROUND ON CONCRETE PAD
 (2) PROVIDE WITH LOW AMBIENT KIT TO OPERATE DOWN TO 0 DEGREES

MARK	NOMINAL CAPACITY, TONS	REQUIRED CAPACITY, TONS	REFRIGERANT	AMBIENT TEMP, DEG F	SEER	ELECTRICAL REQUIREMENTS			CARRIER MODEL
						VOLTS/HERTZ/PHASE	MCA	MOCP	
CU-7	4	3.1	R-410A	95	13	208/60/3	17.8	30	24ABB348A0N50
CU-8	5	3.9	R-410A	95	13	208/60/3	21.4	30	24ABB360A0N50

DX COIL SCHEDULE

NOTES:
 (1) HORIZONTAL ARRANGEMENT
 (2) SITE ELEVATION IS 4,250 FT
 (3) 40 DEGREE EVAP TEMPERATURE

MARK	TOTAL CAPACITY, BTU/HR	SENSIBLE CAPACITY, BTU/HR	ENTERING COIL CONDITIONS		AIRFLOW, CFM	PRESS. DROP, INCHES	CARRIER MODEL
			DRY BULB, F	WET BULB, F			
CC - 7	62700	40100	78.8	55.5	1600	0.17	CNPVP6024ACA
CC - 8	71500	46700	78.8	55.5	2000	0.24	CNPVP6124ACA

PENTHOUSE SCHEDULE

NOTES:
 (1) OUTSIDE AIR
 (2) PROVIDE WITH 14 INCH ROOF CURB

MARK	AIRFLOW, CFM	APD, INCHES	THROAT SIZE, INCHES	OVERALL PENTHOUSE SIZE, INCHES	CURB HEIGHT, INCHES	TEIR	COOK MODEL	REMARKS
PH-2	620	0.05	14 X 14	26 X 26 X 9	14	2	TRE	

REGISTER & GRILLE SCHEDULE

NOTES:
 (1) MAXIMUM NC-25 @ MAXIMUM CFM.
 (2) CONTRACTOR TO FIELD VERIFY EXISTING FLOOR OPENING SIZE BEFORE ORDERING.

MARK	TYPE	SERVICE	CFM RANGE	NECK SIZE, INCHES	MODEL	REMARKS
R-1	FLOOR	RETURN	225-295	19-1/2 X 3-1/2	TITUS CT-580	(2)
R-2	FLOOR	RETURN	225-285	23-1/2 X 3-1/2	TITUS CT-580	(2)
R-3	FLOOR	RETURN	300	23-1/2 X 5-1/2	TITUS CT-580	(2)
R-4	WALL	RETURN	225	16"X8"	TITUS 33RL	(2)

DIFFUSER SCHEDULE

NOTES:
 (1) MAXIMUM NC OF 25 @ MAXIMUM CFM
 (2) FINISH SHALL BE BAKED ENAMEL WITH COLOR AS SELECTED BY ARCHITECT.
 (3) ALL DIFFUSERS ARE 360 DEGREE BLOW UNLESS OTHERWISE NOTED ON PLAN.
 (4) BORDER TYPE 1 (SURFACE MOUNT) TO BE USED.

MARK	TYPE	SERVICE	NECK SIZE, INCHES	CFM RANGE	MODEL	REMARKS
D-1	HARD CEILING	SUPPLY	6 X 6	0 - 125	TITUS TDC	

PLUMBING FIXTURE SCHEDULE

NOTES:
 (1) INSTALL NEW FLOOR DRAIN IN CONCRETE FLOOR.

MARK	FIXTURE	PIPE SIZE						REMARKS
		TRAP	WASTE	VENT	CW	HW	AIR	
FD-1	FLOOR DRAIN	2	2	1.5				(1)

MARK	DATE	DESCRIPTION
1		
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ISSUE TYPE: **CONSTRUCTION DOCUMENTS**
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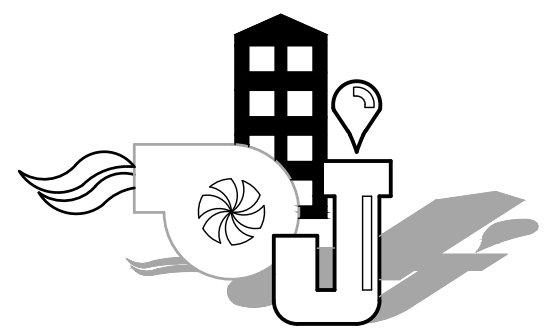
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SHEET TITLE

MECHANICAL SCHEDULES

SHEET NUMBERS

M601



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PROPERTY NUMBER: 505056119010101
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SHEET TITLE

**AUTOMATIC
TEMPERATURE
CONTROL WIRING
AND SCHEDULE**

SHEET NUMBERS


ME101

NOTES:

1. THERMOSTAT CABLE- 4, 8 OR 12 CONDUCTOR- 18 AWG SOLID COPPER WIRE INSULATED WITH HIGH DENSITY POLYETHYLENE. CONDUCTORS PARALLEL. ENCLOSED IN BROWN PVC JACKET. (NO 22 AWG CABLE ALLOWED).
2. IF CONDENSING UNITS HAVE THEIR OWN POWER SUPPLY IT MAY BE NECESSARY TO ADD ADDITIONAL RELAYS IN CONDENSING UNIT TO PROPERLY INTERFACE CONTROLS.
3. USE WIRE NUT CONNECTORS FOR SPLICING CONDUCTORS IN SPECIFIED LOCATIONS. AND TYTON TYPE CRIMP CONNECTORS FOR TERMINAL CONNECTIONS. NO TERMINAL CONNECTORS REQUIRED AT THERMOSTAT OR SENSOR.
4. DO NOT RUN ANY OTHER WIRING IN THIS CONDUIT EXCEPT THERMOSTAT CABLE.
5. VERIFY THAT FURNACE FAN SPEED CONTROL WIRING IS SET TO MATCH SCHEDULE SHEET AND THAT FAN OPERATES AT COOLING SPEED ONLY.
6. DO NOT SPLICE WIRE IN RUNS FROM SENSOR TO THERMOSTAT, THERMOSTAT TO FURNACE, AND THERMOSTAT TO DISCHARGE AIR SENSOR.
7. PROVIDE CHASE NIPPLE W/PLASTIC BUSHING WHEN ATTACHING J-BOX TO EQUIPMENT.
8. PROVIDE CABLE CLAMP SO THAT CABLES CANNOT BE PULLED OUT OF J-BOX.

CONTROL EQUIPMENT		
MARK	DESCRIPTION	CAT. NO. (1)
T-1	THERMOSTAT	T7350H1009
S-1	REMOTE TEMPERATURE SENSOR SELECTABLE 10K OHM OR 20K OHM	T7771A1005
DS-1	DISCHARGE AIR SENSOR	C7041B2005
X-2	TRANSFORMER 120V/24V 50VA	AT150F1002
DM-1	DAMPER MOTOR TWO POSITION	MS8105A1030

(1) ALL CATALOG NUMBERS SHOWN ARE HONEYWELL UNLESS NOTED OTHERWISE.

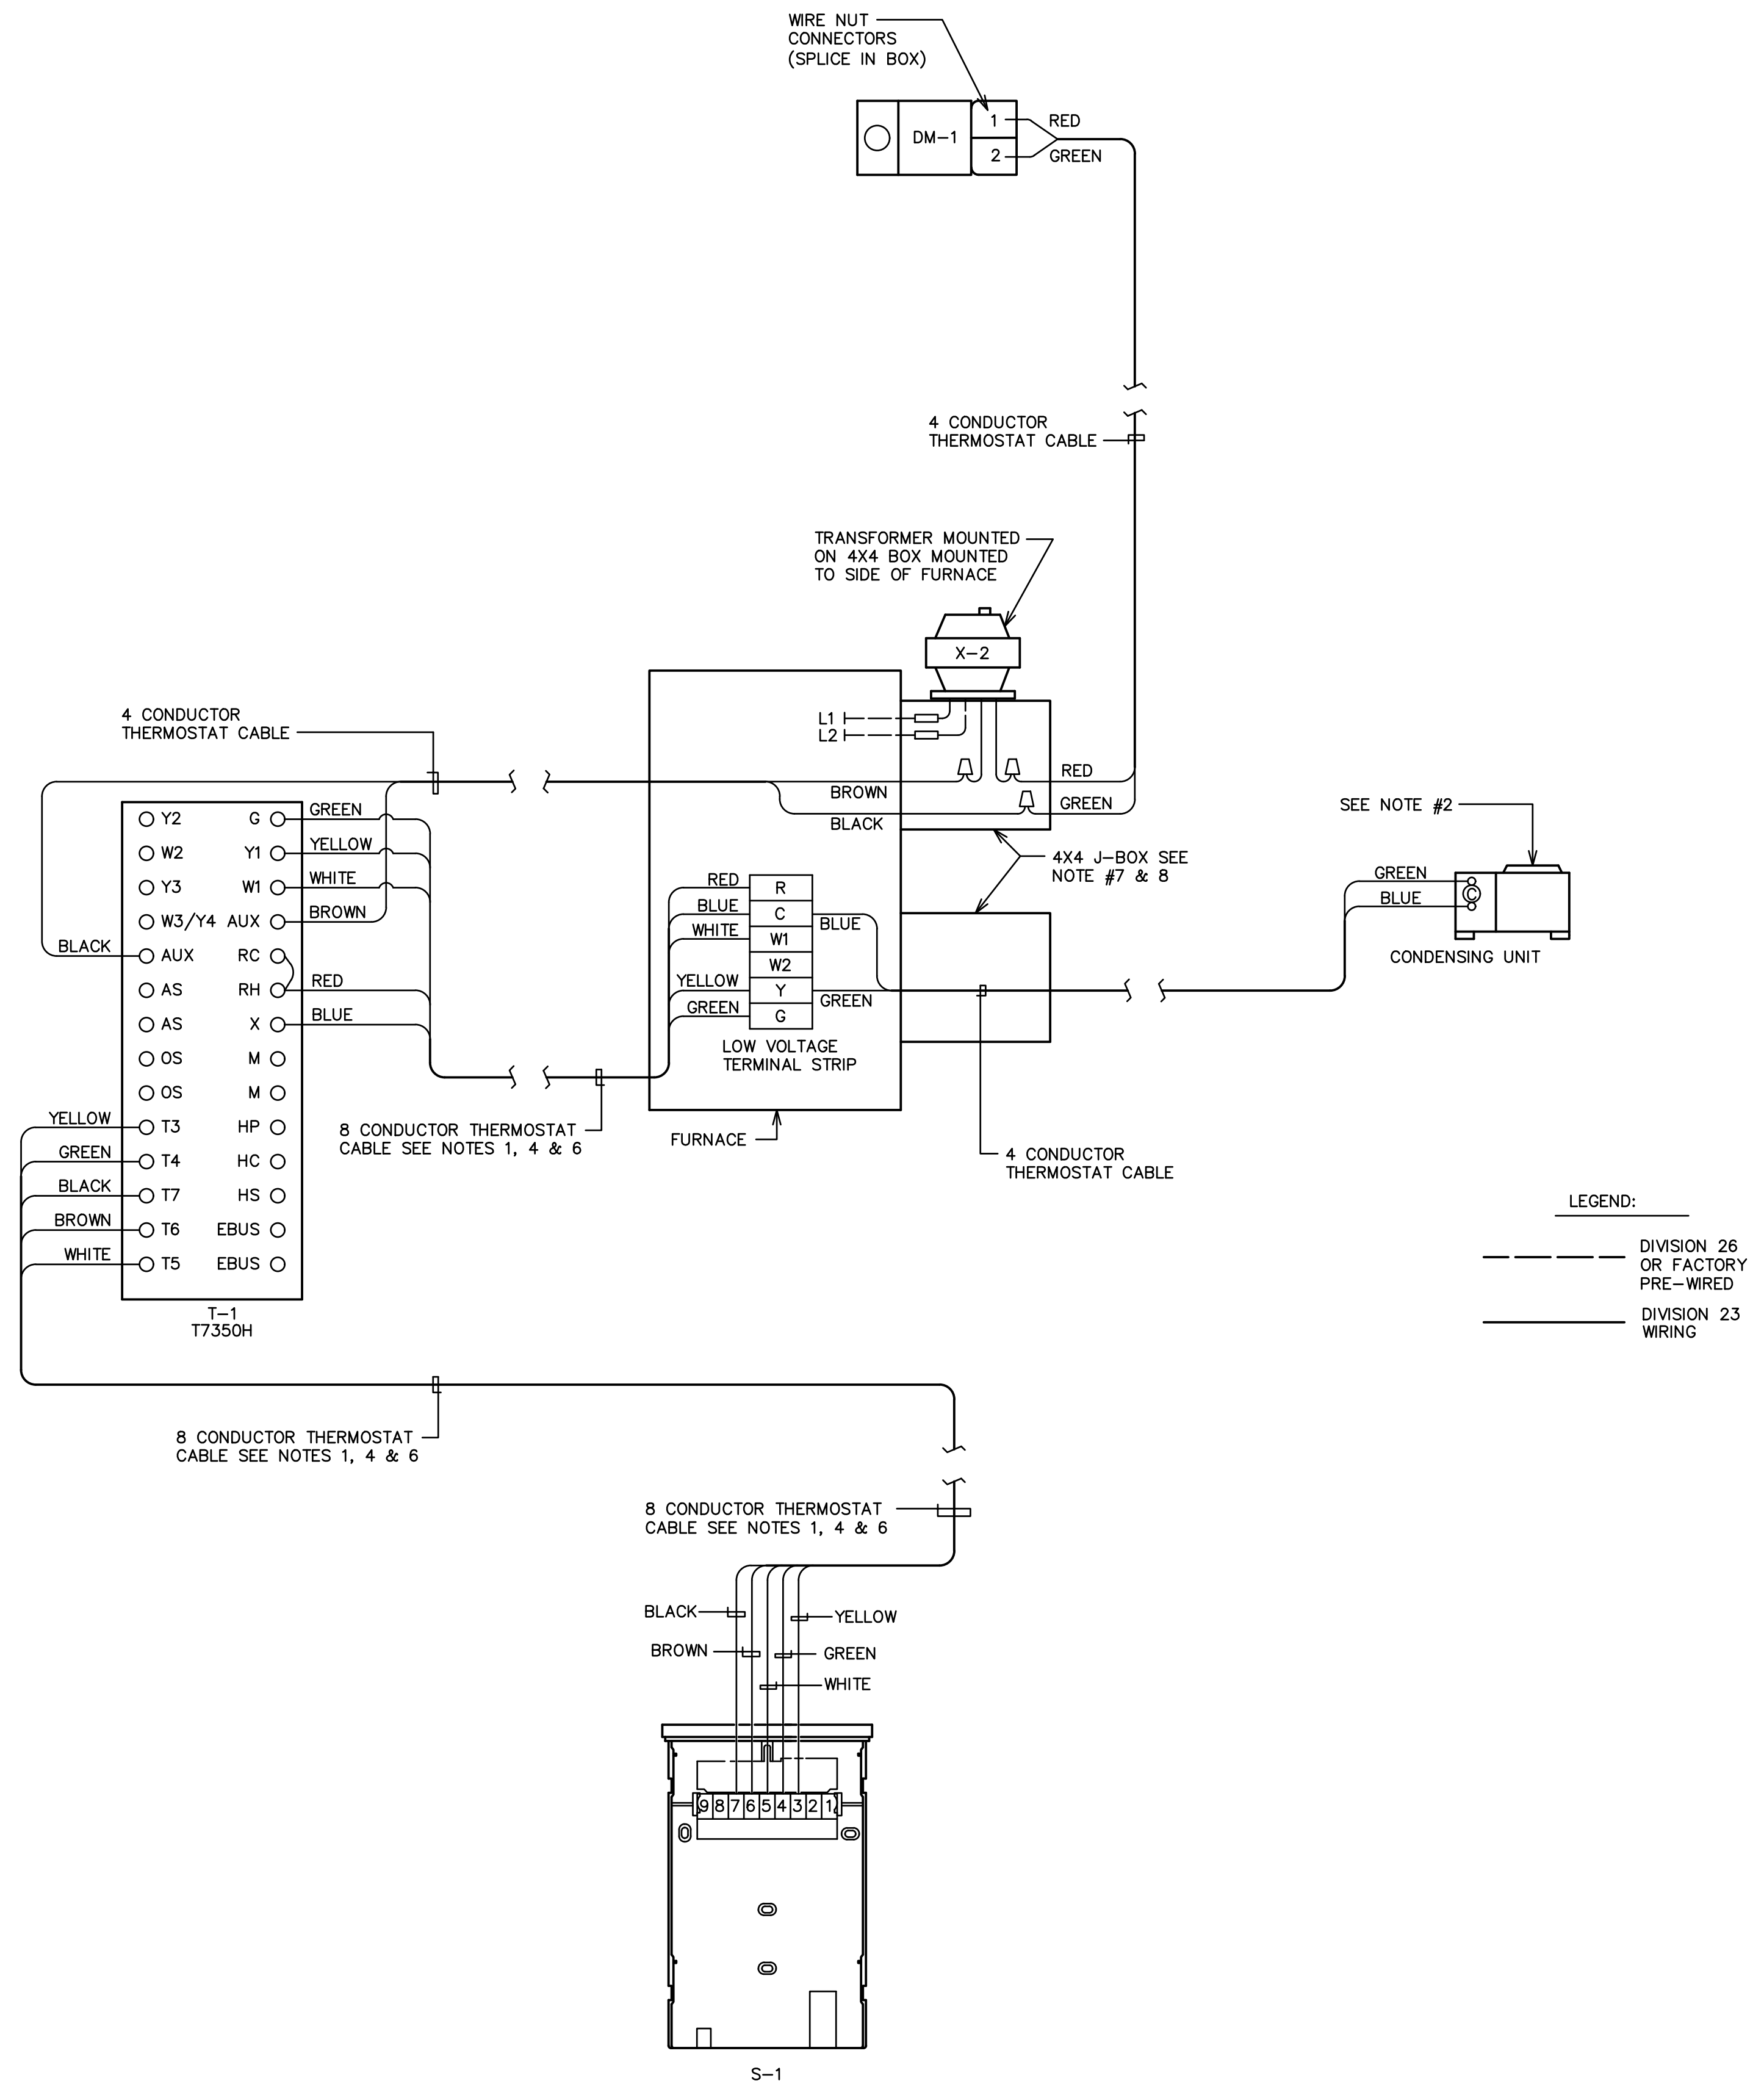

SYSTEMS F-7 AND F-8

WIRING DIAGRAM

SYSTEMS: F-7 AND F-8

WIRING DEVICE SYMBOLS			
SYMBOL	DESCRIPTION	MOUNTING	REMARKS
	SINGLE-POLE TOGGLE SWITCH	+48"	
	THREE-WAY TOGGLE SWITCH	+48"	
	DUPLEX RECEPTACLE	+18"	
	FOURPLEX RECEPTACLE	+18"	
	GROUND FAULT CIRCUIT INTERRUPTER DUPLEX RECEPTACLE	+18"	
	GROUND FAULT CIRCUIT INTERRUPTER FOURPLEX RECEPTACLE	+18"	
	SPECIAL PURPOSE OUTLET	+18"	SUBSCRIPT IN PARENTHESIS INDICATES NEMA CONFIGURATION IF SHOWN. REFER TO DRAWINGS AND/OR EQUIPMENT SCHEDULES. CONFIRM EXACT CONFIGURATION WITH OWNER PRIOR TO INSTALLATION.

GEAR AND CONTROL SYMBOLS			
SYMBOL	DESCRIPTION	MOUNTING	REMARKS
	MANUAL STARTER WITH THERMAL OVERLOAD(S)	AT EQUIPMENT	
	ELECTRIC MOTOR		
	NON-FUSED DISCONNECT SWITCH	TOP AT +48"-72"	
	FUSED DISCONNECT SWITCH	TOP AT +48"-72"	
	CIRCUIT BREAKER AND ENCLOSURE	TOP AT +48"-72"	
	MAGNETIC STARTER	TOP AT +48"-72"	
	COMBINATION MAGNETIC STARTER / NON-FUSED DISCONNECT	TOP AT +48"-72"	
	COMBINATION MAGNETIC STARTER / FUSED DISCONNECT	TOP AT +48"-72"	
	COMB. MAGNETIC STARTER / MOTOR CIRCUIT PROTECTOR (MCP)	TOP AT +48"-72"	

FIRE ALARM SYMBOLS			
SYMBOL	DESCRIPTION	MOUNTING	REMARKS
	TAMPER SWITCH	AT VALVE	
	WATER FLOW INDICATOR	ON FIRE RISER	
	FIRE/SMOKE DAMPER		
	HEAT DETECTOR	CEILING	
	SMOKE DETECTOR	CEILING	
	DUCT SMOKE DETECTOR	SIDE OF DUCT	
	FIRE ALARM MANUAL STATION	+48"	
	CONTROL MODULE	AT DEVICE(S) TO BE CONTROLLED	
	MONITOR MODULE	AT DEVICE(S) TO MONITOR	
	FAN SHUTDOWN RELAY	AT FAN CONTROL PANEL	
	MAGNETIC DOOR HOLDER	COORDINATE WITH DOOR INSTALLER	COORDINATE WITH DOOR INSTALLER; SUBSCRIPT 'C' INDICATES TO MOUNT AT FLOOR LEVEL.
	WATER FLOOD INDICATOR	FLOOR	
	AUDIO HORN	80" MIN AND 96" MAX, MEASURED FROM LENS.	SUBSCRIPT 'WP' INDICATES THAT A WEATHER PROOF BACK BOX IS REQ.
	MINI AUDIO HORN		
	FIRE ALARM VISUAL STROBE		SUBSCRIPT 'C' INDICATES CEILING MOUNTING.
	FIRE ALARM AUDIO/VISUAL HORN/STROBE	IF CEILING IS LESS THAN 80", MOUNT WITHIN 6" OF CEILING.	
	FIRE ALARM AUDIO SPEAKER		NUMERIC SUBSCRIPT INDICATES CANDELLA RATING OF STROBE (I.E., 15, 75, 110)
	FIRE ALARM AUDIO/VISUAL SPEAKER/STROBE		
	FIRE FIGHTER PHONE/COMMUNICATION BOX		

ELECTRONIC SYSTEM GENERAL SYMBOLS			
SYMBOL	DESCRIPTION	MOUNTING	REMARKS
	ELECTRONIC SYSTEM PANELBOARD (SURFACE MOUNT)	TOP AT 72"	ELECTRONIC SYSTEMS MAY INCLUDE BUT ARE NOT SPECIFICALLY LIMITED TO, TELEPHONE, DATA, TELEVISION, LIGHTING CONTROL, CLOCKS, FIRE ALARM, ACCESS CONTROL, SECURITY, CCTV, SOUND SYSTEM, NURSE CALL, OR INTERCOM.
	ELECTRONIC SYSTEM PANELBOARD (FLUSH MOUNT)	TOP AT 72"	
	ELECTRONIC SYSTEM TERMINAL BOARD	TOP AT 72"	

ELECTRICAL SYMBOL SCHEDULE GENERAL NOTES	
1.	MOUNT ALL OUTLETS, DEVICES, AND EQUIPMENT AT HEIGHTS INDICATED BELOW, UNLESS NOTED OTHERWISE ON THE DRAWINGS. UNLESS NOTED OTHERWISE, HEIGHTS ARE GIVEN FROM FINISHED FLOOR TO CENTER OF OUTLET BOX.
2.	WHERE OUTLETS, DEVICES, AND EQUIPMENT ARE NOTED BY SUBSCRIPTS, REFER TO ABBREVIATION SCHEDULE FOR DEFINED REQUIREMENTS.
3.	WHERE OUTLETS, DEVICES AND EQUIPMENT ARE NOTED BY THE SUBSCRIPT 'A', MOUNT AT 4" ABOVE COUNTER. IF COUNTER HAS A BACK SPLASH, MOUNT AT 4" ABOVE BACK SPLASH. REFER TO ARCHITECTURAL INTERIOR ELEVATIONS AND COORDINATE WITH CASEWORK SUPPLIER.
4.	NOT ALL ELECTRICAL SYMBOLS MAY BE USED.

GENERAL SYMBOLS		
SYMBOL	DESCRIPTION	REMARKS
	KEYED NOTE	TOP NUMBER INDICATES ELEVATION NUMBER; BOTTOM LETTER-NUMBER INDICATES WHERE ELEVATION IS SHOWN.
	DETAIL REFERENCE	
	ELEVATION REFERENCE	
	SECTION REFERENCE	TOP NUMBER INDICATES ELEVATION NUMBER; BOTTOM LETTER-NUMBER INDICATES WHERE ELEVATION IS SHOWN.
	ARCHITECTURAL ROOM NUMBER	
	EQUIPMENT NAME / NUMBER	TOP NUMBER ABBREVIATES EQUIPMENT NAME OR TYPE; BOTTOM NUMBER INDICATES EQUIPMENT NUMBER. REFER TO EQUIPMENT SCHEDULE.
	REVISION NUMBER	USED TO DENOTE CHANGES EITHER ISSUED BY ADDENDUM OR DURING CONSTRUCTION AND TO DENOTE RECORD DRAWING CHANGES.
	BREAKLINE	USED TO BREAK DRAWINGS.

BRANCH CIRCUITING SYMBOLS		
SYMBOL	DESCRIPTION	REMARKS
	BRANCH CIRCUIT HOME RUN TO PANEL	ARROWS: NUMBER OF ARROWS INDICATES NUMBER OF CIRCUITS REQUIRED.
	BRANCH CIRCUITING (U.N.O.) TURNED UP OR TOWARDS OBSERVER.	
	BRANCH CIRCUITING (U.N.O.) TURNED DOWN OR AWAY FROM OBSERVER.	
	BRANCH CIRCUITING (U.N.O.) CONTINUATION	
	CONDUIT STUB-IN	CAP AND MARK
	JUNCTION BOX	MOUNT AS NOTED. SUBSCRIPT 'F' INDICATES TO PROVIDE A FLOOR BOX WITH BLANK COVERPLATE

TELEPHONE / DATA SYMBOLS			
SYMBOL	DESCRIPTION	MOUNTING	REMARKS
	COMBINATION TELEPHONE/DATA OUTLET	+18"	MINIMUM 2 CAT 6E CABLES
	WIRELESS ACCESS POINT	CEILING	OWNER FURNISHED CONTRACTOR INSTALLED

ELECTRICAL SHEET INDEX	
EG001	SYMBOLS SCHEDULES AND ABBREVIATIONS
EG000	ELECTRICAL DETAILS
ED102	DEMOLITION PLAN
EP102	POWER PLAN
EP700	ONE LINE DIAGRAM
EP800	PANEL BOARD SCHEDULES

ABBREVIATION SCHEDULE			
NOTE: NOT ALL ABBREVIATIONS MAY BE USED.			
A	ABOVE COUNTER	ISO	ISOLATED
A	AMP OR AMPS	KVA	KILO VOLT AMPERES
ADJ	ADJACENT	KW	KILOWATTS
AFF	ABOVE FINISHED FLOOR	LFMC	LIQUID-TIGHT METAL CONDUIT
AHJ	AUTHORITY HAVING JURISDICTION	LFNC	LIQUID-TIGHT NONMETAL CONDUIT
AL	ALUMINUM	MCA	MINIMUM CIRCUIT AMPS
C	CONDUIT	MLO	MAIN LUGS ONLY
CB	CIRCUIT BREAKER	N.C.	NORMALLY CLOSED
CKT	CIRCUIT	N.I.C.	NOT IN CONTRACT
C.O.S	CONVENIENCE OUTLETS	N.L.	NIGHT LIGHT
CU	COPPER	N.O.	NORMALLY OPEN
EA	EACH	O.C.	ON CENTER(S)
ELEC	ELECTRICAL	OCPT	OVER CURRENT PROTECTION
EM	EMERGENCY	QTY	QUANTITY
EMT	ELECTRIC METALLIC TUBING	R	REMOVE
ENT	ELECTRIC NONMETALLIC TUBING	REQ.	REQUIREMENTS
EQUIP	EQUIPMENT	RMC	RIGID METAL CONDUIT
EWC	ELECTRIC WATER COOLER	RNC	RIGID NONMETALLIC CONDUIT
E, EX	EXISTING	RR	REMOVE AND RELOCATE
EXP	EXPLOSION PROOF	SS	SURGE SUPPRESSION
FA	FIRE ALARM	SCP	SECURITY CONTROL PANEL
FACP	FIRE ALARM CONTROL PANEL	TR	TAMPER RESISTANT
FLA	FULL LOAD AMPS	TYP	TYPICAL
FMC	FLEXIBLE METAL CONDUIT	TVSS	TRANSIENT VOLTAGE SURGE SUPPRESSOR
FOB	FREIGHT ON BOARD	UF	UNDER FLOOR
GND	GROUND CONDUCTOR	UG	UNDERGROUND
HOA	HAND-OFF-AUTO	U.N.O.	UNLESS NOTED OTHERWISE
HP	HORSE POWER	W	WITH
IG	ISOLATED GROUND	WP	WEATHER PROOF
IMC	INTERMEDIATE METAL CONDUIT	XFMR	TRANSFORMER
INS	INSULATED		

- GENERAL PROJECT NOTES:**
- DIVISION 26 CONTRACTOR IS RESPONSIBLE FOR READING AND APPLYING WHAT IS IN THE SPECIFICATIONS TO THIS PROJECT. ANYTHING THAT IS NOT INCLUDED ON THE PROJECT THAT IS CALLED OUT IN THE SPECIFICATION SHALL BE LISTED ON THE SUBSTANTIAL COMPLETION PUNCHLIST. THE CONTRACTOR WILL BE REQUIRED TO REMEDY THESE DEFICIENCIES. THERE WILL BE NO EXCEPTIONS.
 - THE CONTRACTOR MAY SCHEDULE A PRE-CONSTRUCTION MEETING, AT THEIR DISCRETION WITH THE ELECTRICAL ENGINEER AND REVIEW THE DRAWINGS AND SPECIFICATIONS. THE MEETING SHALL BE A MAXIMUM OF ONE HOUR AND SHALL TAKE PLACE AT THE ENGINEER'S OFFICE.
 - THE FOLLOWING ITEMS ARE SOME OF THE REQUIREMENTS THAT ARE LISTED IN THE SPECIFICATIONS, THESE ITEMS DO NOT REPRESENT ALL ITEMS AND THE CONTRACTOR IS RESPONSIBLE FOR MEETING ALL REQUIREMENTS OF THE SPECIFICATIONS:
 - INSULATED THROAT CONNECTORS OR PLASTIC BUSHINGS SHALL BE UTILIZED FOR ALL CONDUIT SIZES USED ON THIS PROJECT.
 - A DEDICATED NEUTRAL CONDUCTOR WILL BE PROVIDED FOR ALL LIGHTING AND POWER CIRCUITS.
 - THE CONTRACTOR SHALL LABEL ALL ELECTRICAL EQUIPMENT AS IT IS CALLED OUT IN THE SPECIFICATIONS.
 - THE CONTRACTOR SHALL PROVIDE SEISMIC SUPPORT AND BRACING FOR ALL ELECTRICAL EQUIPMENT AS REQUIRED BY LOCAL AND NATIONAL CODE.
 - THE CONTRACTOR SHALL FOLLOW THE PANELBOARD SCHEDULES AS INDICATED IN THE DRAWINGS. EACH CIRCUIT BREAKER HAS BEEN ASSIGNED A SPECIFIC AREA OF THE BUILDING. NO DEVIATION WILL BE ALLOWED WITHOUT THE APPROVAL FROM THE ELECTRICAL ENGINEER.
 - THE CONTRACTOR SHALL INSTALL PROPER WIRE SIZE AS CALLED OUT ON THE PANELBOARD SCHEDULES. HOWEVER, THE CONTRACTOR IS RESPONSIBLE TO ENSURE THE WIRE IS LARGE ENOUGH FOR VOLTAGE DROP.
 - THE CONTRACTOR SHALL VERIFY ALL MECHANICAL OVERCURRENT DEVICES FOR THE ACTUAL MECHANICAL EQUIPMENT SUPPLIED ON THE JOB, PRIOR TO RELEASE OF ANY ELECTRICAL DISTRIBUTION EQUIPMENT. CONTACT THE ELECTRICAL ENGINEER WITH ANY DISCREPANCIES.
 - THE CONTRACTOR SHALL VISIT THE SITE BEFORE SUBMITTING THE BID, AND SHALL EXAMINE ALL PHYSICAL CONDITIONS WHICH MAY BE MATERIAL TO THE PERFORMANCE OF HIS WORK. NO EXTRA PAYMENTS WILL BE ALLOWED TO THE CONTRACTOR AS A RESULT OF EXTRA WORK MADE NECESSARY BY HIS FAILURE TO DO SO. ANY CASE OF DISCREPANCY OR LACK OF CLARITY SHALL BE PROMPTLY IDENTIFIED TO THE OWNER'S REPRESENTATIVE AND THE ENGINEER FOR CLARIFICATION.
 - THE CONTRACTOR SHALL MAKE SURE THAT ALL BRANCH CIRCUITS THAT ARE AFFECTED BY THIS PROJECT ARE NOT OVERLOADED. PROVIDE ADDITIONAL BRANCH CIRCUITS FROM ELECTRICAL PANELS AS NECESSARY TO COMPLY WITH THE BRANCH CIRCUIT LOADING REQUIREMENTS. PROVIDE ALL MATERIAL AND LABOR AS NECESSARY FOR A COMPETENT AND OPERATING SYSTEM.
 - PROVIDE UPDATED, TYPED PANELBOARD SCHEDULE(S) TO REFLECT ALL THE CHANGES MADE INCLUDING EXISTING LOADS. THE EXISTING LOADS SHALL BE NAMED THE SAME AS LISTED ON THE EXISTING PANELBOARD SCHEDULE.

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PROFESSIONAL ENGINEER
05/21/2020
8357784-2202
TREVOR REED SPENCER
STATE OF UTAH

PROJECT FOR

SALEM 1, 2 & 9 WARDS
SALEM UT WEST STAKE
PROPERTY NUMBER: 505056119010101
60 SOUTH MAIN STREET
SALEM, UTAH 84653

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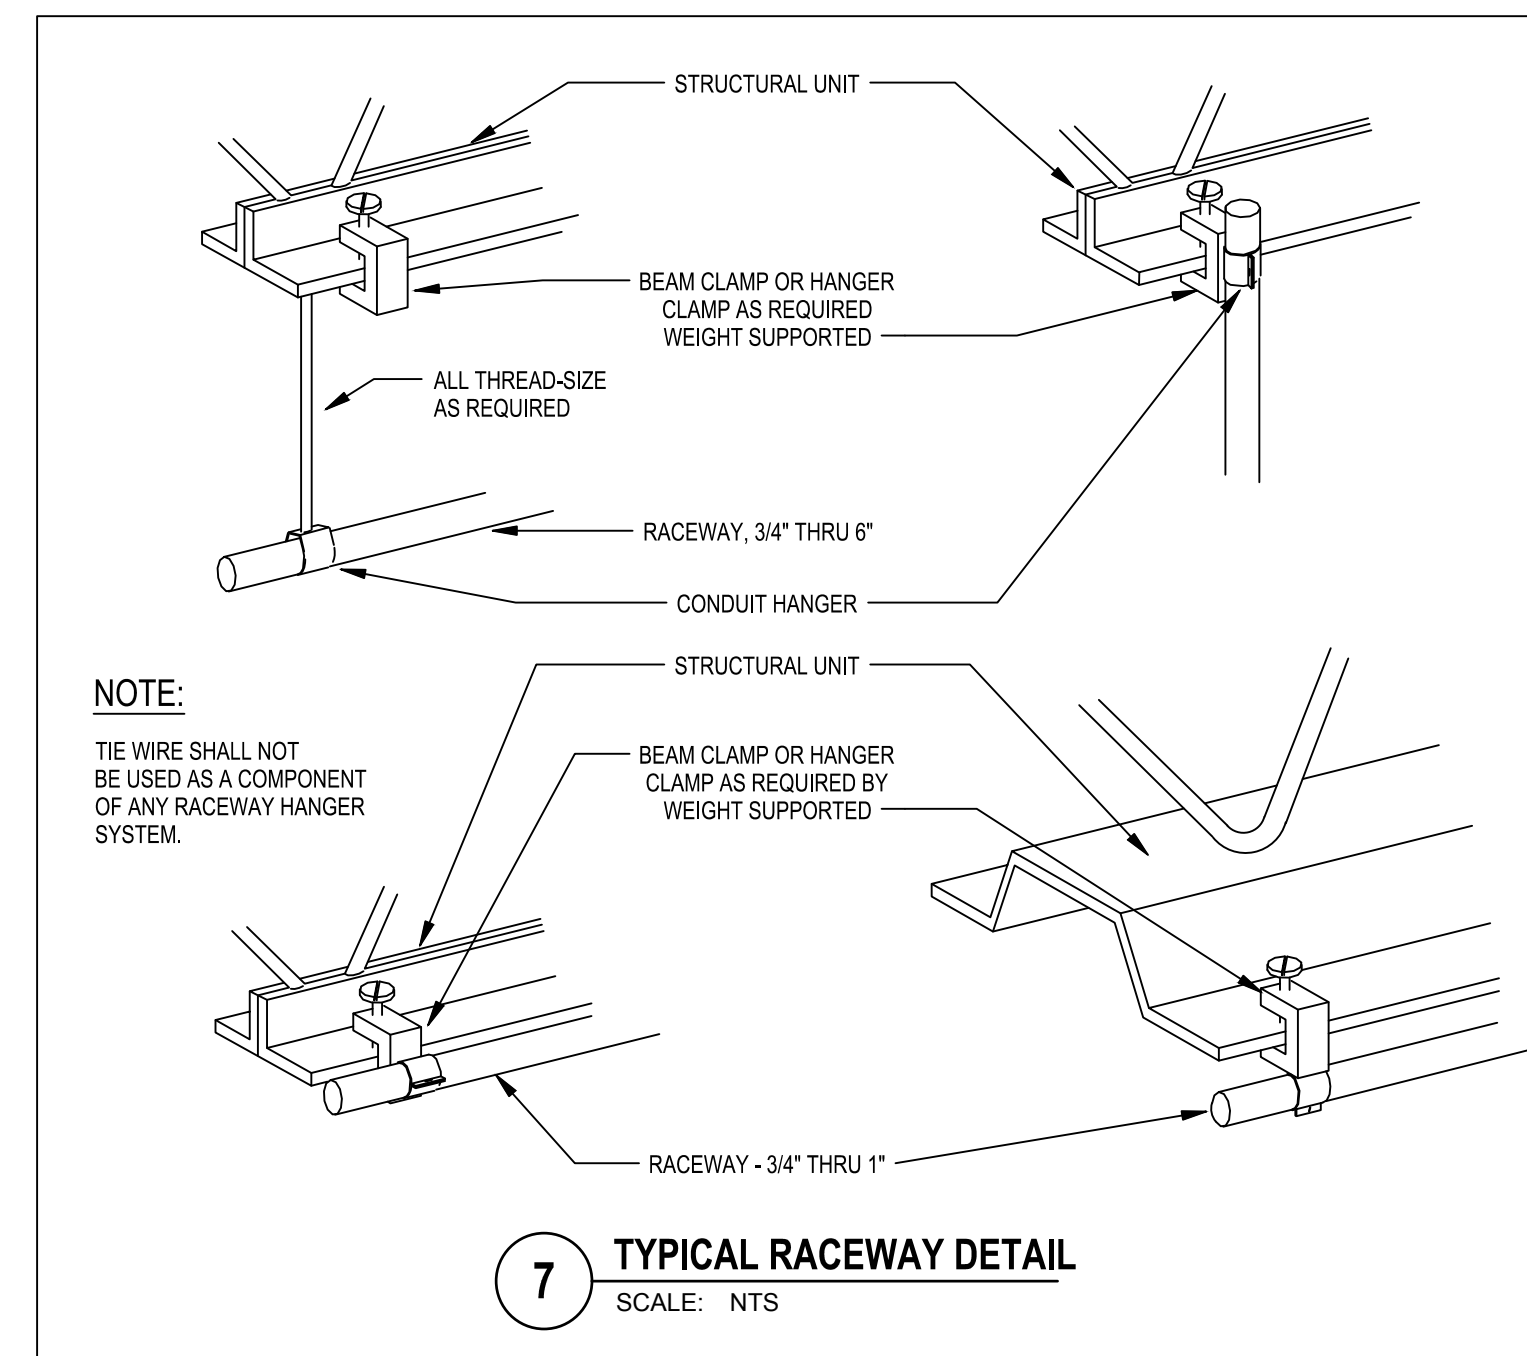
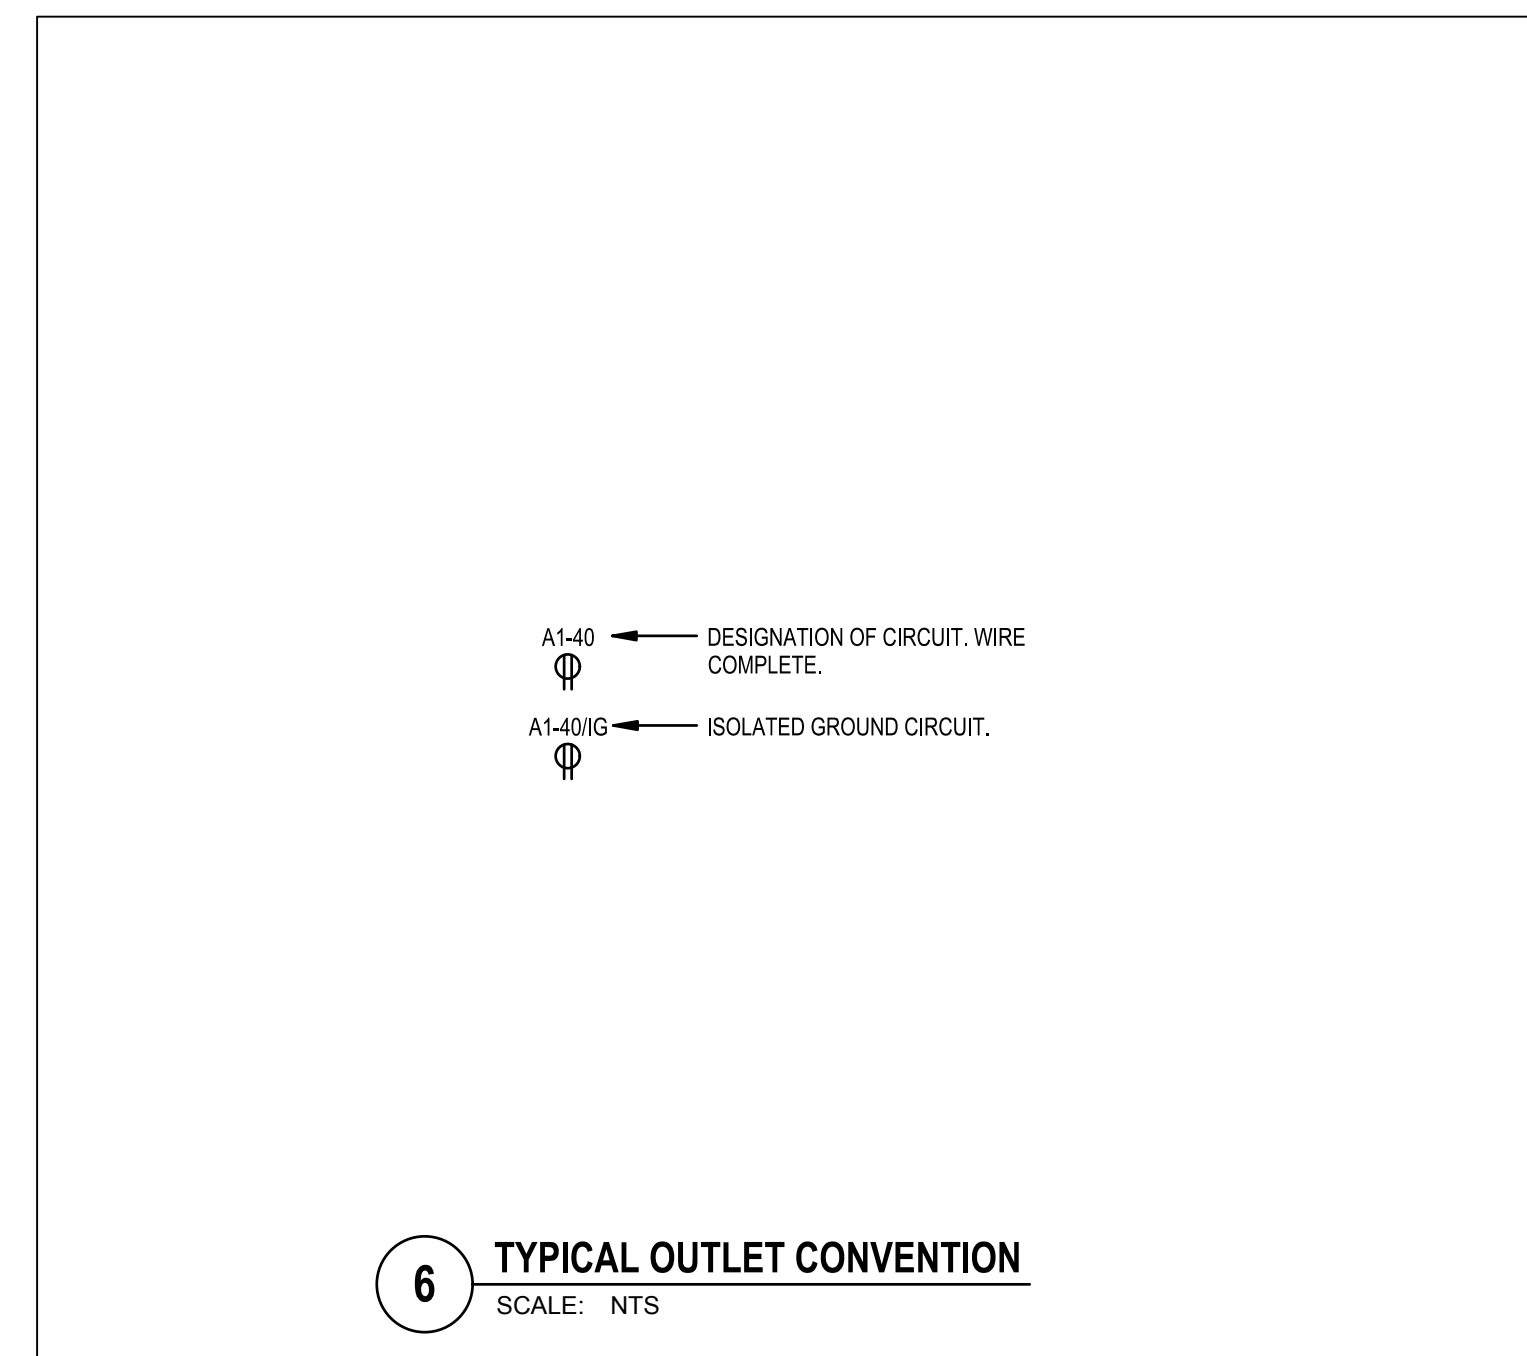
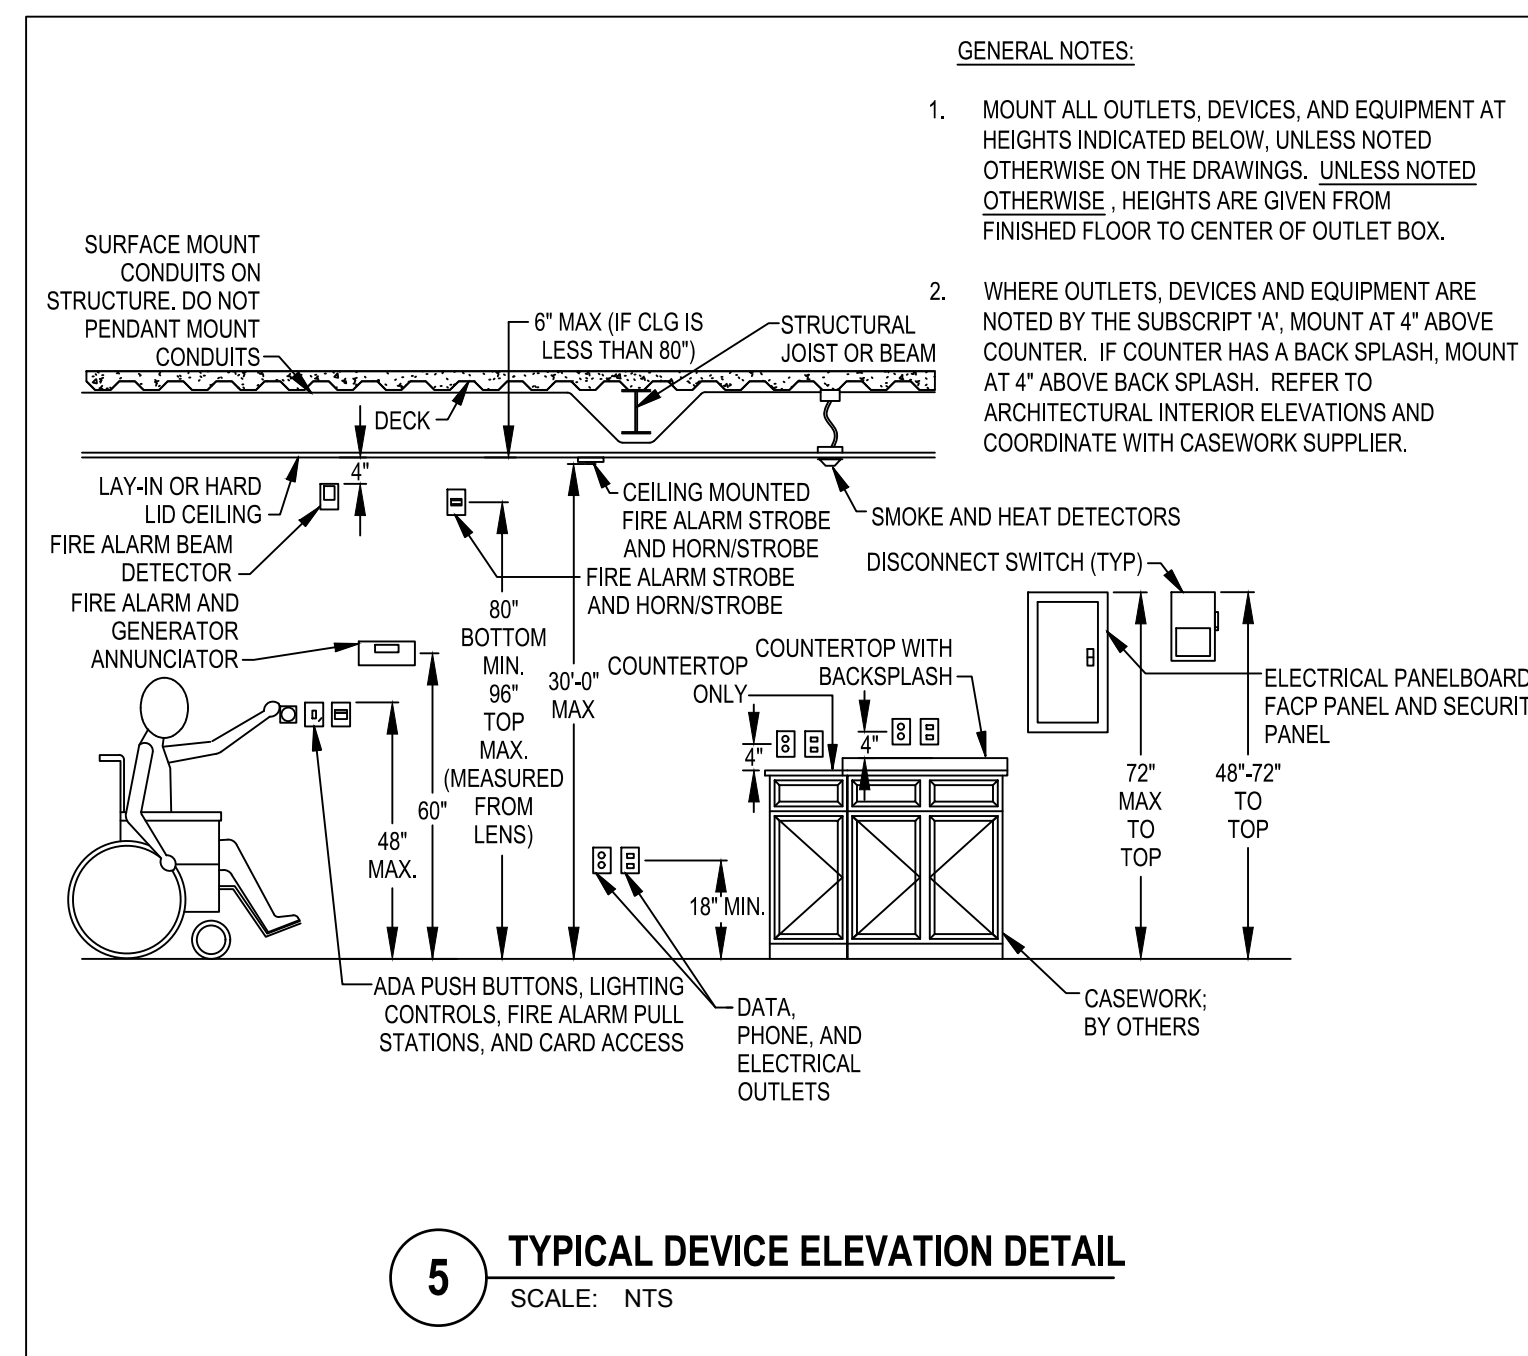
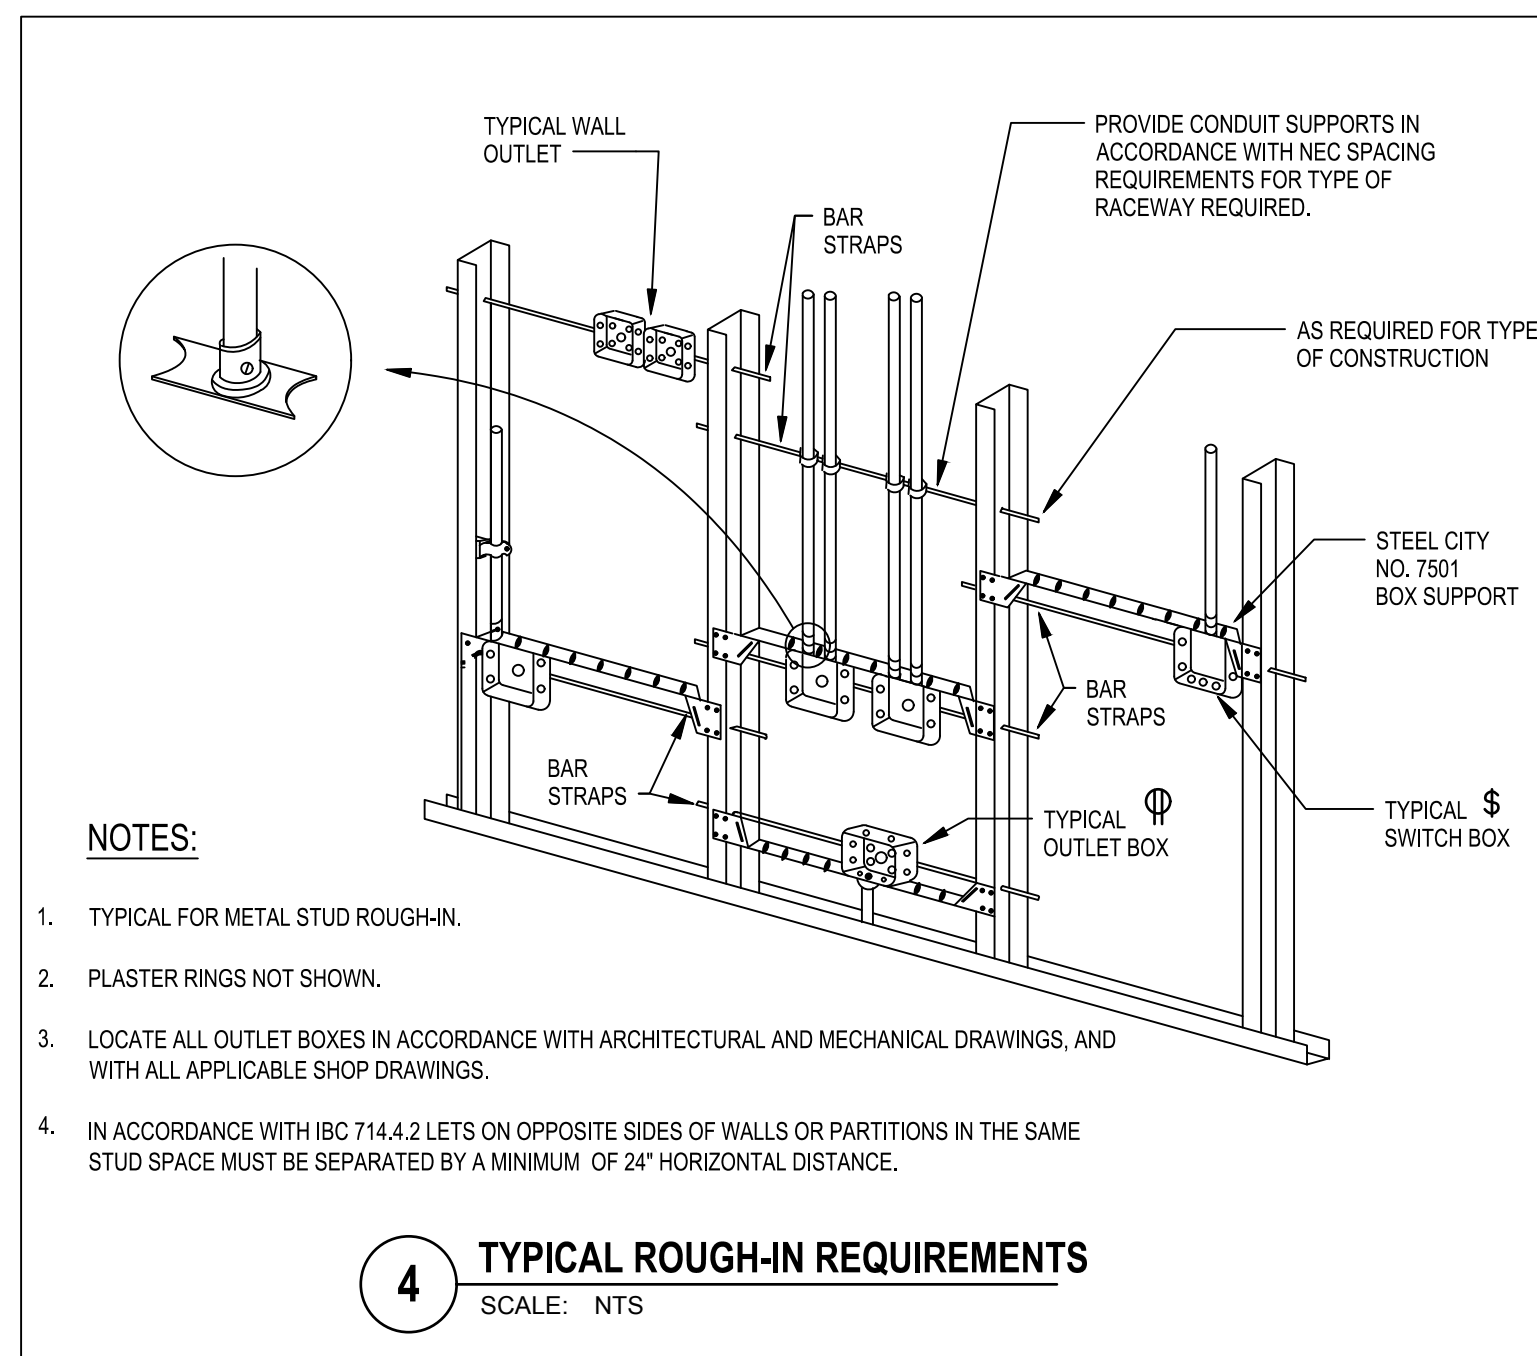
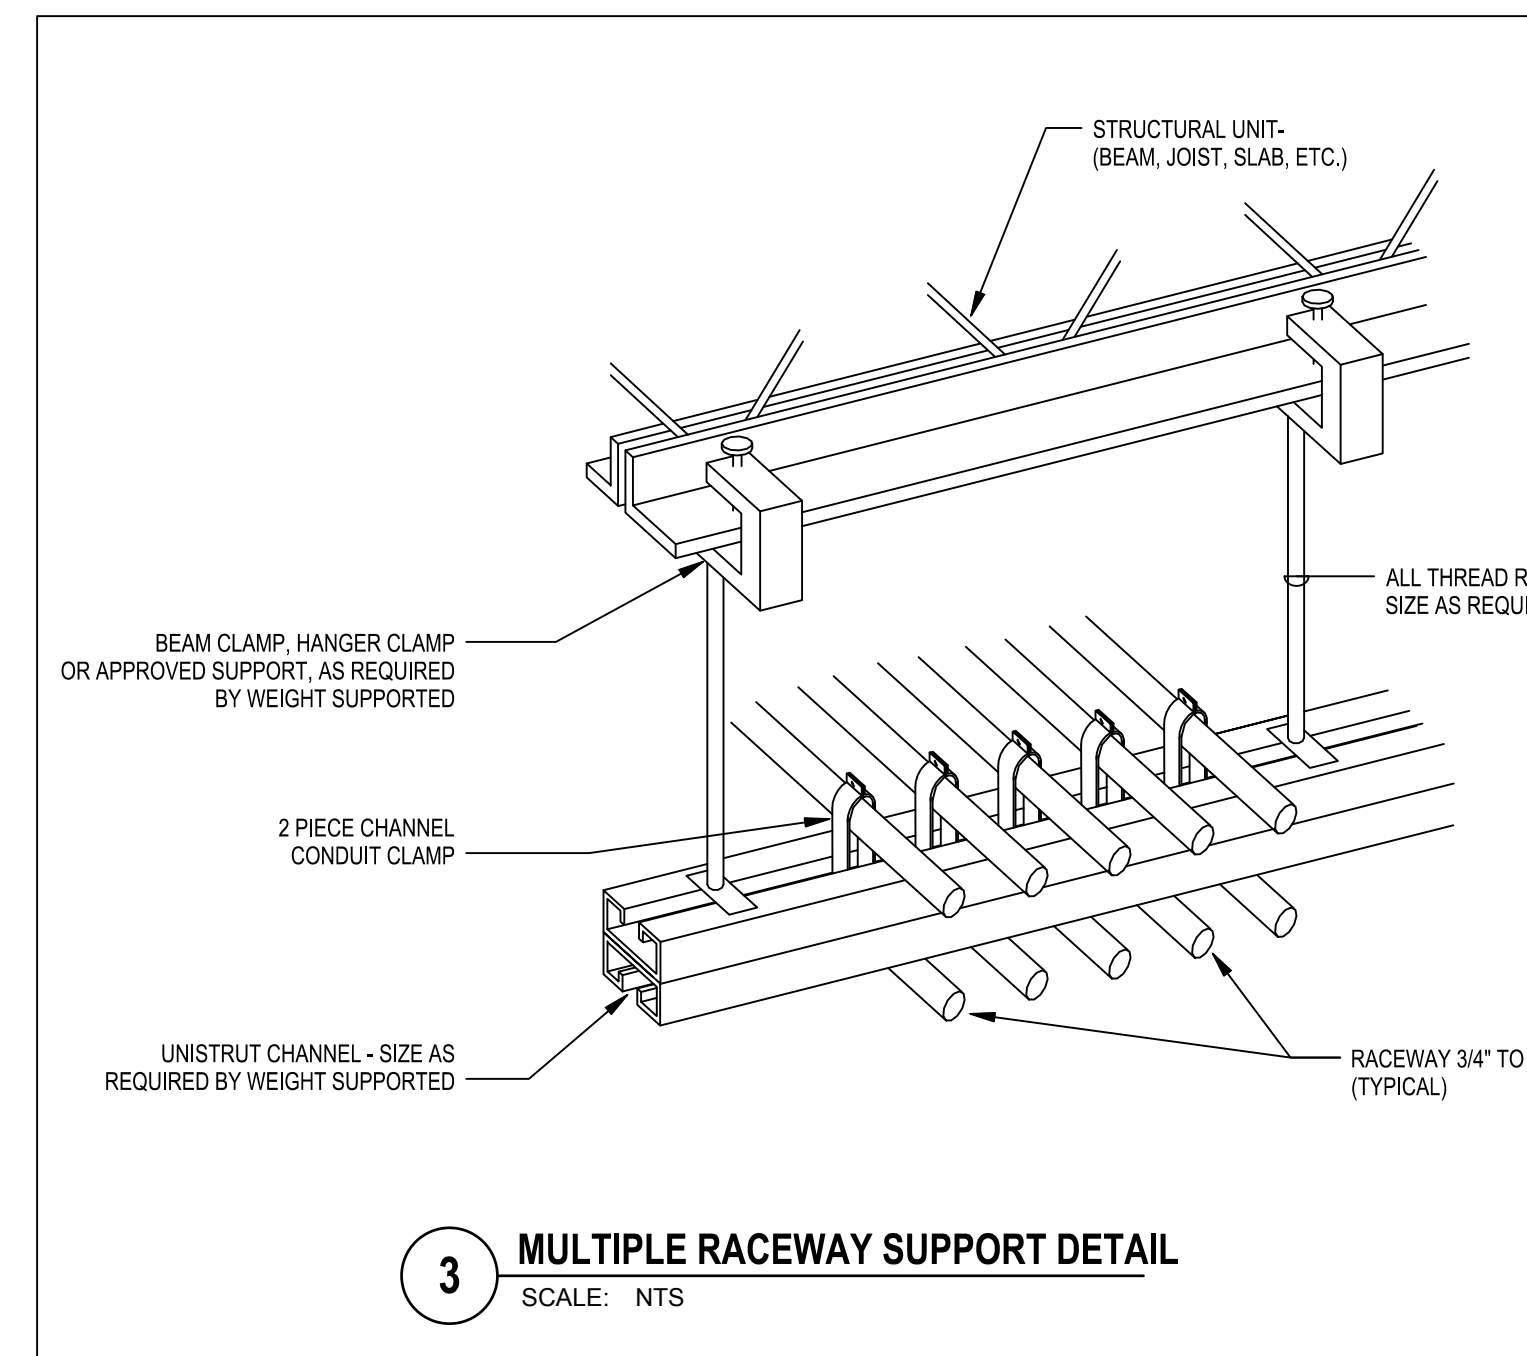
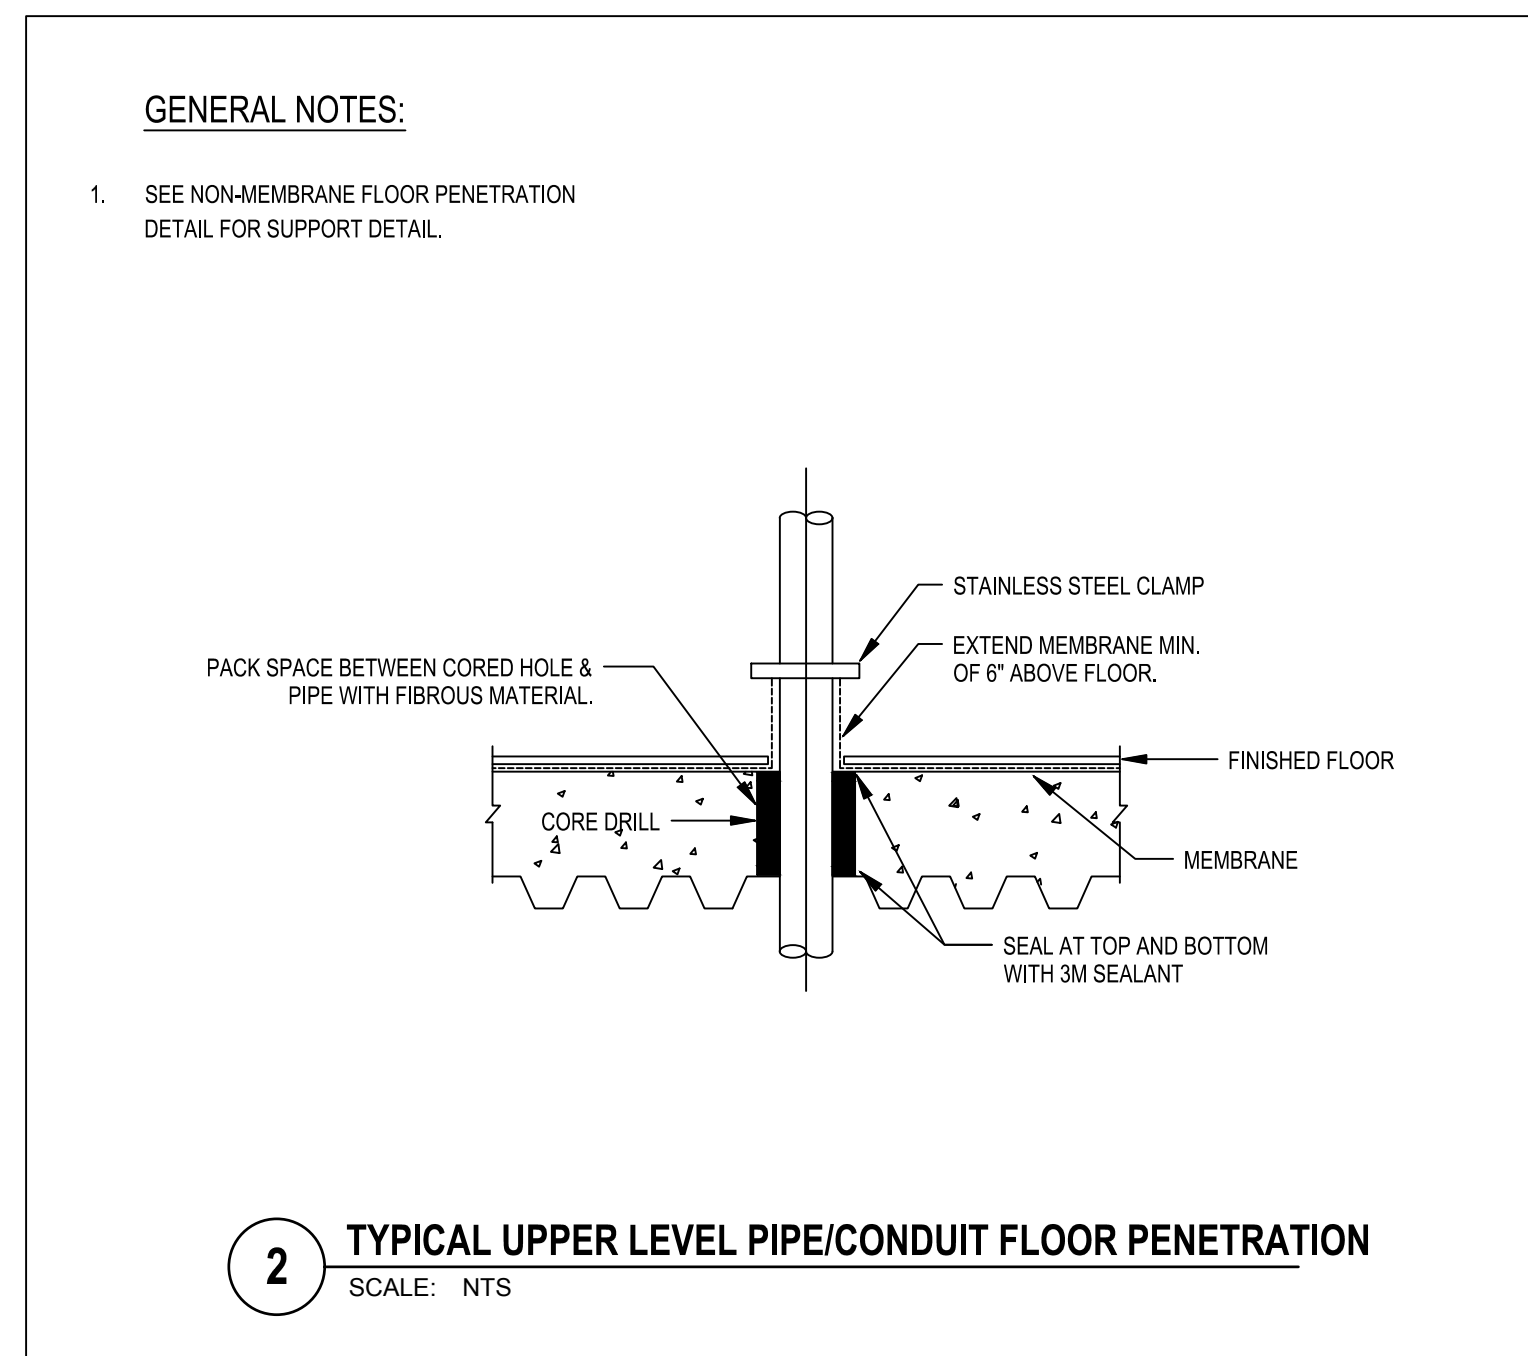
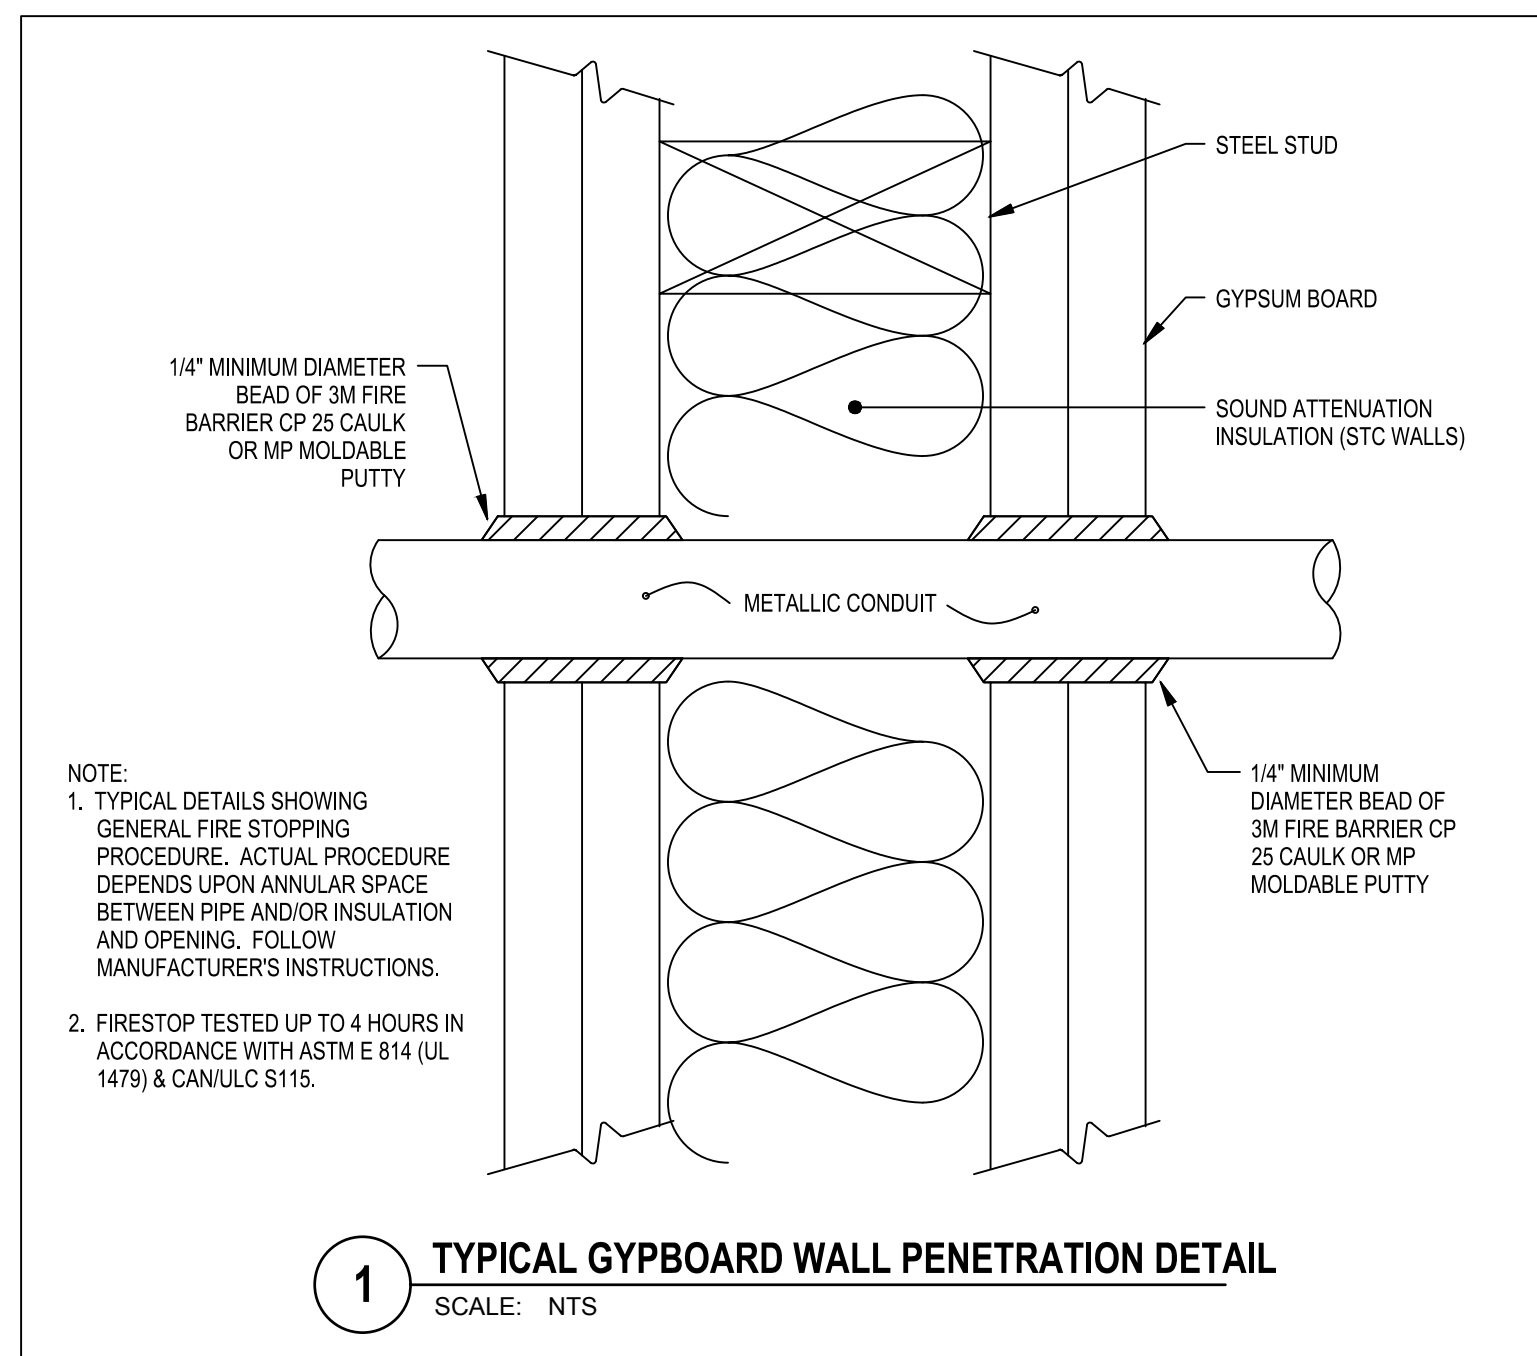
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SHEET TITLE

SYMBOLS, SCHEDULES AND NOTES

SHEET NUMBERS

EG001



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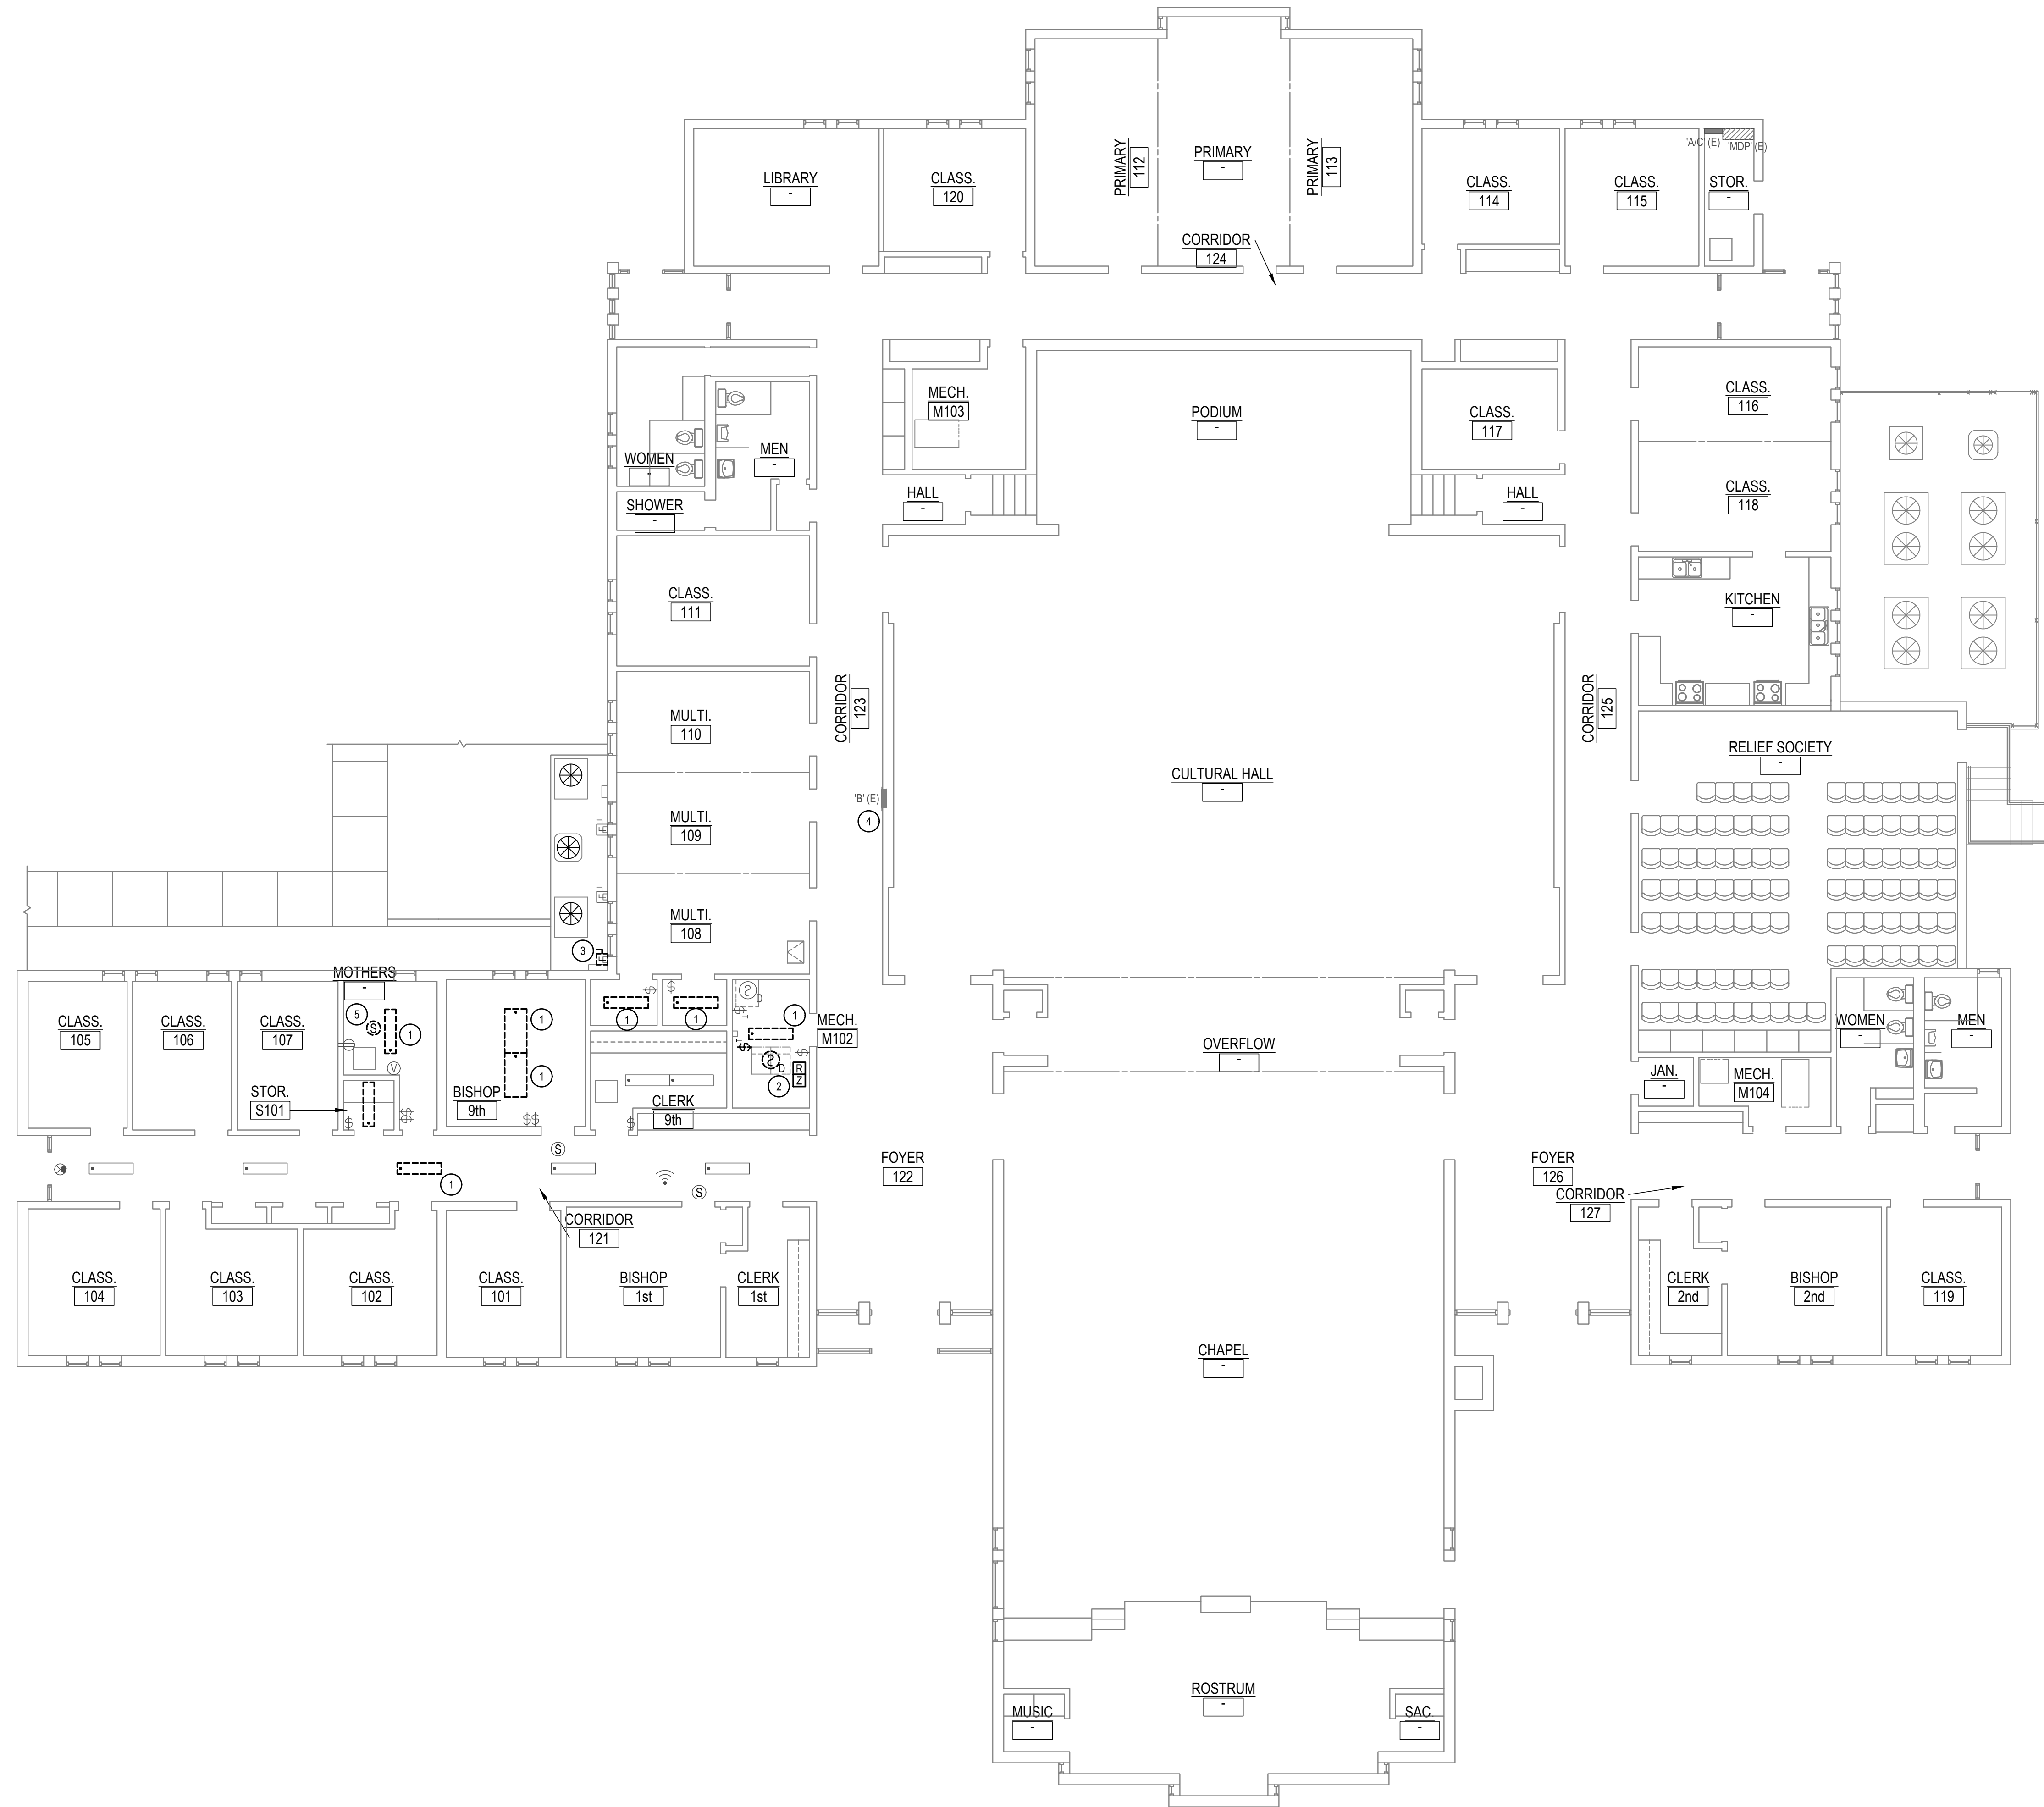
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SHEET TITLE

ELECTRICAL DETAILS

SHEET NUMBERS

EG500




GENERAL DEMOLITION NOTES:

1. UNLESS SPECIFICALLY NOTED OTHERWISE, REMOVE ALL ELECTRICAL ITEMS SHOWN IN DARK & DASHED LINES. LIGHT & SOLID ITEMS ARE TO REMAIN. DEMOLITION ITEMS ARE SHOWN TO GIVE A BASIC DESCRIPTION OF THE EXTENT OF DEMOLITION WORK, BUT MAY NOT BE INCLUSIVE. PROVIDE DEMOLITION WORK IN ACCORDANCE WITH THE FOLLOWING REQUIREMENTS:
 - 1.1. DISCONNECT AND REMOVE ANY/ALL FIXTURES, DEVICES, EQUIPMENT, ETC. REQUIRED FOR PROPER COMPLETION OF THE WORK WHETHER SHOWN OR NOT.
 - 1.2. RELOCATE, REWIRE, AND/OR RECONNECT ANY/ALL FIXTURES, DEVICES, EQUIPMENT, ETC. THAT FOR ANY REASON OBSTRUCTS CONSTRUCTION.
 - 1.3. LEAVE ALL EXISTING FIXTURES, DEVICES, EQUIPMENT, ETC. IN PORTIONS OF THE BUILDING NOT BEING REMODELED, IN WORKING CONDITION. RESTORE ALL INTERRUPTED BRANCH CIRCUITS, FEEDERS, ETC.
 - 1.4. REMOVE AND DISPOSE OF ALL RACEWAYS, CONDUCTORS, BOXES, DEVICES, EQUIPMENT, ETC. THAT ARE NOT TO BE REUSED. TERMINATE AT ACCESSIBLE JUNCTION BOX BY PROVIDING PROPER KNOCK-OUT CLOSURE, TAPE CONDUCTORS, LABEL AS "SPARE" WITH CIRCUIT NO., ZONE NO. OR OTHER CHARACTERISTIC IDENTIFYING SOURCE.
 - 1.5. EXISTING RACEWAYS MAY BE REUSED, IF IN PLACE, WHERE POSSIBLE, AND WHERE IN COMPLIANCE WITH THE SPECIFICATIONS AND THE INTENT OF THE CONTRACT DOCUMENTS. UPGRADE AND OR PROVIDE NEW CONDUIT SUPPORTS WHERE NECESSARY FOR ALL RACEWAYS BEING REUSED. ENSURE INTEGRITY OF EXISTING RACEWAYS BEFORE REUSE.
 - 1.6. CONCEAL ALL RACEWAY AND WIRING IN EXISTING WALLS, CEILINGS, FLOORS, ETC. THE USE OF WIREMOLD IS PERMITTED ONLY WHERE SPECIFICALLY NOTED ON DRAWING.
 - 1.7. DO NOT PENETRATE STRUCTURAL ELEMENTS OF FLOORS, WALLS, CEILINGS, ROOFS, ETC.
 - 1.8. COORDINATE WITH OWNER WHAT EQUIPMENT SHOULD BE DISPOSED OF AND WHAT EQUIPMENT IS TO BE RETURNED TO OWNER.

KEYED NOTES: #

1. CAREFULLY REMOVE EXISTING LIGHT FIXTURE AND STORE IN A COOL, DRY AND PROTECTED LOCATION. DEVICE TO BE REINSTALLED IN SAME LOCATION AND BE RECONNECTED TO EXISTING CIRCUIT AND CONTROL.
2. DEMOLISH EXISTING DUCT SMOKE DETECTOR AND ASSOCIATED CONTROL MODULE, RELAY, ETC. ENSURE THAT EXISTING SYSTEM AND DUCT SMOKE DETECTOR FOR EXISTING TO REMAIN FURNACE RETAINS FULL FUNCTIONALITY.
3. DEMOLISH EXISTING FEED FROM CONDENSING UNIT TO DISCONNECT, ALONG WITH FUSES INSIDE OF DISCONNECT. PROTECT AND MAINTAIN DISCONNECT ALONG WITH ASSOCIATED WIRING BACK TO PANEL A/C(E), DISCONNECT TO BE REUSED FOR CONNECTION TO NEW CONDENSING UNIT IN SAME LOCATION.
4. REMOVE EXISTING SPARE 30A/2P BREAKER (26,28) FROM PANEL AND DELIVER TO OWNER.
5. CAREFULLY REMOVE EXISTING SPEAKER AND STORE IN A COOL, DRY AND PROTECTED LOCATION. DEVICE TO BE REINSTALLED IN SAME LOCATION AND BE RECONNECTED TO EXISTING CIRCUIT AND CONTROL.

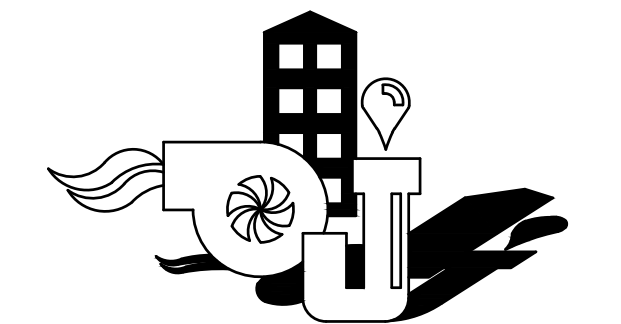

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SHEET TITLE

ELECTRICAL DEMOLITION PLAN

SHEET NUMBERS

ED102




GENERAL NOTES:

- A. CONFIRM ALL ELECTRICAL REQUIREMENTS FOR ALL MECHANICAL EQUIPMENT WITH EQUIPMENT SUPPLIER.
- B. NEW OVERCURRENT PROTECTIVE DEVICES IN EXISTING EQUIPMENT SHALL BE OF THE SAME MANUFACTURER AND AIC RATING AS THE EQUIPMENT.
- C. PROVIDE ALL REQUIRED CORE DRILLS, PENETRATIONS, ETC. ALONG WITH SEALING OF PENETRATIONS FOR ALL CONDUIT ROUTING. COORDINATE AND CONFIRM EXACT ROUTING WITH OWNER PRIOR TO ROUGH IN.

KEYED NOTES: #

- 1. REINSTALL EXISTING LIGHT FIXTURE IN SAME LOCATION AS IT WAS PRIOR TO DEMOLITION AND RECONNECT TO EXISTING CIRCUIT AND CONTROL. PROVIDE ALL REQUIRED CONDUIT, WIRING, ETC. AS REQUIRED.
- 2. REINSTALL EXISTING SPEAKER IN SAME LOCATION AS IT WAS PRIOR TO DEMOLITION AND RECONNECT TO EXISTING CIRCUIT AND CONTROL. PROVIDE ALL REQUIRED CONDUIT, WIRING, ETC. AS REQUIRED.
- 3. PROVIDE NEW CONNECTION FROM EXISTING DISCONNECT TO NEW CONDENSING UNIT INCLUDING ALL REQUIRED CONDUIT AND WIRE. PROVIDE NEW FUSES IN EXISTING DISCONNECT SIZED APPROPRIATELY FOR NEW UNIT.
- 4. PROVIDE (2) NEW 30A/1P BREAKERS IN EXISTING GE TYPE NLTO STYLE 5 PANELBOARD. NEW BREAKERS TO MATCH EXISTING PANEL AIC RATINGS.
- 5. PROVIDE NEW 30A/3P BREAKER IN EXISTING SQUARE-D PANELBOARD. NEW BREAKER TO BE OF SAME MANUFACTURER AND TO MATCH EXISTING PANEL AIC RATINGS.

POWER PLAN
SCALE: 1/8" = 1'-0"
NORTH

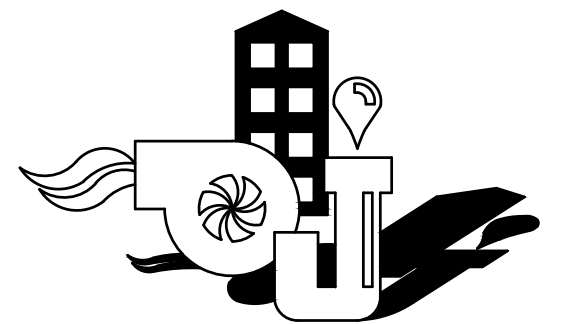

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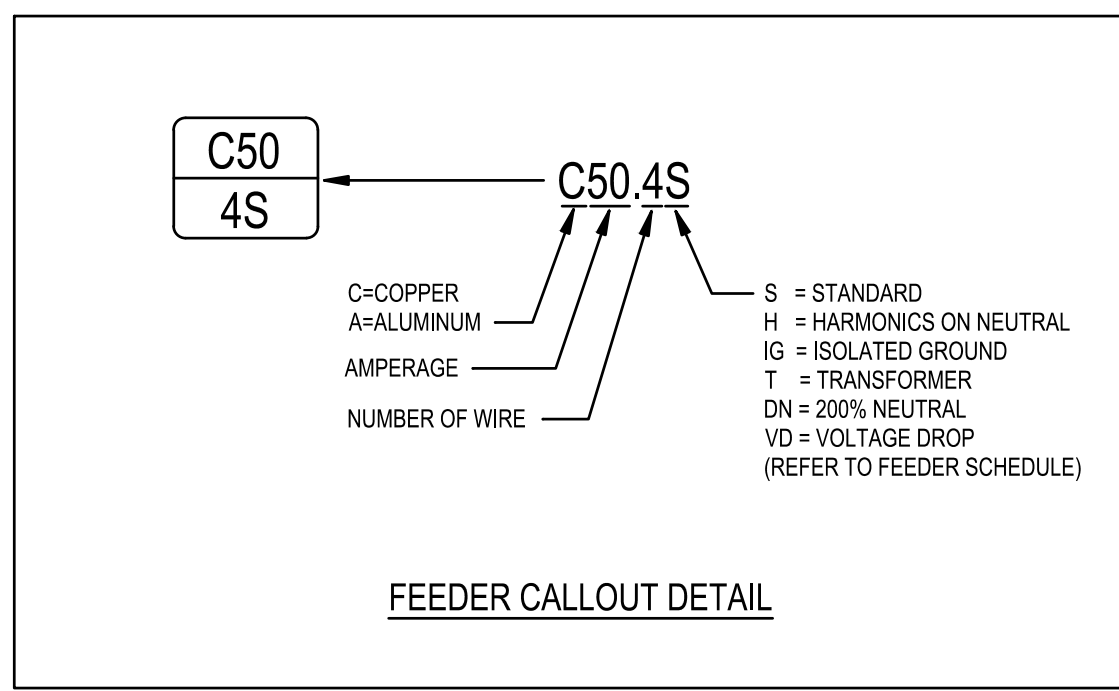
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POWER PLAN

SHEET NUMBERS

EP102


LIGHT FIXTURE SCHEDULE											
TYPE	MANUFACTURER	SERIES	DESCRIPTION	VOLTAGE	LOAD (VA)	MOUNTING	NUMBER	LAMPS	COLOR (KELVIN)	CRI	REMARKS
SW1	LITHONIA	ZL1N	3,000 LUMENS / FROSTED ACRYLIC DIFFUSER 48" STRIP LIGHT 0-10 VOLT DIMMING-10%	120	15	SURFACE	A/R	LED	3000	80	
ABBREVIATION SCHEDULE			LIGHT FIXTURE GENERAL NOTES								
A.F.F. WALL@CLG.	ABOVE FINISHED FLOOR WALL MOUNT AT CORNER OF WALL AND CEILING		REFER TO THE ARCHITECTURAL REFLECTED CEILING PLANS FOR LOCATIONS OF LIGHT FIXTURES. BRING ALL DISCREPANCIES OF LOCATIONS AND QUANTITIES TO THE ATTENTION OF THE ARCHITECT PRIOR TO BIDDING.								
CCBA	CUSTOM PAINTED COLOR AS SELECTED BY THE ARCHITECT		REFER TO THE ARCHITECTURAL ELEVATIONS FOR MOUNTING HEIGHTS AND LOCATIONS OF LIGHT FIXTURES. BRING ALL DISCREPANCIES TO THE ATTENTION OF THE ARCHITECT PRIOR TO BIDDING.								
SCBA	STANDARD PAINTED COLOR AS SELECTED BY THE ARCHITECT		REFER TO THE SPECIFICATIONS FOR OTHER LIGHT FIXTURE, BALLAST, AND LAMP REQUIREMENTS AND ACCEPTABLE MANUFACTURERS. THOSE LISTED IN LIGHTING FIXTURE SCHEDULE.								
CFBA	CUSTOM FINISH AS SELECTED BY THE ARCHITECT		REFER TO ARCHITECTURAL DRAWINGS FOR LOUVER REQUIREMENTS (IF ANY).								
SFBA	STANDARD FINISH AS SELECTED BY THE ARCHITECT		CONFIRM AVAILABLE MOUNTING DEPTHS OF ALL LIGHT FIXTURES AND COMPARE WITH DEPTHS SHOWN ON SHOP DRAWING. BRING ALL POTENTIAL CONFLICT AREAS TO THE ATTENTION OF THE ARCHITECT AND ELECTRICAL ENGINEER PRIOR TO RELEASE.								
MOD	MODIFY STANDARD LIGHT FIXTURE AS INDICATED										
BF	BALLAST FACTOR										
THD	TOTAL HARMONIC DISTORTION										
UNIV	UNIVERSAL										
N/A	NOT APPLICABLE										
INCL	INCLUDED WITH FIXTURE										
MT	MULTI-TAP BALLAST										
MVOLT	MULTI-VOLT BALLAST										
LIGHT FIXTURE PRIOR APPROVAL REQUIREMENTS			BIDDING REQUIREMENTS								
1. PRIOR APPROVAL IS REQUIRED BEFORE BIDDING THIS PROJECT			BID ONLY PRODUCTS THAT ARE SPECIFIED OR APPROVED BY ADDENDUM.								
2. PRIOR APPROVALS SHALL BE SUBMITTED TO THE ELECTRICAL ENGINEER'S OFFICE AT LEAST (8) WORKING DAYS BEFORE BID TIME. PRIOR APPROVALS RECEIVED AFTER THIS TIME PERIOD SHALL BE REJECTED.			PACKAGING OF LIGHT FIXTURES WITH OTHER SYSTEMS IS NOT ALLOWED.								
3. PRIOR APPROVALS SHALL BE SIGNED BY A PRINCIPAL OF THE SUBMITTING ORGANIZATION STATING THAT THEY HAVE PREPARED AND/OR REVIEWED THE SUBMITTALS AND THAT THE PROJECTS PROPOSED ARE EQUIVALENT TO THOSE SPECIFIED. ANY EXCEPTIONS SHALL BE SO NOTED.			WHEN ONLY ONE PRODUCT IS APPROVED FOR BIDDING, THE PRICE FOR THAT ITEM SHALL BE BROKEN OUT SEPARATELY WHEN SUBMITTING PRICING TO VARIOUS DISTRIBUTORS AND/OR CONTRACTOR.								
4. ITEMS THAT ARE SUBMITTED AND HAVE BEEN APPROVED WILL BE LISTED IN THE ADDENDUM(S). VERBAL APPROVALS WILL NOT BE GIVEN ON ANY ITEM.			WHEN A CONTRADICTION EXISTS BETWEEN A SPECIFIC MODEL NUMBER AND THE DESCRIPTION, THE DESCRIPTION SHALL GOVERN.								
5. IT IS NOT THE RESPONSIBILITY OF THE ELECTRICAL ENGINEER TO NOTIFY THE SUBMITTING PARTY OF ERRORS IN THE SUBMITTAL. NOTIFICATION OF ERRORS BY THE ELECTRICAL ENGINEER PRIOR TO ISSUANCE OF THE ADDENDUM(S) MAY NOT BE GIVEN.			REFER TO INSTRUCTIONS TO BIDDER LOCATED IN DIVISION 0 SPECIFICATION.								
6. PRIOR APPROVALS SHALL CONSIST OF TWO SETS OF CUT SHEETS DESCRIBING THE PRODUCTS BEING SUBMITTED AS EQUIVALENTS. FAXES ARE NOT ACCEPTABLE. ALL SPECIFICATION INFORMATION SHALL BE CLEARLY MARKED, WITH NON-APPLICABLE INFORMATION CROSSED OUT. COMPLETE PHOTOMETRIC DATA SHALL BE PROVIDED. PRODUCTS WITHOUT PHOTOMETRIC DATA WILL NOT BE APPROVED.											




FEEDER SCHEDULE							
FEEDER	# OF SETS	CONDUIT DIAMETER	CONDUCTOR		EQ GND COND	ISOLATED GROUND	SYSTEM BONDING JUMPER
			#	SIZE			
C30.2S	1	0.75	2	10	10	-	-
C30.3VD1	1	1	3	8	8	-	-

ONE-LINE SYMBOLS			
SYMBOL	DESCRIPTION	SYMBOL	DESCRIPTION
[Panel 'XX']	LIGHTING AND APPLIANCE PANEL BOARD	⊗	MOTOR
[Circuit Breaker]	CIRCUIT BREAKER	[Fused Disconnect]	FUSED DISCONNECT SWITCH

- KEYED NOTES:** (#)
- DEMOLISH EXISTING FEED FROM CONDENSING UNIT TO DISCONNECT, ALONG WITH FUSES INSIDE OF DISCONNECT. PROTECT AND MAINTAIN DISCONNECT ALONG WITH ASSOCIATED WIRING BACK TO PANEL A/C(E). DISCONNECT TO BE REUSED FOR CONNECTION TO NEW CONDENSING UNIT IN SAME LOCATION.
 - REMOVE EXISTING SPARE 30A/2P BREAKER (26.28) FROM PANEL AND DELIVER TO OWNER.
 - PROVIDE NEW CONNECTION FROM EXISTING DISCONNECT TO NEW CONDENSING UNIT INCLUDING ALL REQUIRED CONDUIT AND WIRE. PROVIDE NEW FUSES IN EXISTING DISCONNECT SIZED APPROPRIATELY FOR NEW UNIT.
 - PROVIDE (2) NEW 30A/1P BREAKERS IN EXISTING GE TYPE NLTQ STYLE 5 PANELBOARD. NEW BREAKERS TO MATCH EXISTING PANEL AIC RATINGS.
 - PROVIDE NEW 30A/3P BREAKER IN EXISTING SQUARE-D PANELBOARD. NEW BREAKER TO MATCH EXISTING PANEL AIC RATINGS.

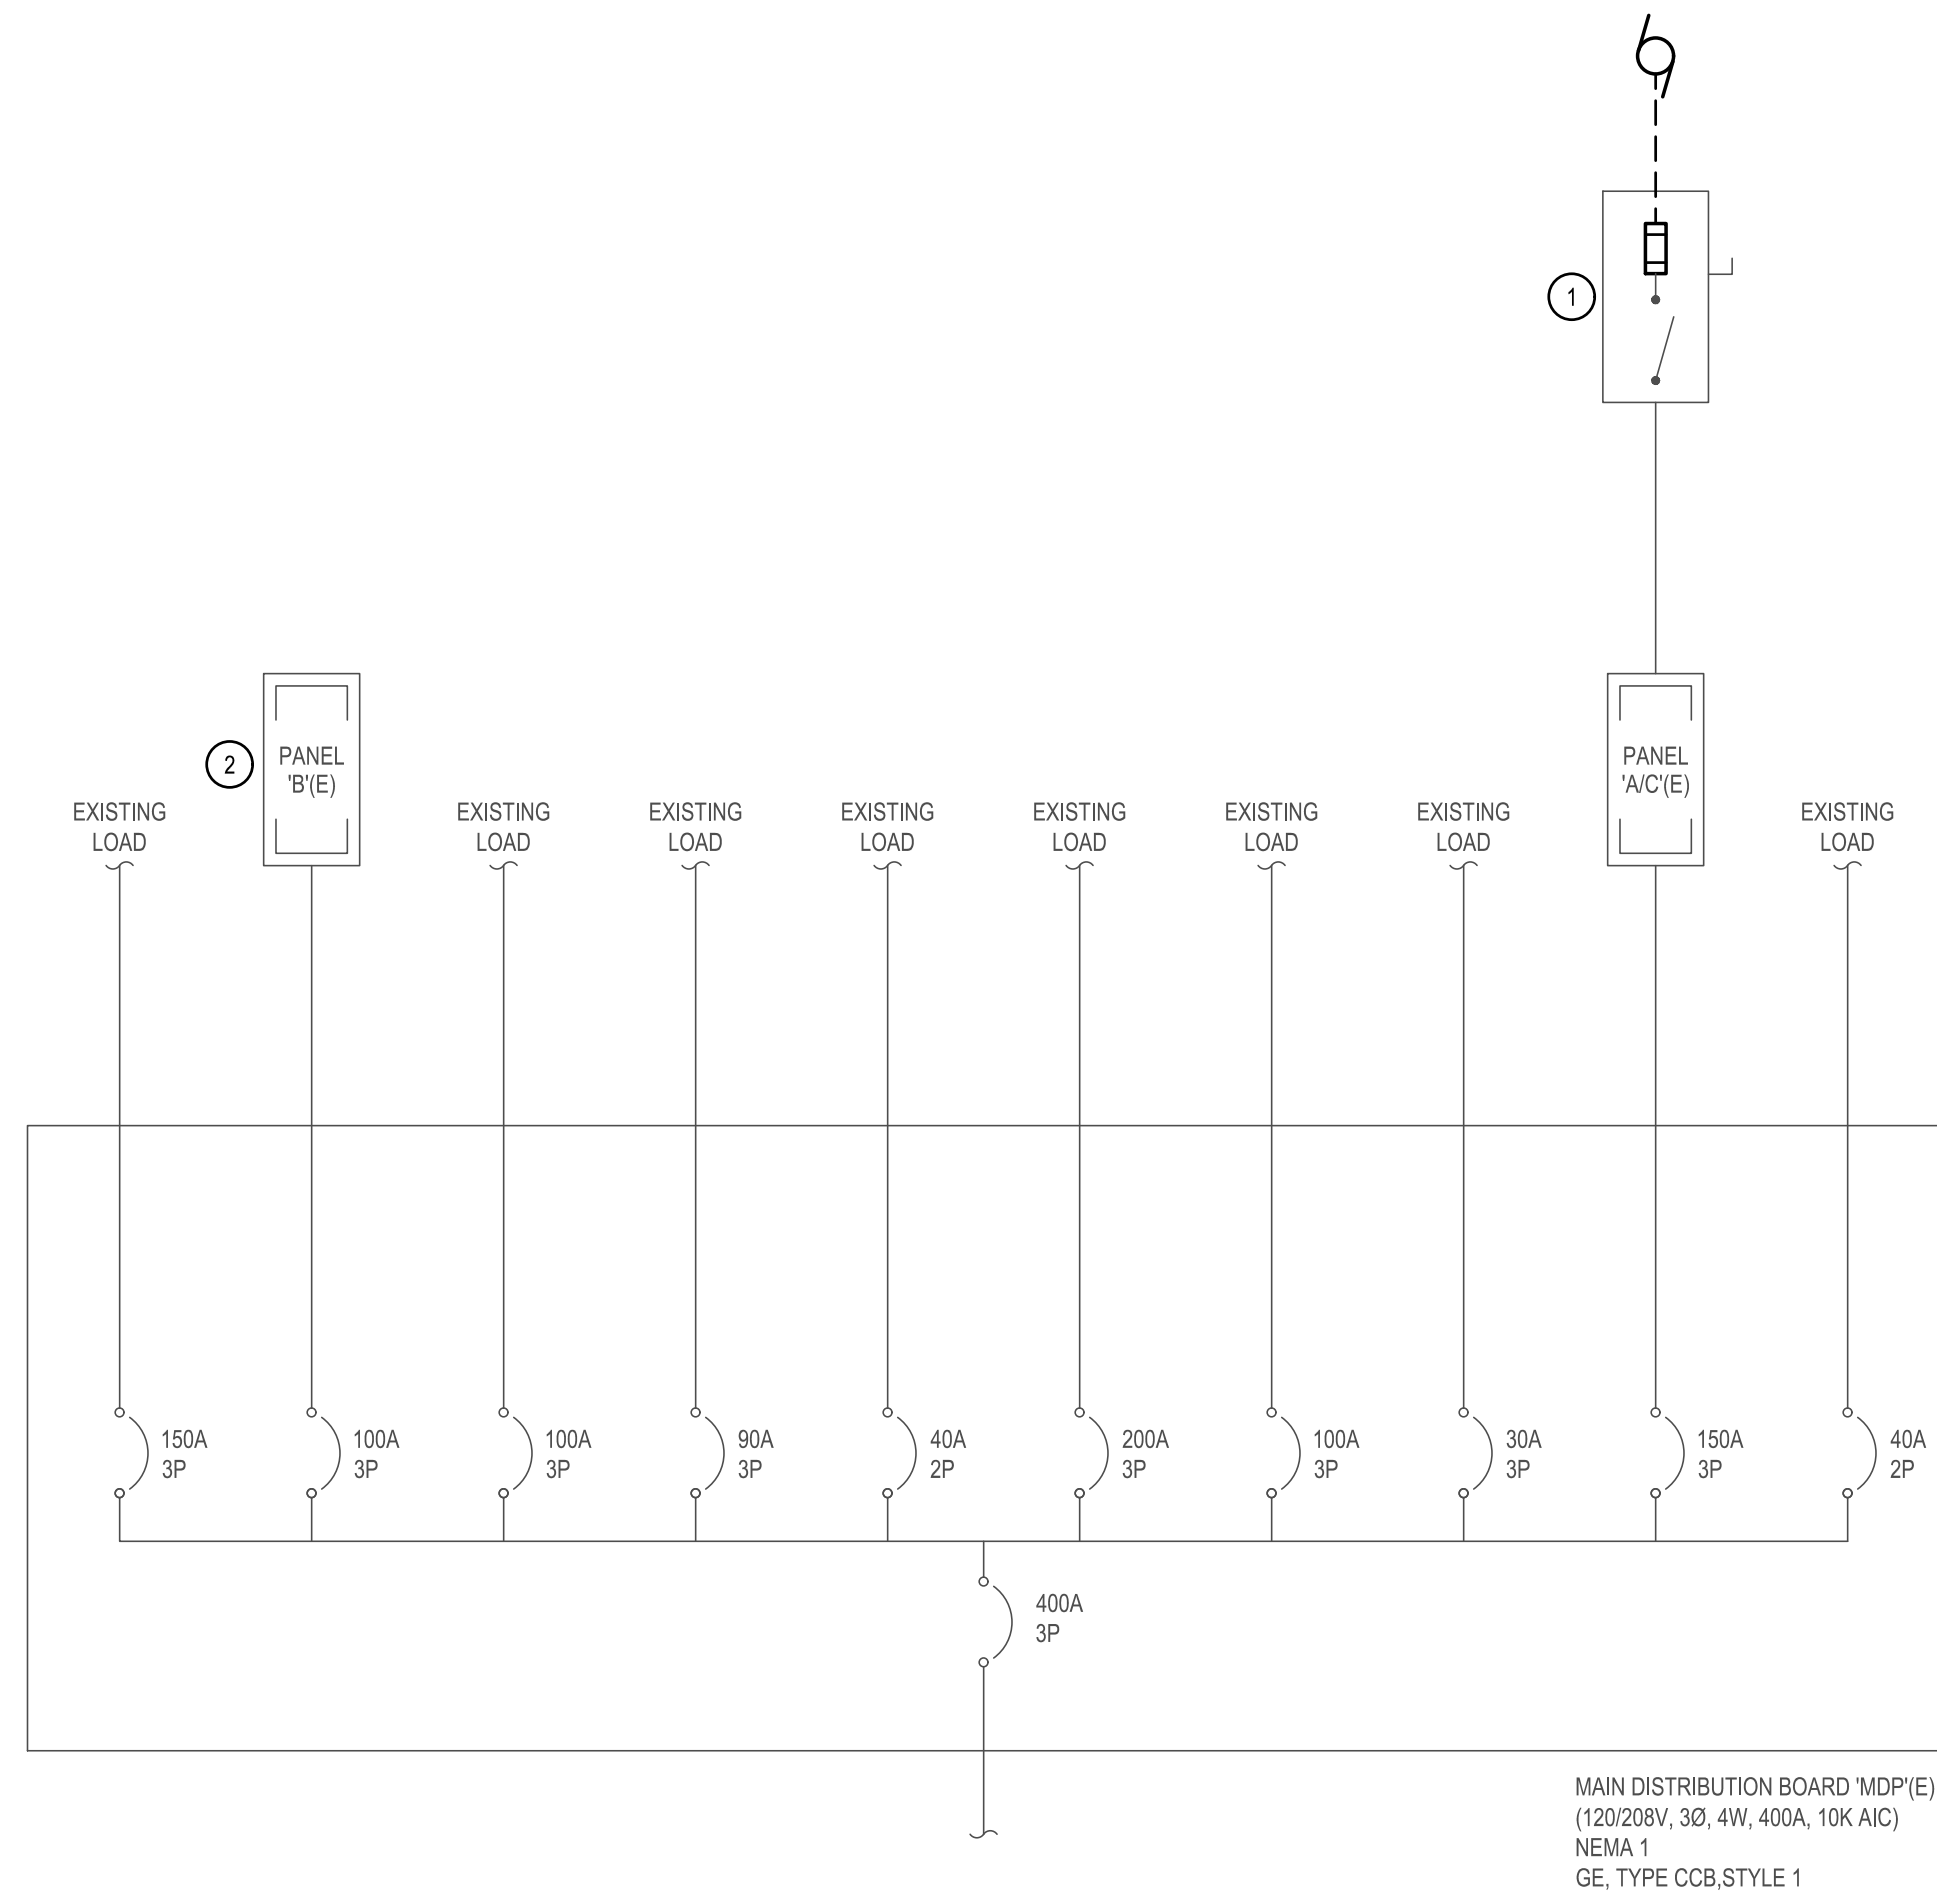

1 ONE-LINE DIAGRAM - DEMOLITION
SCALE: NONE

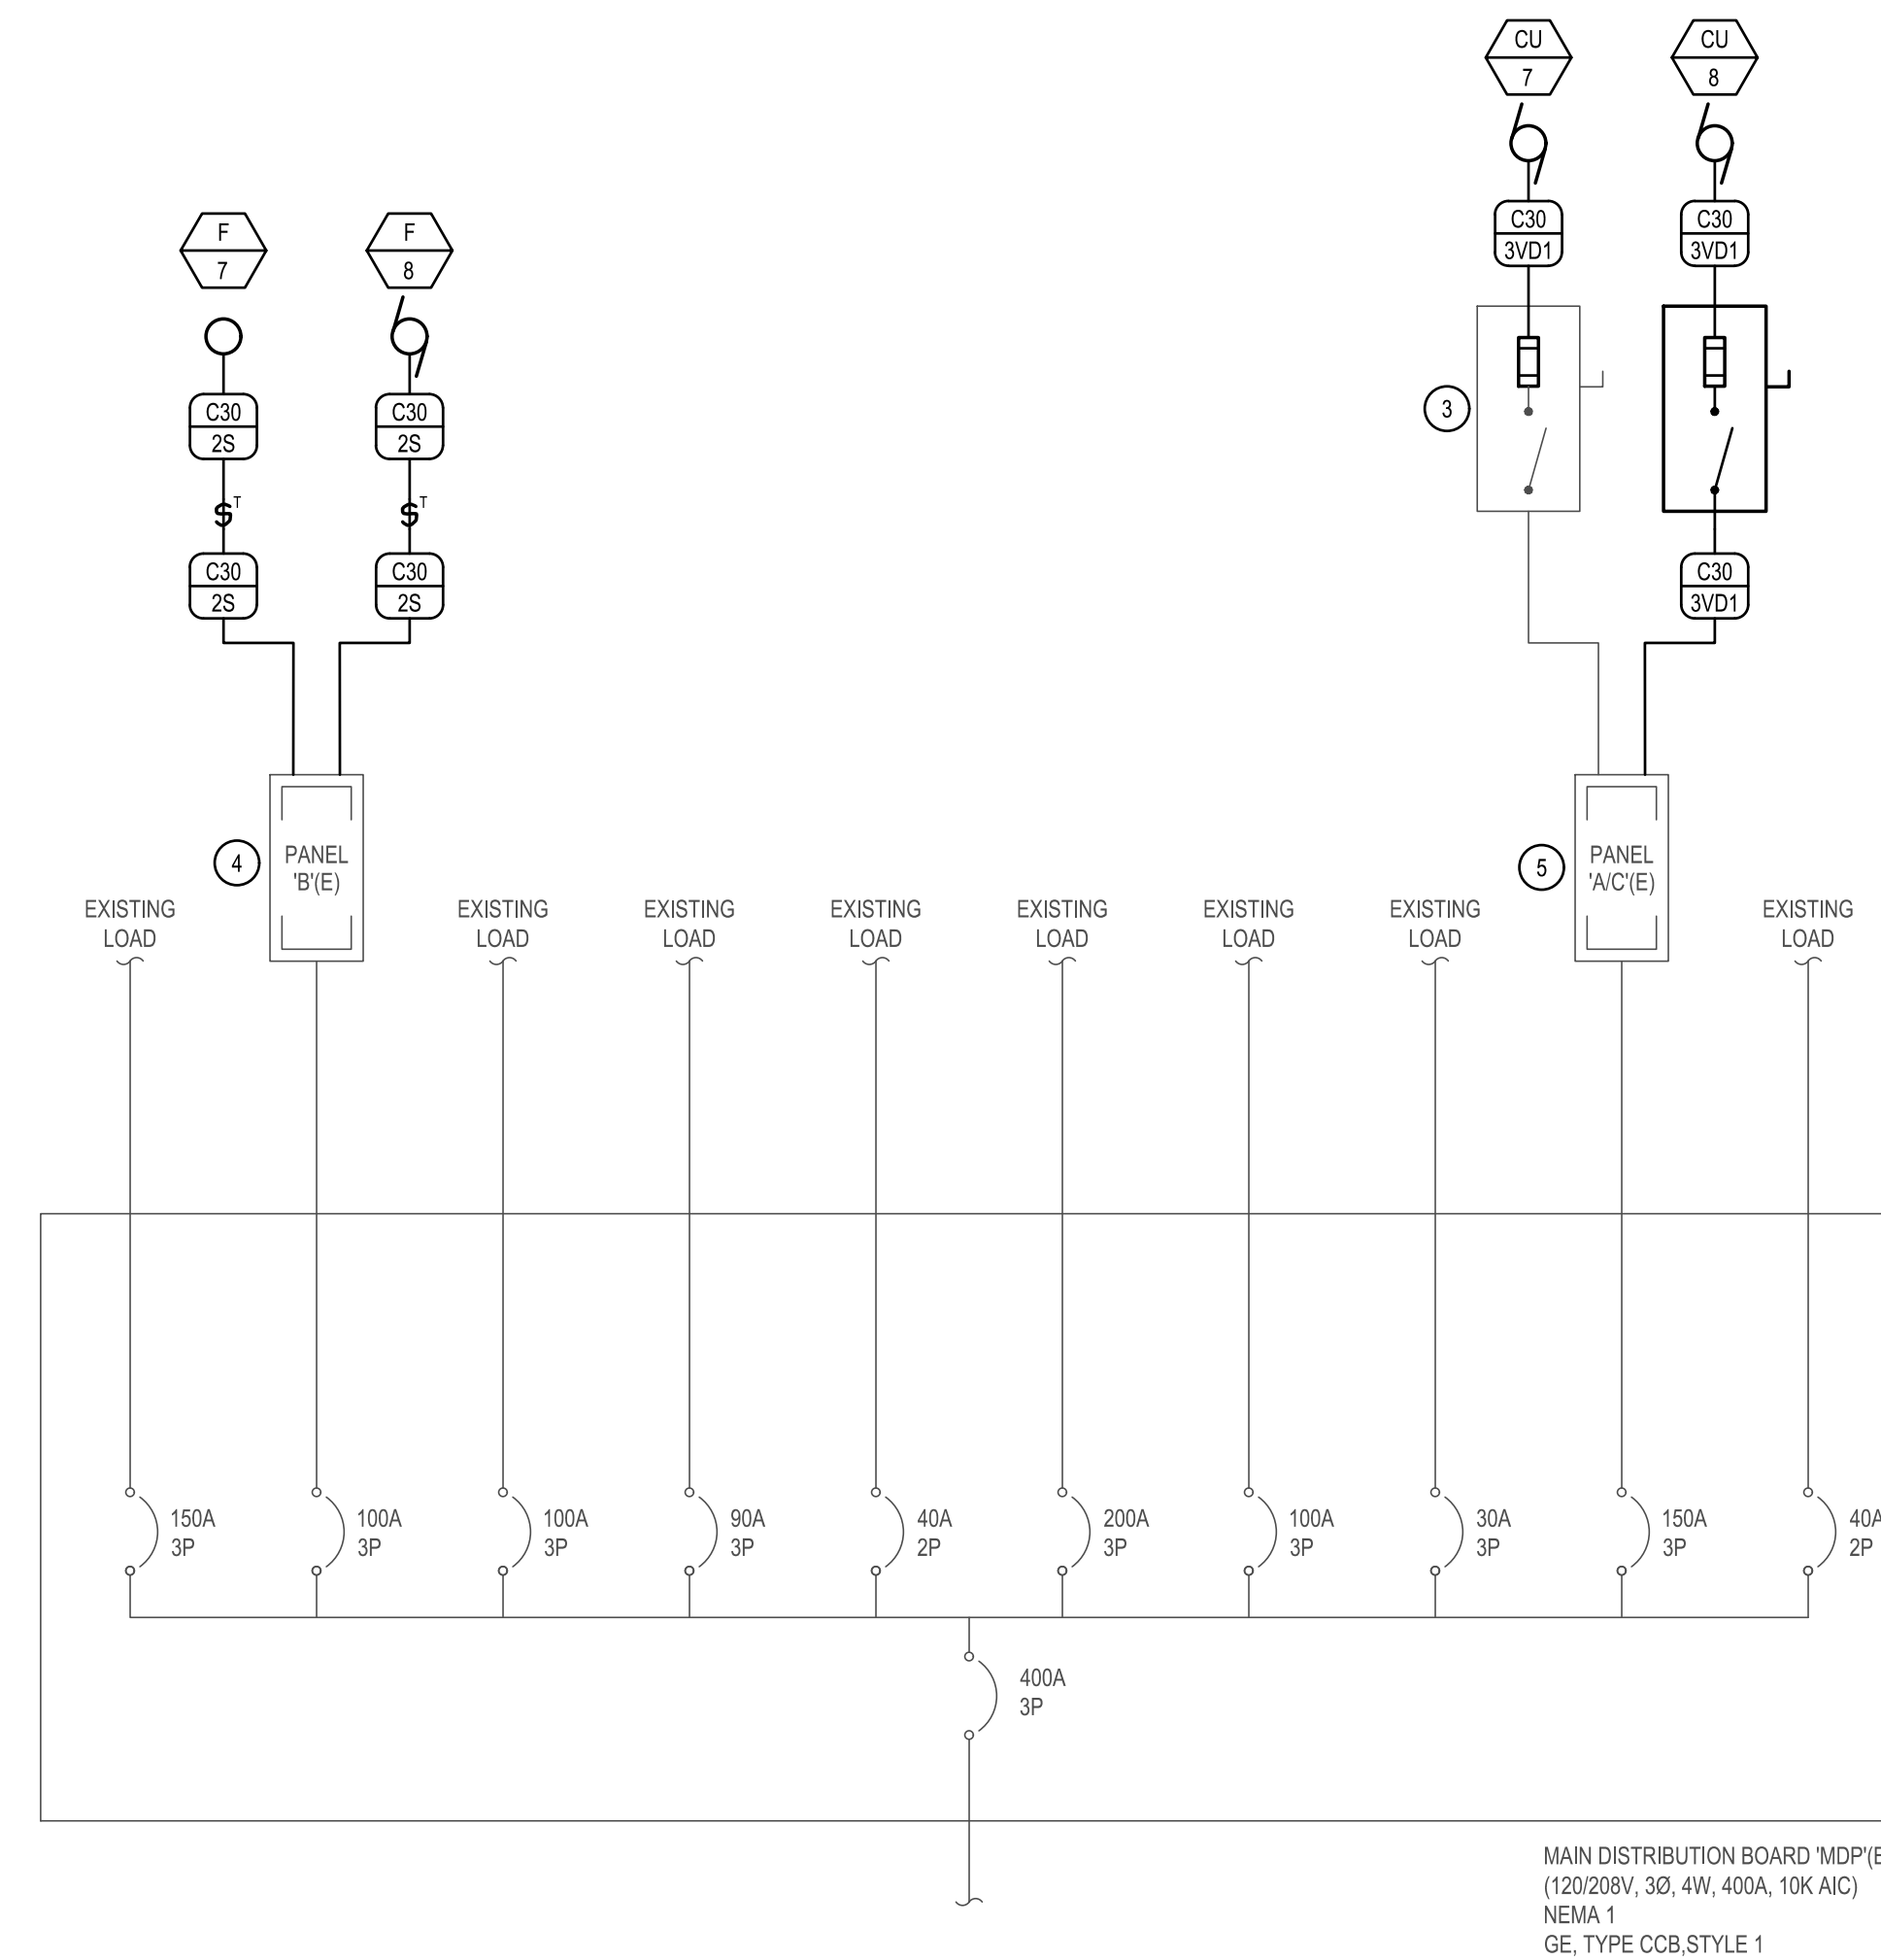

2 ONE-LINE DIAGRAM - NEW
SCALE: NONE

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2020-075.00

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PROJECT FOR

SALEM 1, 2 & 9 WARDS
SALEM UT WEST STAKE
PROPERTY NUMBER: 505056119010101
60 SOUTH MAIN STREET
SALEM, UTAH 84653

MARK	DATE	DESCRIPTION
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ISSUE TYPE: CONSTRUCTION DOCUMENTS
ISSUE DATE: JUNE 18, 2020
PROJECT NO: 18107
CAD DWG FILE:
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SHEET TITLE

ONE LINE DIAGRAM

SHEET NUMBERS

EP700

PANELBOARD SCHEDULE															
PANEL NAME: B(E)-EXIST				VOLTAGE: 208Y/120				MAINS TYPE: MLO				SPD: NONE			
MOUNTING: RECESSED				PHASE: 3				BUS MATERIAL: COPPER				NEUTRAL: 100% RATED			
ENCLOSURE: NEMA 1				WIRE: 4				BUS RATING: 225 AMPS				BRANCH OCP TYPE: BOLT-ON CBs			
DOOR STYLE: STANDARD				MIN. A.I.C. RATING: 10KA				MCB RATING: NONE				ISOLATED GROUND: NO			
MANUFACTURER: GE, TYPE NLTO, STLE 5															
KEYED NOTE	CIRCUIT DESCRIPTION	BREAKER AMPS	LOAD POLE	LOAD TYPE	CKT. #	CONNECTED LOAD/PHASE (VA)			CKT. #	LOAD TYPE	BREAKER AMPS	POLE	CIRCUIT DESCRIPTION	KEYED NOTE	
9	SOUTH CORRIDOR/EQPT LIGHTS	20	1	M	1	4,776	4,776		2	M	50	3	WEST WING A/C	9	
9	ENTRANCE AND FOYER LIGHT	20	1	M	3				4	M	50	3	108. BISHOPS, CLERKS, LIGHTS	9	
9	RESTROOM LIGHTS AND FAN	20	1	M	5				6	M	50	3	CLERKS, HALL, 101 LIGHTS	9	
9	MATERIALS, PRIMARY, ROOM 1 LIGHTS	20	1	M	7				8	M	50	3	111 ERCP	9	
9	MATERIALS, CORRIDOR, MEN'S RECPT	20	1	M	9				10	M	50	3	ENTRANCE, FOYER, CLERKS RECPT	9	
9	MATERIALS, NEXT ROOM RECPT	20	1	M	11				12	M	50	3	101, CLERKS RECPT	9	
9	PRIMARY RECPT, EWC	20	1	M	13				14	M	50	3	WEST CLASS FURNACE	9	
9	4 TON AC UNIT	30	3	M	15				16	M	50	3			
									18	M	50	3			
									20	M	50	3	HEAT TAPE, BELL	9	
9	EAST FURNACES	30	2	M	21				22	M	50	3	HALL RECPT	9	
									24	M	50	3	EXISTING LOAD	9	
9	RPP,S 105, 106, 107	20	1	M	25				26	M	50	3	SPARE	10	
9	EXISTING LOAD	20	1	M	27				28	M	50	3			
9	EXISTING LOAD	20	1	M	29				30	M	50	3	HEAT TAPE	9	
TOTAL CONNECTED LOAD PER PHASE (VA):															
TOTAL ESTIMATED DEMAND LOAD PER PHASE (VA):															
TOTAL ESTIMATED DEMAND LOAD PER PHASE (AMPS):															

PANELBOARD SCHEDULE															
PANEL NAME: AC(E)-EXIST				VOLTAGE: 208Y/120				MAINS TYPE: MLO				SPD: NONE			
MOUNTING: SURFACE				PHASE: 3				BUS MATERIAL: COPPER				NEUTRAL: 100% RATED			
ENCLOSURE: NEMA 1				WIRE: 4				BUS RATING: 150 AMPS				BRANCH OCP TYPE: BOLT-ON CBs			
DOOR STYLE: STANDARD				MIN. A.I.C. RATING: 10KA				MCB RATING: NONE				ISOLATED GROUND: NO			
MANUFACTURER: SQUARE-D															
KEYED NOTE	CIRCUIT DESCRIPTION	BREAKER AMPS	LOAD POLE	LOAD TYPE	CKT. #	CONNECTED LOAD/PHASE (VA)			CKT. #	LOAD TYPE	BREAKER AMPS	POLE	CIRCUIT DESCRIPTION	KEYED NOTE	
11	EAST WING A/C	50	3	M	1	4,776	4,776		2	M	50	3	WEST WING A/C	9	
									4	M	50	3			
									6	M	50	3			
9	CHILDREN MEETING ROOM	20	2	M	7	1,248	1,248		8	M	20	2	CHILDREN MEETING ROOM	9	
	SOUTH A/C			M	9				10	M	20	2	NORTH A/C		
	SPACE ONLY	20	1	M	11				12	M	20	1	SPACE ONLY		
	SPACE ONLY	20	1	M	13				14	M	20	1	SPACE ONLY		
	SPACE ONLY	20	1	M	15				16	M	20	1	SPACE ONLY		
TOTAL CONNECTED LOAD PER PHASE (VA):						12,048	12,048	9,552							
TOTAL ESTIMATED DEMAND LOAD PER PHASE (VA):						13,242	13,242	10,746							
TOTAL ESTIMATED DEMAND LOAD PER PHASE (AMPS):						110	110	90							

MECHANICAL EQUIPMENT SCHEDULE																	
UNIT NAME	DESCRIPTION	LOAD	TYPE	VOLTAGE	PHASE	AMPERAGE	CONDUIT SIZE	WIRES			STARTER / DISCONNECT/ CONNECTION AT UNIT				REMARKS		
								NO.	SIZE	EQPT	STARTER SIZE	OCP		DISCONNECT		ENCLOSURE	
F-7	FURNACE	1	HP	120	1	16	3/4"	2	10	10	2A						
F-8	FURNACE	1	HP	120	1	16	3/4"	2	10	10	2A						
CU-7	CONDENSING UNIT	17.8	MCA	208	3	17.8	1"	3	8	8	10A						
CU-8	CONDENSING UNIT	21.4	MCA	208	3	21.4	1"	3	8	8	10A						

SIZE ALL FUSES IN ACCORDANCE WITH MANUFACTURER'S RECOMMENDATIONS.

STARTER / DISCONNECT NOTES:

- MANUAL STARTER WITH THERMAL OVERLOAD
- MANUAL STARTER WITH THERMAL OVERLOAD PROTECTION & LOW VOLTAGE RELAY / CONTACTOR FOR ATC CONTROL
- COMBINATION MAGNETIC STARTER / FUSED DISCONNECT
- COMBINATION MAGNETIC STARTER / MOTOR CIRCUIT PROTECTOR (MCP)
- COMBINATION VARIABLE FREQUENCY DRIVE / MOTOR CIRCUIT PROTECTOR (MCP)
- REDUCED VOLTAGE STARTER
- COMBINATION TWO-SPEED STARTER / FUSED DISCONNECT
- COMBINATION TWO-SPEED STARTER / MOTOR CIRCUIT PROTECTOR (MCP)
- NON-FUSED DISCONNECT SWITCH

INSTALLATION NOTES:

- FUSED DISCONNECT SWITCH
- BREAKER AND ENCLOSURE
- DIRECT CONNECTION
- DUPLEX RECEPTACLE OUTLET
- SPECIAL PURPOSE OUTLET
- SHUNT-TRIP BREAKER AND ENCLOSURE
- TOGGLE SWITCH
- MAGNETIC STARTER
- BUSSMANN ELEVATOR POWER MODULE
- NON-FUSED DISCONNECT SWITCH WITH LATE-MAKE/EARLY BREAK CONTACT

A. FURNISHED, INSTALLED, & CONNECTED UNDER DIVISION 26.
 B. FURNISHED & INSTALLED UNDER ANOTHER DIVISION REQUIRING CONNECTIONS UNDER DIVISION 26.
 C. FURNISHED UNDER ANOTHER DIVISION BUT INSTALLED AND CONNECTED UNDER DIVISION 26.
 D. FURNISHED, INSTALLED, & CONNECTED UNDER ANOTHER DIVISION
 E. FURNISHED BY OWNER, INSTALLED & CONNECTED BY DIVISION 26

REMARKS:
1. MAKE ALL REQUIRED CONNECTIONS FROM DISCONNECT TO UNIT.

- PANELBOARD SCHEDULE KEYED NOTES:
- PROVIDE CLASS A GROUND FAULT INTERRUPTER TYPE CIRCUIT BREAKER.
 - PROVIDE ARC FAULT CIRCUIT INTERRUPTER TYPE CIRCUIT BREAKER.
 - PROVIDE 30 MILLIAMPERE EQUIPMENT GROUND FAULT PROTECTOR TYPE CIRCUIT BREAKER.
 - PROVIDE SHUNT-TRIP TYPE CIRCUIT BREAKER WITH 120V COIL.
 - PROVIDE HACR RATED CIRCUIT BREAKER.
 - PROVIDE HANDLE CLAMP FOR HOLDING CIRCUIT BREAKER IN THE "ON" OR "OFF" POSITION.
 - PROVIDE SWITCHING RATED CIRCUIT BREAKER.
 - PROVIDE NEW CIRCUIT BREAKER IN EXISTING PANELBOARD (WHERE PANEL IS INDICATED AS EXISTING) OF SAME MANUFACTURER AND A.I.C. RATING AS EXISTING.
 - EXISTING LOAD.
 - REMOVE EXISTING BREAKER FROM EXISTING PANEL.
 - EXISTING LOAD TO BE REPLACED BY NEW. NO CHANGE TO BREAKER.

PANEL LEGEND

B(E)-EXIST	B(E)-NEW
AC(E)-NEW	AC(E)-NEW

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PROFESSIONAL ENGINEER
05/21/2020
8367784-2202
TREVOR REED SPENCER
STATE OF UTAH

PROJECT FOR

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PANEL BOARD SCHEDULES

SHEET NUMBERS

EP800