




					DRAWING INDEX				
SHEET NUMBER	SHEET TITLE	SHEET NUMBER	SHEET TITLE	SHEET NUMBER	SHEET TITLE	SHEET NUMBER	SHEET TITLE		
	GENERAL		ARCHITECTURAL		PLUMBING		MECHANICAL		
G001	COVER AND INDEX SHEET	A101	FLOOR PLANS	PD101	PLUMBING DEMOLITION PLAN	MD101	MECHANICAL DEMOLITION PLAN		
		A121	ROOF PLANS	P101	PLUMBING PLANS	M101	MECHANICAL PLANS		
		A122	ROOFING DETAILS	P301	LARGE SCALE PLUMBING PLANS	M501	MECHANICAL DETAILS		
		A151	REFLECTED CEILING PLANS			M601	LARGE SCALE MECHANICAL PLAN AND EQUIPMENT SCH		
		A152	CEILING DETAILS			M701	AUTOMATIC TEMPERATURE CONTROL WIRING AND EQU		
		A401	ENLARGED RECEPTION, WORK ROOM AND BREAK ROOM						
		A402	ENLARGED RESTROOMS						
		A601	FINISH SCHEDULE AND DETAILS						
		A602	DOOR AND WINDOW SCHEDULES AND DETAILS						
			FURNISHINGS						
		F101	FLOOR FINISH PLAN						
		F201	ROOM SIGNAGE PLAN AND DETAILS						

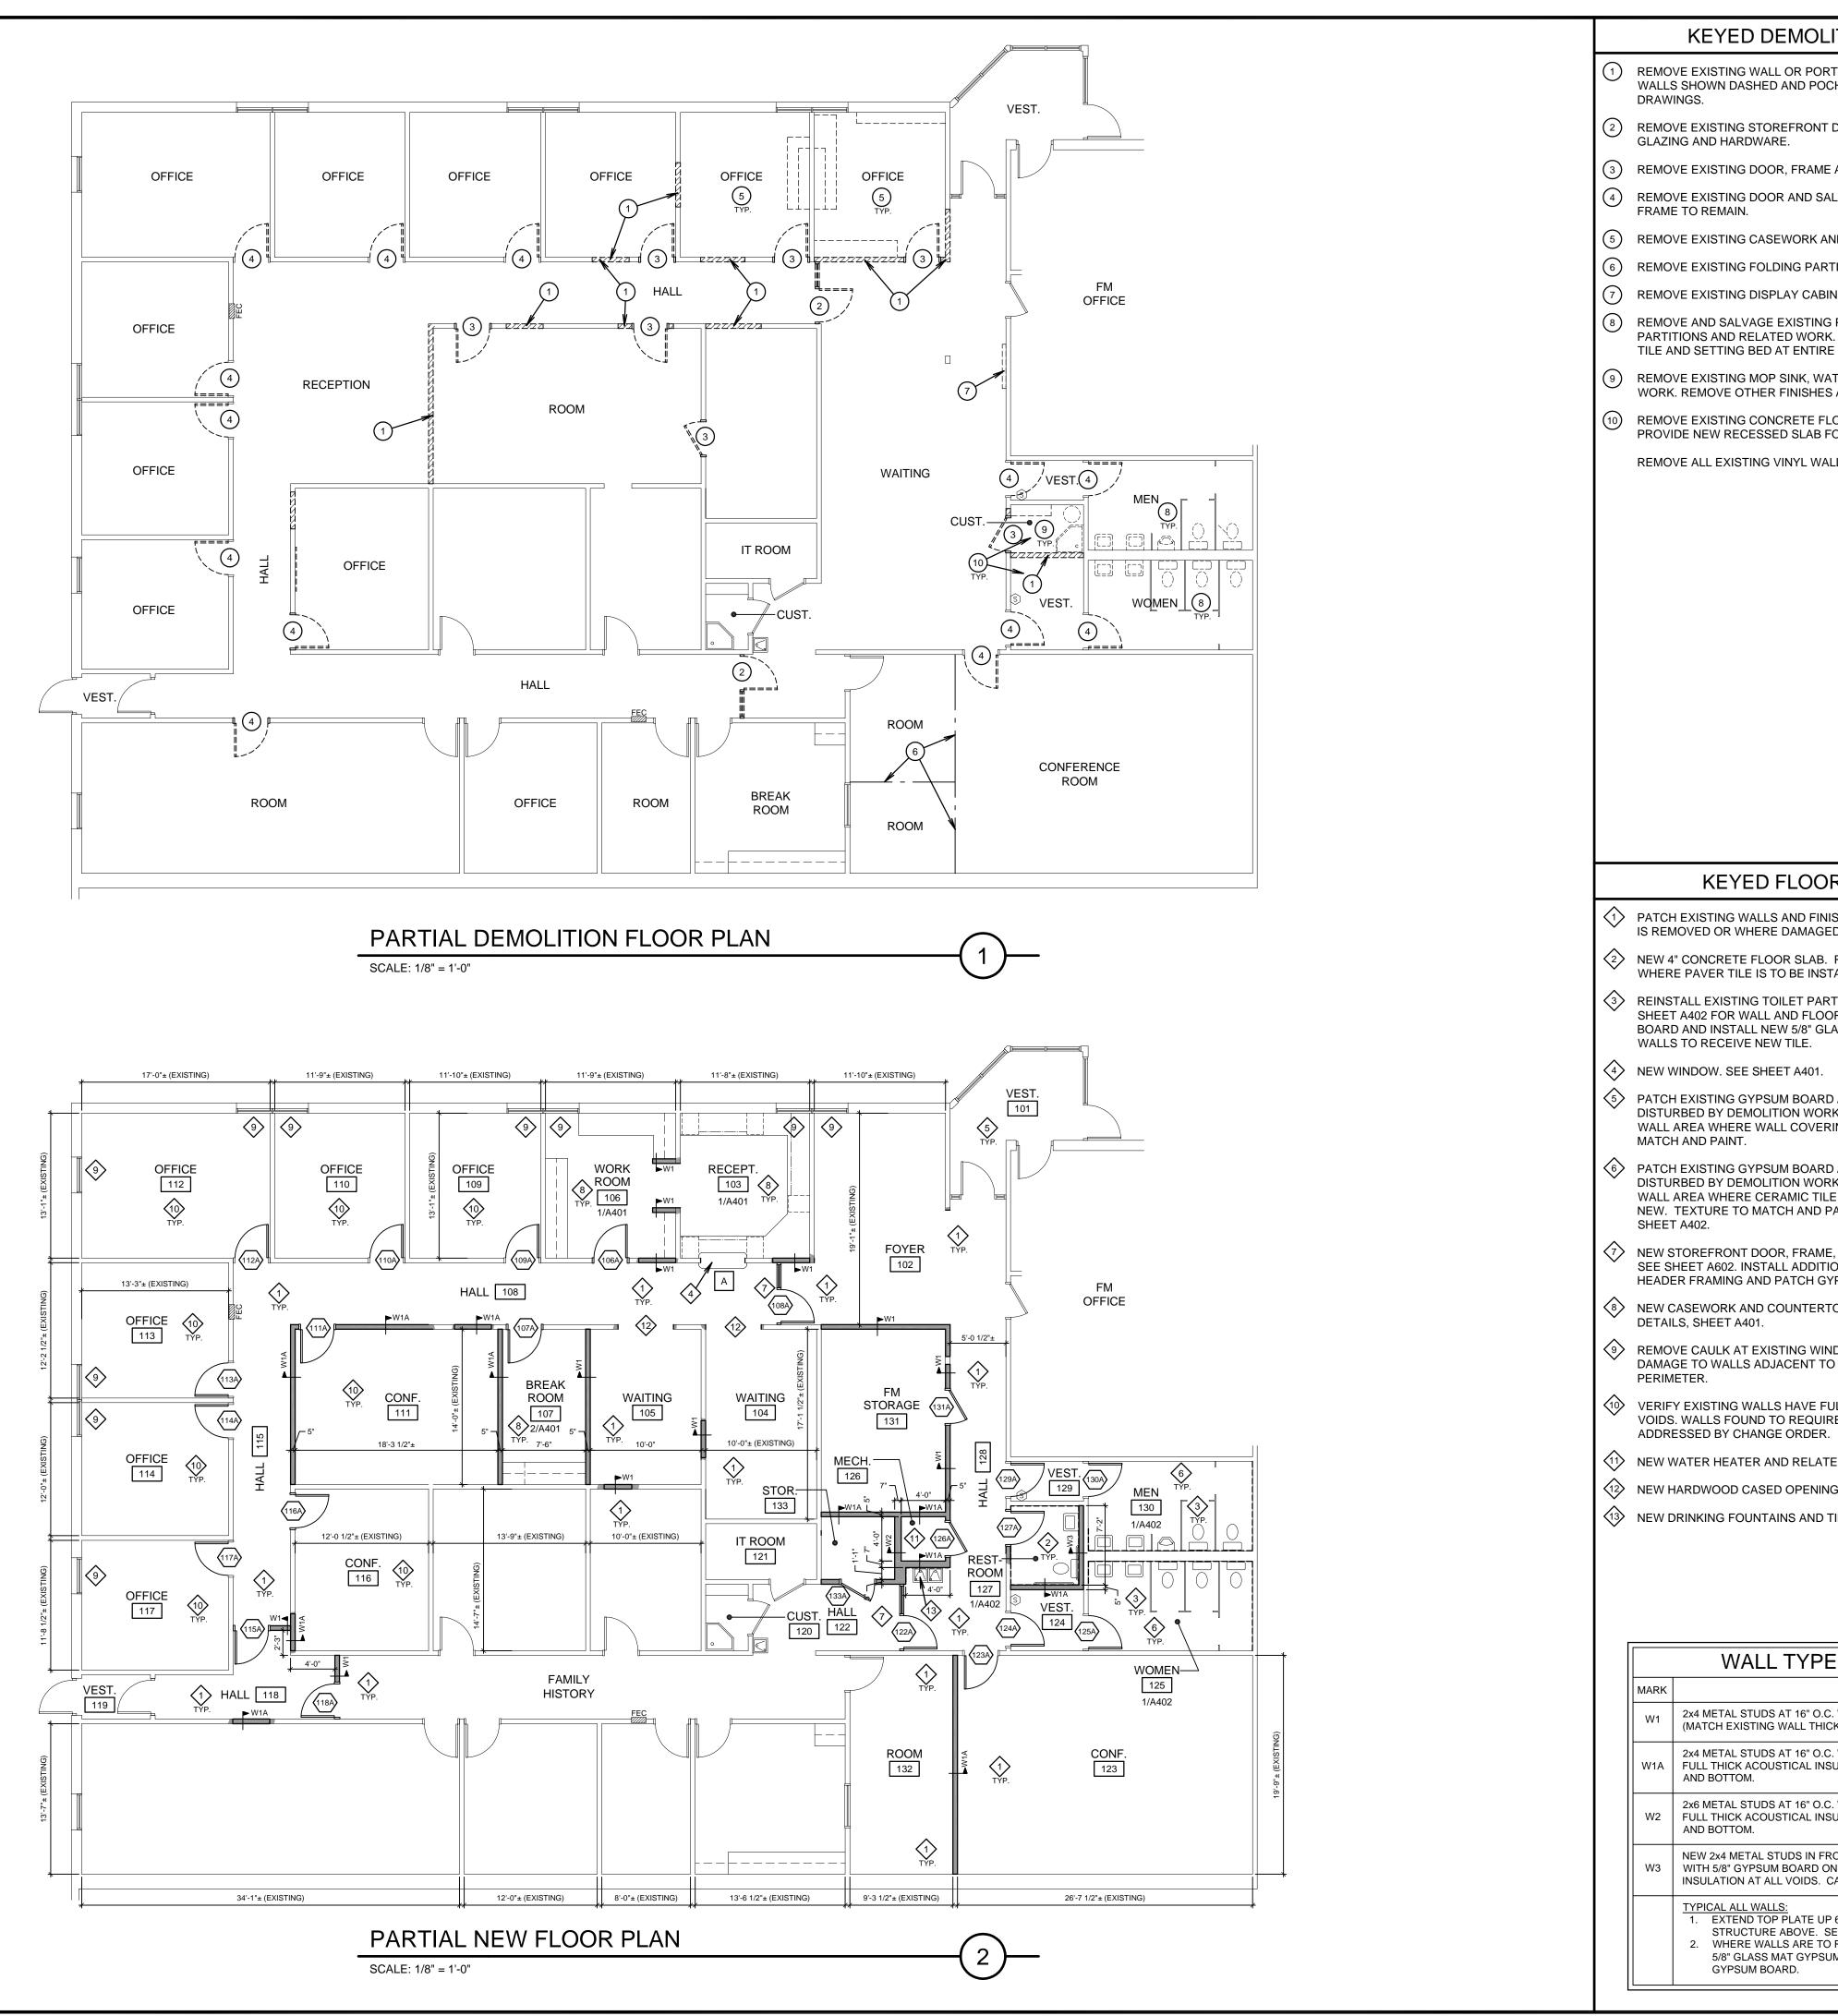



ITION NOTES	GENERAL DEMOLITION NOTES	
TION OF WALL - COMPLETE. TYPICAL ALL CHED. COORDINATE WITH OTHER DOOR, FRAME, SIDELITE(S), TRANSOM,	1. DEMOLITION DRAWINGS ARE NOT INTENDED TO BE ALL-INCLUSIVE OR TO LIMIT EXTENT OF DEMOLITION WORK REQUIRED. CONTRACTOR SHALL VISIT SITE PRIOR TO BIDDING AND COORDINATE WITH ALL TRADES AND OTHER DRAWINGS AND DOCUMENTS TO DEFINE EXTENT OF DEMOLITION WORK REQUIRED TO CARRY OUT THE INTENT OF THESE CONTRACT	architec , plic
AND HARDWARE.	 PROTECT EXISTING FINISHES WHICH ARE TO REMAIN DURING THIS WORK. 	ar , pl
LVAGE EXISTING HARDWARE. EXISTING	 OWNER HAS FIRST RIGHTS TO SALVAGE. 	YGI Ites Atos
ND COUNTER TOPS. TITION AND RELATED WORK.	4. <u>FLOOR COVERINGS:</u> AT ALL AREAS OF NEW WORK, REMOVE EXISTING CARPET AND BASE AS REQUIRED TO ACCOMMODATE NEW WORK. OWNER WILL REMOVE REMAINDER OF CARPET, BASE AND GLUE RESIDUE AT COMPLETION OF THIS WORK. SEE FINISH SCHEDULE ON SHEET A601 AND FURNISHINGS FLOOR PLAN, SHEET F101.	bradley gygi al & associates, F Salt Lake City, Utah 84106 801.747.2451
NET. SALVAGE TO FM GROUP. 9 PLUMBING FIXTURES, TOILET 4. REMOVE EXISTING WALL AND FLOOR 5 ROOM.	5. <u>FLOORS:</u> REMOVE EXISTING FLOOR STRUCTURE, CONCRETE, WOOD AND FLOOR SHEATHING AS REQUIRED FOR THIS WORK.	brad & as 2150 Sou Salt Lake 801.147.2
TER HEATER, SHELVING AND RELATED AT ENTIRE ROOM.	 <u>CEILINGS</u>: SEE SHEET A151. <u>WALLS, FLOORS AND CEILING STRUCTURE</u>: REMOVE ALL WALLS, FLOORS AND CEILING STRUCTURE WHERE NEW WORK WILL OCCUR. SEE NEW FLOOR PLANS FOR LOCATION OF NEW WALLS. SEE OTHER DRAWINGS 	
OOR SLAB SOILS, ETC. AS REQUIRED TO OR RESTROOM THIS AREA. LL COVERING AT ENTIRE ROOM.	 FOR AREAS WHICH WILL REQUIRE REMOVAL TO ACCOMPLISH NEW WORK. 8. VISUAL DISPLAY BOARDS, MOVIE SCREENS, EQUIPMENT, DEVICES, FIXTURES, GRILLES, SPEAKERS, CONVECTORS, COVER PLATES, HANDRAILS, BRACKETS, COAT RACKS, HOOK STRIPS, AND OTHER EXISTING WORK: WHERE NOT SHOWN TO BE REMOVED OR REPLACED WITH NEW, 	STAMP:
	 REMOVE AND REINSTALL EXISTING AS REQUIRED TO ACCOMMODATE NEW WORK AND FINISHES. 9. PLUMBING, MECHANICAL, H.V.A.C., FIRE SPRINKLING, ELECTRICAL, SOUND AND RELATED WORK: COORDINATE WITH NEW WORK AND OTHER DRAWINGS, SALVAGE AND FOURDMENT AND FIXTURES SHOWN TO BE 	No. 6112725
	 DRAWINGS. SALVAGE ALL EQUIPMENT AND FIXTURES SHOWN TO BE REINSTALLED. 10. CONTRACTOR TO MAINTAIN STRUCTURAL INTEGRITY OF EXISTING STRUCTURE. PROVIDE SHORING AND TEMPORARY SUPPORT AS 	BRADLEY G GYGI H-9-2018
	REQUIRED. 11. WHERE SHOWN ZZZZZZZ POCHED ON PLAN, REMOVE EXISTING WALL OR PORTION OF WALL - COMPLETE. REMOVE ALL PIPING, WIRING, EQUIPMENT, AND OTHER ITEMS CONCEALED IN WALL. COORDINATE ITEMS	and the second s
	TO BE MAINTAINED AND ABANDONED WITH ALL DISCIPLINES.	Y SERVICES DY UT TOREHOUSE 8400 SOUTH Y, UTAH
R PLAN NOTES	GENERAL FLOOR PLAN NOTES	MIL S S S AND
SHES TO MATCH WHERE EXISTING WORK	GENERAL NOTES: 1. DIMENSIONS SHOWN ON PLANS ARE FROM FACE OF GYPSUM BOARD OR EXISTING WALLS	
RECESS SLAB 2" FOR SETTING BED FALLED.	UNLESS NOTED OTHERWISE. 2. PROVIDE SOLID BLOCKING IN THE WALLS AT ALL DOOR STOPS, VISUAL DISPLAY BOARDS, TOILET COMPARTMENTS, LAVATORY SUPPORTS, AND AT ALL OTHER EQUIPMENT AND ACCESSORY LOCATIONS. SEE A/A501.	SAT BISH
TITIONS AND PLUMBING FIXTURES. SEE OR TILE. REMOVE EXISTING GYPSUM	 FOR FINISH SCHEDULE, SEE SHEET A601. FOR DOOR SCHEDULE, SEE SHEET A602. 	
ASS MAT GYPSUM TILE BACKER AT	 WALLS: 1. WHEN EXISTING WORK IS TO REMAIN: HVAC, PLUMBING, ELECTRICAL, SOUND OR OTHER WORK WHICH IS ENCOUNTERED WITH REMOVAL OF FLOORS, WALLS OR CEILINGS, SHALL BE REROUTED TO MAINTAIN CONTINUITY. 2. NEW WALLS ARE SHOWN "POCHED" AND "HATCHED" TYPICAL. 	
D AND PLASTER TO MATCH WHERE RK. (1) COAT KILZ COATING AT ENTIRE RINGS ARE REMOVED. TEXTURE TO	WOOD FRAMED BRICK CMU CONCRETE 3. FOR WALL TYPES, SEE SCHEDULE THIS SHEET.	R: HOF IRIS SAINT
D AND PLASTER TO MATCH WHERE RK. (1) COAT KILZ COATING AT ENTIRE E IS REMOVED AND NOT REPLACED WITH PAINT. COORDINATE LOCATIONS WITH	 INTERIOR - PATCHING/FINISHES: PATCH AND REPAIR ALL EXISTING WORK DISTURBED BY THIS NEW WORK. WALLS, CEILINGS, FLOORS, TRIM AND OTHER WORK SHALL BE FINISHED TO MATCH EXISTING (OR NEW) FINISHES FOR SPACE. WHERE EXISTING WORK IS TO BE REPLACED: REMOVE AND REINSTALL EXISTING FIXTURES, DEVICES, CONVECTORS, GRILLES, LOUVERS, EQUIPMENT AND OTHER EXISTING WORK TO EXISTING LOCATION TO ACCOMMODATE NEW WORK. 	PROJECT FOR: THE CHURCH US CH LATTER-DAY S
E, SIDELITE(S), TRANSOM AND GLAZING. ONAL METAL WALL FRAMING AND (PSUM BOARD TO MATCH.	 WALLS TO HAVE PAINT ARE TO BE FINISHED TO SMOOTH SURFACE (LEVEL) PRIOR TO APPLICATION OF TEXTURING AND WALL COVERING INSTALLATIONS. CASEWORK, PANELING, TRIM, DOORS: 1. WOOD CASEWORK, PANELING, DOORS, JAMBS, TRIM, RAILINGS AT ALL AREAS EXCEPT 	JESI OF L
OPS. SEE ENLARGED PLANS AND IDOWS. REPAIR EXISTING WATER D WINDOWS. RECAULK WINDOWS ENTIRE	MECHANICAL, STORAGE AND OTHER UNFINISHED NON-PUBLIC SPACES: ALL EXISTING PAINTED WOOD WORK TO BE SANDED, PATCHED AND REPAIRED, AND PAINTED TO MATCH EXISTING COLOR. ALL EXISTING STAINED WOOD WORK TO BE LIGHTLY SANDED, PATCHED AND REPAIRED, STAIN TOUCHED UP TO MATCH EXISTING COLOR AND TWO COATS FINISH APPLIED.	
JLL THICK ACOUSTIC INSULATION AT ALL RE ADDITIONAL INSULATION WILL BE	CAULKING: 1. CAULK ALL NEW AND EXISTING DOOR, WINDOW AND STOREFRONT FRAMES ENTIRE PERIMETER AT INTERIOR AT ALL AREAS OF THIS NEW WORK. REMOVE EXISTING CAULK AND INSTALL NEW CAULK PRIOR TO PAINTING AND FINISH WORK.	
ED WORK. SEE PLUMBING DRAWINGS.	INSULATION: 1. EXISTING OFFICES HAVE ACOUSTICAL BATT INSULATION ON TOP OF LAT-IN ACOUSTICAL TILE. INSULATION SHALL BE SALVAGED AND REINSTALLED OR MAINTAINED IN PLACE	
G. SEE F/A601. TILE. SEE H/A402.	 DURING CEILING REPLACEMENT. 2. CONTRACTOR SHALL VERIFY THAT OFFICES, CONFERENCE ROOMS IN AREAS OF THIS WORK HAVE FULL THICK ACOUSTIC INSULATION AT ALL VOIDS. WALLS FOUND TO REQUIRE ADDITIONAL INSULATION WILL BE ADDRESSED BY CHANGE ORDER. 3. AT EXISTING AREAS, REPLACE ALL DISTURBED OR REMOVED INSULATION WHICH IS 	
	OTHERWISE TO REMAIN AT WALLS AND CEILINGS TO MATCH EXISTING - FULL THICK. 4. AT WALLS, FLOOR AND ATTIC SPACES, REINSTALL OR REPLACE WITH NEW ACOUSTIC OR THERMAL INSULATION ENCOUNTERED OR DISTURBED BY THIS WORK.	
	FIRE PROTECTION: I. FIRE SPRINKLING: AT ALL AREAS OF NEW WORK, MODIFY EXISTING AUTOMATIC FIRE SPRINKLING SYSTEM TO PROVIDE FULL COVERAGE. SEE SPECIFICATIONS SECTION 21 1313	PROJECT NUMBER: 5261066-18010106 DATE:
ESCHEDULE	 FOR STANDARDS. <u>FIRE ALARM</u>: SEE ELECTRICAL DRAWINGS FOR FIRE ALARM MODIFICATIONS AT AREAS OF NEW WORK. 	9 APR 2018 PROPERTY NUMBER: 5261066
DESCRIPTION	STRUCTURAL: 1. MAINTAIN STRUCTURAL INTEGRITY OF EXISTING STRUCTURE. PROVIDE SHORING AND	DRAWN BY: CHECKED: BGG BGG
:. WITH 5/8" GYPSUM BOARD EACH SIDE. CKNESS AT EXISTING ADJACENT WALLS)	TEMPORARY SUPPORT AS REQUIRED. 2. SEE STRUCTURAL DRAWINGS FOR NEW SEISMIC UPGRADES AND OTHER WORK. PLUMBING, MECHANICAL AND ELECTRICAL:	SHEET TITLE:
2. WITH 5/8" GYPSUM BOARD EACH SIDE. SULATION AT ALL VOIDS. CAULK TOP	1. REMOVE EXISTING FIXTURES AND DEVICES TO ACCOMMODATE OTHER TRADES DURING THIS CONSTRUCTION AND REINSTALL OR REPLACE WITH NEW AT COMPLETION OF WORK.	FLOOR PLANS
SULATION AT ALL VOIDS. CAULK TOP		
NE SIDE. FULL THICK ACOUSTICAL CAULK TOP AND BOTTOM. 		SHEET:
DEFINITION OF THE DIGITIES OF THE DIGITIES OF THE DETAIL A/A101. RECEIVE CERAMIC WALL TILE, INSTALL JM TILE BACKER INSTEAD OF 5/8"		A101

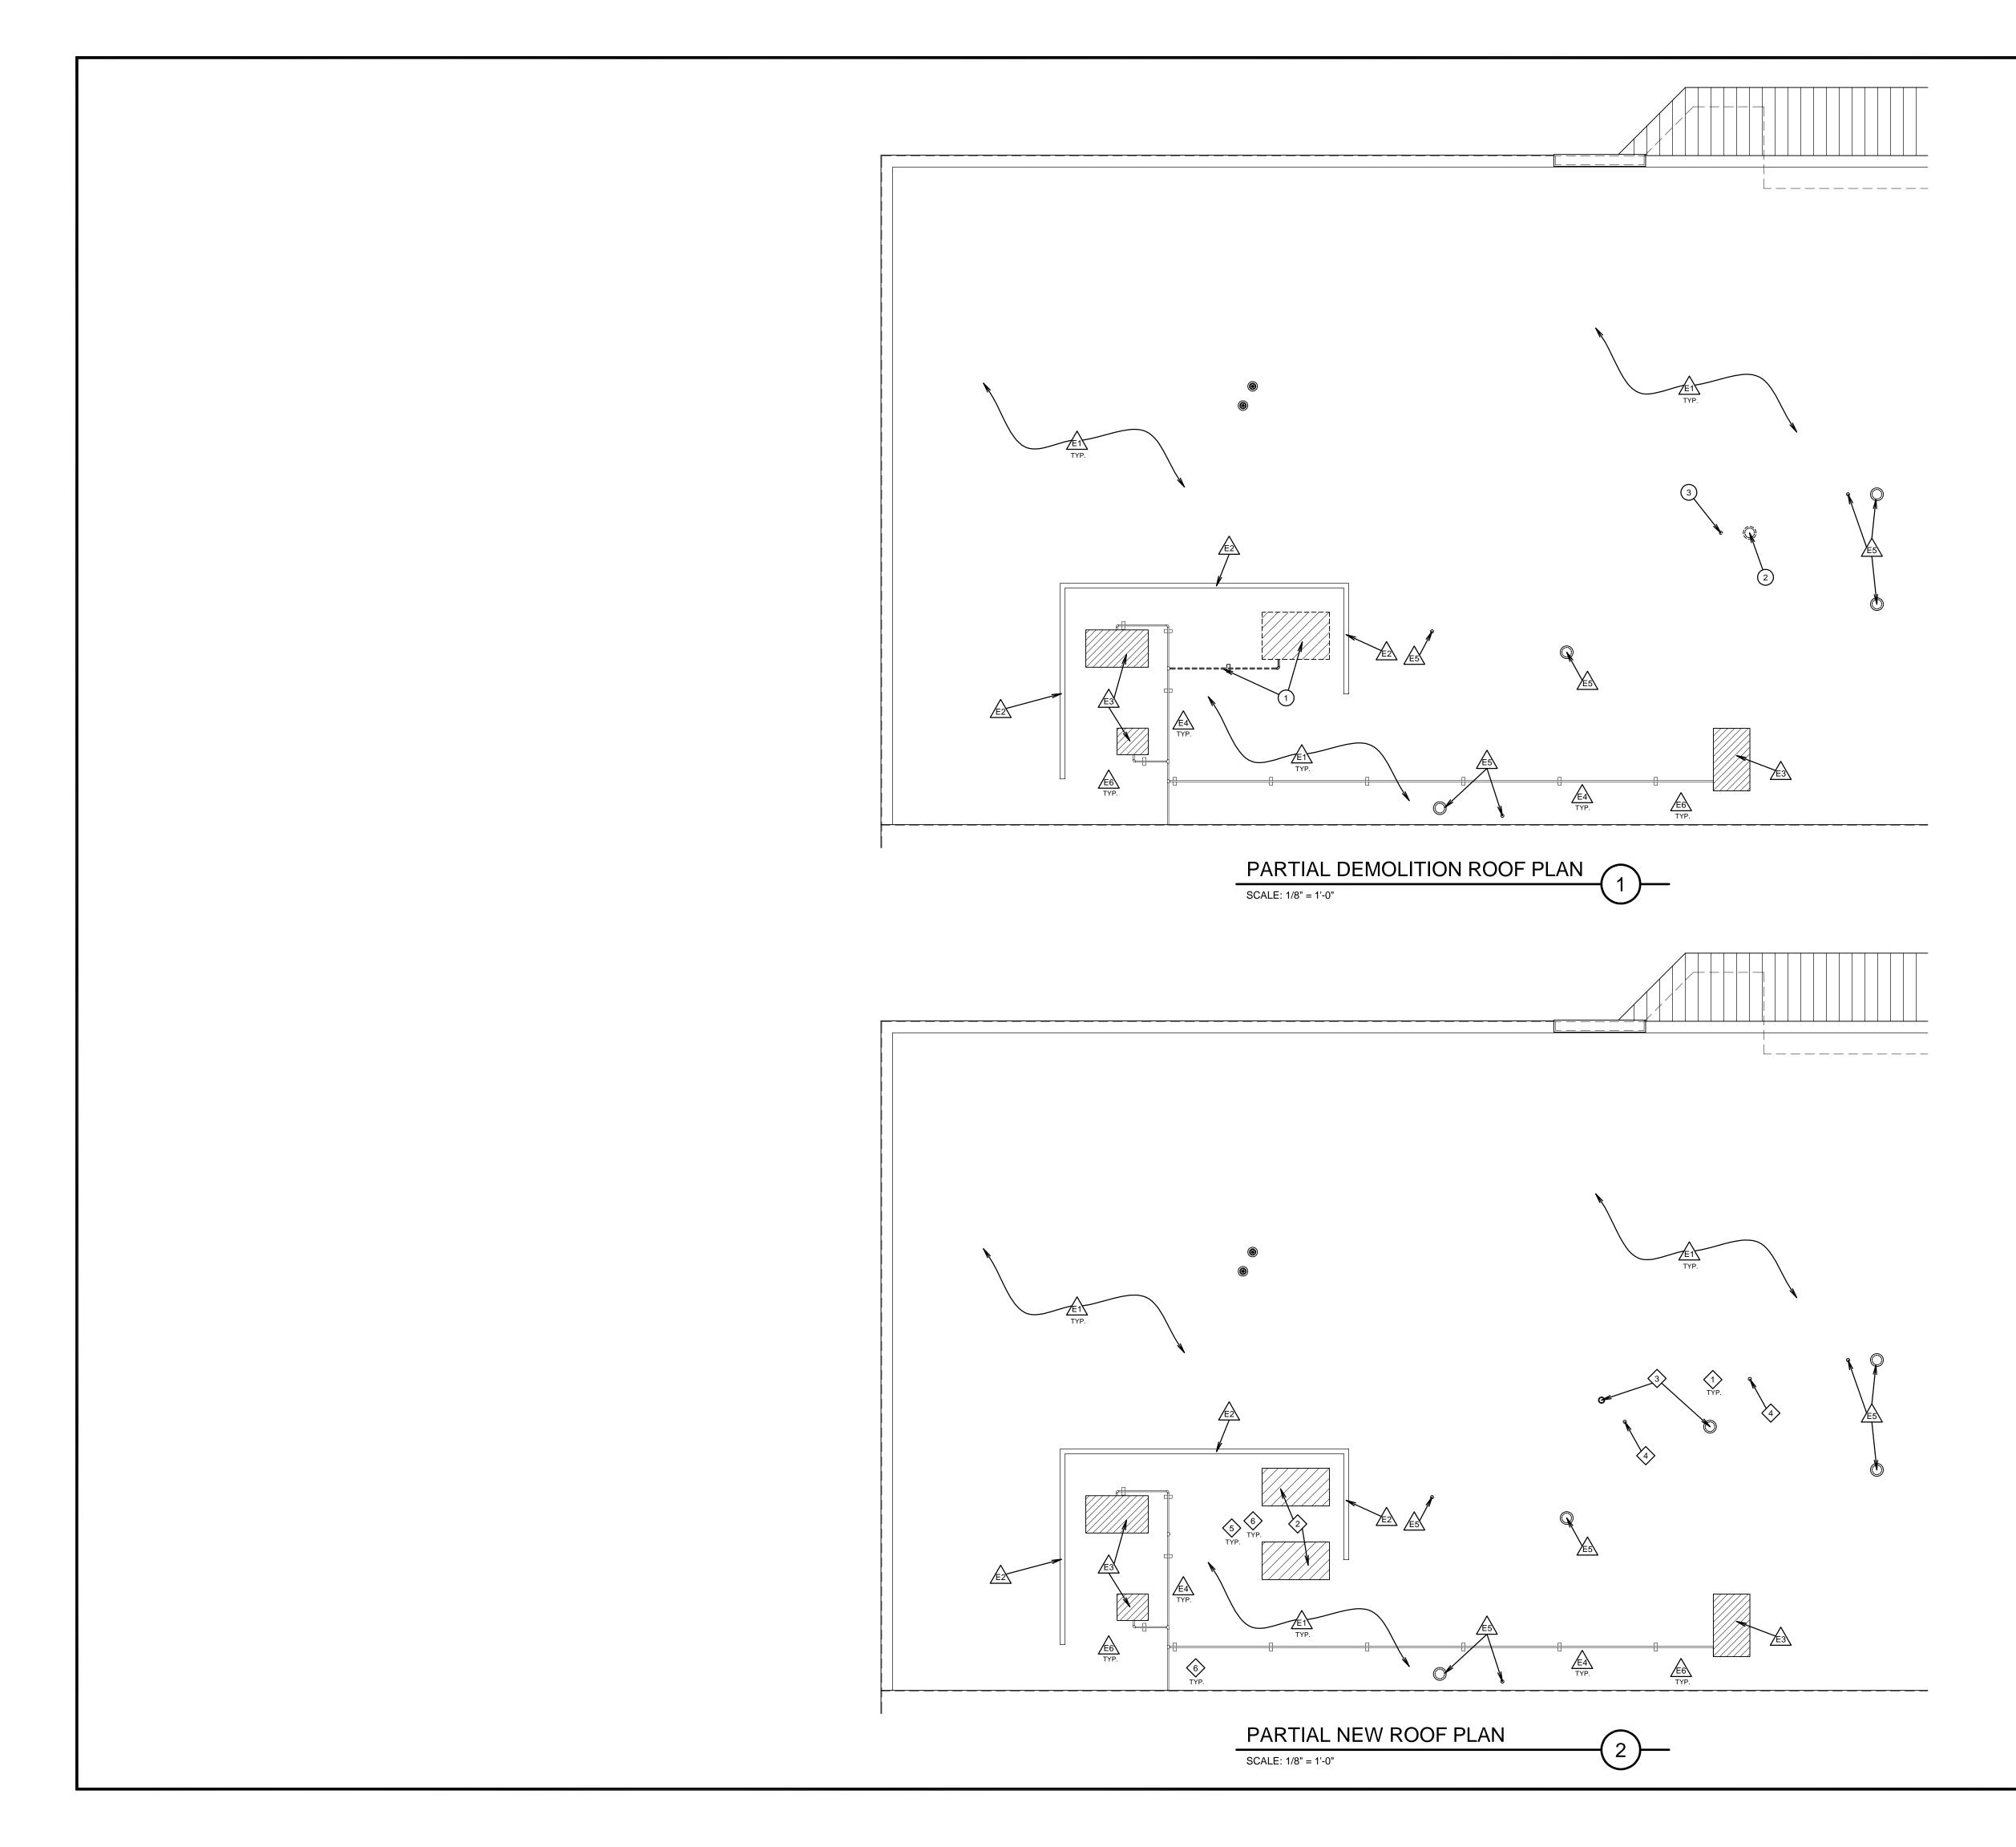


GENERAL ROOFING NOTES	
 HISTORIC FINISHES: PROTECT EXISTING FINISHES WHICH ARE TO REMAIN, WITH PARTICULAR ATTENTION TO HISTORIC FINISHES AT EXTERIOR AREAS, INCLUDING MASONRY VENEER, TERRA COTTA DRIPS, VENEER PANELS, CAPS AND ORNAMENTS AND TILE MOSAIC AT EAST END OF CHAPEL. GENERAL: CONTRACTOR IS RESPONSIBLE TO KEEP AREAS OF ROOFING WORK FREE FROM WATER DAMAGE DURING CONSTRUCTION. ALL ROOF AREAS ARE TO BE SWEPT CLEAN AND KEPT CLEAN DURING DEMOLITION AND INSTALLATION. SEE STRUCTURAL AND OTHER DRAWINGS FOR WORK WHICH OCCURS AT ROOF. REMOVE AND REINSTALL EXISTING WORK ON ROOF AS REQUIRED TO ACCOMMODATE NEW WORK OR ROOFING. PATCH OR REPLACE EXISTING INSULATION IN ATTIC AND CEILING SPACES TO MATCH WHERE DISTURBED OR REMOVED TO ACCOMMODATE STUCTURAL OR OTHER WORK. ALL EXISTING PLUMBING, MECHANICAL, ELECTRICAL WORK, CONDUITS, PIPES, WIRE, DUCTS, ETC. TO REMAIN SHALL BE SECURELY ANCHORED AND FUNCTION MAINTAINED. IF NECESSARY TO ACCOMMODATE NEW WORK, REMOVE AND REINSTALL OR REROUTE EXISTING WORK TO MAINTAIN FUNCTION. REMOVE AND REINSTALL OR REROUTE EXISTING WORK TO MAINTAIN FUNCTION. REMOVE AND REINSTALL OR REROUTE EXISTING WORK TO MAINTAIN FUNCTION. REMOVE ALL EXISTING PIPE AND CONDUIT SUPPORTS. INSTALL NEW SUPPORTS AT ALL NEW AND EXISTING CONDUITS, GAS PIPES AND OTHER WORK REQUIRING SUPPORTS. SEE DETAILS A, B/A125. ROOF DECK: ROOFING. DO NOT PROCEED WITH ANY WORK UNTIL THE PROBLEMS HAVE BEEN CORRECTED. AFTER COMPLETION OF DEMOLITION, SEISMIC, AND STRUCTURAL WORK, SECURE ALL EXISTING STRUCTURE AND DECKING MATERIALS PRIOR TO REROOFING. PENETRATIONS: ALL AREAS OF ROOF, WALLS AND PENETRATIONS THROUGH ROOF OR WALLS ARE TO BE FLASHED, COUNTER FLASH	And the second s
	and the second second second
KEYED ROOF NOTES EXISTING WORK NOTES: EXISTING BUILT UP ASPHALT (BUR) SYSTEM TO REMAIN. PROTECT	ERVICES UT REHOUSE SOUTH TAH
$EXISTING THIS WORK. TYPICAL ALL AREAS. REMOVE ONLY TOMINIMUM EXTENT REQUIRED FOR NEW WORK AND PATCHING.\widehat{E2}EXISTING SCREEN WALL AND SUPPORTS TO REMAIN.\widehat{E3}EXISTING HVAC EQUIPMENT AND CURB TO REMAIN.\widehat{E3}EXISTING GAS PIPING AND SUPPORTS TO REMAIN.\widehat{E4}EXISTING GAS PIPING AND SUPPORTS TO REMAIN (COORDINATEWITH PLUMBING AND MECHANICAL DRAWINGS).\widehat{E5}EXISTING VENT, FLUE OR OTHER PENETRATION TO REMAIN.\widehat{E6}EXISTING ELECTRICAL CONDUIT AND SUPPORTS TO REMAIN.\widehat{E6}EXISTING ELECTRICAL CONDUIT AND SUPPORTS TO REMAIN.\widehat{E1}DEMOLITION WORK NOTES:$	SAT FAMILY SERVICES SANDY UT BISHOP'S STOREHOUSI 615 EAST 8400 SOUTH SANDY, UTAH
 REMOVE EXISTING HVAC EQUIPMENT, INCLUDING CURB, GAS PIPING, ELECTRICAL, ETC. COORDINATE EXTENT OF ANY EXISTING WORK TO REMAIN WITH PLUMBING, MECHANICAL AND ELECTRICAL DRAWINGS. REMOVE EXISTING FLUE AND RELATED WORK. REMOVE EXISTING VENT AND RELATED WORK. REMOVE EXISTING BUILT UP ASPHALT (BUR) ROOFING SYSTEM AS REQUIRED NEW PENETRATIONS AND CURBS. AND WHERE EXISTING PENETRATIONS ARE REMOVED. MATCH EXISTING COVER BOARD, INSULATION, ETC. WHERE DISTURBED. NEW MECHANICAL EQUIPMENT. SEE MECHANICAL DRAWINGS. COORDINATE CURB SIZE WITH ACTUAL EQUIPMENT. SEE B/A122 FOR CURB AND FLASHING DETAILS. STRUCTURAL NOTE: UNITS TO BE PLACED SUCH THAT EACH UNIT IS CARRIED BY (2) EXISTING METAL ROOF JOISTS WITH ONE JOIST SPACE BETWEEN UNITS. NEW FLUE. SEE MECHANICAL DRAWINGS. SEE C/A122 FOR FLASHING. 	PROJECT FOR: THE CHURCH OF JESUS CHRUST OF LATTER-DAY SAINTS
 NEW FLUE. SEE MECHANICAL DRAWINGS. SEE C/A122 FOR FLASHING. NEW VENT. SEE PLUMBING DRAWINGS. SEE D/A122 FOR FLASHING. NEW GAS PIPING. SEE PLUMBING AND MECHANICAL DRAWINGS FOR LOCATIONS. SEE E,F/A122 FOR PIPE SUPPORTS. INSTALL NEW ELECTRICAL AS REQUIRED TO ACCOMMODATE NEW HVAC EQUIPMENT. SEE ELECTRICAL DRAWINGS. SEE G/A122 FOR ROOF PENETRATION FLASHING AND E,F/A122 FOR PIPE SUPPORTS AS REQUIRED. 	PROJECT NUMBER: 5261066-18010106 DATE: 9 APR 2018 PROPERTY NUMBER: 5261066 DRAWN BY: CHECKED: BGG SHEET TITLE: ROOFF PLANS
	SHEET: A121

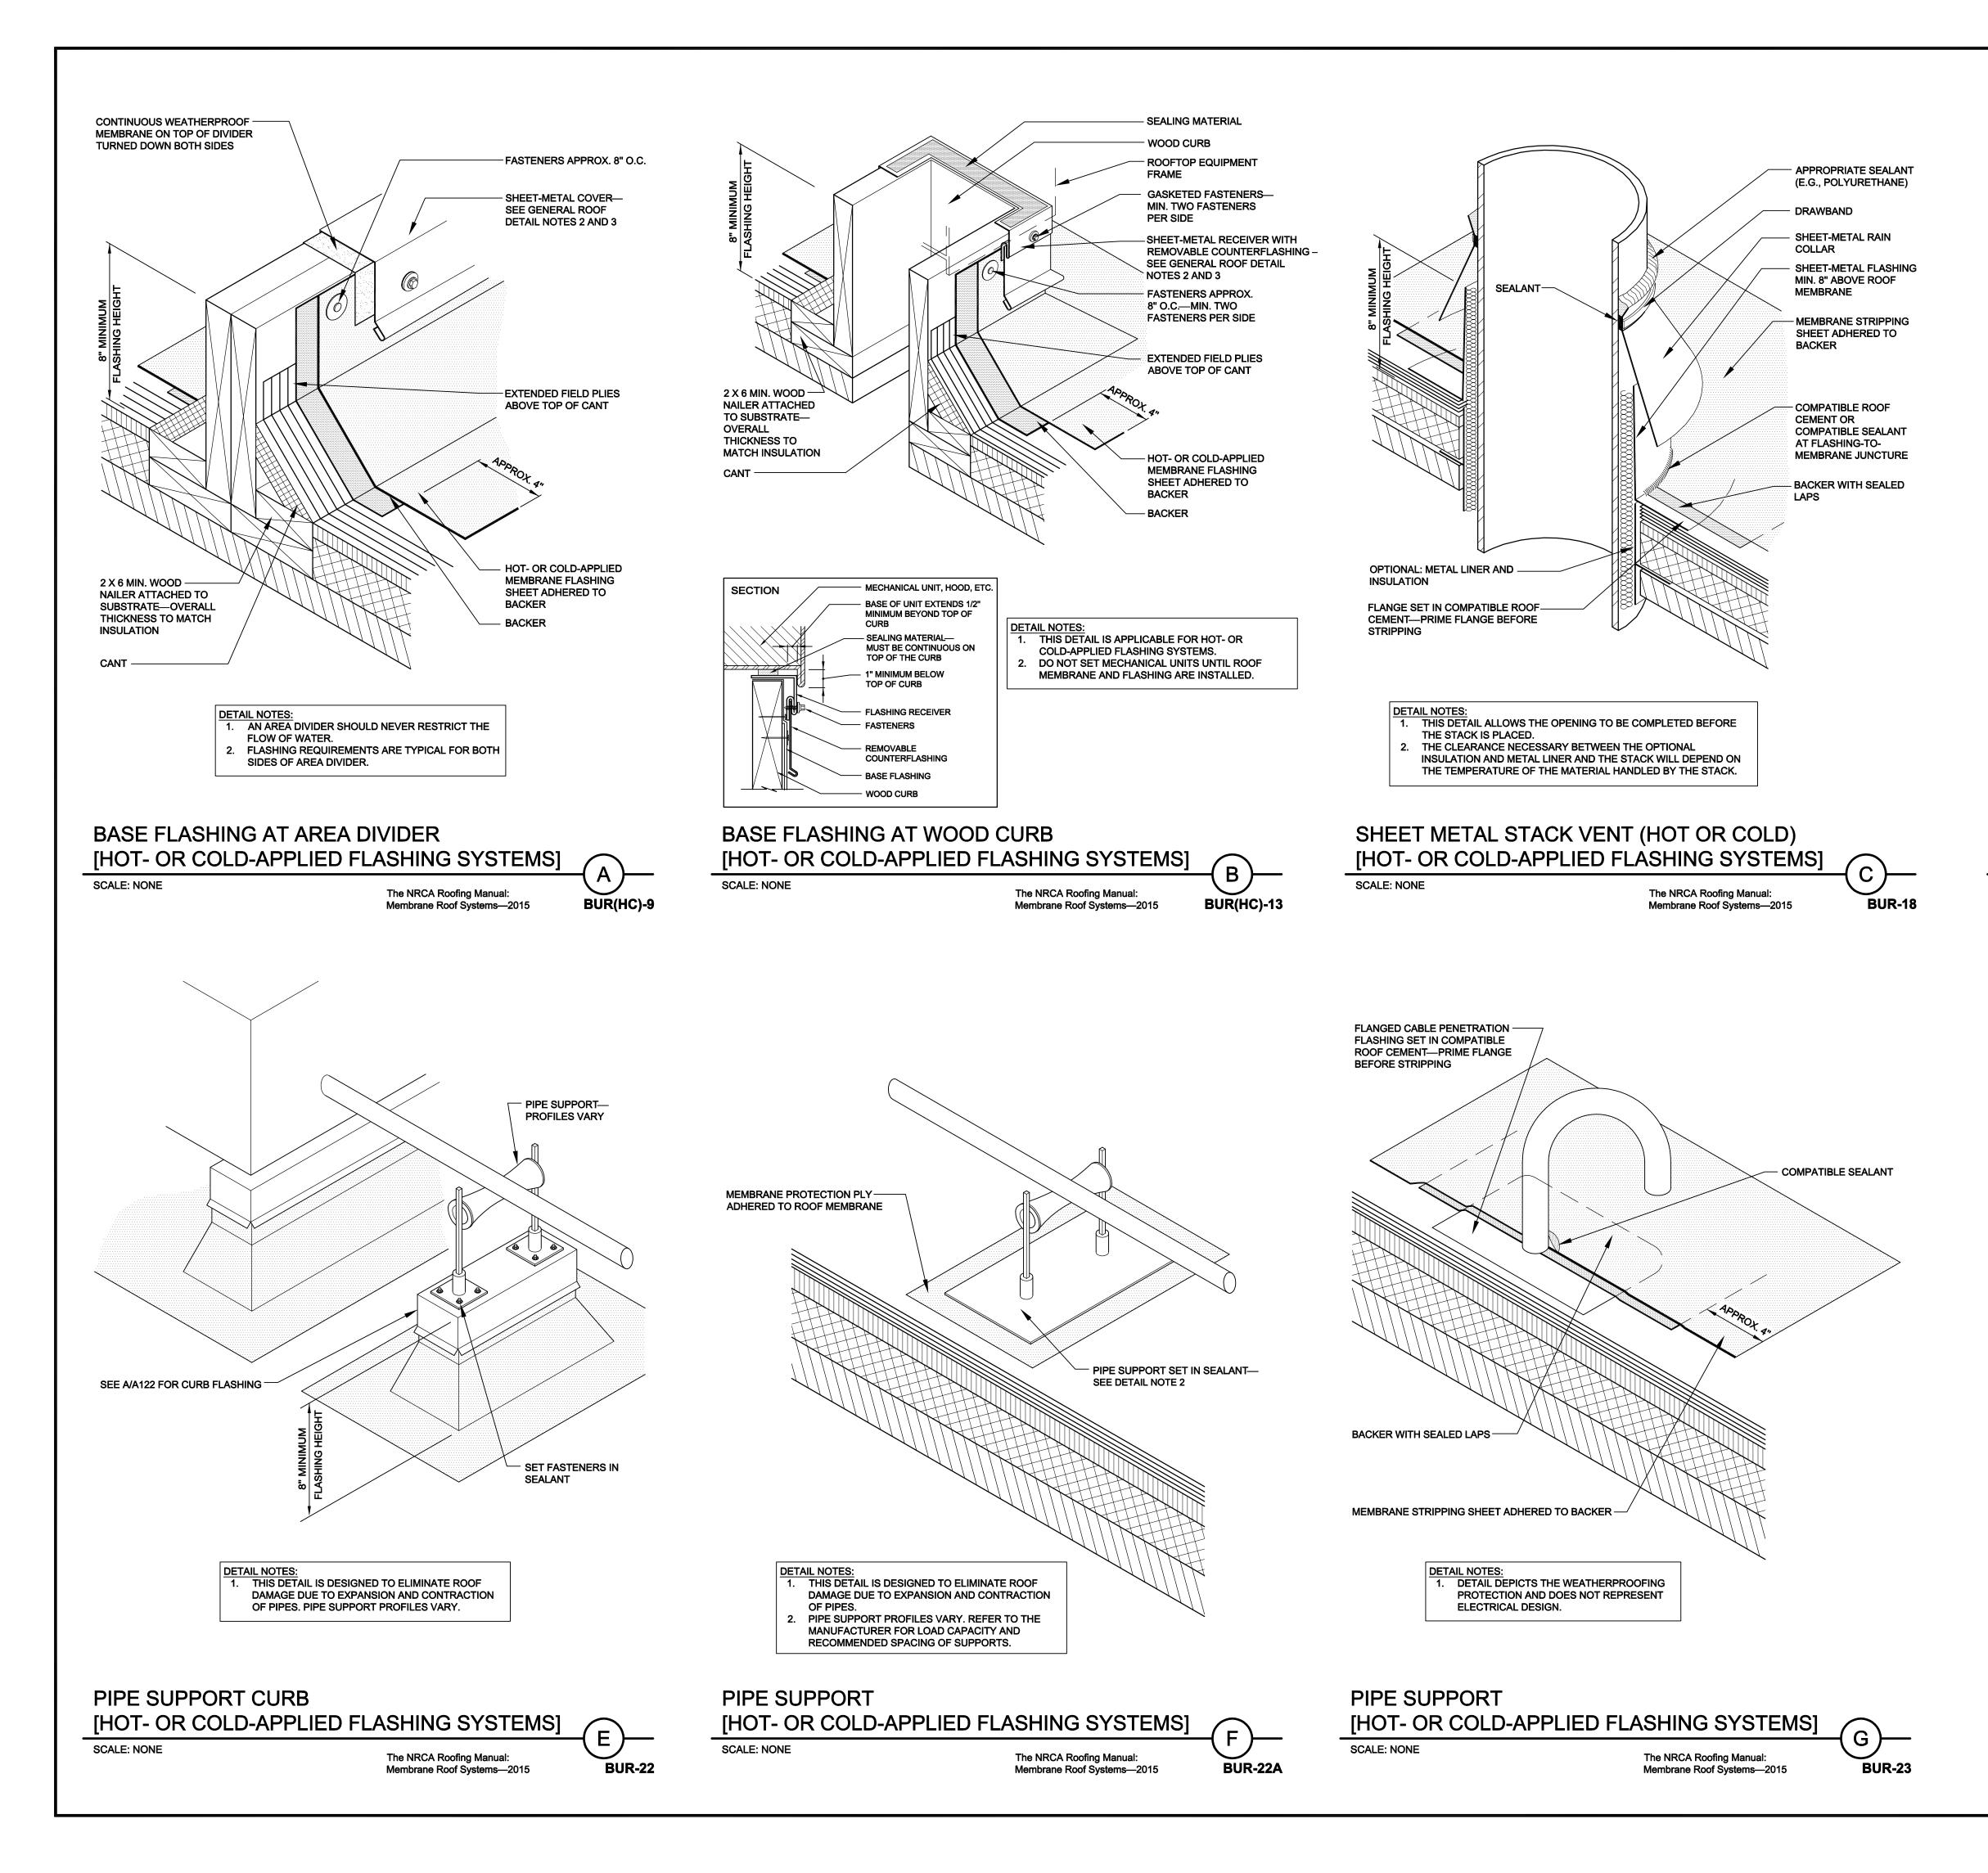

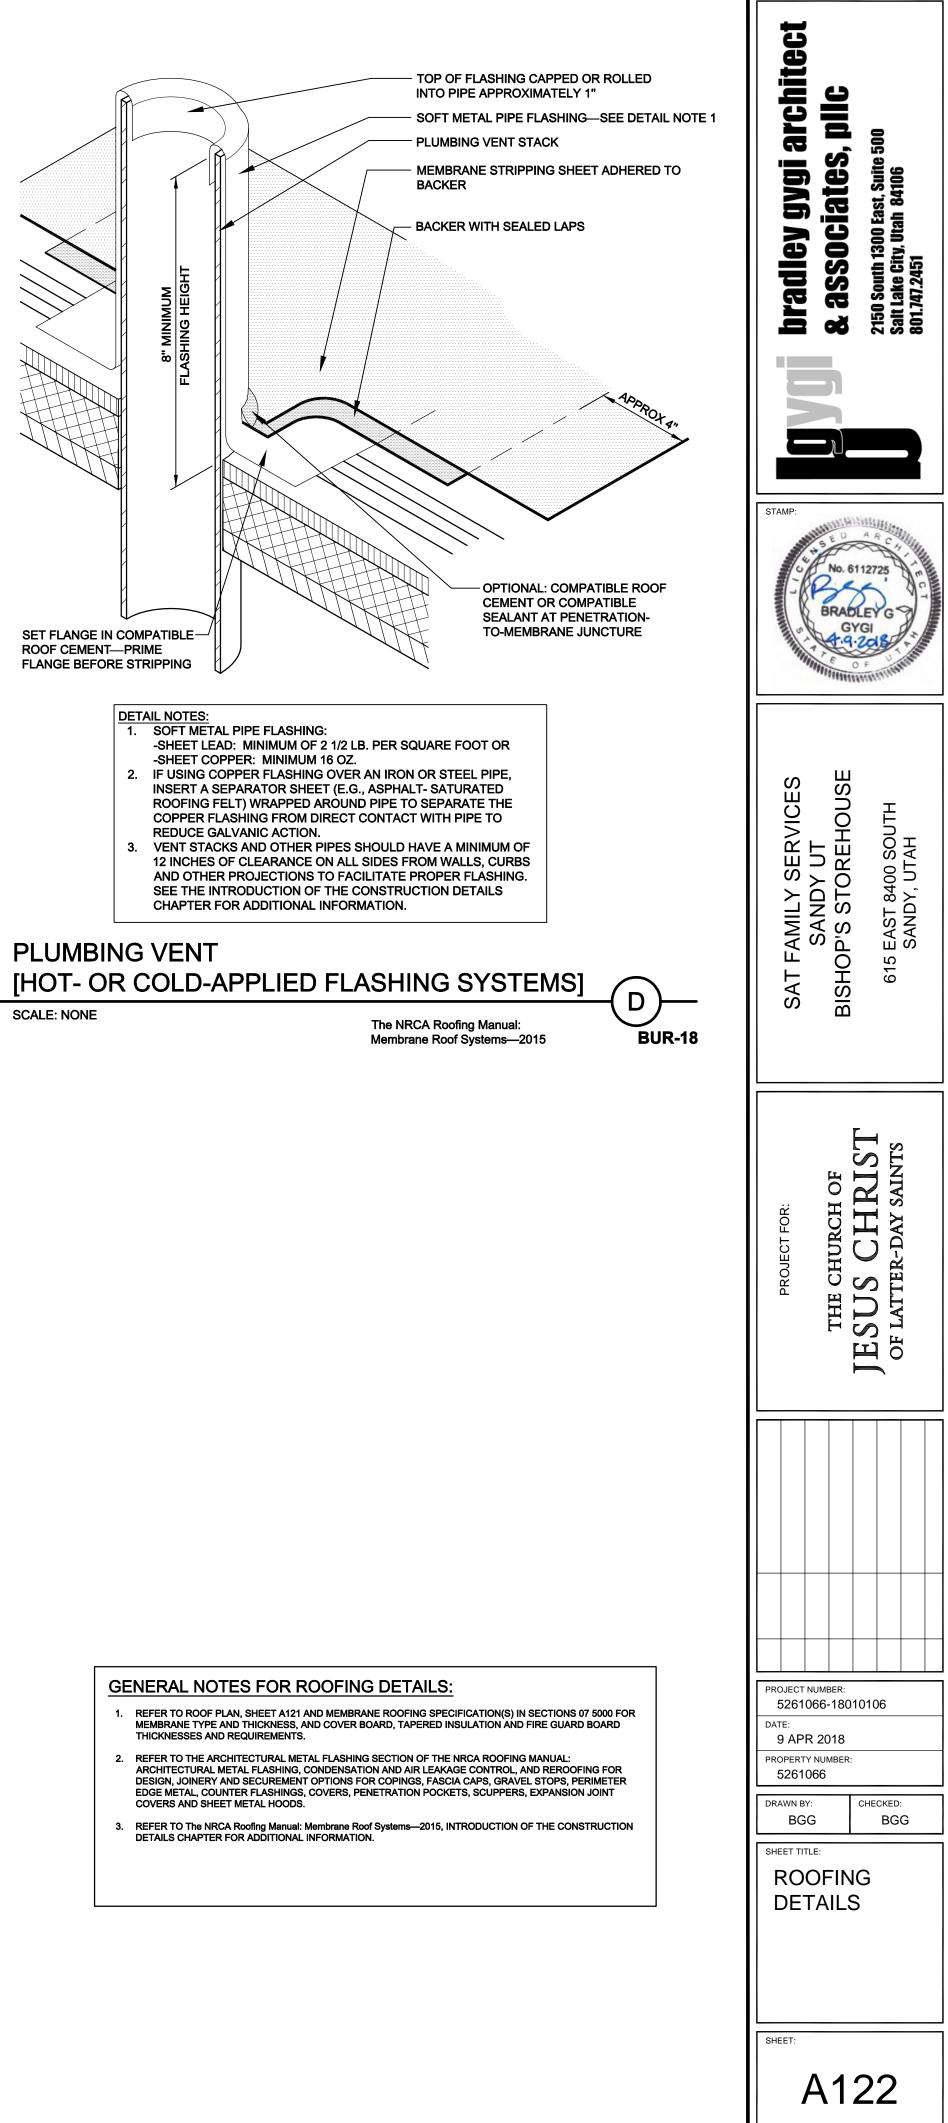

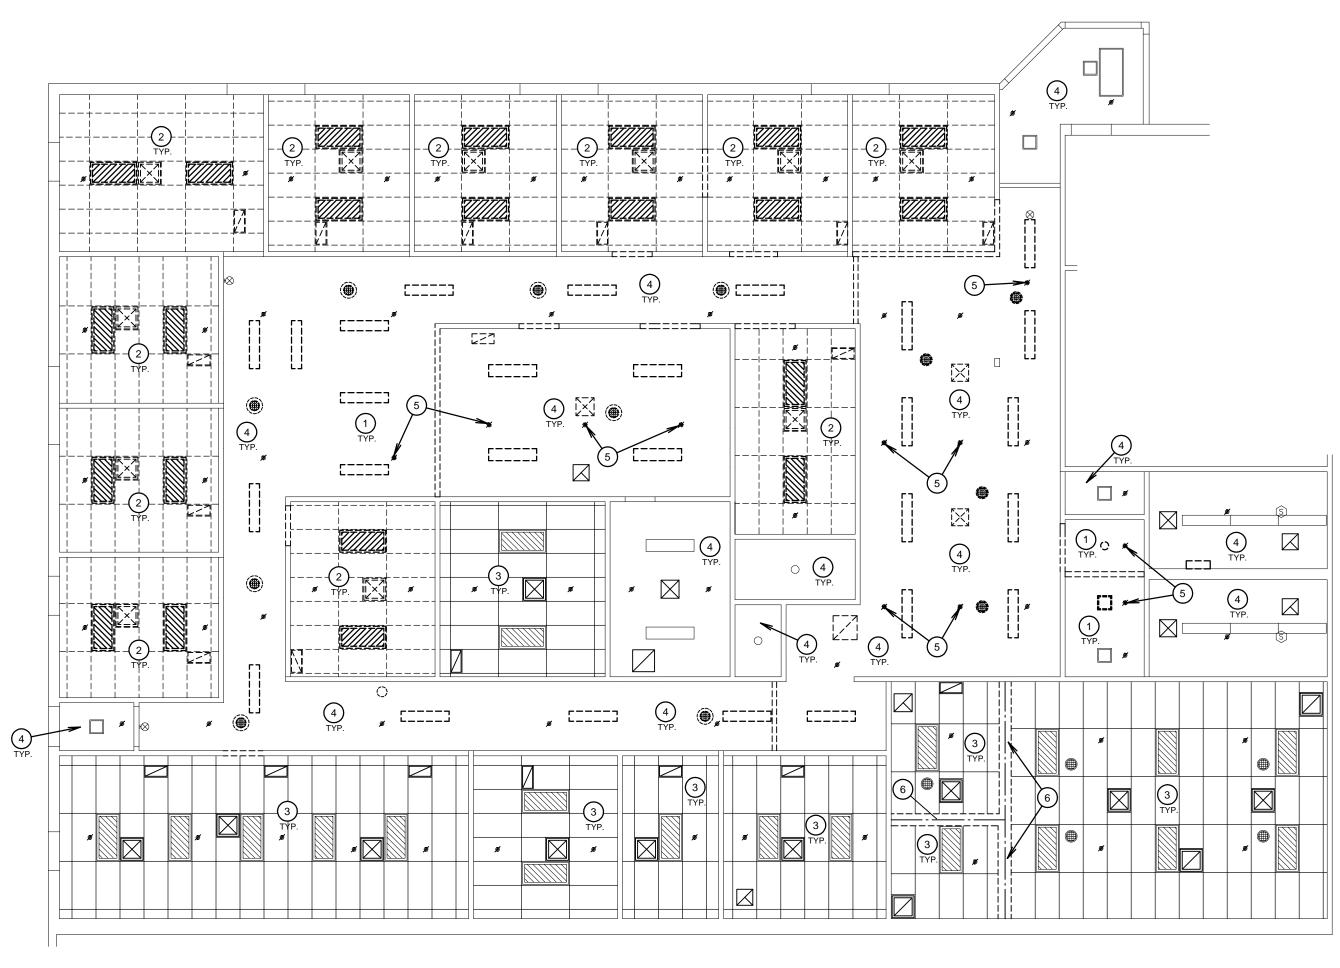

PARTIAL DEMOLITION REFLECTED CEILING PLAN SCALE: 1/8" = 1'-0"

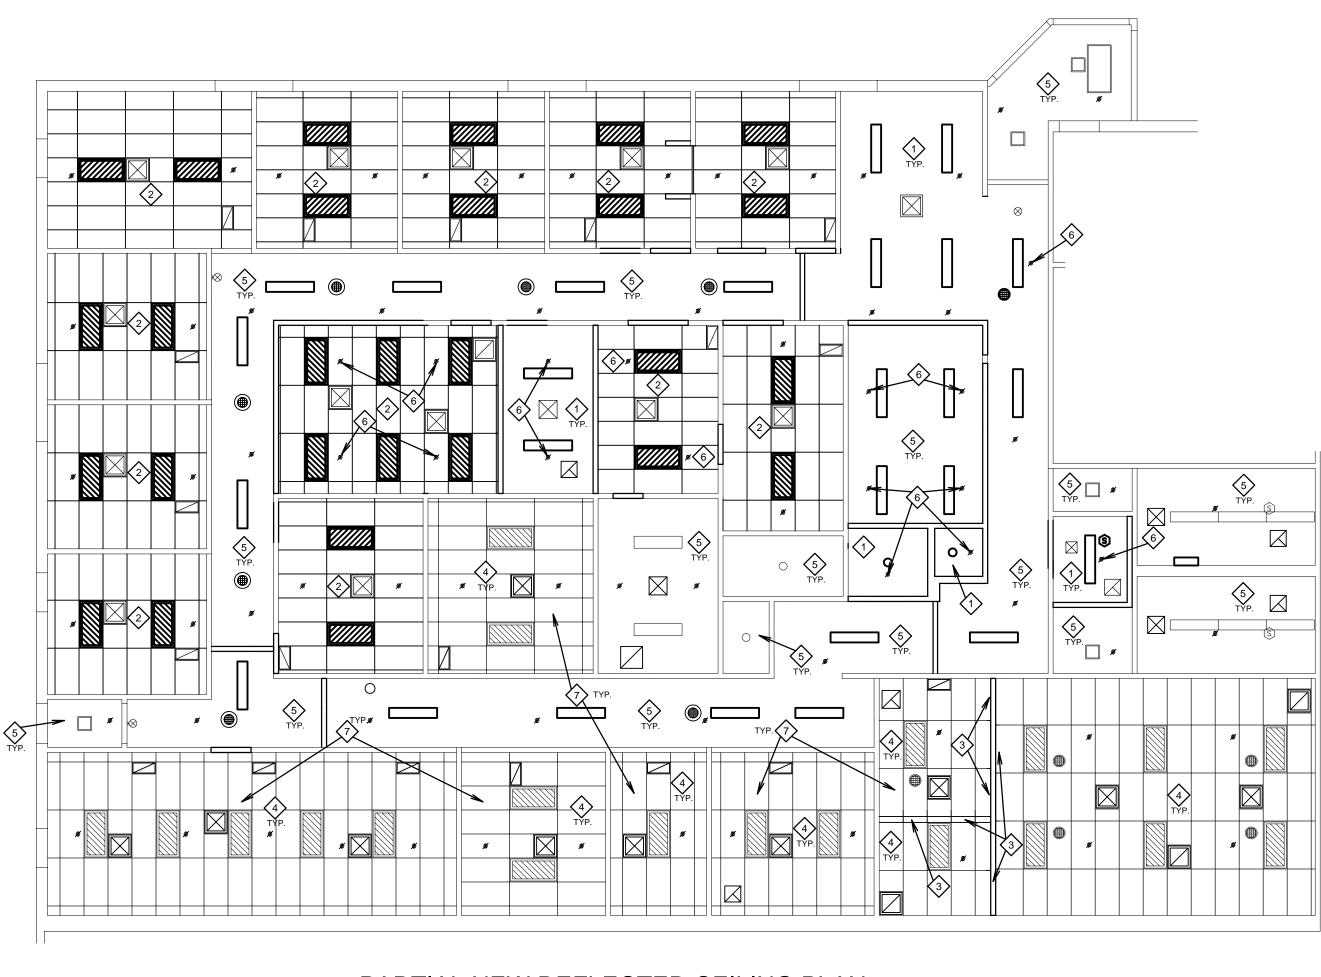

PARTIAL NEW REFLECTED CEILING PLAN

SCALE: 1/8" = 1'-0"





LE LIGHT FIXTURES SMOKE DETECTOR MECHANICAL AIR AUDIO SPEAKERS FOLDING PANEL PARTITIONS CEILING ACCESS DOORS


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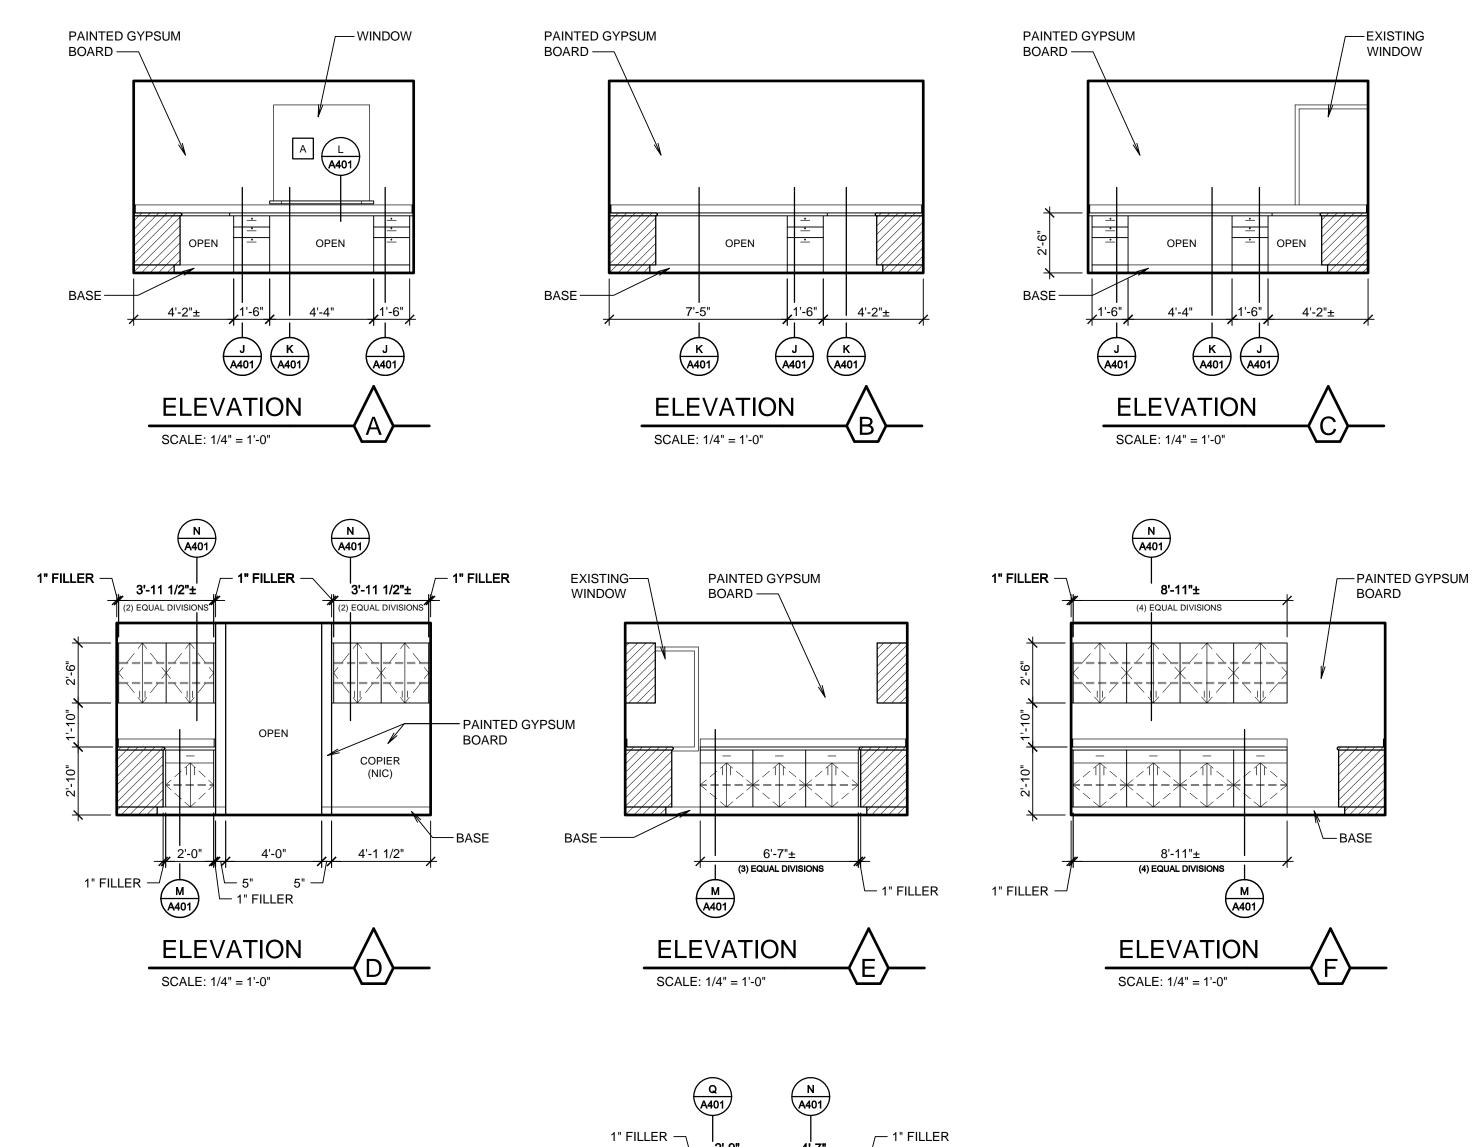
GENERAL CEILING DEMOLITION NOTES	
1. PROTECT EXISTING FINISHES WHICH ARE TO REMAIN.	jet
 REMOVE CEILING MATERIALS, FRAMING, BACKER BOARD, TRIM, EQUIPMENT, OR OTHER ITEMS TO PROVIDE ACCESS TO PERFORM OTHER WORK OR TO ACCOMMODATE NEW WORK. COORDINATE WITH OTHER DRAWINGS AND ALL TRADES. 	Dradley gygi architec & associates, pllc 150 South 1300 East, Suite 500 alt Lake City, Utah 84106 01.747.2451
3. REMOVE FIXTURES, SPEAKERS, GRILLES, LOUVERS, EQUIPMENT, DEVICES AND OTHER WORK AS REQUIRED TO ACCOMMODATE NEW CEILING WORK OR OTHER RELATED NEW WORK AND ACCESS TO ACCOMPLISH NEW WORK.	bradley gygi al & associates, p 2150 South 1300 East, Suite 500 Salt Lake City, Utah 84106 801.747.2451
 SALVAGE AND STORE ITEMS ARE TO BE REUSED AND RE-INSTALLED. REMOVE ALL EXISTING CEILING TILE WHERE SHOWN TO RECEIVE NEW TILE. 	CD CD CD CD CD CD CD CD CD CD CD CD CD CD
SALVAGE FOR RE-USE OR PATCHING AS REQUIRED.	radley associ o south 1300 E 147.2451
 REMOVE CEILING MATERIALS, FRAMING, BACKER BOARD, TRIM, EQUIPMENT, OR OTHER ITEMS TO PROVIDE ACCESS TO PERFORM OTHER WORK OR TO ACCOMMODATE NEW WORK. COORDINATE WITH OTHER DRAWINGS AND ALL TRADES. 	bra 8 3 2150 S salt La 801.74
7. REMOVE DETERIORATED OR DAMAGED BACKER BOARD OR BACKING NOT TO REMAIN BEHIND CEILING TILE.	
8. SEE ELECTRICAL, MECHANICAL AND OTHER DRAWINGS FOR LIGHT FIXTURES, HVAC EQUIPMENT, GRILLES, ETC. TO BE REMOVED.	
KEYED CEILING DEMOLITION NOTES	0 A R C 11
(1) REMOVE EXISTING GYPSUM BOARD, SUSPENSION SYSTEM, FURRING	BRADLEYG
 AND OTHER ASSOCIATED WORK. (2) REMOVE EXISTING SUSPENDED CEILING GRID, LAY-IN TILE AND 	GYGI 4-9-208
RELATED WORK. SEE MECHANICAL, ELECTRICAL AND AV DRAWINGS FOR NOTES REGARDING WORK MOUNTED IN EXISTING CEILINGS. NOTE THAT OFFICES HAVE EXISTING ACOUSTICAL BATT INSULATION ABOVE WHICH IS TO REMAIN OR BE SALVAGED AND REINSTALLED.	Minister Contraction of the Cont
(3) EXISTING 24"x48" SUSPENDED SYSTEM WITH LAY-IN ACOUSTICAL CEILING TILE TO REMAIN.	
4 EXISTING PAINTED GYPSUM BOARD TO REMAIN.	ERVICES UT REHOUSE SOUTH TAH
(5) EXISTING FIRE SPRINKLER HEAD TO BE REMOVED TO ACCOMMODATE NEW LAYOUT.	ERVI UT REHC SOUT
6 REMOVE EXISTING FOLDING PARTITION HEADER TRACK. SUPPORT EXISTING SUSPENDED CEILING GRID.	SAT FAMILY SERVIC SANDY UT BISHOP'S STOREHOL 615 EAST 8400 SOUTH SANDY, UTAH
GENERAL CEILING NOTES	
EXISTING WORK:	r ,
 VERIFY LOCATION OF ALL EXISTING PIPING, WIRING, DUCT WORK AND OTHER EXISTING WORK IN EXISTING FRAMING AND ATTIC SPACES AND COORDINATE WITH NEW WORK. FILL HOLES AND PATCH CEILING WHERE EXISTING LIGHT FIXTURES, GRILLES, DIFFUSERS, FURRING OR OTHER WORK IS REMOVED OR WHERE NEW WORK DOES NOT COVER EXISTING OPENINGS COMPLETELY. REMOVE AND REINSTALL EXISTING LIGHT FIXTURES, GRILLES, DIFFUSERS, SPEAKERS AND OTHER EXISTING WORK AS REQUIRED TO ACCOMMODATE NEW WORK. 	project for: Church of S CHRIST Ter-day saints
 <u>ALL AREAS:</u> 1. SEE ELECTRICAL, MECHANICAL AND OTHER DRAWINGS FOR LIGHT FIXTURES, HVAC EQUIPMENT, FIRE SPRINKLING, GRILLES, ETC. TO BE REMOVED AND REINSTALLED OR REPLACED WITH NEW. 2. BLOCK ALL NEW UNSUPPORTED GYPSUM BOARD PANEL EDGES WITH 2x4 FLAT AND METAL "Z" CLIPS EACH END (BENT CLIP AS REQUIRED) AT WOOD TRUSS FRAMING. 	PRO THE C JESUS OF LATTE
 NEW SUSPENDED ACOUSTICAL PANEL CEILINGS: BLOCK ALL NEW UNSUPPORTED GYPSUM BOARD PANEL EDGES WITH 2x4 FLAT AND METAL "Z" CLIPS EACH END (BENT CLIP AS REQUIRED) AT WOOD TRUSS FRAMING. AT SUSPENDED CEILINGS, PROVIDE SEISMIC BRACING AS REQUIRED BY BUILDING CODE. SEE DETAILS A,B,C,D/A152. APPLIES TO AREAS LARGER THAN 1,200 SQUARE FEET. FOR MOUNTING OF SPEAKERS IN CORRIDOR CEILINGS, SEE F/A152. FOR MOUNTING OF RECESSED LIGHT FIXTURES IN CORRIDORS, SEE E,F/A152. 	
 FOR EXPANSION JOINTS, SEE G/A152. <u>NEW SUSPENDED GYPSUM BOARD</u> <u>& ACOUSTICAL TILE CEILINGS</u>: AT SUSPENDED CEILINGS, PROVIDE SEISMIC BRACING AS REQUIRED BY BUILDING CODE. SEE DETAILS H, J, K/A152. APPLIES TO AREAS LARGER THAN 1,200 SQUARE FEET. FOR MOUNTING OF SPEAKERS AND LIGHT FIXTURES IN CEILINGS, SEE L/A152. 	PROJECT NUMBER: 5261066-18010106
KEYED CEILING NOTES	DATE: 9 APR 2018
CEILING SUSPENSION SYSTEM WITH 5/8" GYPSUM BOARD. TEXTURE	PROPERTY NUMBER: 5261066
24" x 48" SUSPENDED SYSTEM WITH LAY-IN ACOUSTICAL CEILING	DRAWN BY: CHECKED: BGG BGG
 TILE. 24" x 48" SUSPENDED SYSTEM WITH LAY-IN ACOUSTICAL CEILING TILE. TIE INTO EXISTING GRID SYSTEM. REPLACE SMALLER TILES WITH SALVAGED EXISTING TILE FROM ROOMS WHERE EXISTING TILE AND GRID ARE REPLACED. 	SHEET TITLE: REFLECTED CEILING PLANS
EXISTING 24" x 48" SUSPENDED SYSTEM WITH LAY-IN ACOUSTICAL CEILING TILE TO REMAIN.	
 EXISTING PAINTED GYPSUM BOARD TO REMAIN. PATCH TO MATCH WHERE DISTURBED BY NEW WORK AND WHERE EXISTING WORK IS REMOVED. PAINT. 	
NEW FIRE SPRINKLER HEAD IN NEW LOCATION. TIE IN TO EXISTING SYSTEM.	SHEET:
REMOVE AND REINSTALL EXISTING LAY-IN CEILING TILE AND GRID AS REQUIRED TO ACCOMMODATE HVAC WORK AT THIS AREA - TYPICAL.	A151


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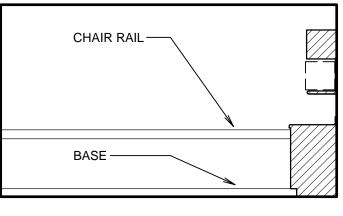





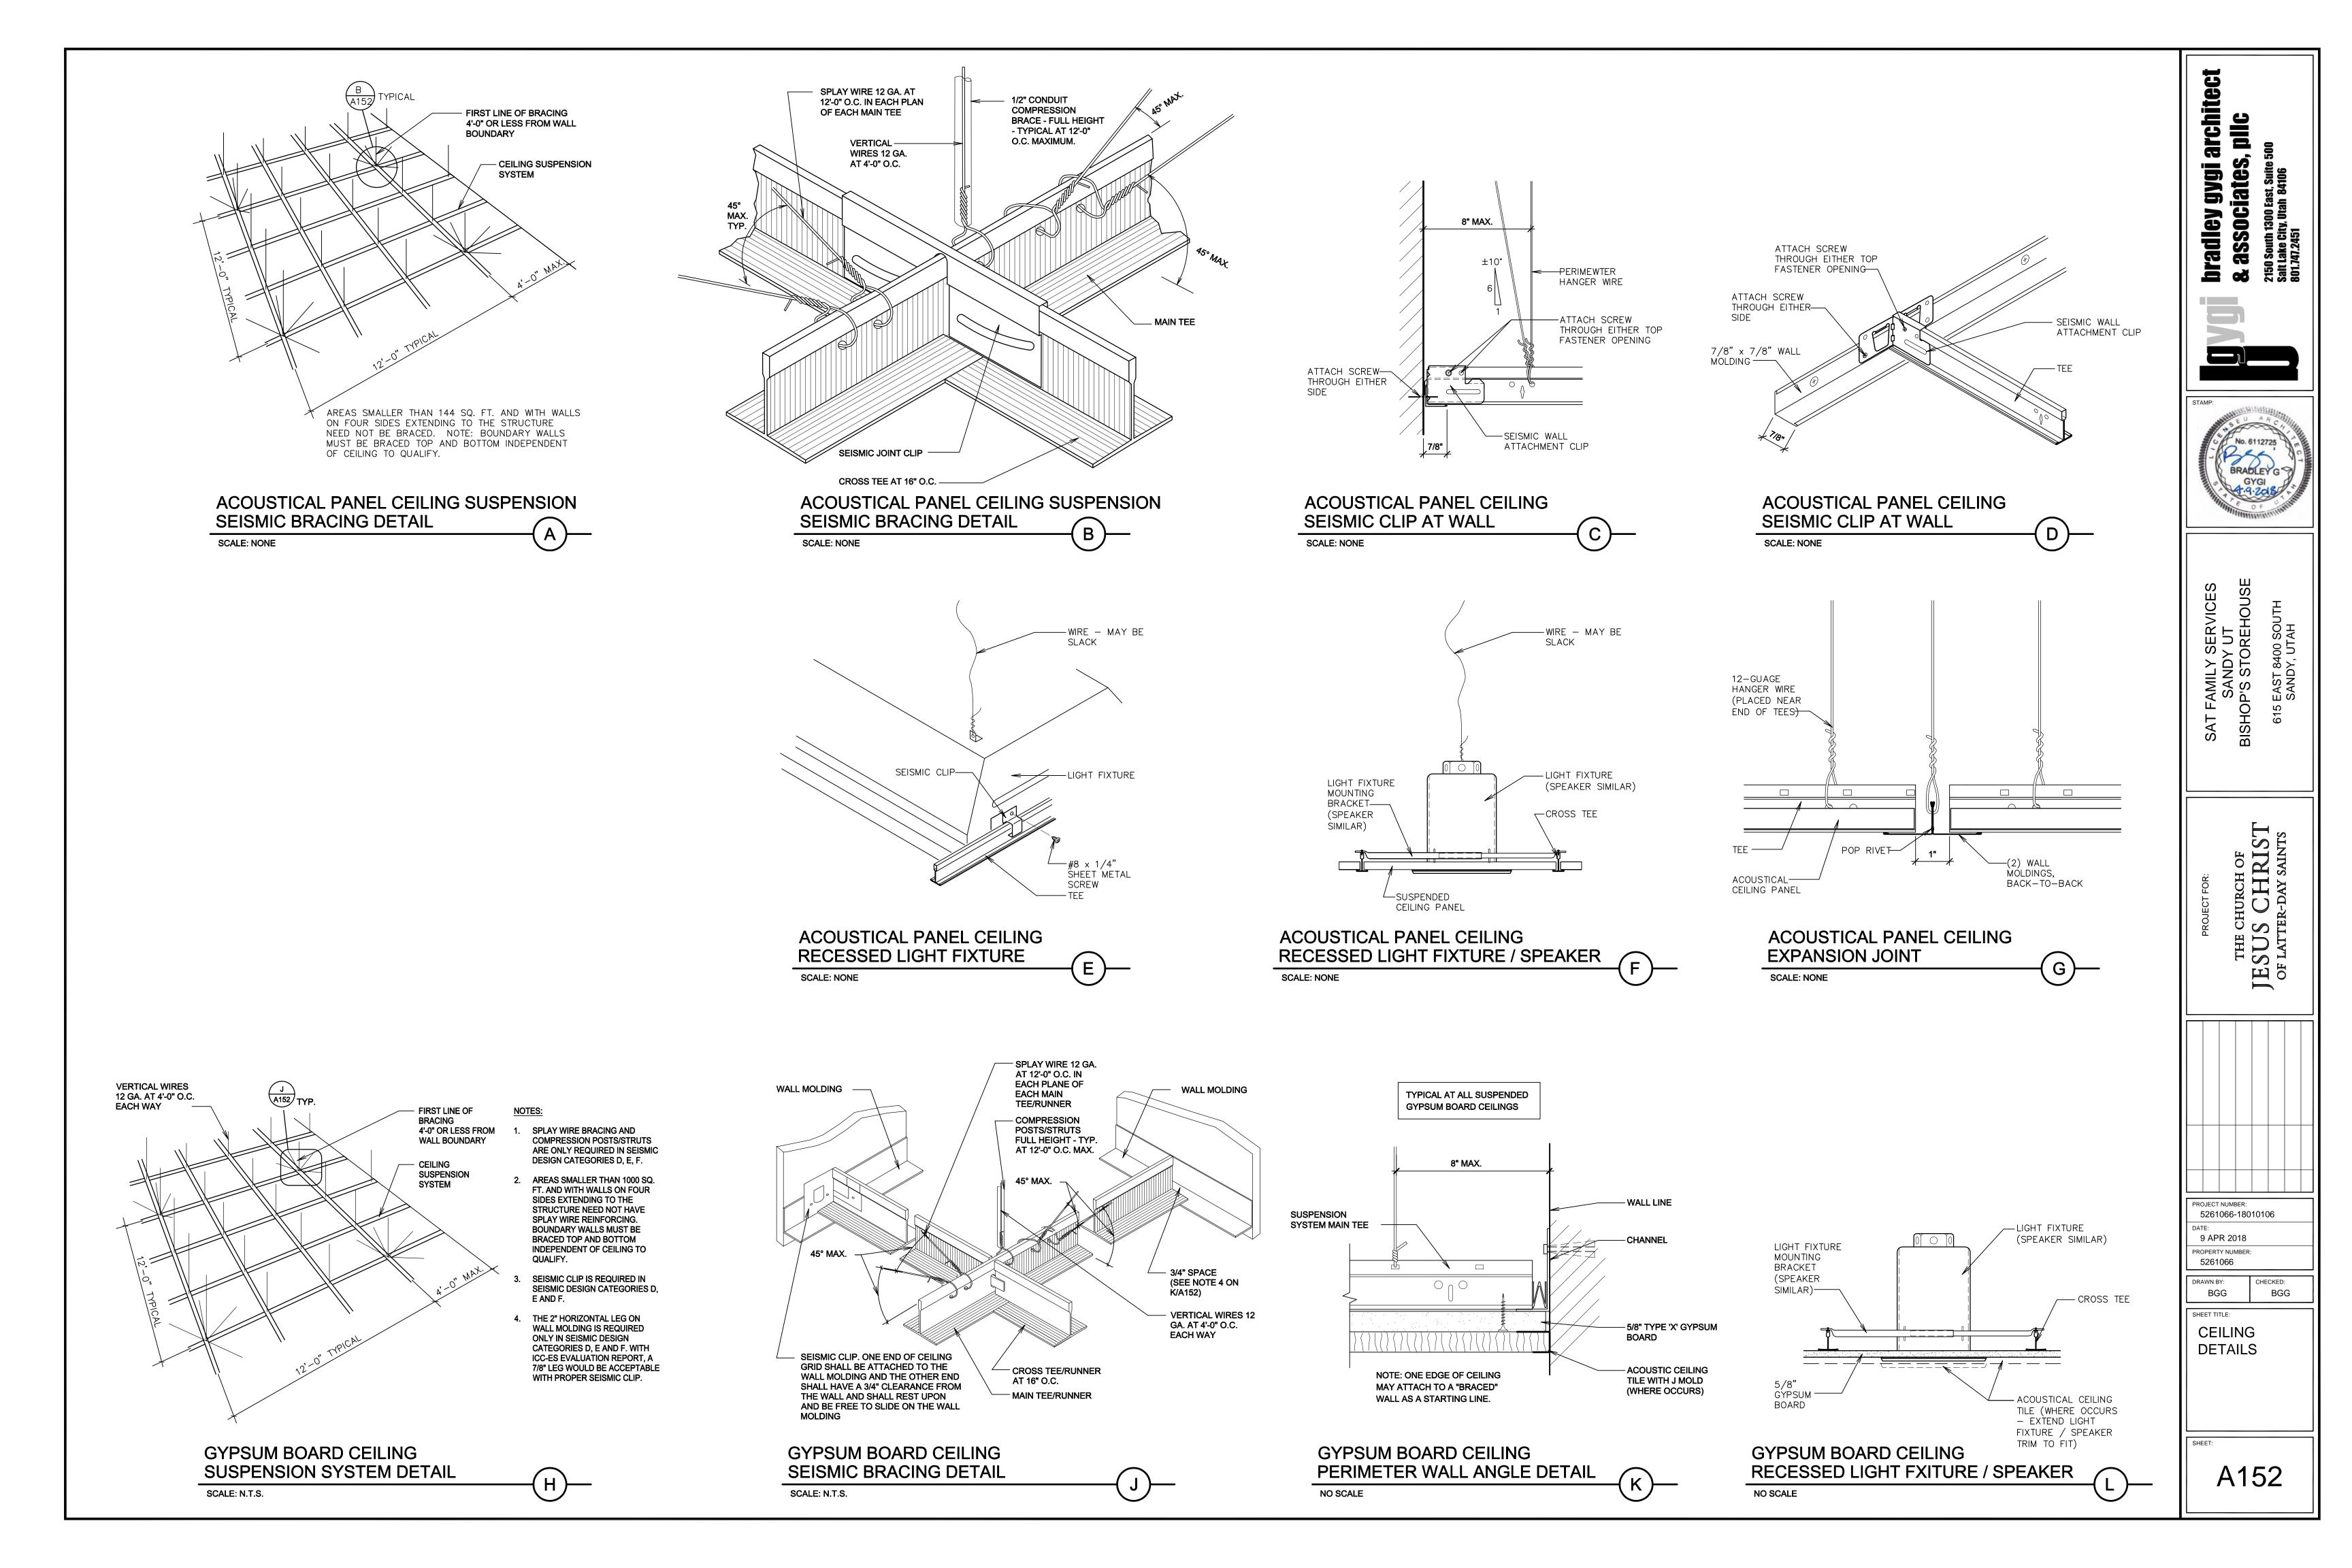


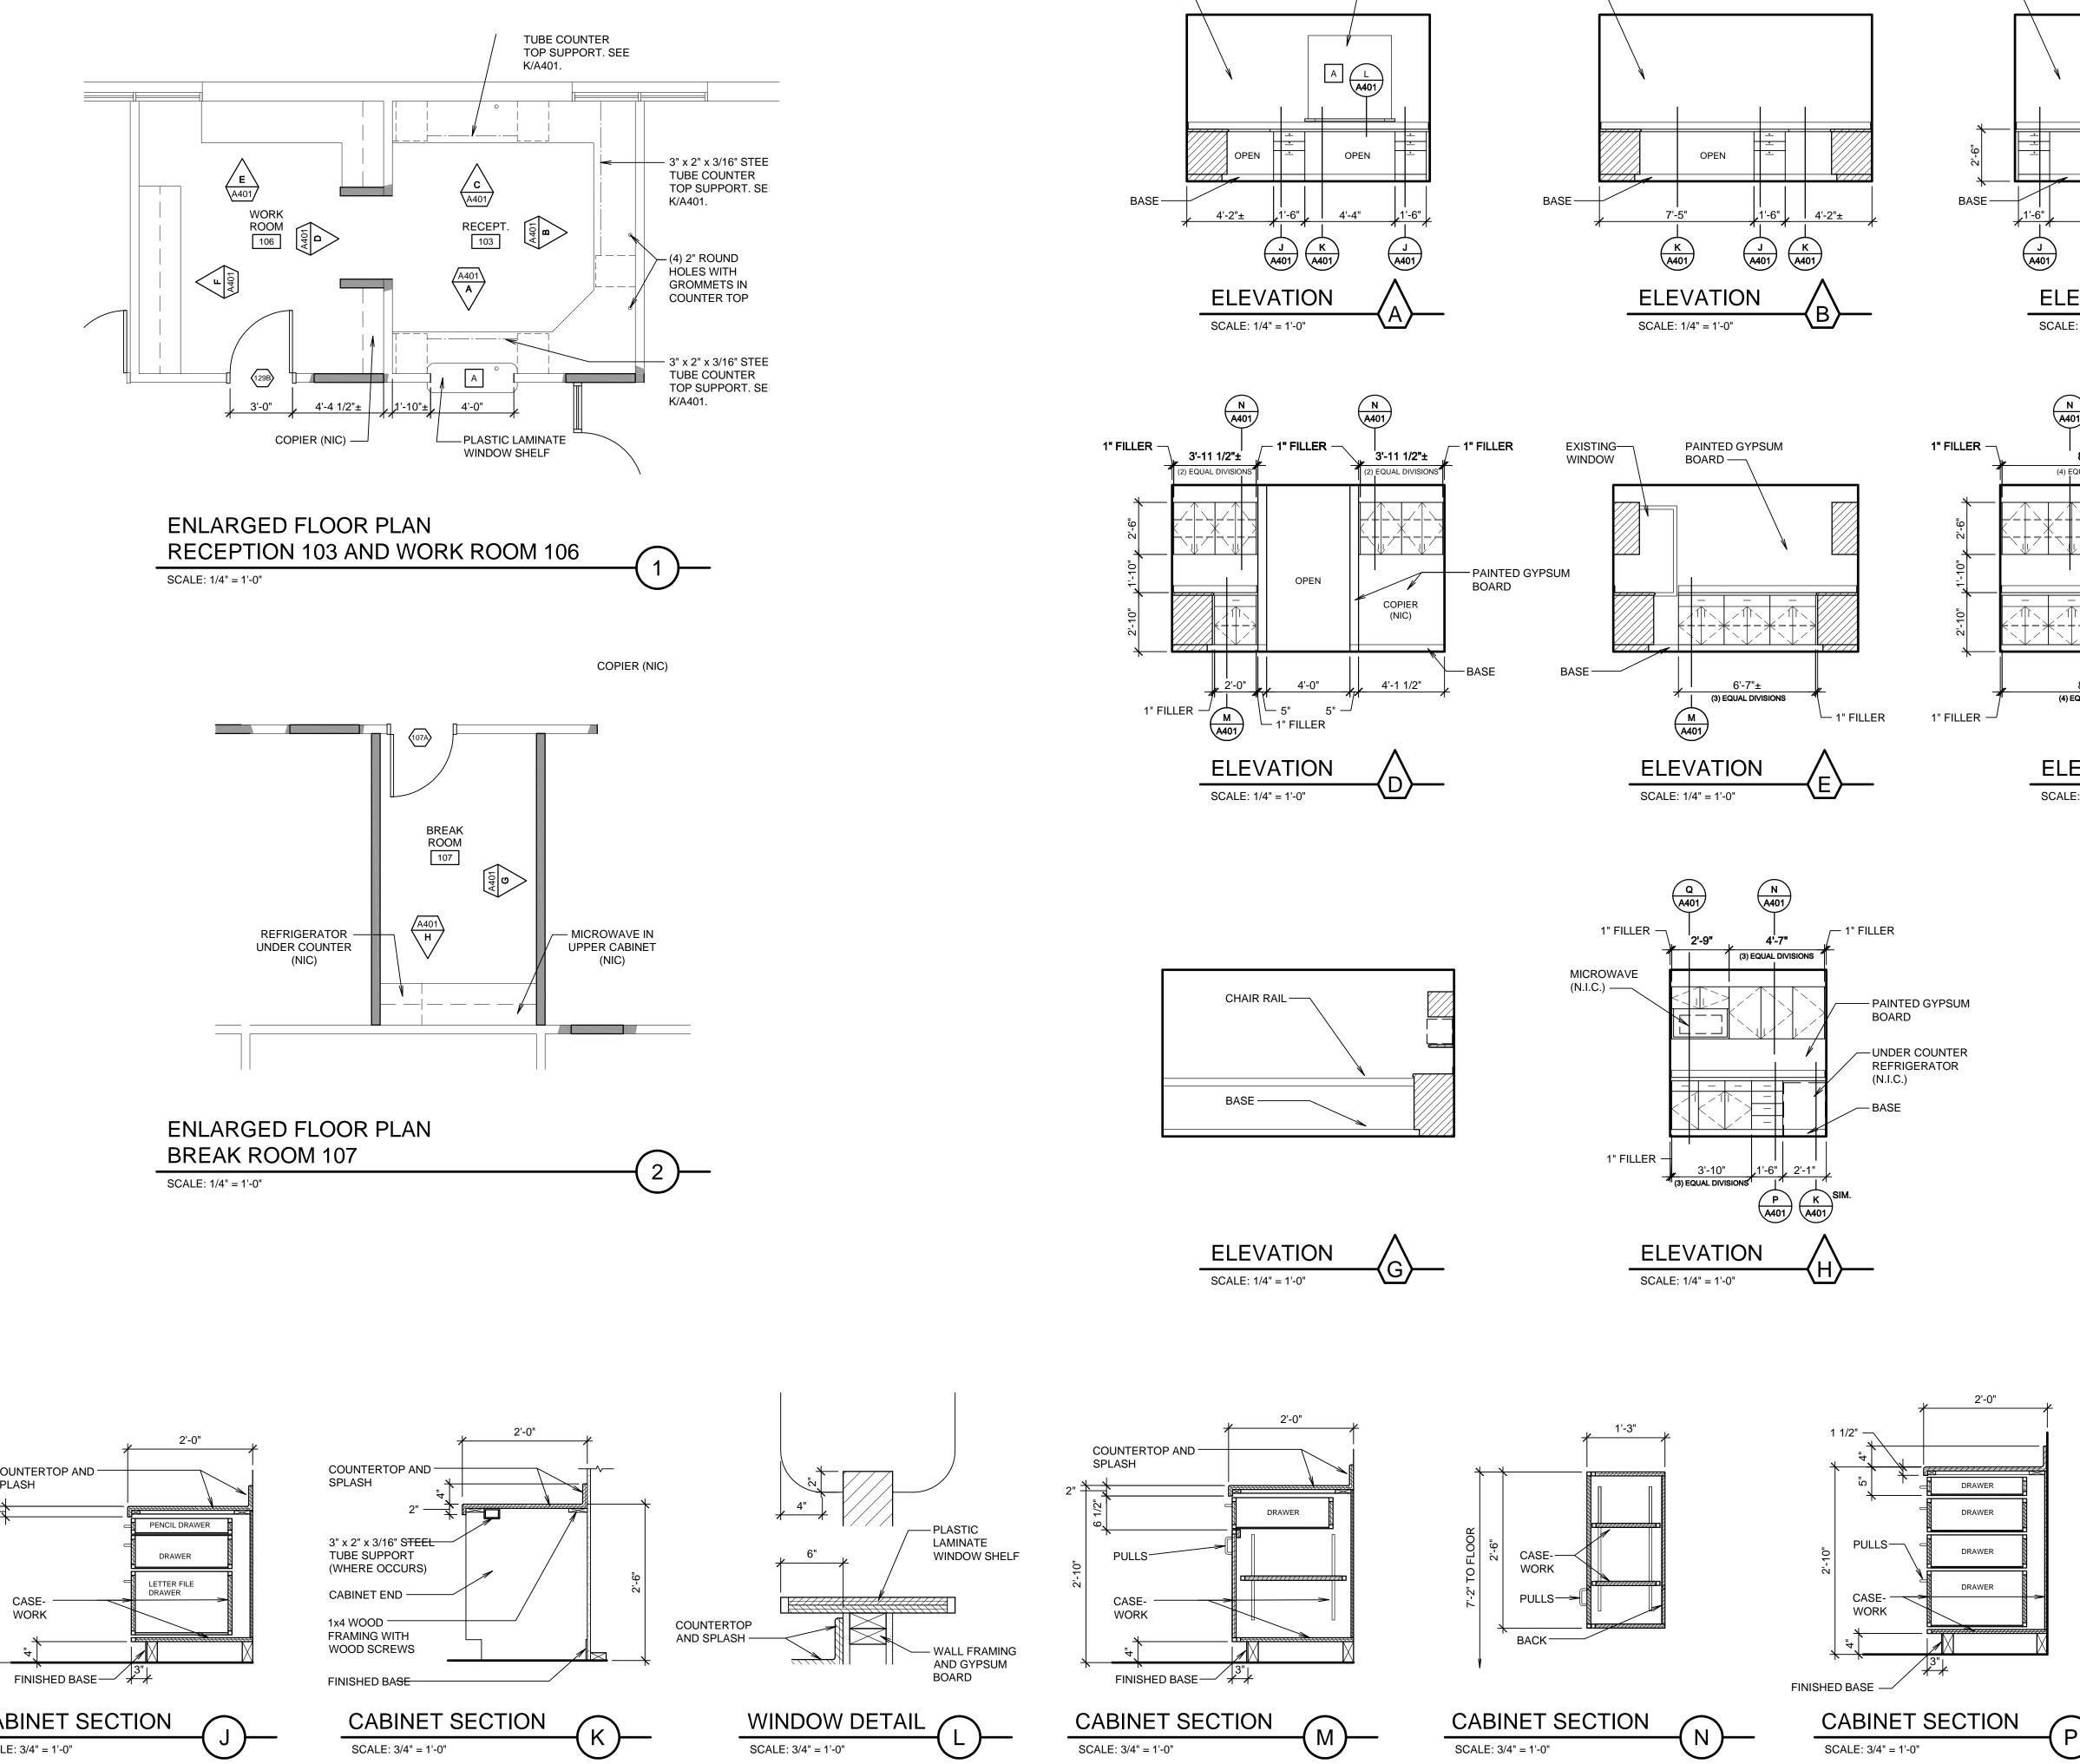


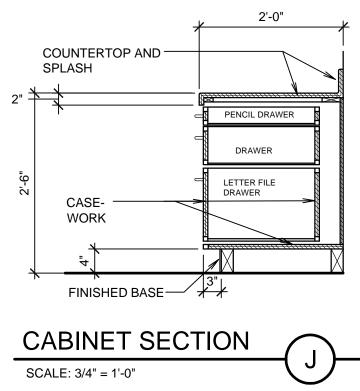


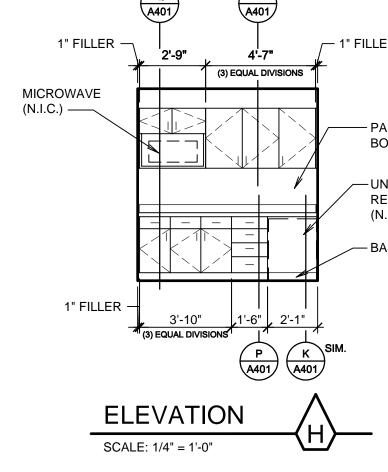


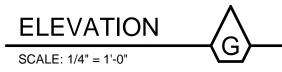


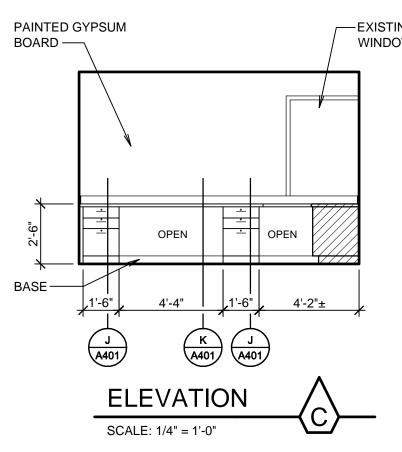


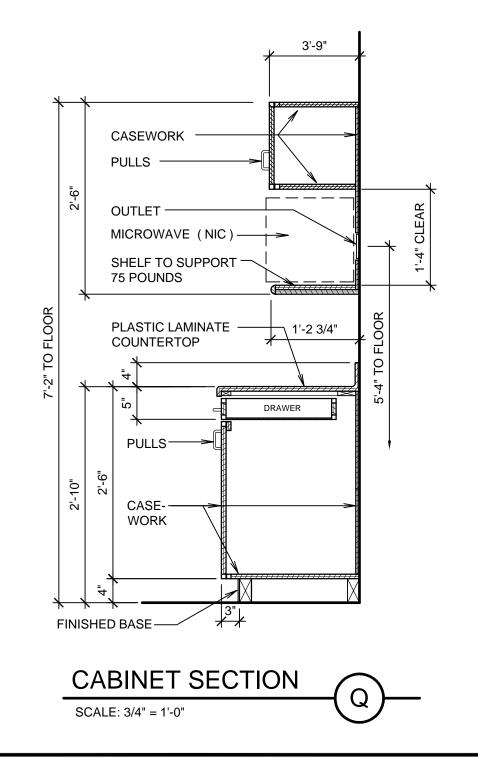


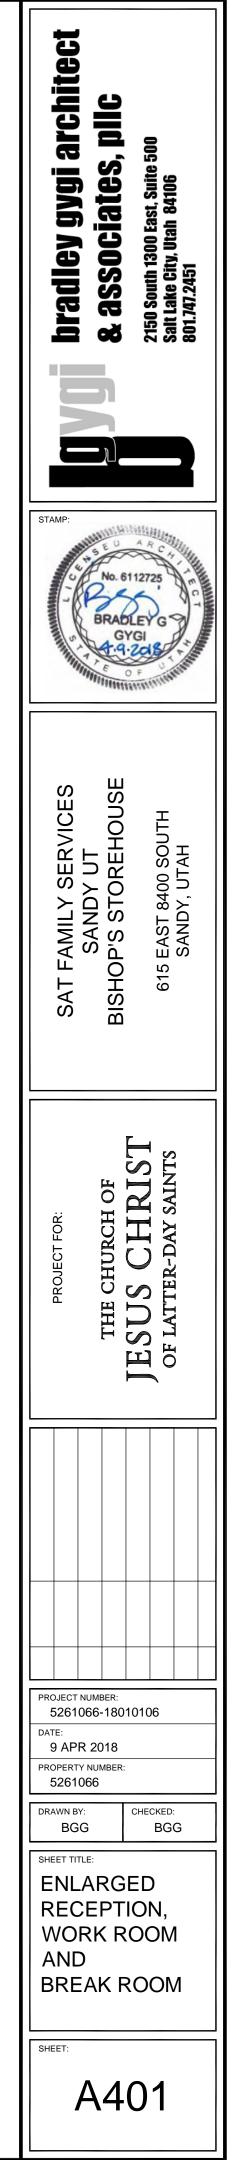


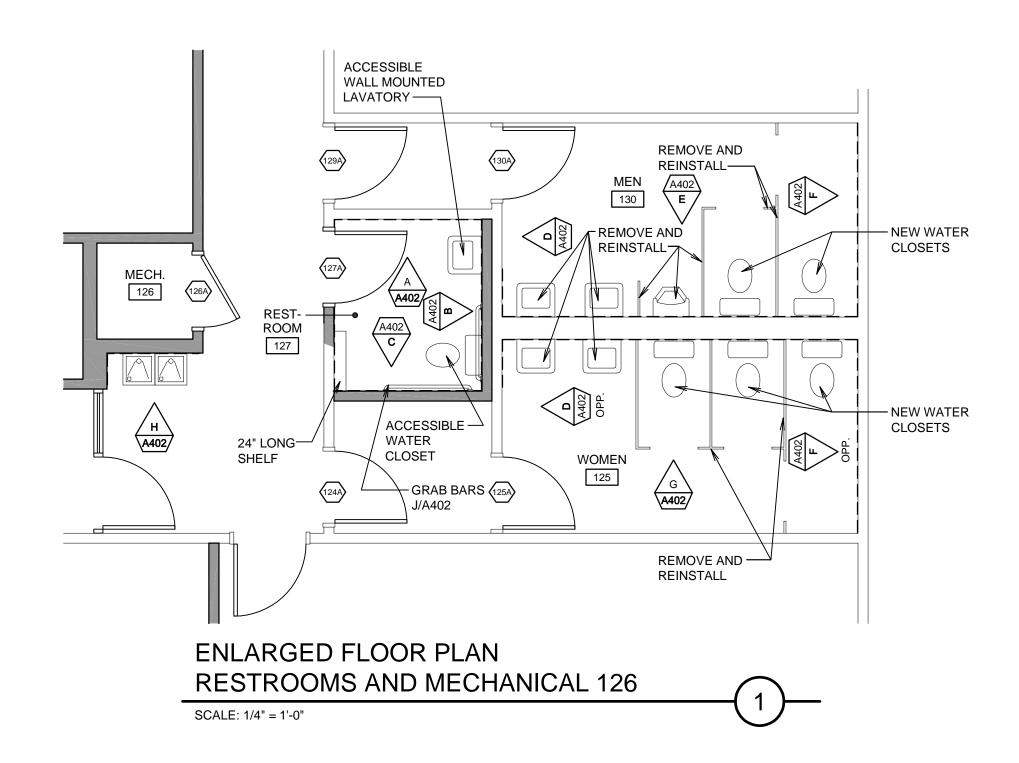

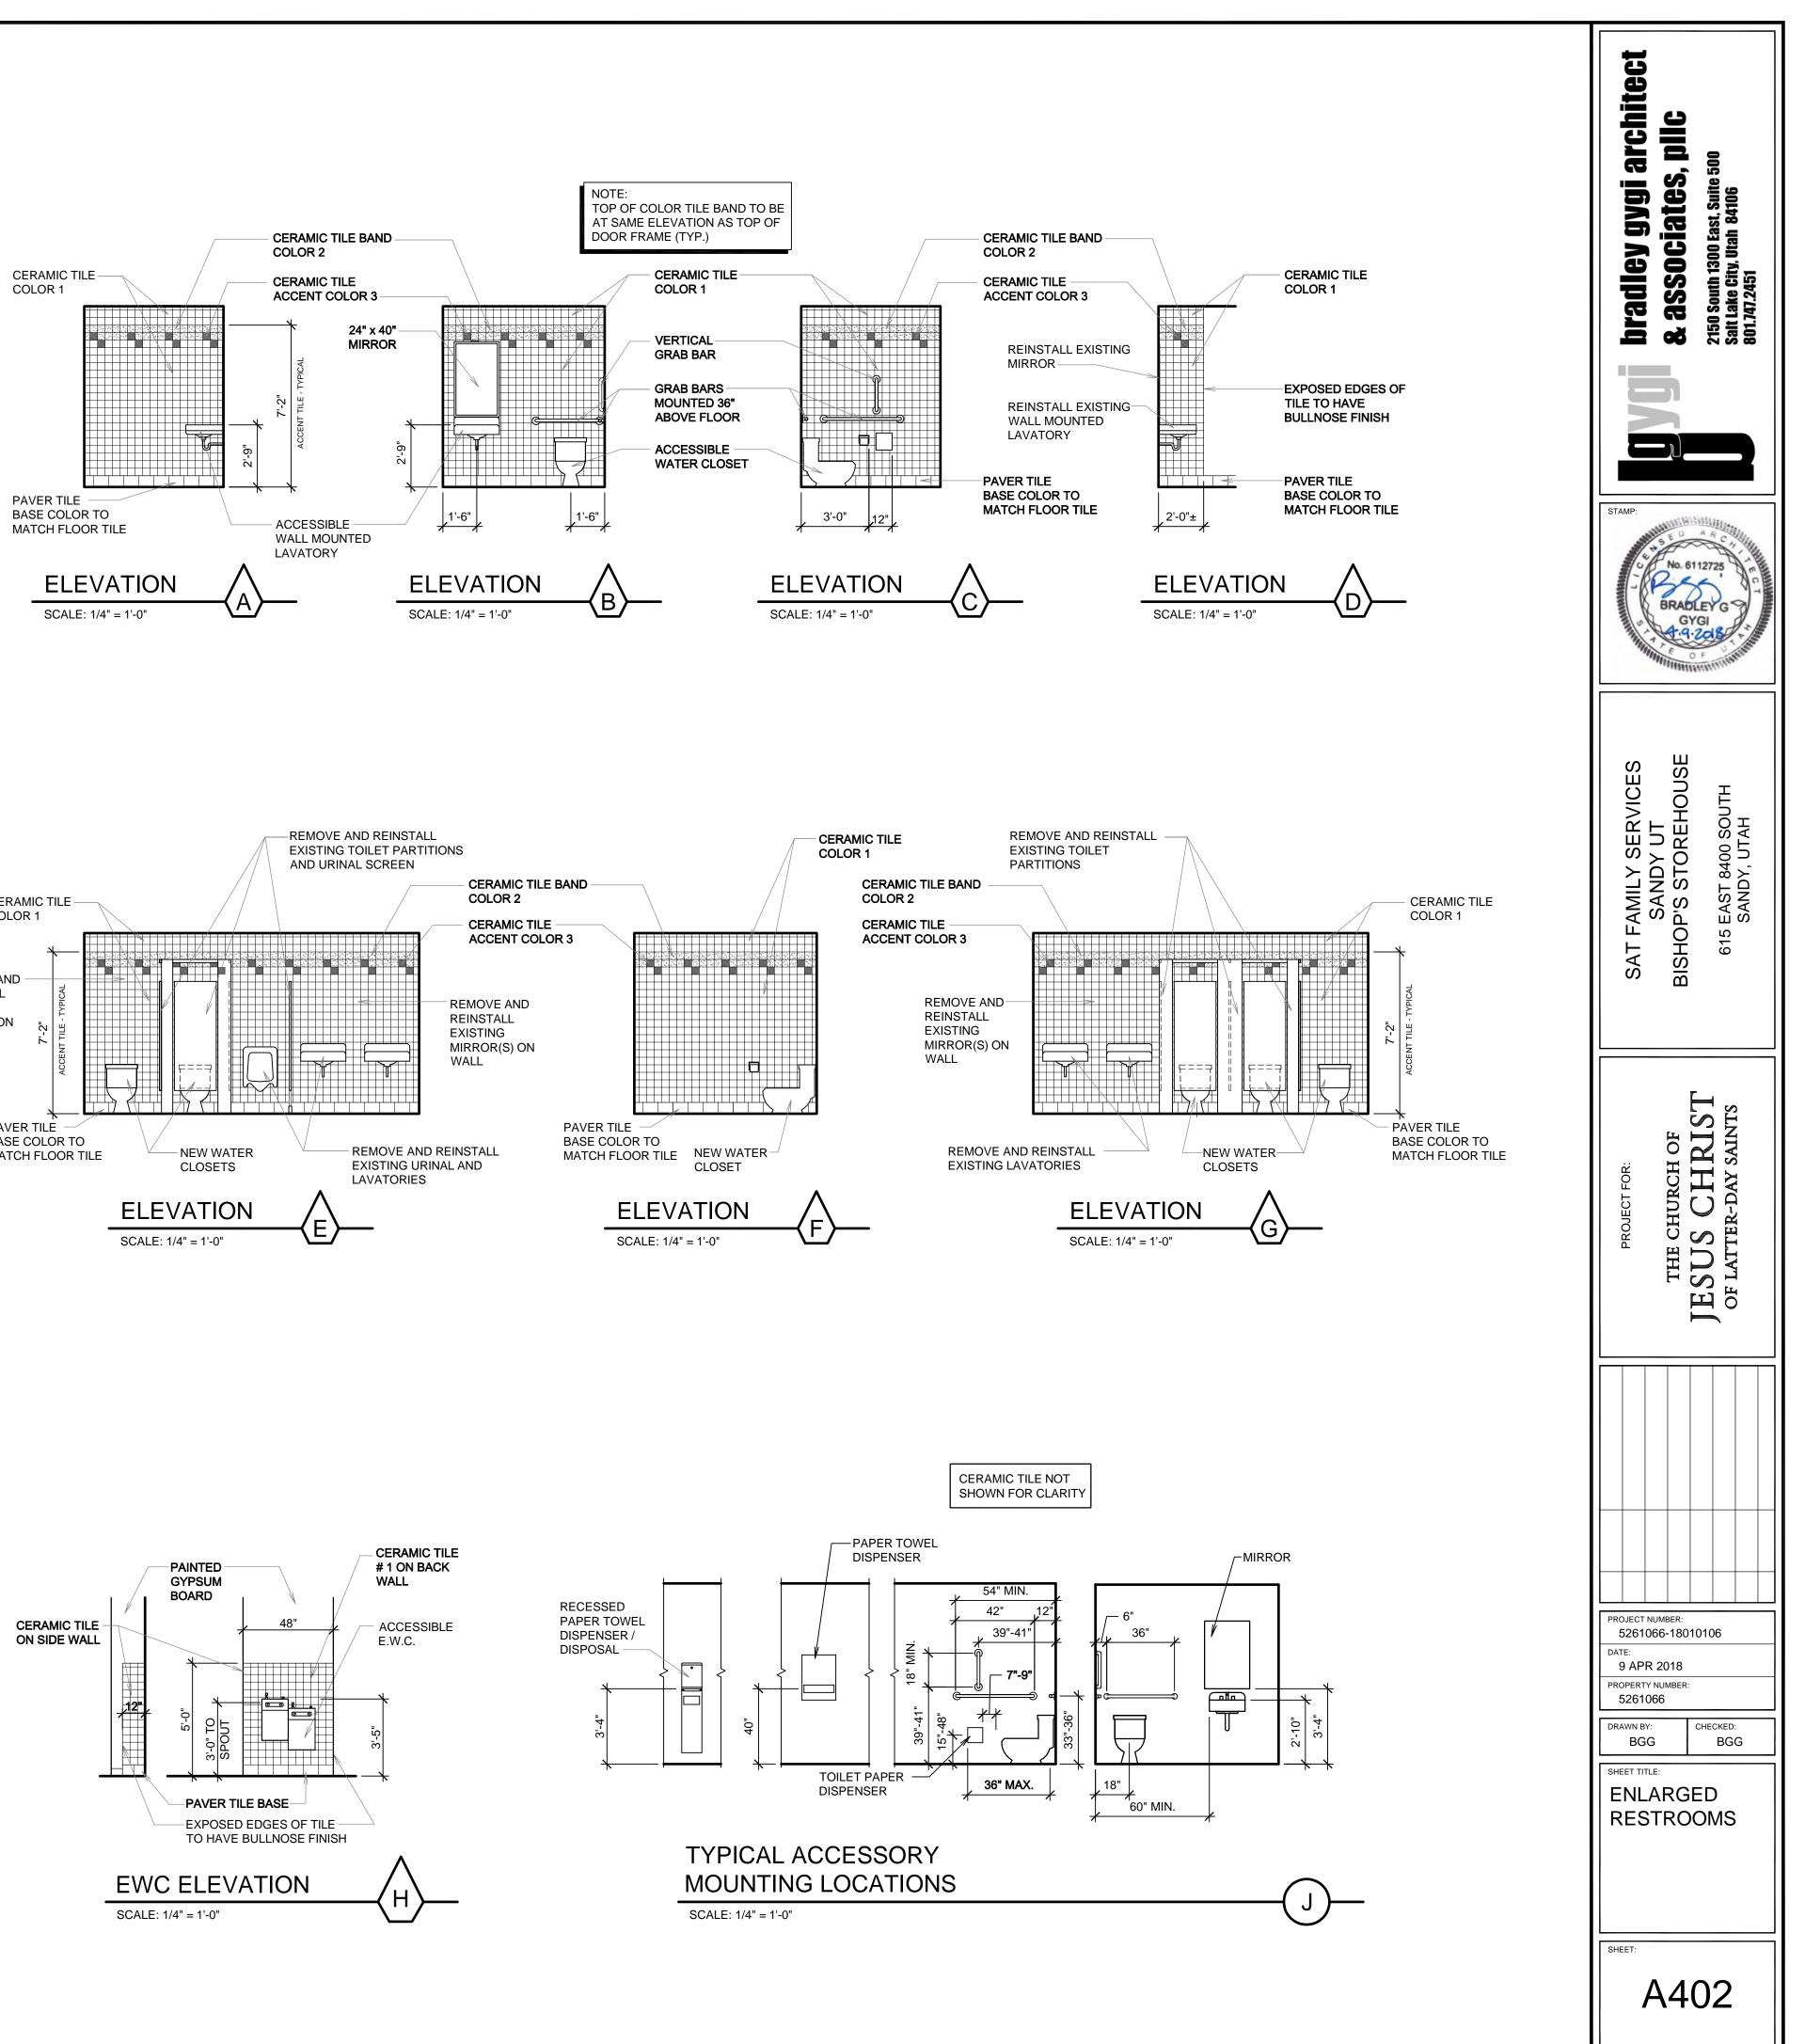


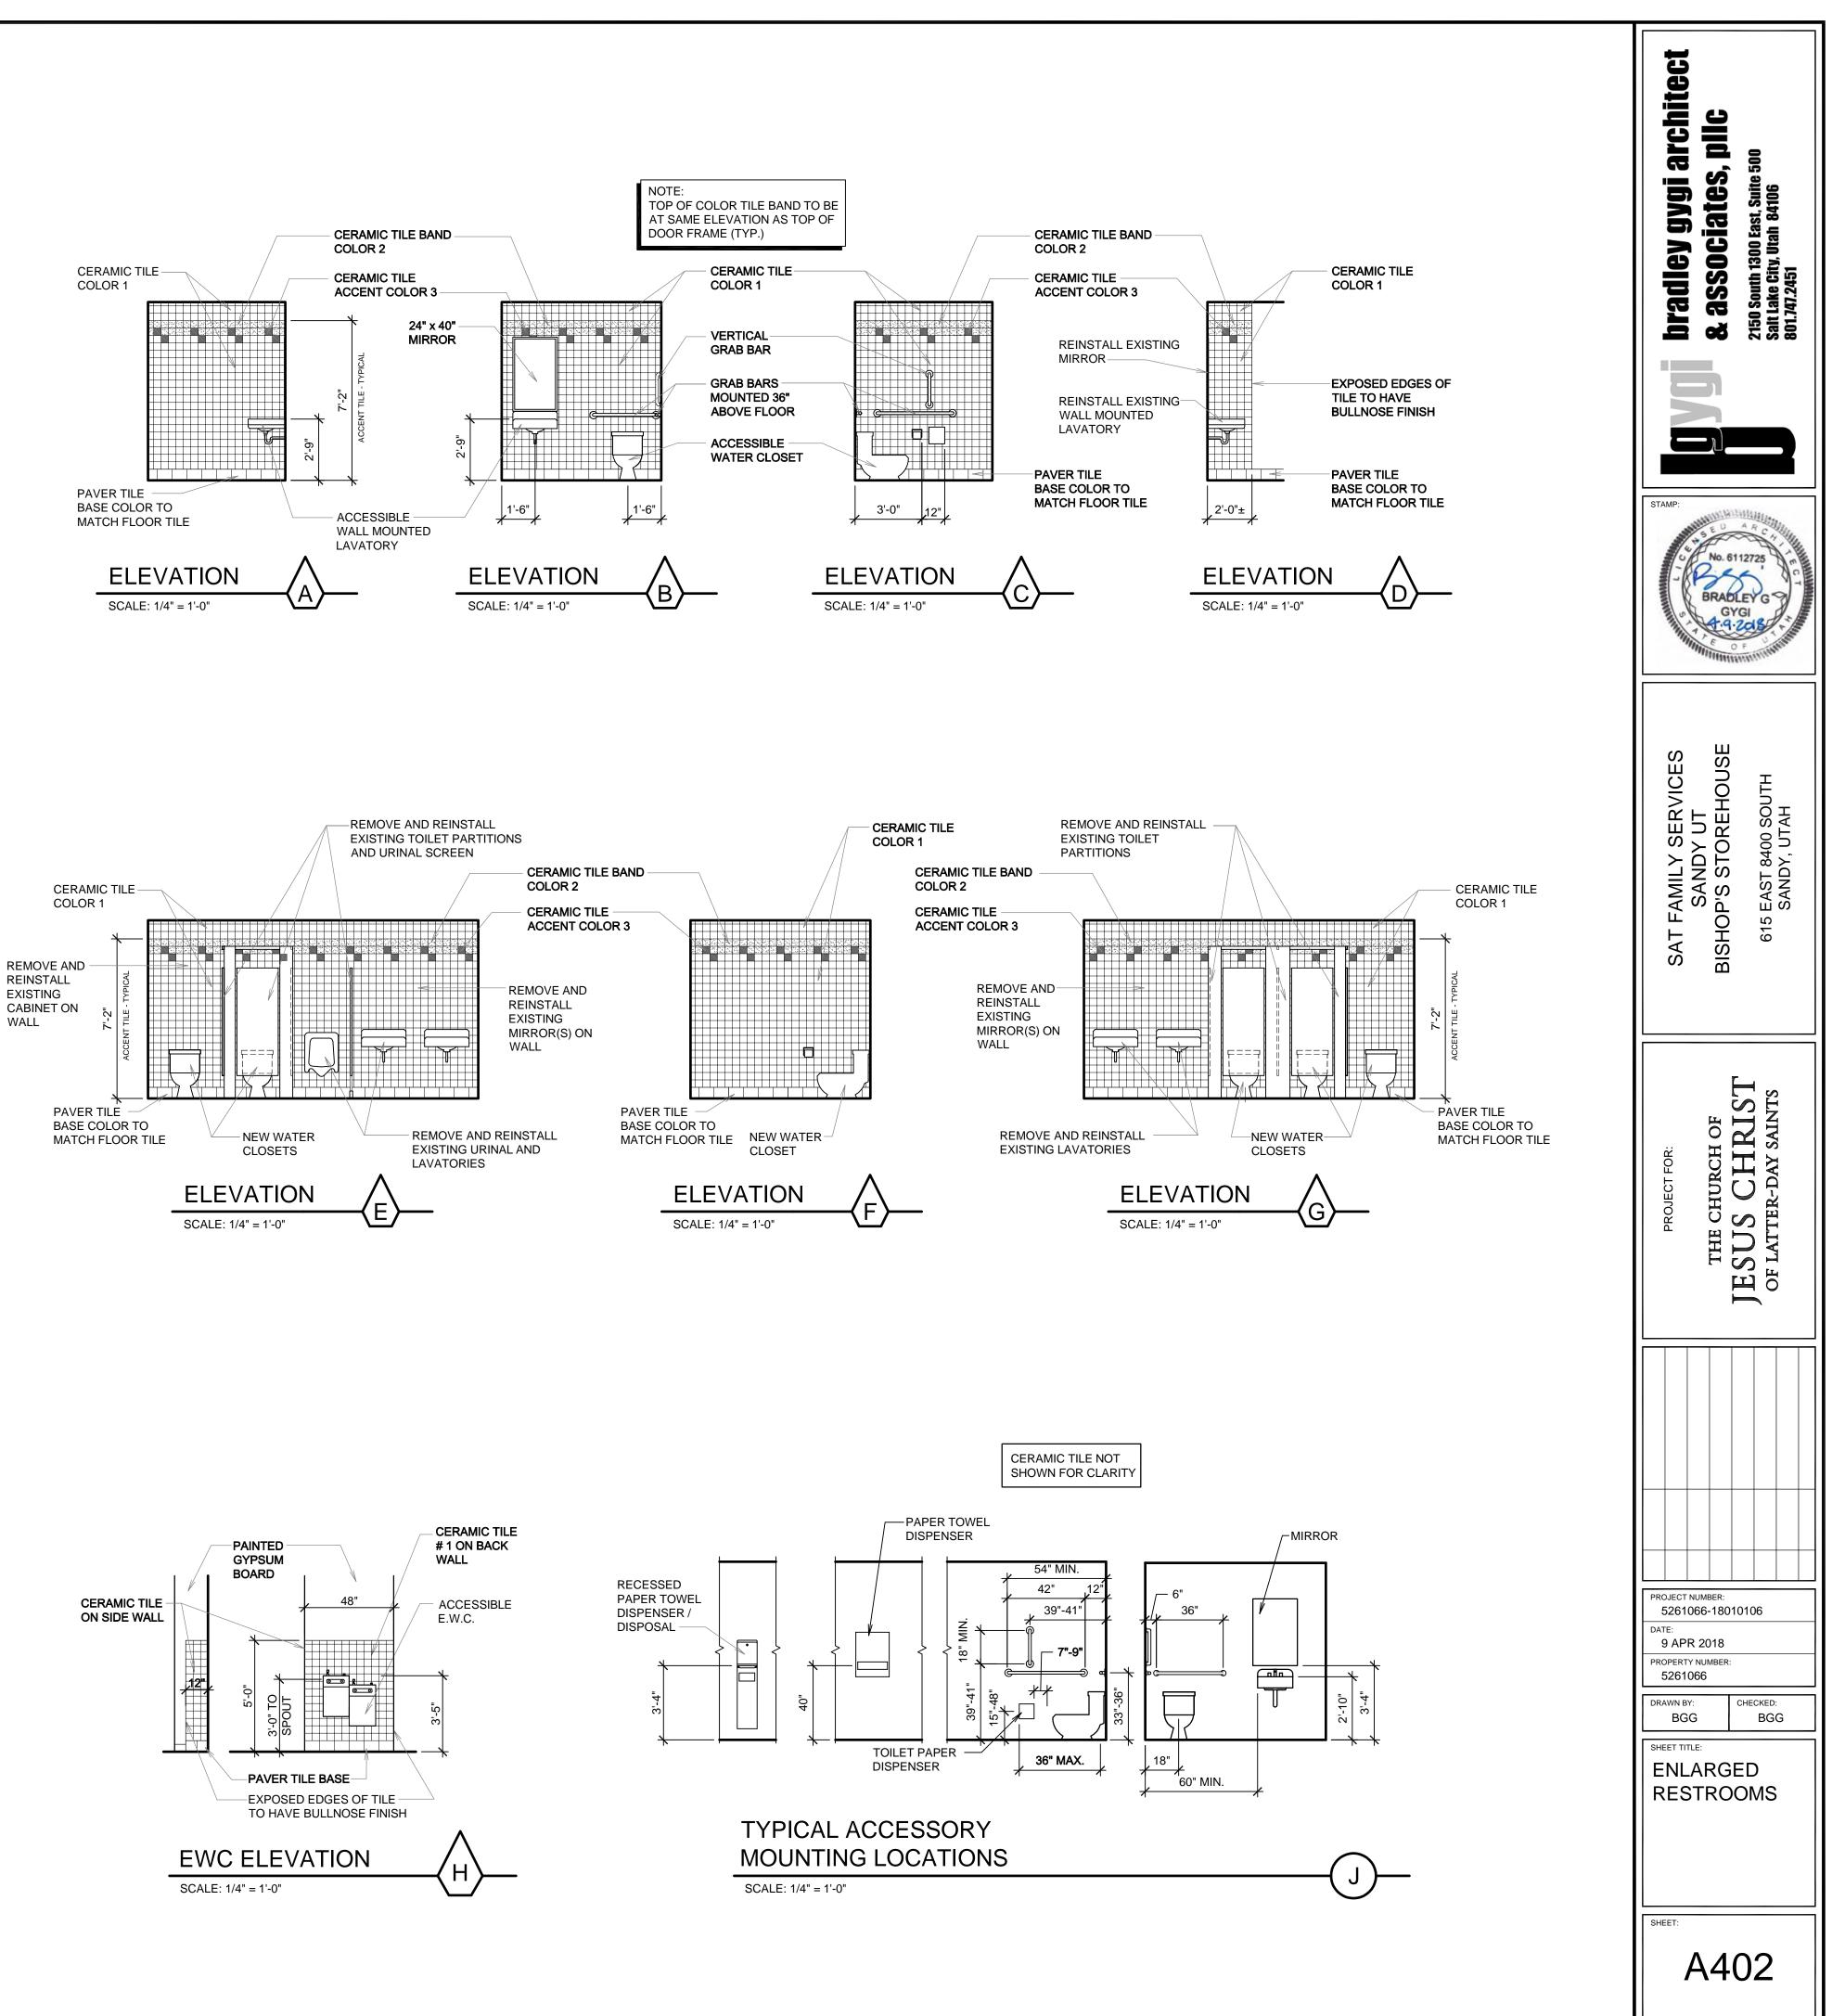


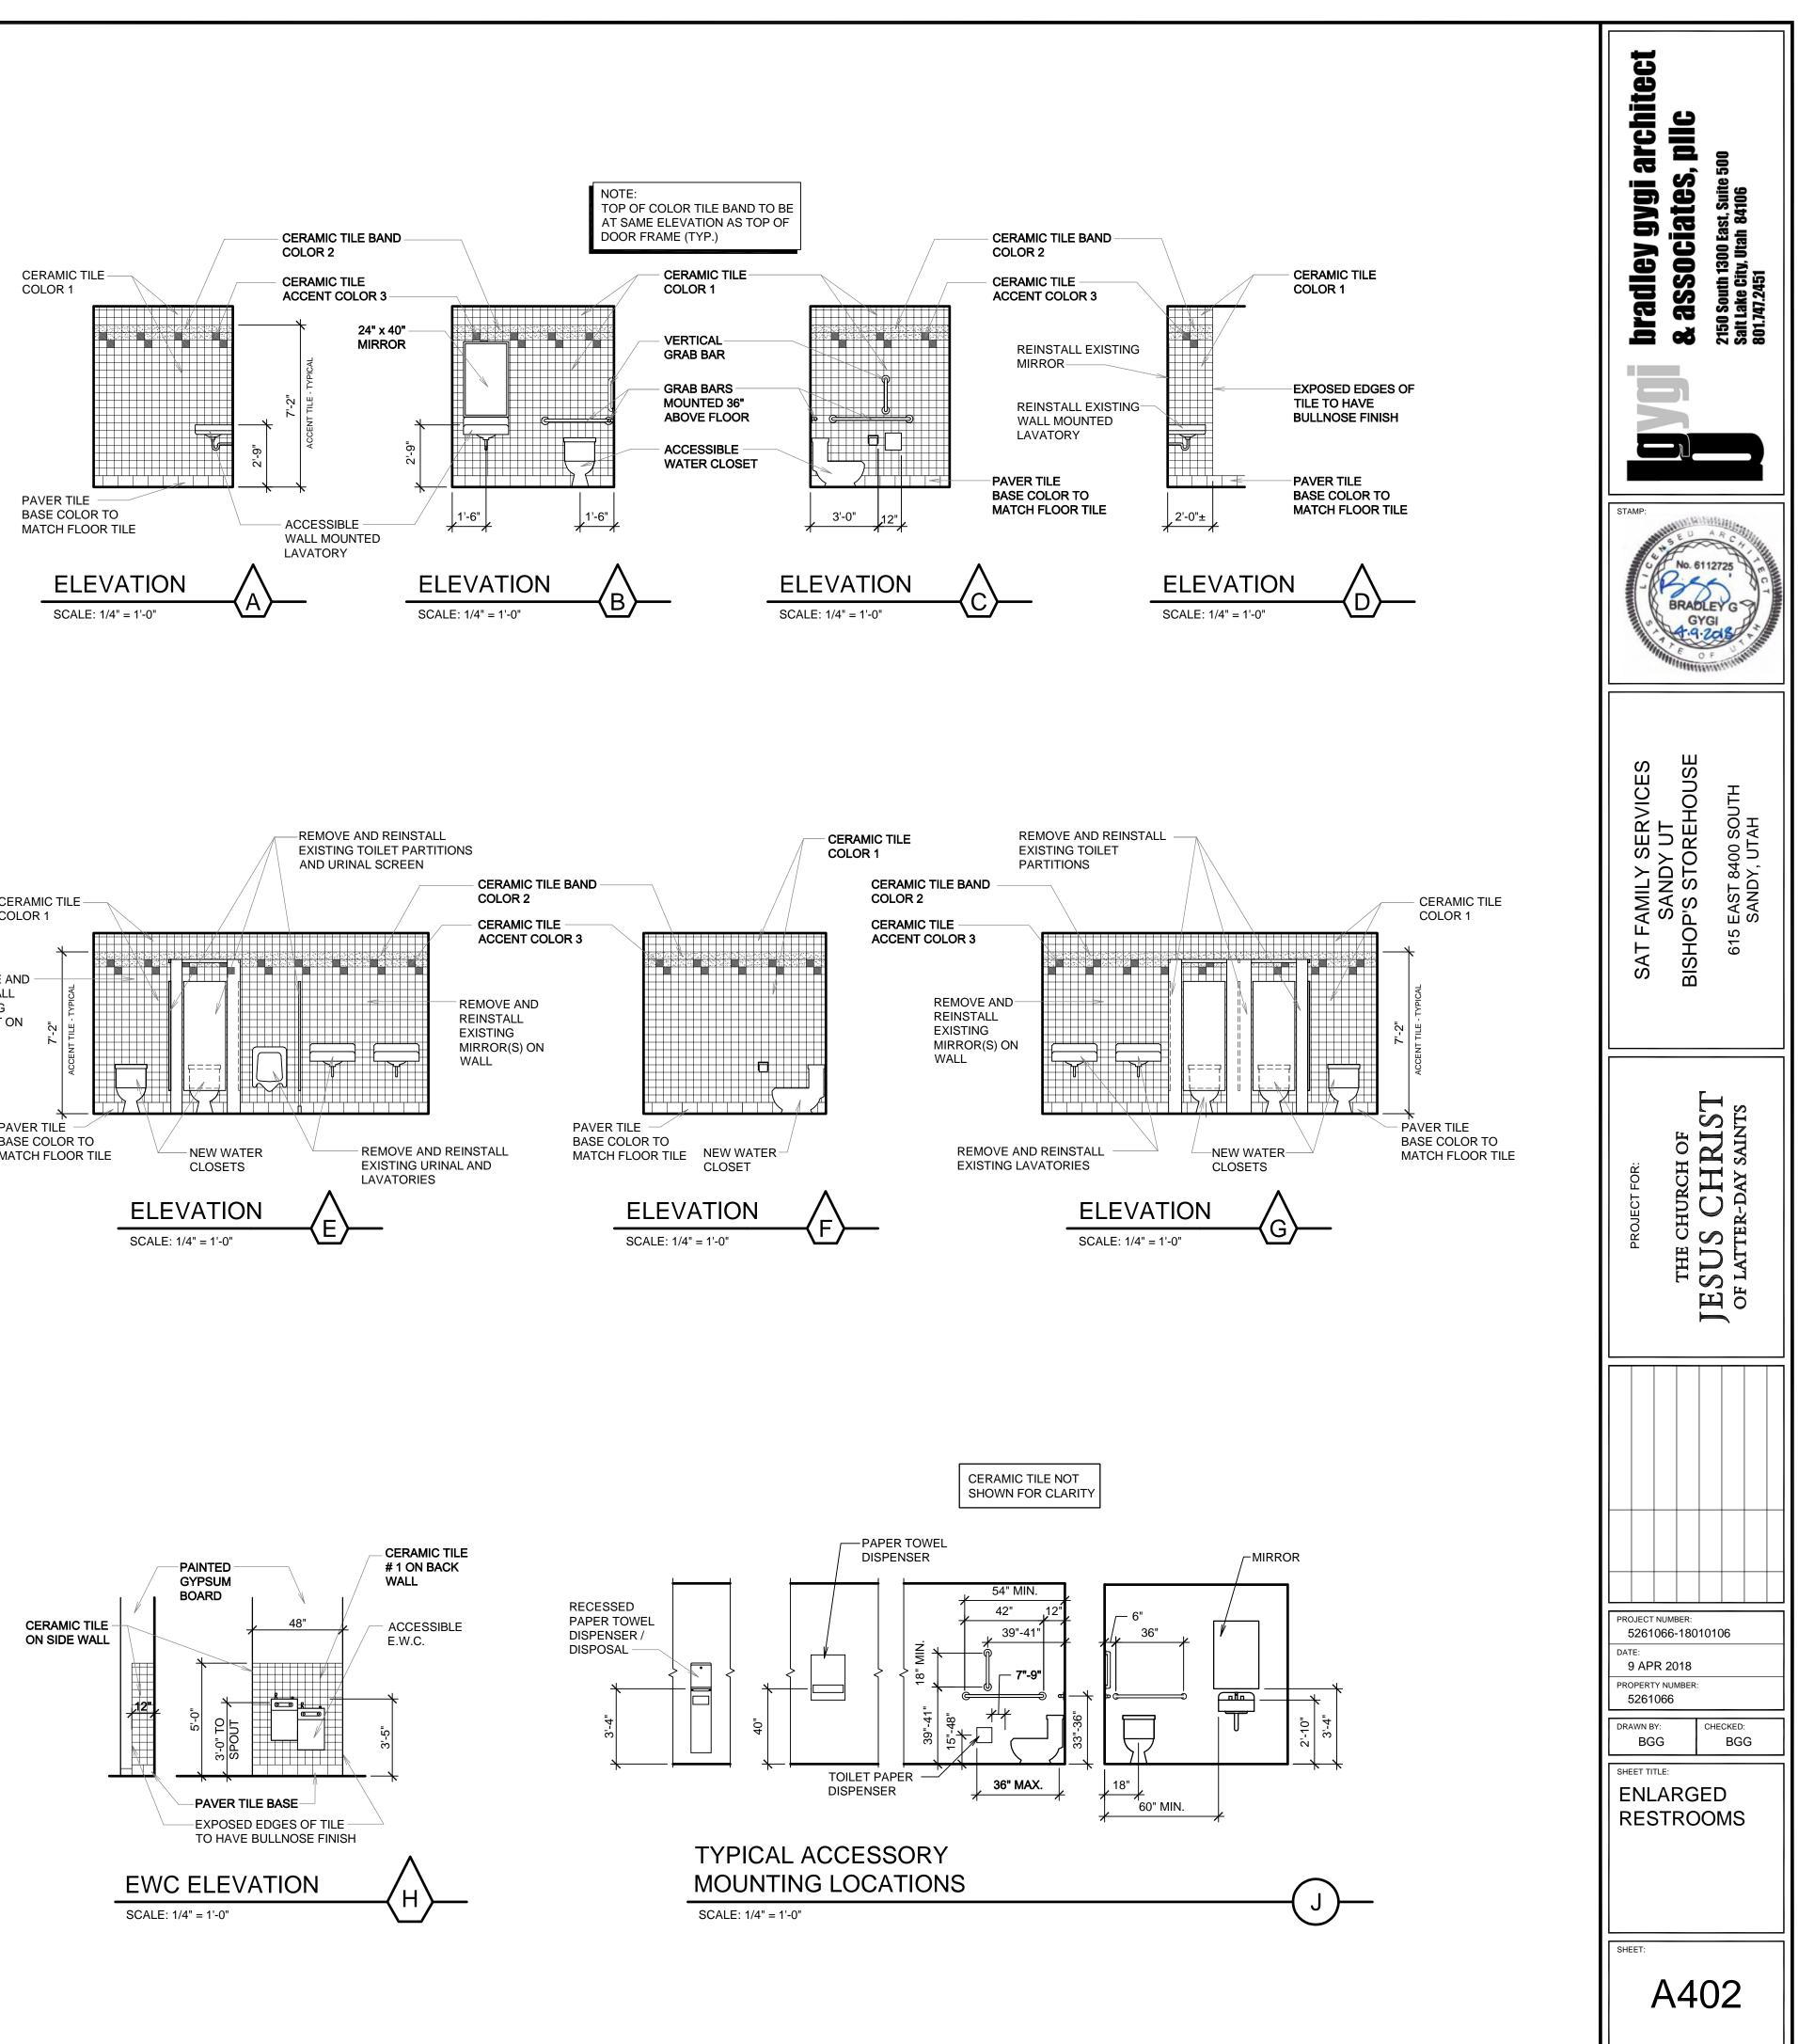


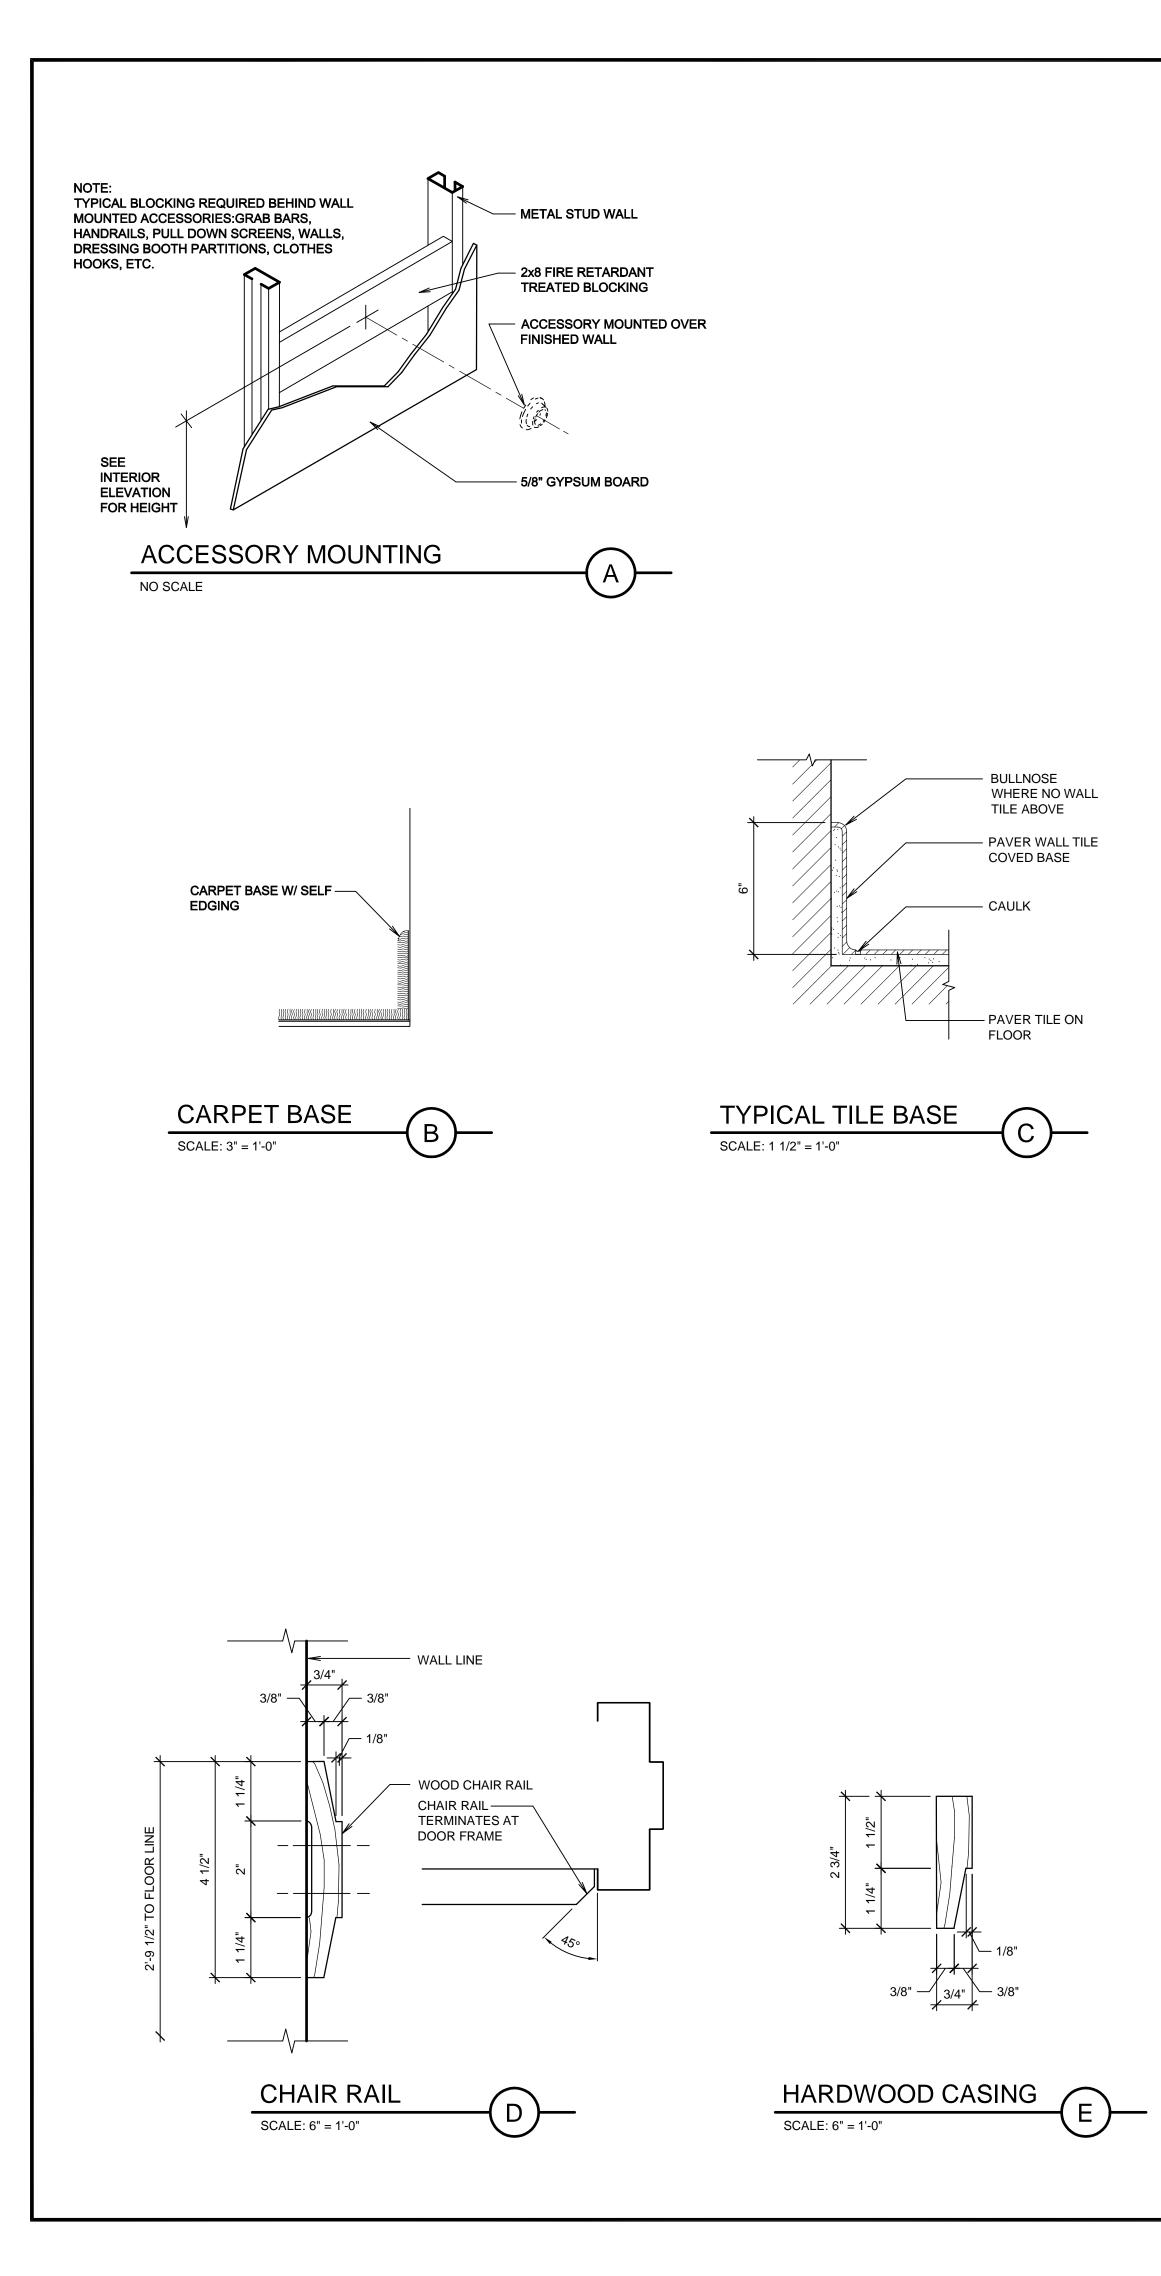



				FIN		SΗ	SCHEDL	LE	H
ROOM NO.	ROOM NAME	FLOOR	BASE	WALLS	CEILING	CEILING HEIGHT	SPECIAL TRIM OR EQUIPMENT	FFLOORF1CARPETF2CARPET TILEF3PAVER TILEF4CONCRETE - PAINT.F5EXISTING CARPET TILE - PROTECTF6EXISTING TO REMAINBBASEP1CARPET SEE P/A601	radley gygi architect associates, pllc 0 South 1300 East, Suite 500 1 Lake City, Utah 84106 1 Lake City, Utah 84106
M 101 102 103 104 105 106 107 108 109 110 112 113 114 115 116 117 118 119 120 121 122 123 124 125 126 127 130 131 132 133 130 131 132 133 131 132 133 131 132 133 131 132 133 131 132 133 131 132 133 120 131 132 133	RING SYSTEM RS OARD TUDS	F5 F1 F3 F1 F1	B2 B1 B3 B1 B3 B1 B3 B1 B1	W3 W1,W6 W1 W4,W5 W2 W5 W1,W6 W1,W6 W1,W6 W1,W6 W1,W6 W1,W6	C5 C1 C2 C2 C2 C2 C2 C2 C2 C2 C2 C2 C2 C2 C2	8'-0"± 8'-0"±	S2 S6 S2,S3 S6 S2,S6,S8,S9 S2,S6,S8,S9 S2 S4,S5,S7 S2 S4,S5,S7 S4,S5,S7 S4,S5,S7	 CARPET, SEE EXAMPL. CARPET, ON ATCH CARPET THE COVED PAYER THE, SEE CARD. COVED PAYER THE, SEE CARD. COVED PAYER THE, SEE CARD. EXISTING TO REMAIN W WALLS NE OR EXISTING GYPSUM BOARD - SMOOTH FINISH AND PAINTED NE OR EXISTING GYPSUM BOARD AND PAISTER TO MATCH WHERE DISTURBED BY DEMOLITON WORK (1) COAT HEXISTING GYPSUM BOARD AND PAISTER TO MATCH WHERE DISTURBED BY DEMOLITON WORK (1) COAT NUL COATING AT ENTIRE WALL AREA WHERE WALL COVERNISS ARE REMOVED. SMOOTH TEXTURE TO MATCH WHERE DISTURBED BY DEMOLITON WORK (1) COAT NUL COATING AT ENTIRE WALL AREA WHERE WALL COVERNISS ARE REMOVED. SMOOTH TEXTURE TO MATCH WHERE DISTURBED BY DEMOLITON WORK (1) COAT NUL COATING AT ENTIRE WALL AREA WHERE WALL COVERNISS ARE REMOVED. SMOOTH TEXTURE TO MATCH WHERE DISTURBED BY DEMOLITON WORK (1) COAT NUL COATING AT ENTIRE WALL AREA WHERE WALL COVERNISS AND EXISTEM WITH AREA WHERE WALL COVERNISS AND REMOVED. SMOOTH TEXTURE TO MATCH AND PAINT. CREMAN CTHE COALES AT GYPSUM BOARD AND PAISTER TO THAT WHERE DISTURS AND PAINT. CREMAN CHE COLUES AND THE COALES. CELING CELING SYSTEM WITH ANY ACOUSTICAL CELING THE COMPARE SYSTEM REPLACE SMALLER THES WITH SALVARED EXISTING THE RAD COUNTER. ZAY 447 SUBPENDED SYSTEM WITH LAYIN ACOUSTICAL CELING THE. TO REMAIN. PATCH TO MATCH WHERE DISTING THE PROM ROOM AND PAINT. EXISTING SYNCH IS REMAYED EXISTING THE PROM ROOM AND PAINT. EXISTING SYNCH IS REMAYED EXISTING THE PROM ROOM AND PAINTED GYSTEM WITH LAYIN ACOUSTICAL CELING THE. TO REMAIN THE AND ROOM AND PAINTE. SPECIAL TRIM ORDER SYSTEM WITH LAYIN ACOUSTICAL CELING THE WITH ANY IN ACOUSTICAL CELING THE SWITH SALVARED EXISTING THE PROM ROOM AND PAINTED GYSTEM WITH ANY IN ACOUSTICAL CELING THE SWITH SALVARED EXISTING THE PROM ROOM AND AND PAINTED GYSTEM WITH ANY IN ACOUSTICAL CELING THE SWITH SALVARED EXISTING THE PROM ROOM AND AND AND THE TO REMAIN	BISHOP'S STOREHOUSE CHECT FOR SATE FAMILY SERVICES SATE FAMILY SERVICES SATE FAMILY SERVICES SATE FAMILY SERVICES SATE FAMILY SERVICES SATE FORCE OF SATE FORCE OF SATE FORCE OF SATE FORCE OF SATE FORCE OF SATE SAUDY OF SATE SATE SAUDY OF SATE SAUDY OF SATE SATE SAUDY OF SATE SATE SATE SATE SAUDY OF SATE SATE SATE SATE SATE SATE SATE SATE

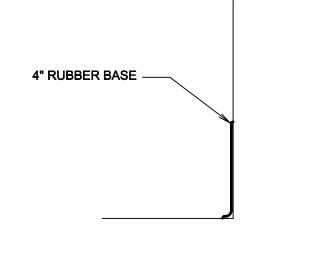

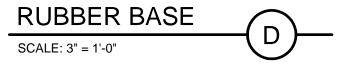

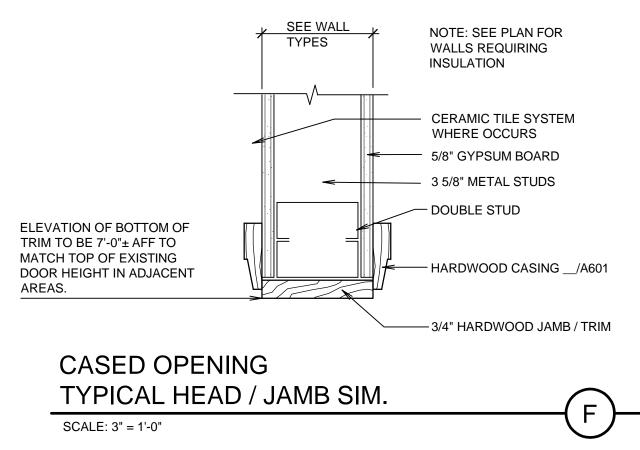

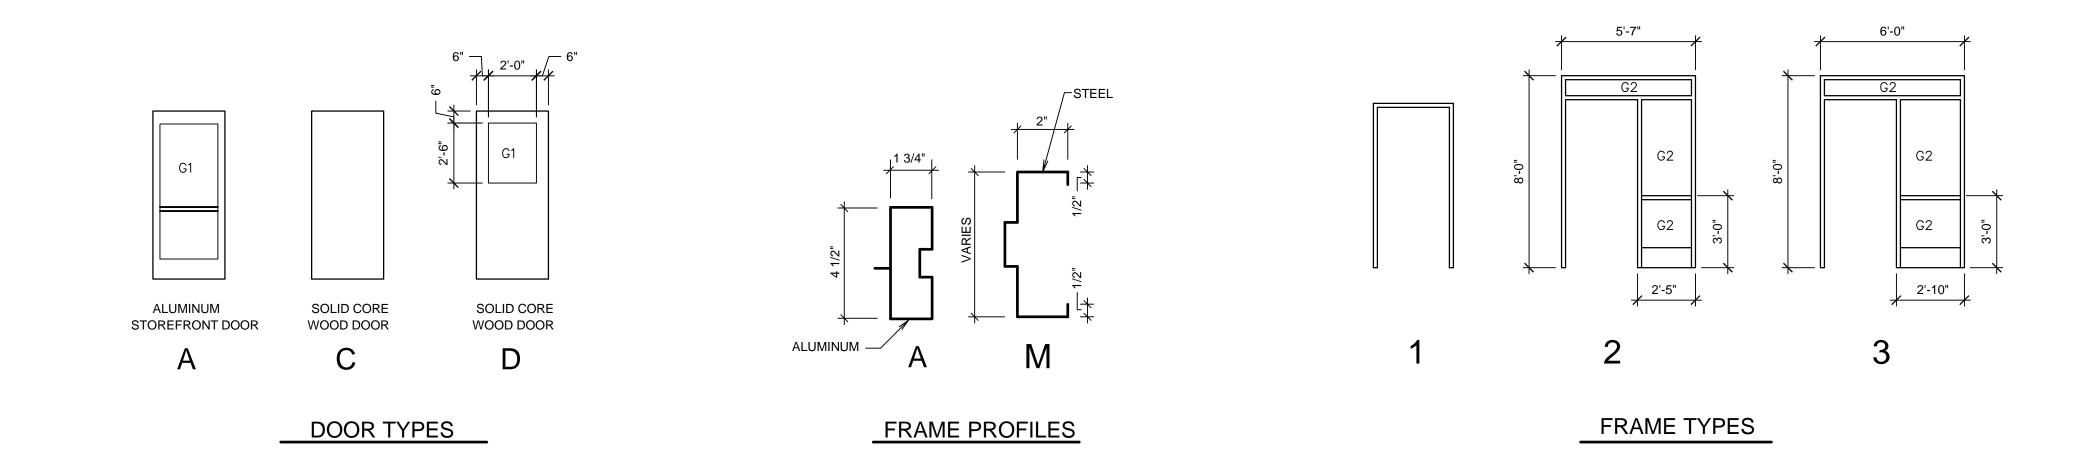

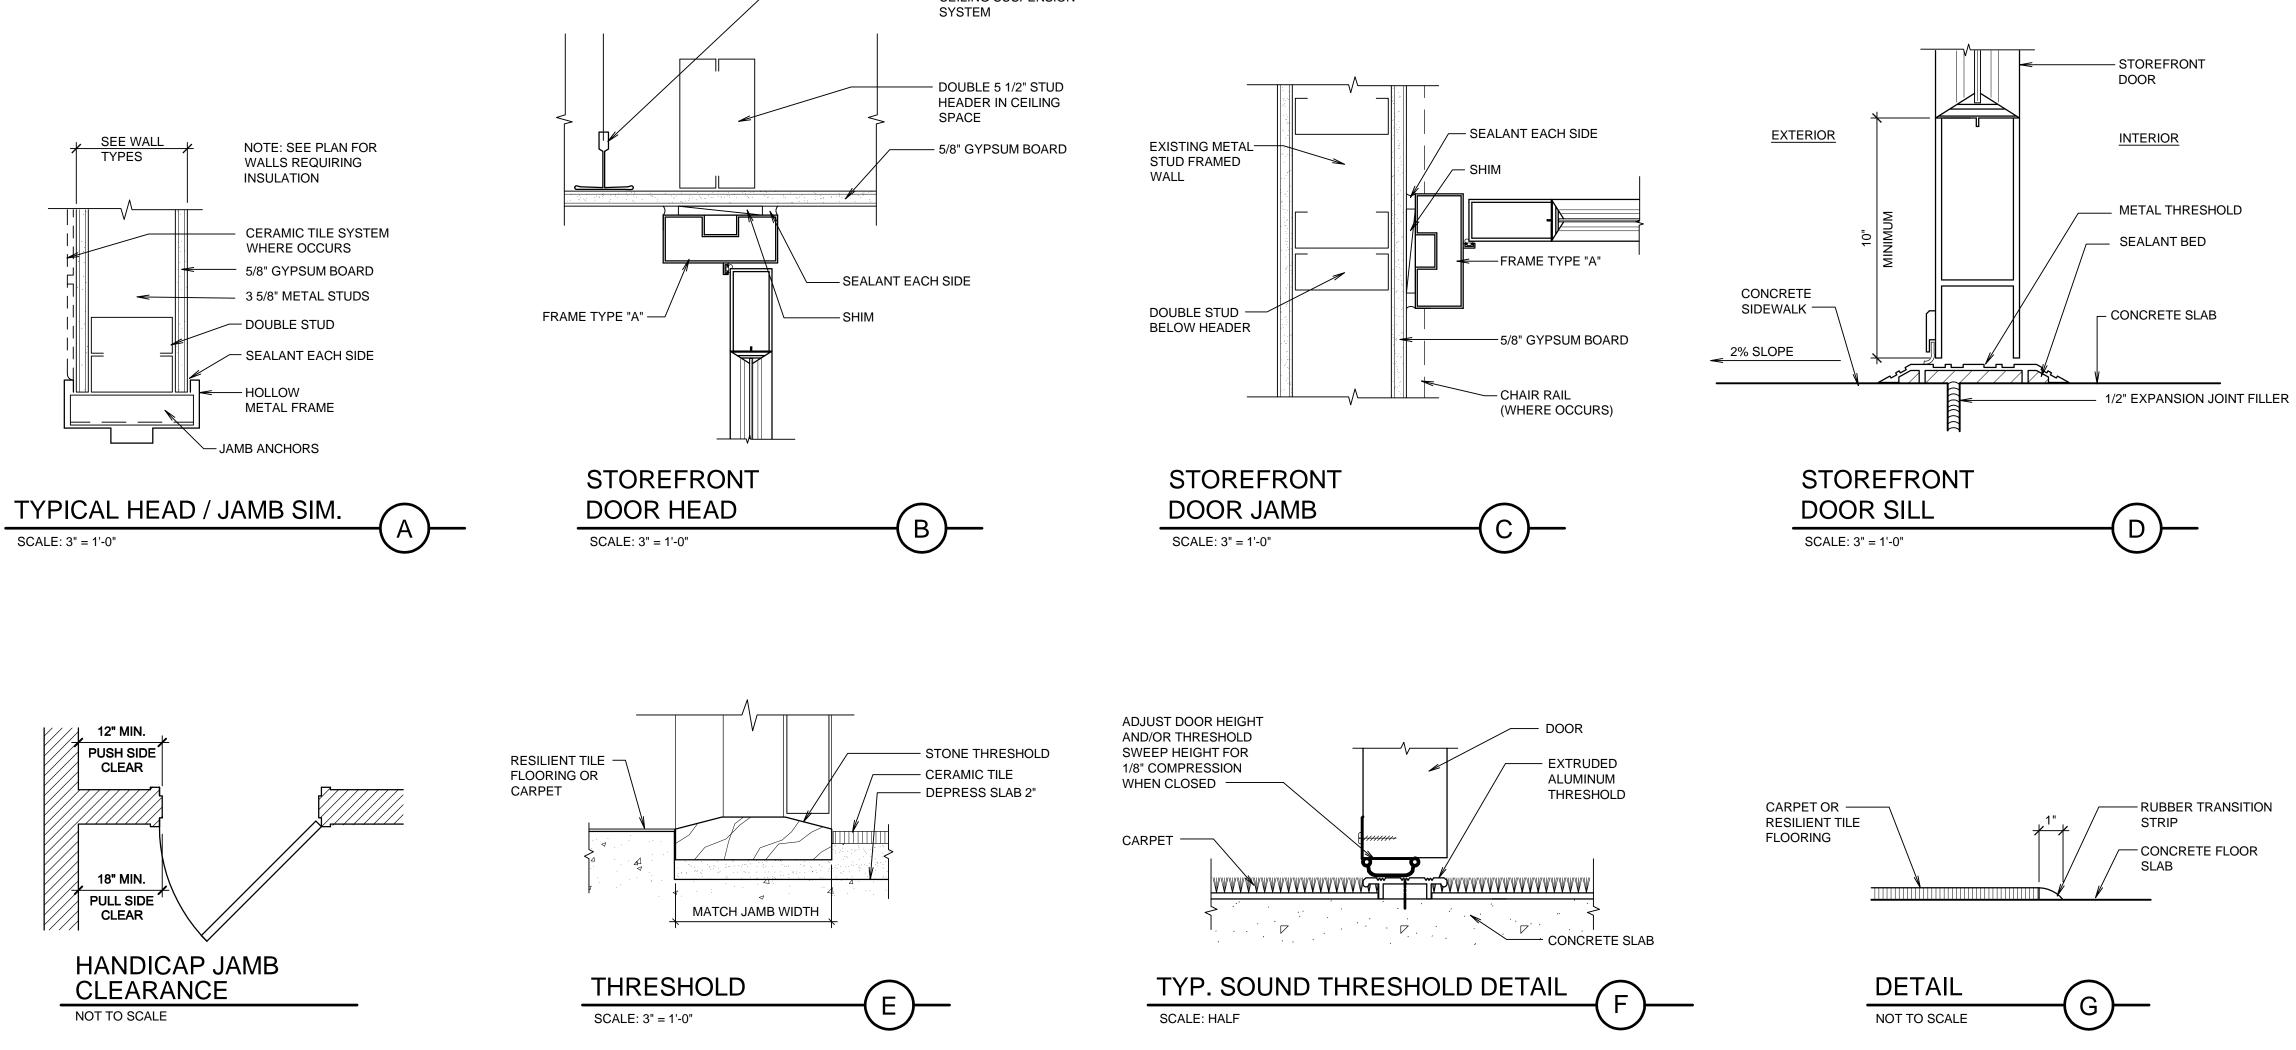


- CEILING SUSPENSION

			DO	OR				ш	DETAIL			0		
MARK	ROOM	ТҮРЕ	SINGLE	DOUBLE	SIZE	GLASS	PROFILE	FRAME TYPE	HEAD	JAMB	HARDWARE GROUP	THRESHOLD	REMARKS	bradley gygi architec & associates, pllc alt Lake City, Utah 84106
	N LE\ 106	/EL C	0		S1		М	1	A/A602	A/A602 (SIM).	24			bradley gygi al & associates, p 2150 South 1300 East, Suite 500 Salt Lake City, Utah 84106
107A 108A	107 108	D A	•		S1 S1	G1 G2	M A	1 2	A/A602 B/A602	A/A602 (SIM). C/A602	20 ST1		R1	CIA DEast, 0 East, 0 E
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125A 126A	125 126	C C	•		S2 S1		М	1	EXISTING A/A602	EXISTING A/A602 (SIM).	28 22A	T2 T4	R2	
127A 129A	127 129	C C	•		S1 S2		М	1	A/A602 EXISTING	A/A602 (SIM). EXISTING	32 28	T2	R2	STAMP:
131A	130 131	C C	•		S2 S1		М	1	EXISTING A/A602	EXISTING A/A602 (SIM).	28 22	T2	R2	No. 6112725
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	G2	1/4	4" TE	MPE	RED		(SIN		GLAZE)	DOOF C. FIELD	RS WHER VERIFY	E NECES	SSARY). DR OPENINGS FOR	m s m
						• -				SIZE	OF FRAM	ES AND	DOORS.	
	T T1	M	ETAL	. THF	RESHO		- See d							
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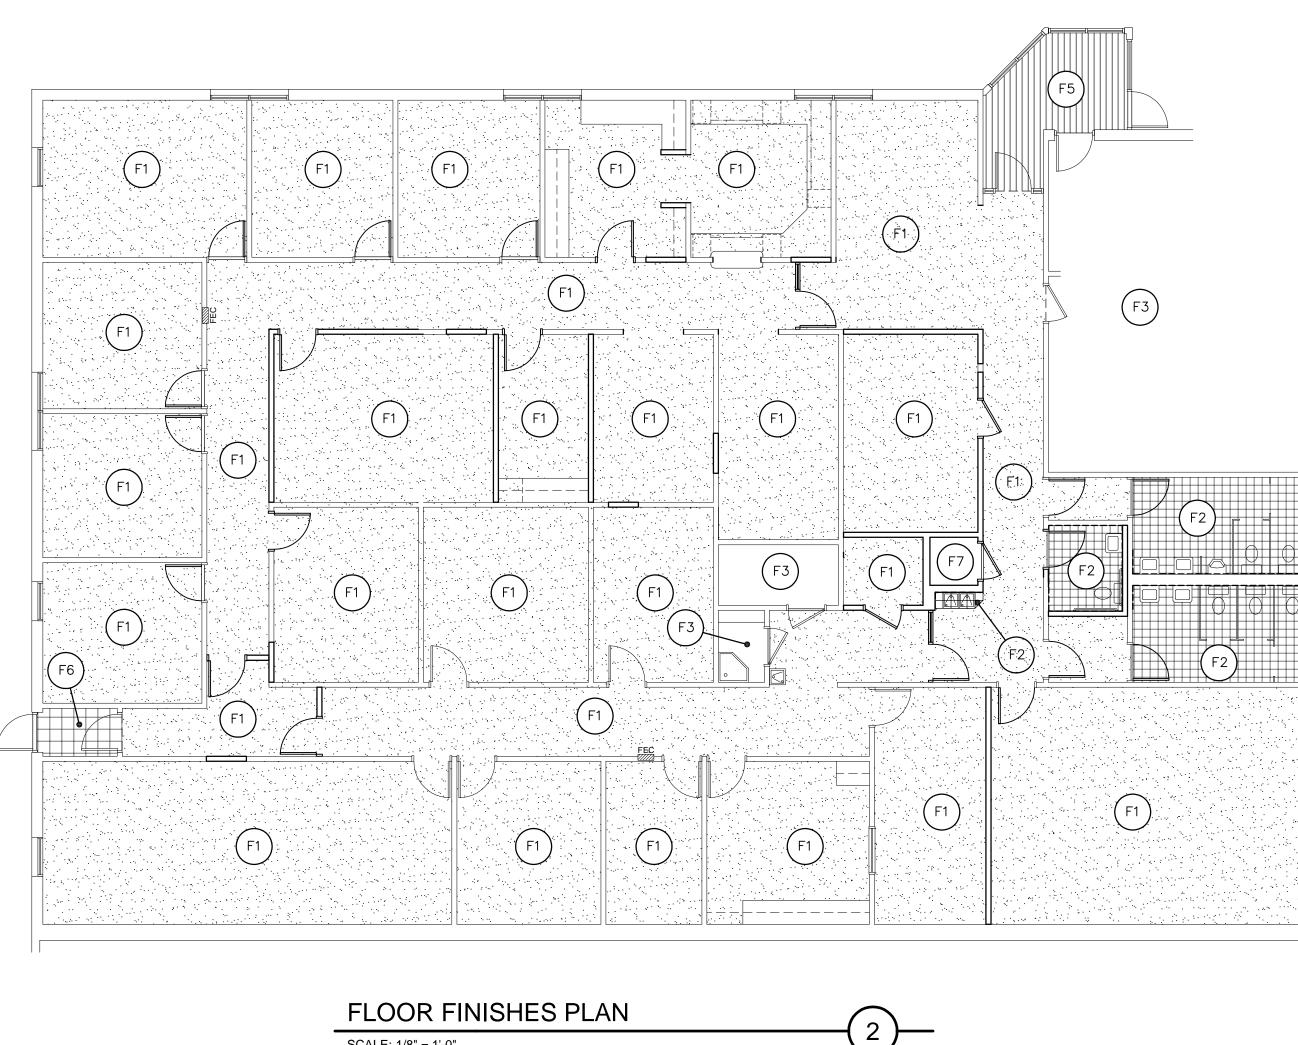


FURNISHINGS AND EQUIPMENT SCHEDULE									
<u>NOTE:</u> FOR OTHER SEE DIVISIO				IS REFER TO SHEE NCERNING OWNER F					
ITEM	FURNISHED BY	INSTALLED BY	BRAND	STYLE OR TYPE	COLOR	REMARKS			
CARPET	OWNER	OWNER	SEE DIV. 09			CONTRACTOR TO PROVIDE FLOOR PREPARATION			
MODULAR FURNITURE	OWNER	OWNER							
ROOM SIGNAGE	OWNER	CONTRACTOR	SEE DIV. 10	SEE SHEET F201					
FIRE EXTINGUISHERS						EXISTING TO REMAIN			
SECURITY	OWNER	OWNER							
MICROWAVE	OWNER	CONTRACTOR		SEE SHEET A401					
REFRIGERATOR	OWNER	OWNER							

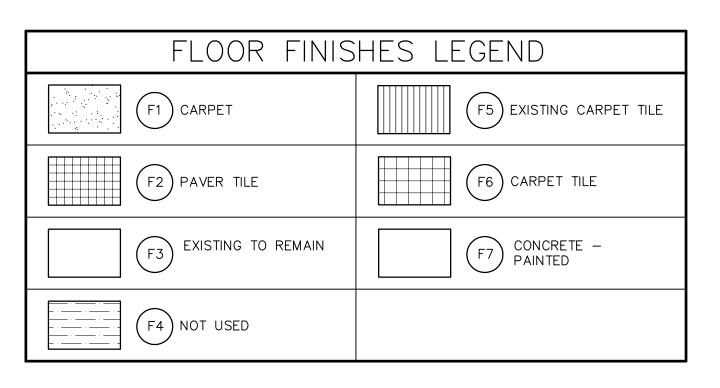


OFFICE FURNITURE








SCALE: 1/8" = 1'-0"

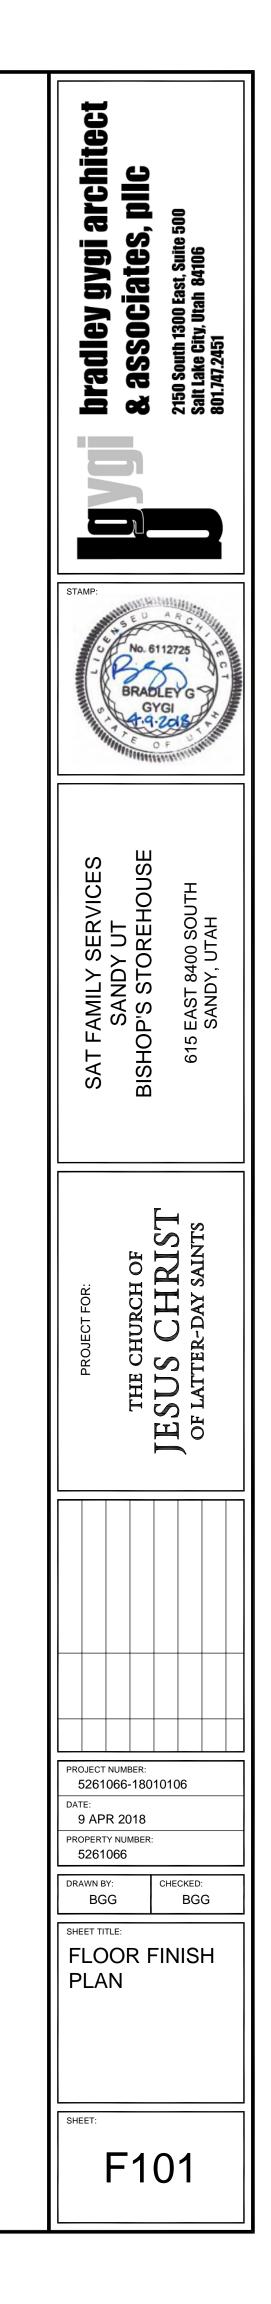




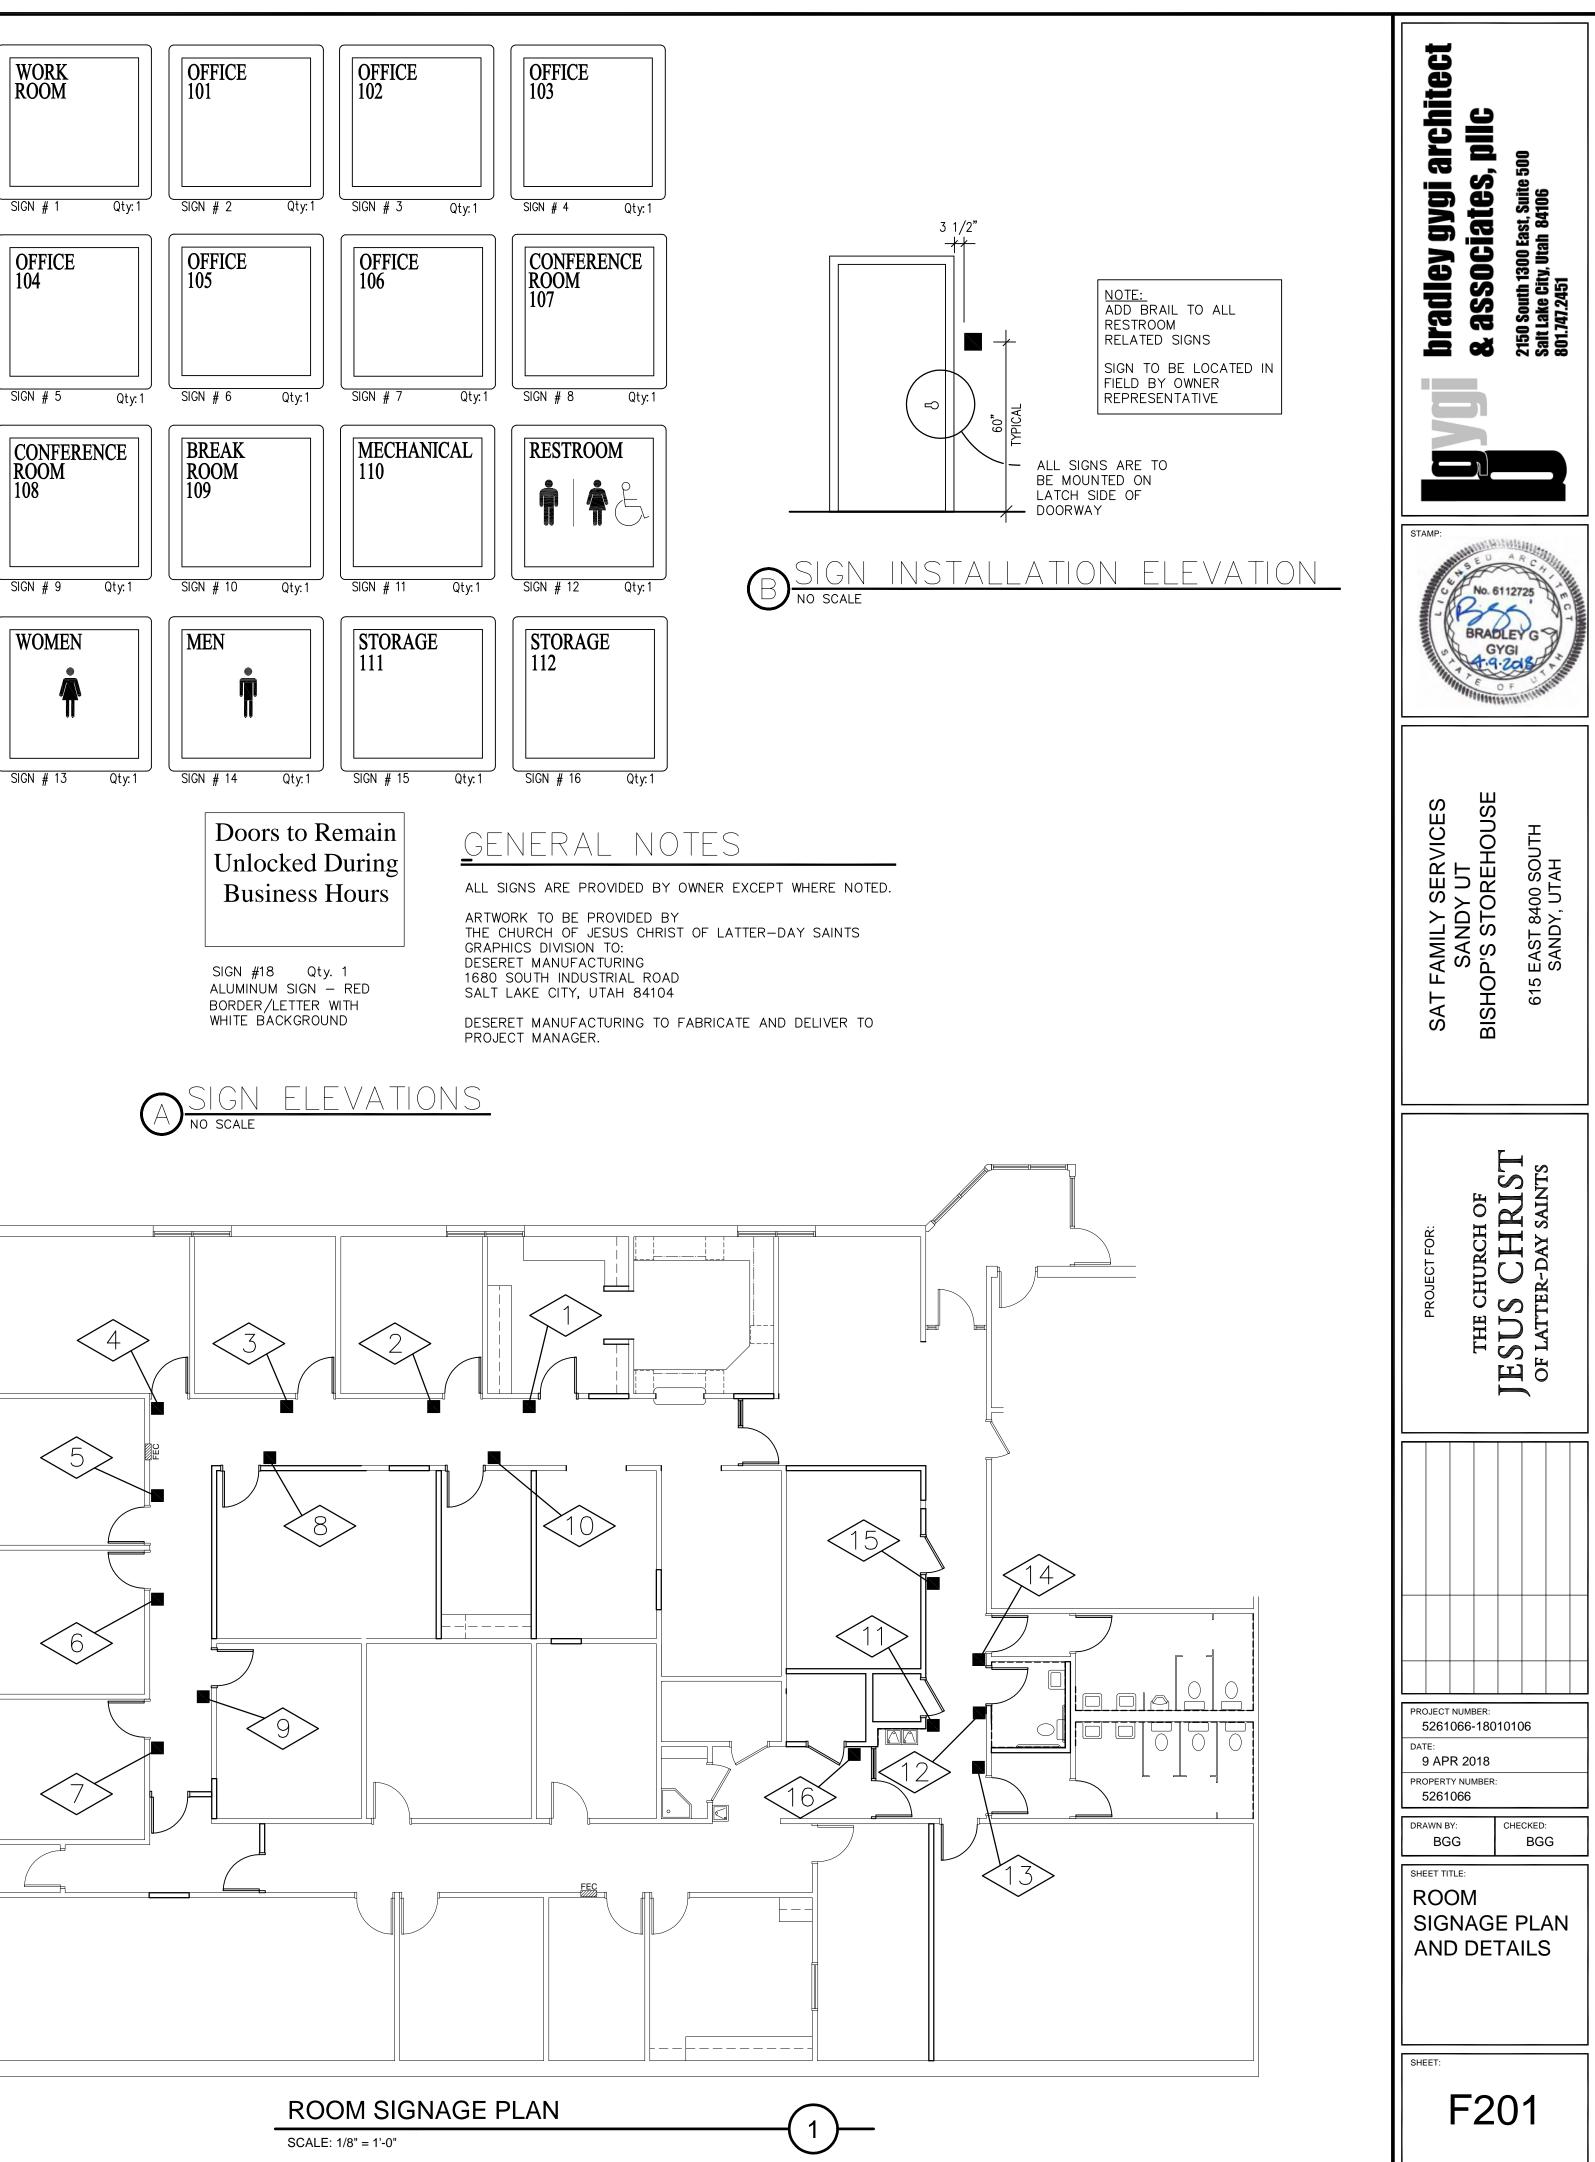


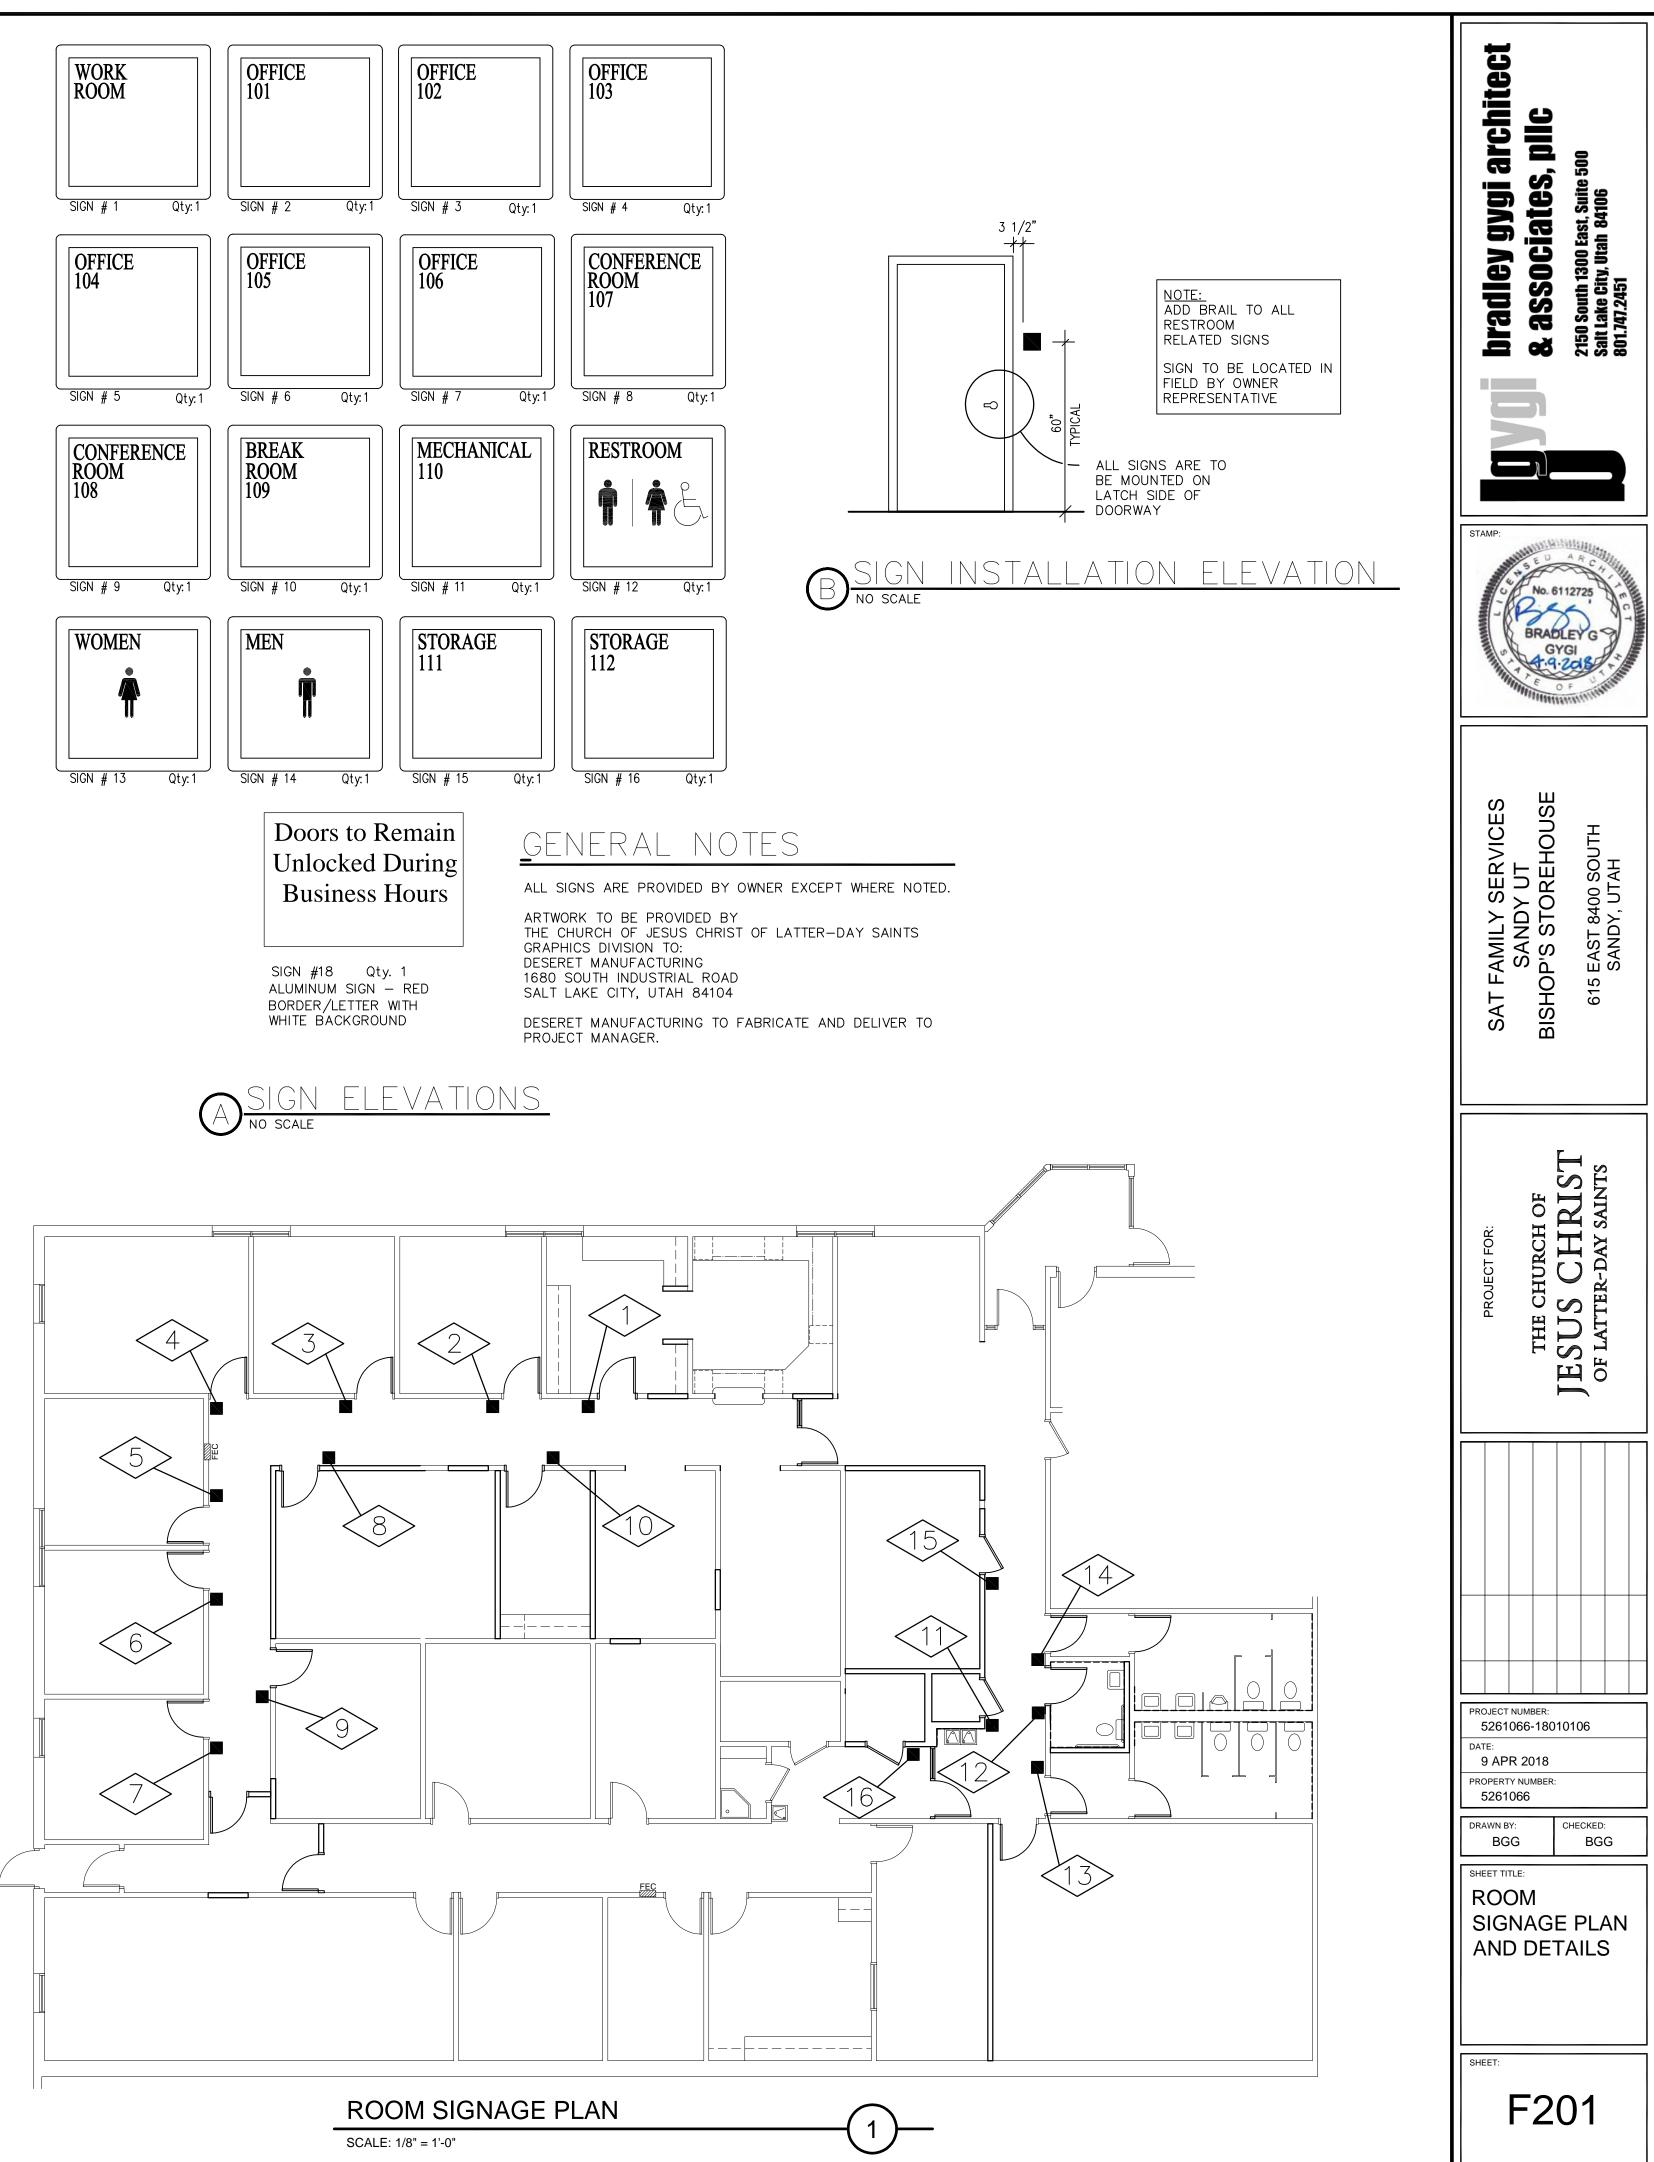


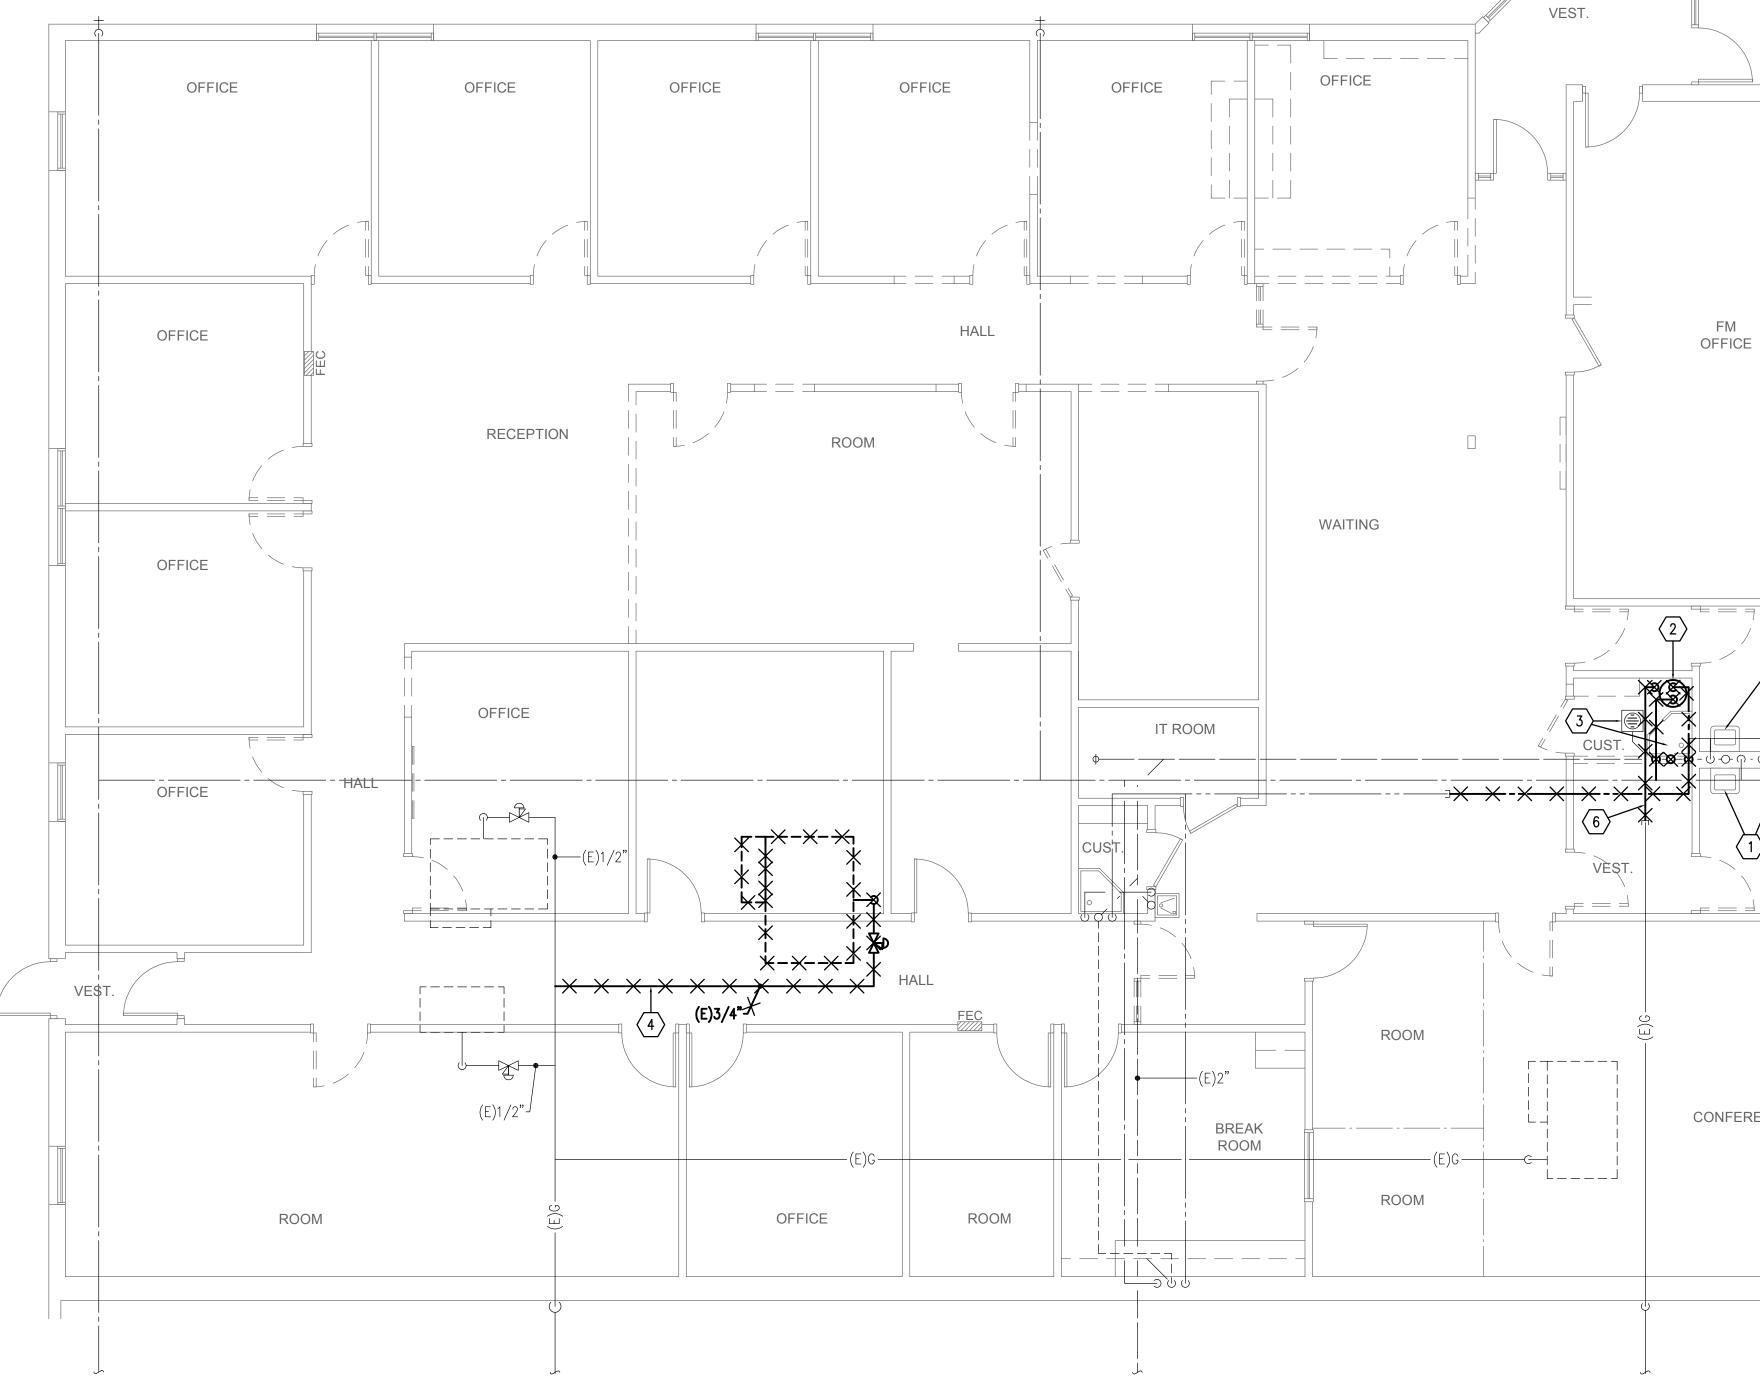

SCALE: 3/16" = 1'-0"

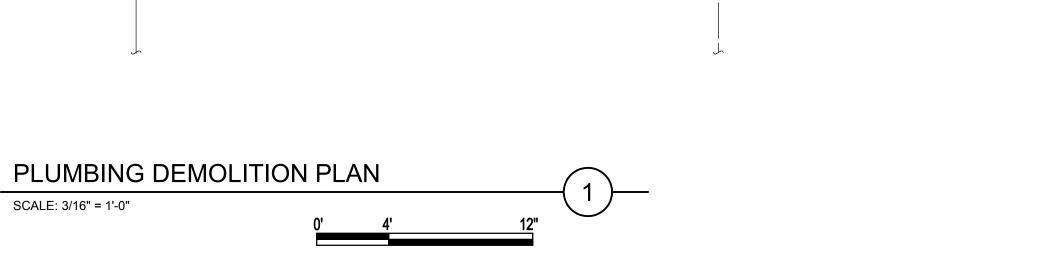

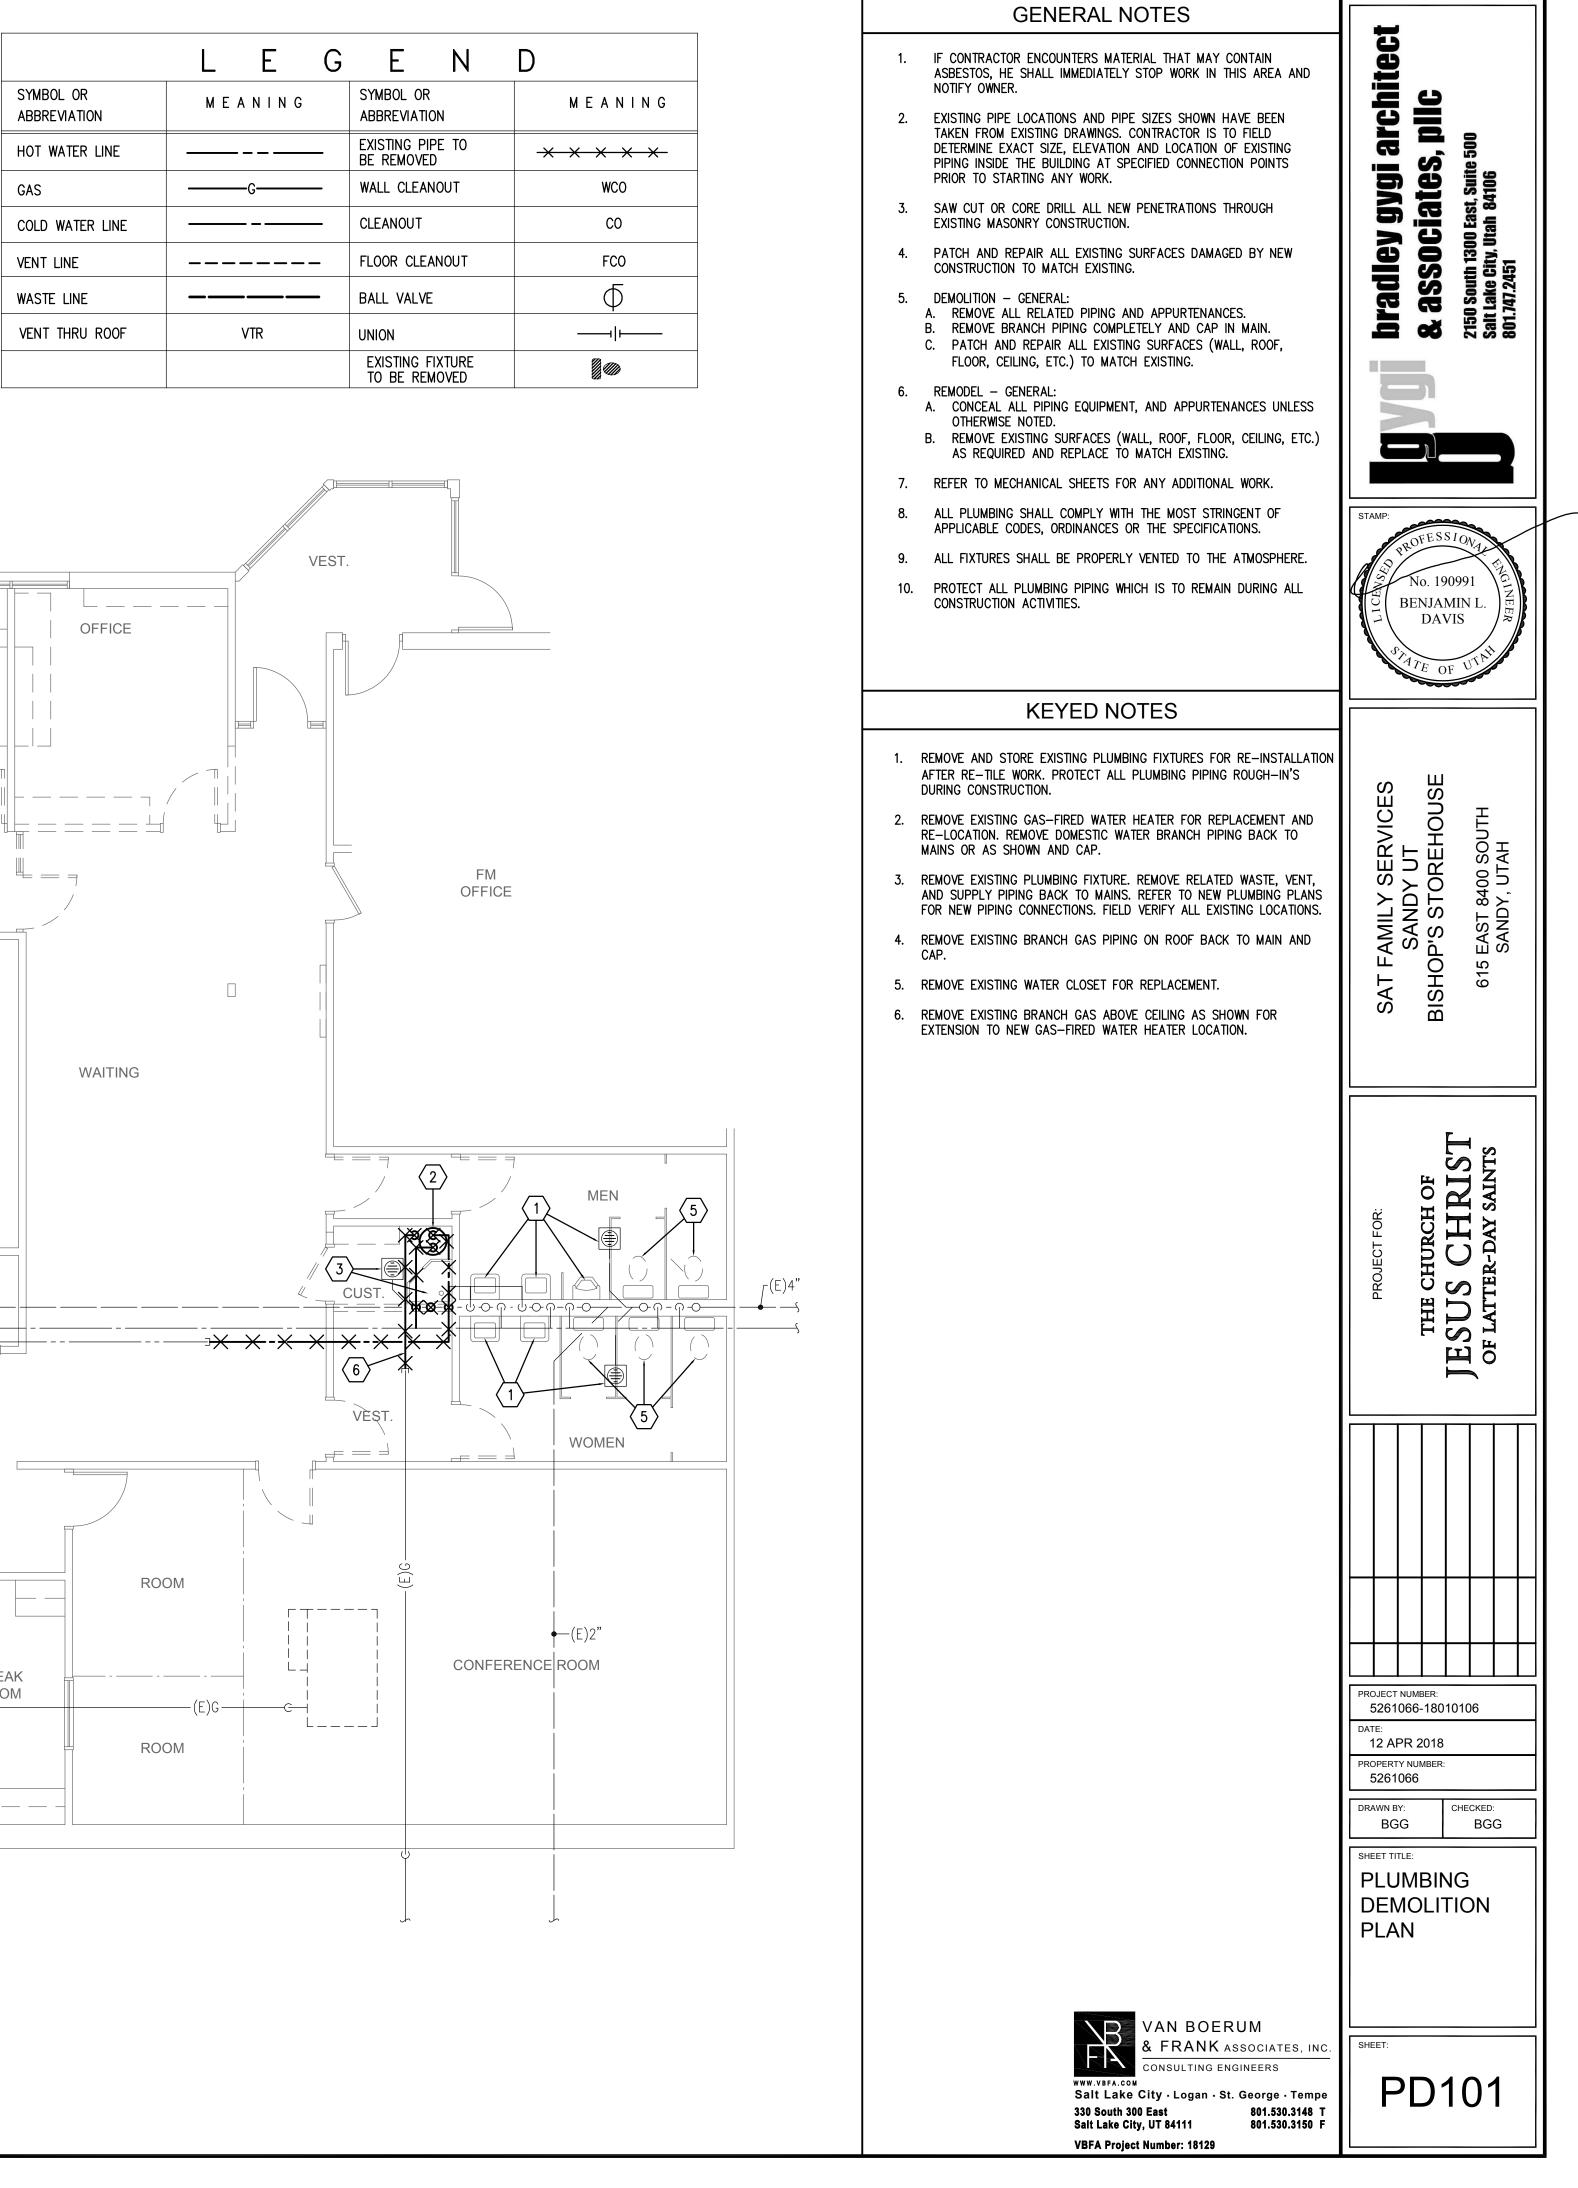

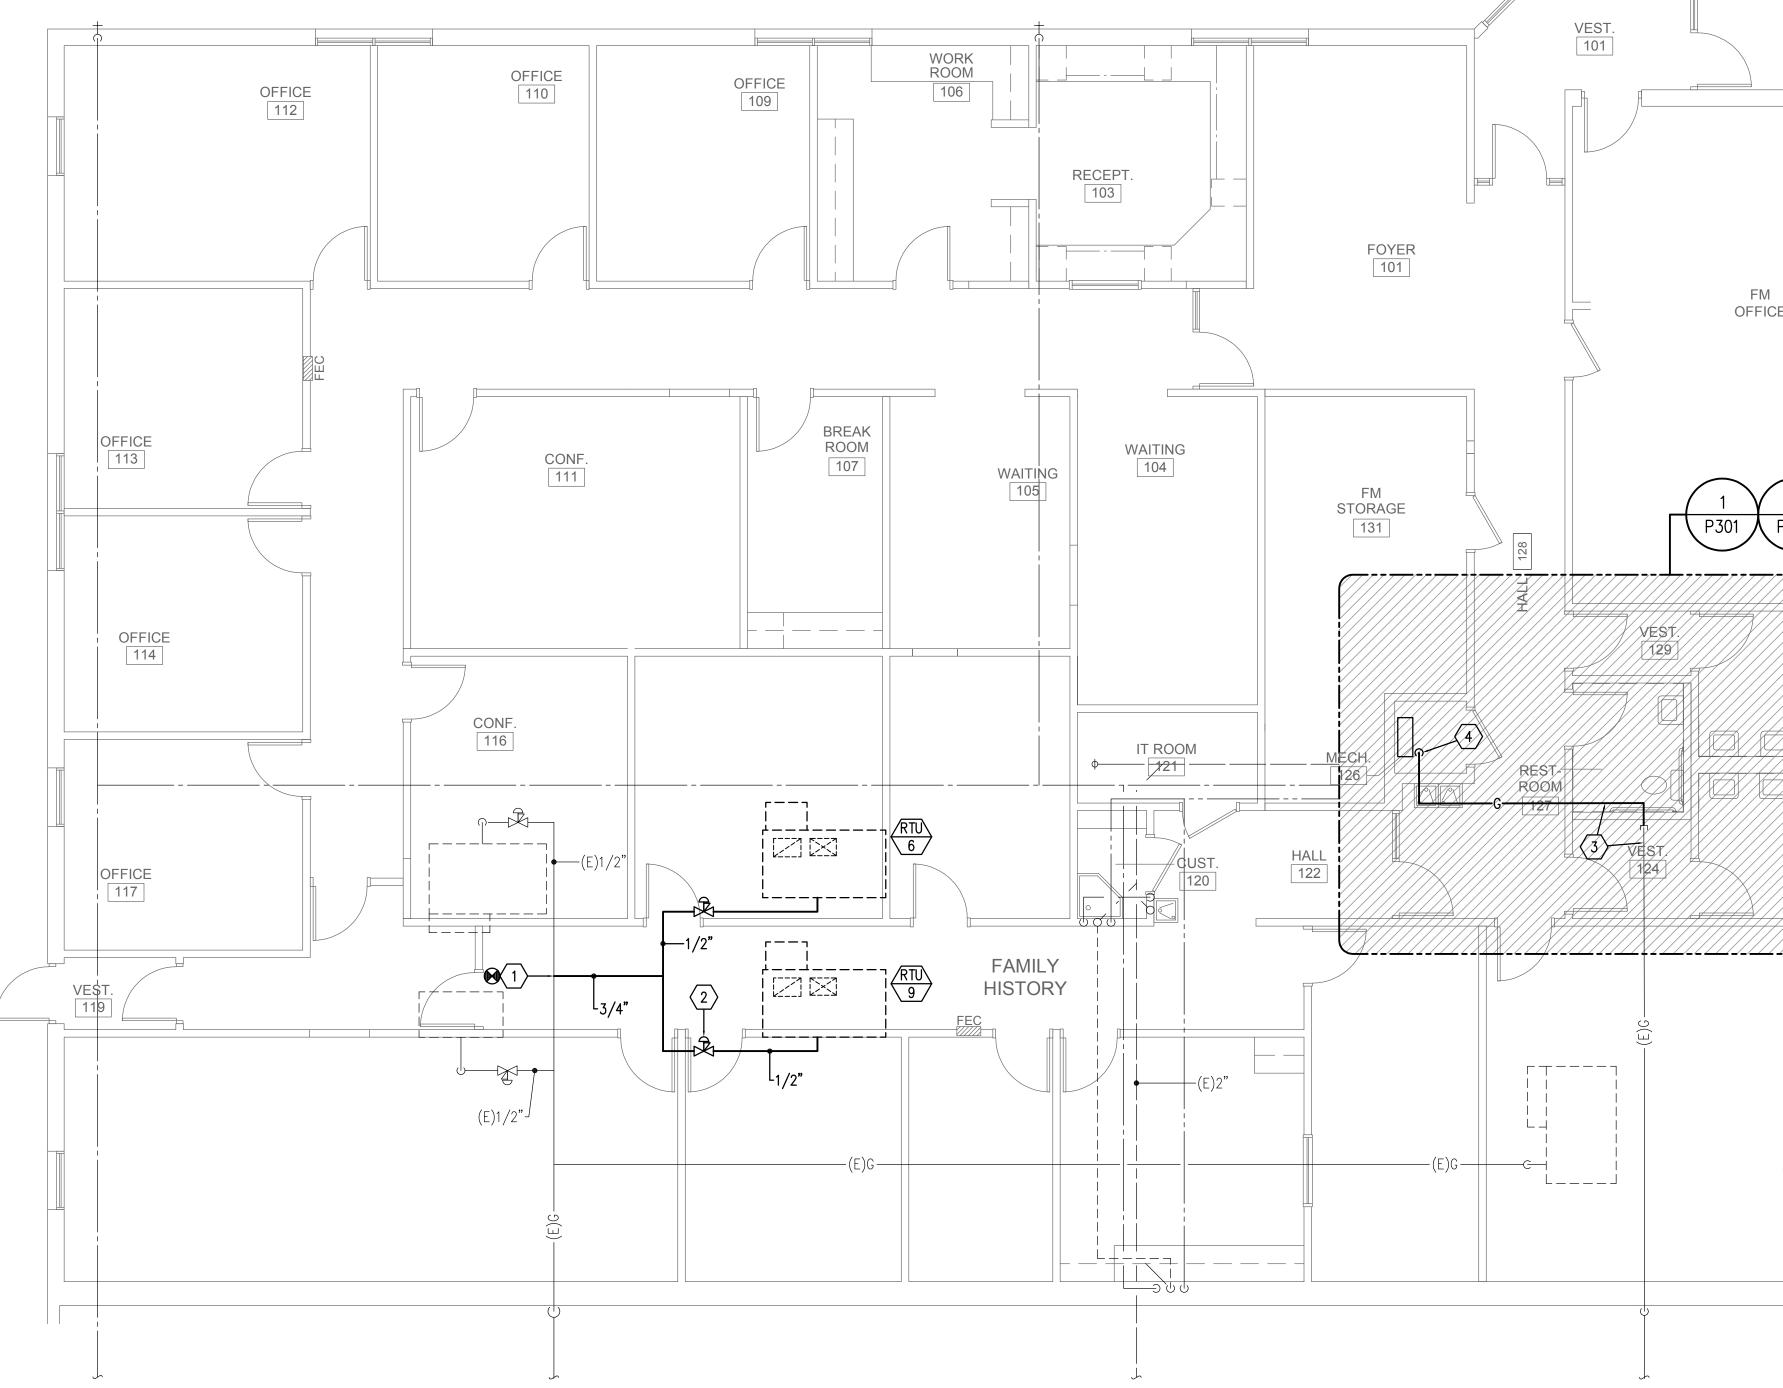


PLUMBING PLAN SCALE: 3/16" = 1'-0"




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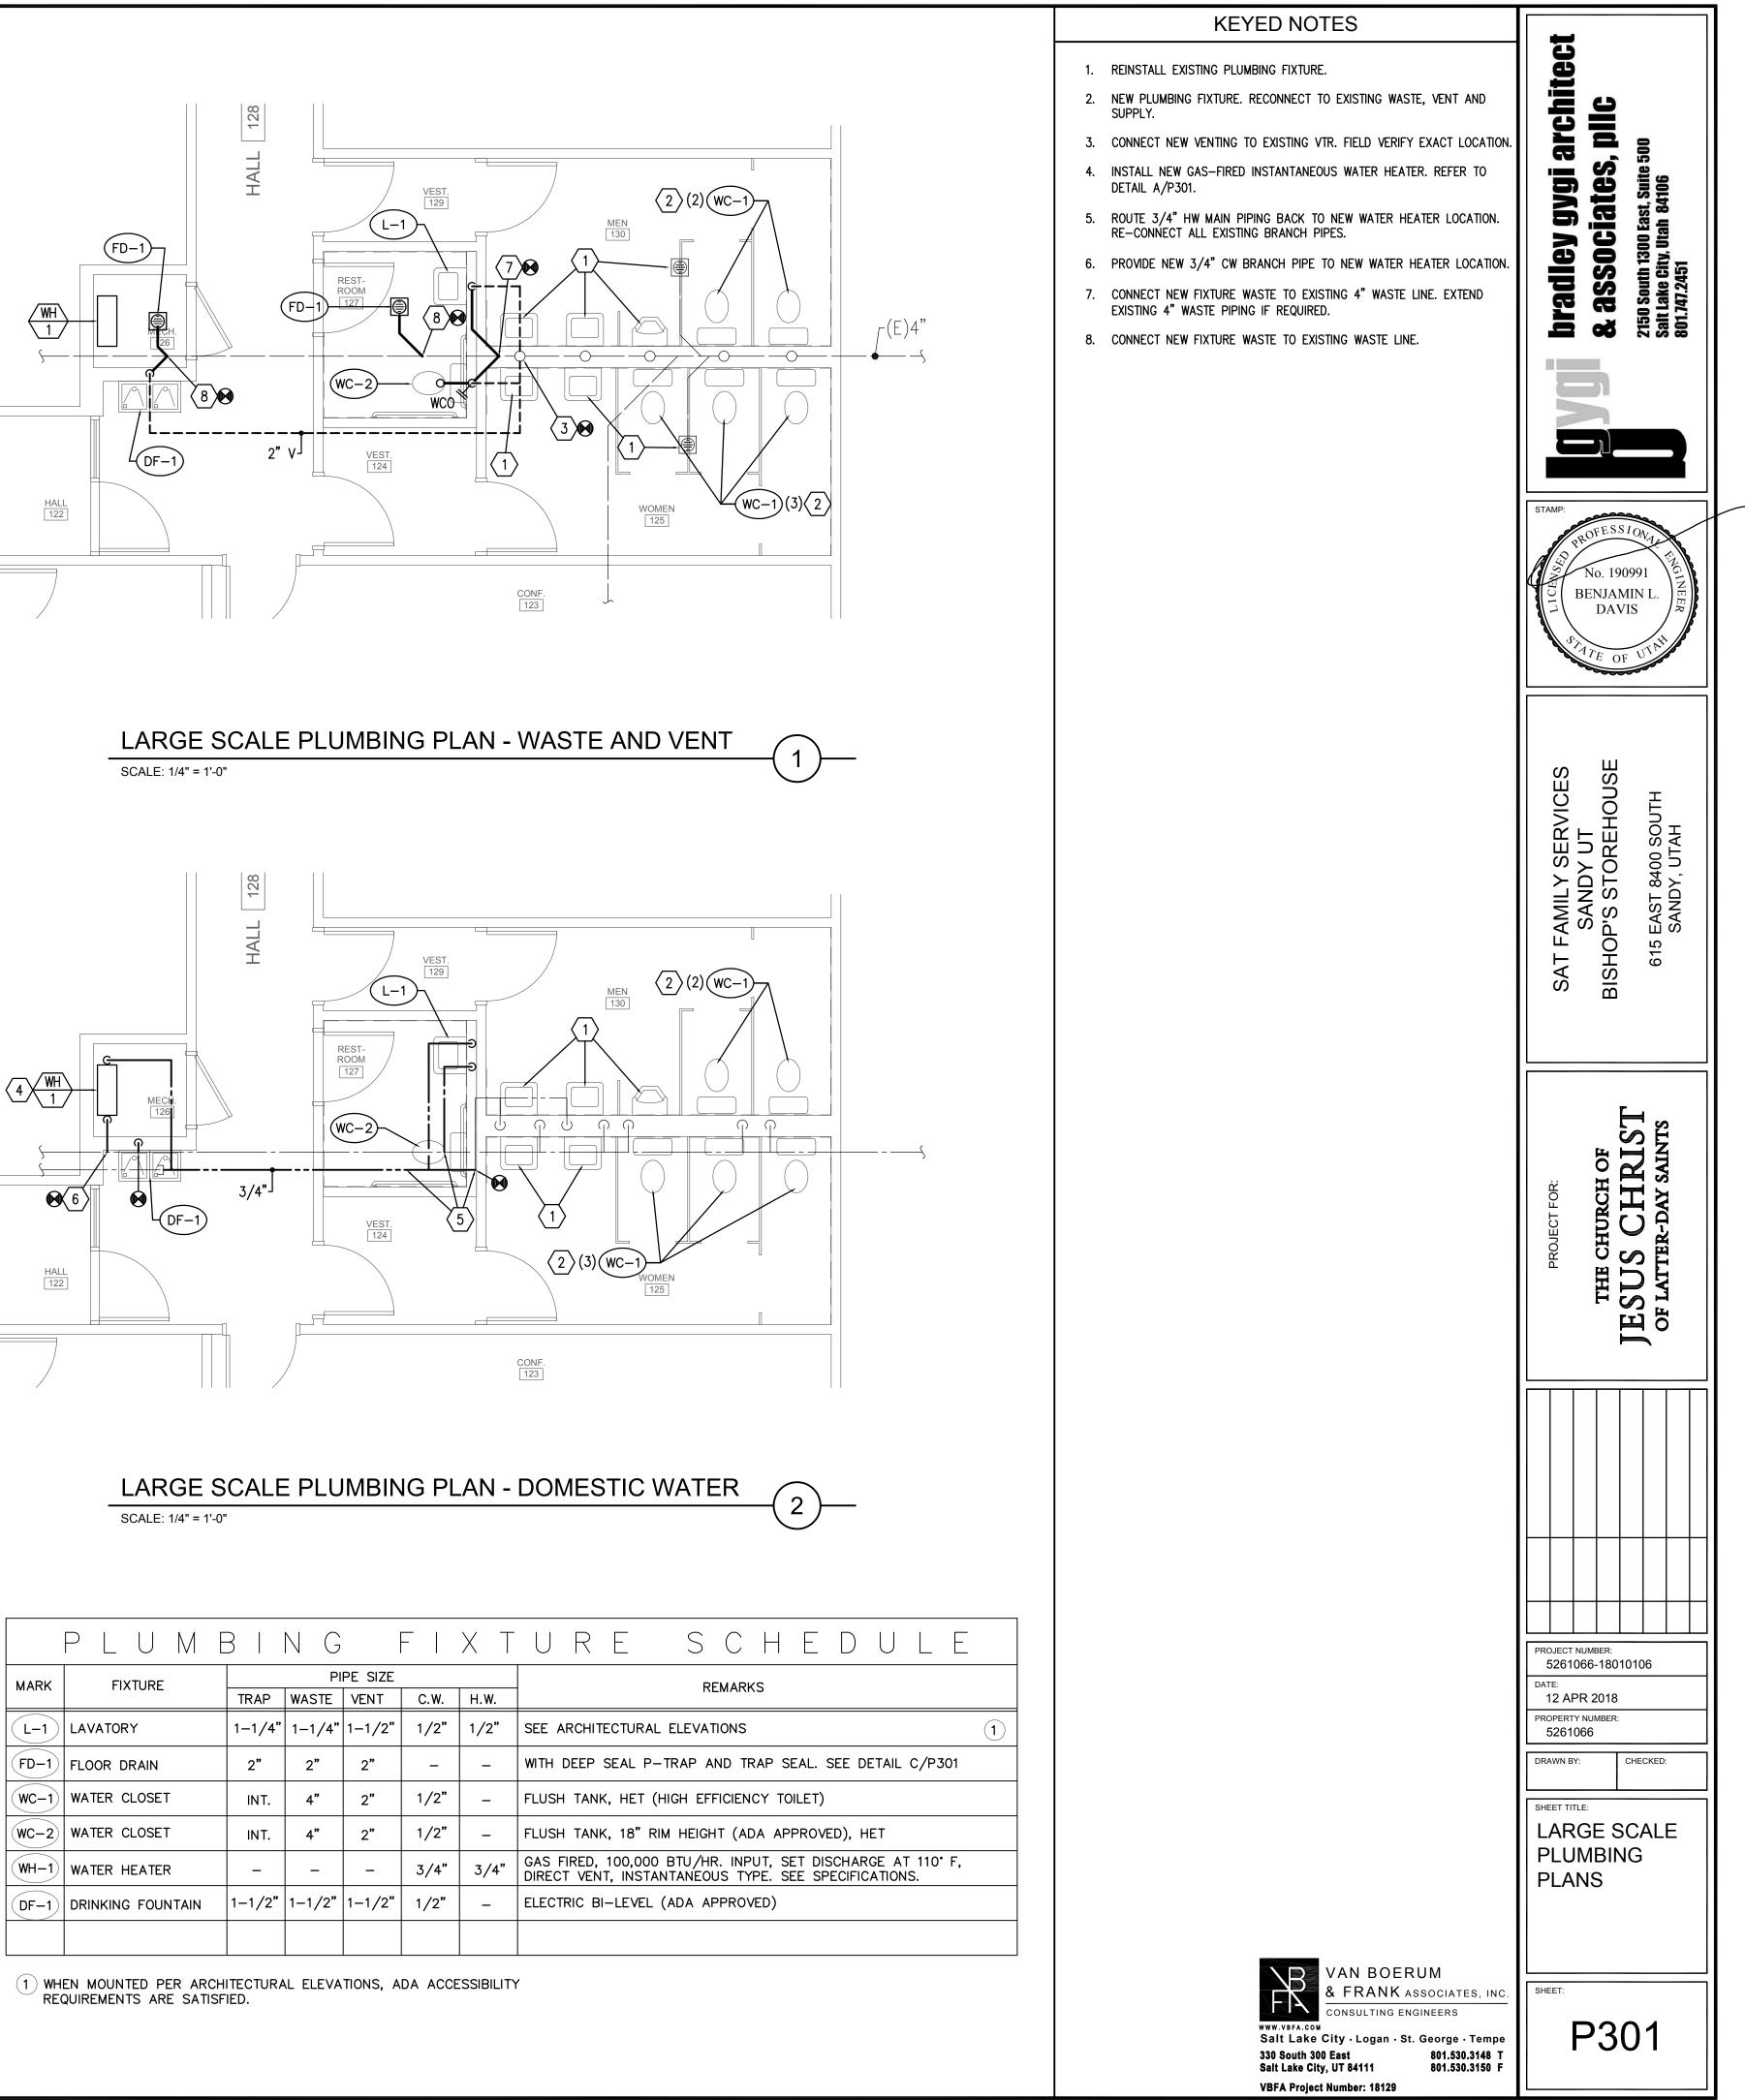
	KEYED NOTES	[]
	 CONNECT NEW 3/4" GAS LINE TO EXISTING ON ROOF AND ROUTE TO NEW RTU'S. NEW GAS REGULATOR (2 PSI TO 4 OZ.), TYPICAL. EXTEND EXISTING 1/2" (2 PSI) GAS BRANCH PIPING ABOVE CEILING TO NEW WATER HEATER LOCATION. DROP 1/2" GAS BRANCH PIPING DOWN TO NEW WATER HEATER. PROVIDE 2 PSI TO 4 OZ. PRESSURE REGULATOR. 	Bradley gygi architect & associates, pllc 2150 South 1300 East, Suite 500 Salt Lake City, Utah 84106 801.747.2451
E		STAME: No. 190991 BENJAMIN L. DAVIS SANDY UT BISHOP'S STOREHOUSE BISHOP'S STOREHOUSE BISHOP'S STOREHOUSE 615 EAST 8400 SOUTH SANDY, UTAH 615 EAST 8400 SOUTH SANDY, UTAH
2 P301		PROJECT FOR: THE CHURCH OF JESUS CHRIST OF LATTER-DAY SAINTS
CONF. 123		PROJECT NUMBER: 5261066-18010106 DATE: 12 APR 2018 PROPERTY NUMBER: 5261066 DRAWN BY: BGG CHECKED: BGG SHEET TITLE: PLUMBING PLANS
	VAN BOERUM & FRANK ASSOCIATES, INC. CONSULTING ENGINEERS WWW.VBFA.COM Salt Lake City - Logan - St. George - Tempe 330 South 300 East Salt Lake City, UT 84111 801.530.3148 T Salt Lake City, UT 84111 801.530.3150 F	SHEET: P101



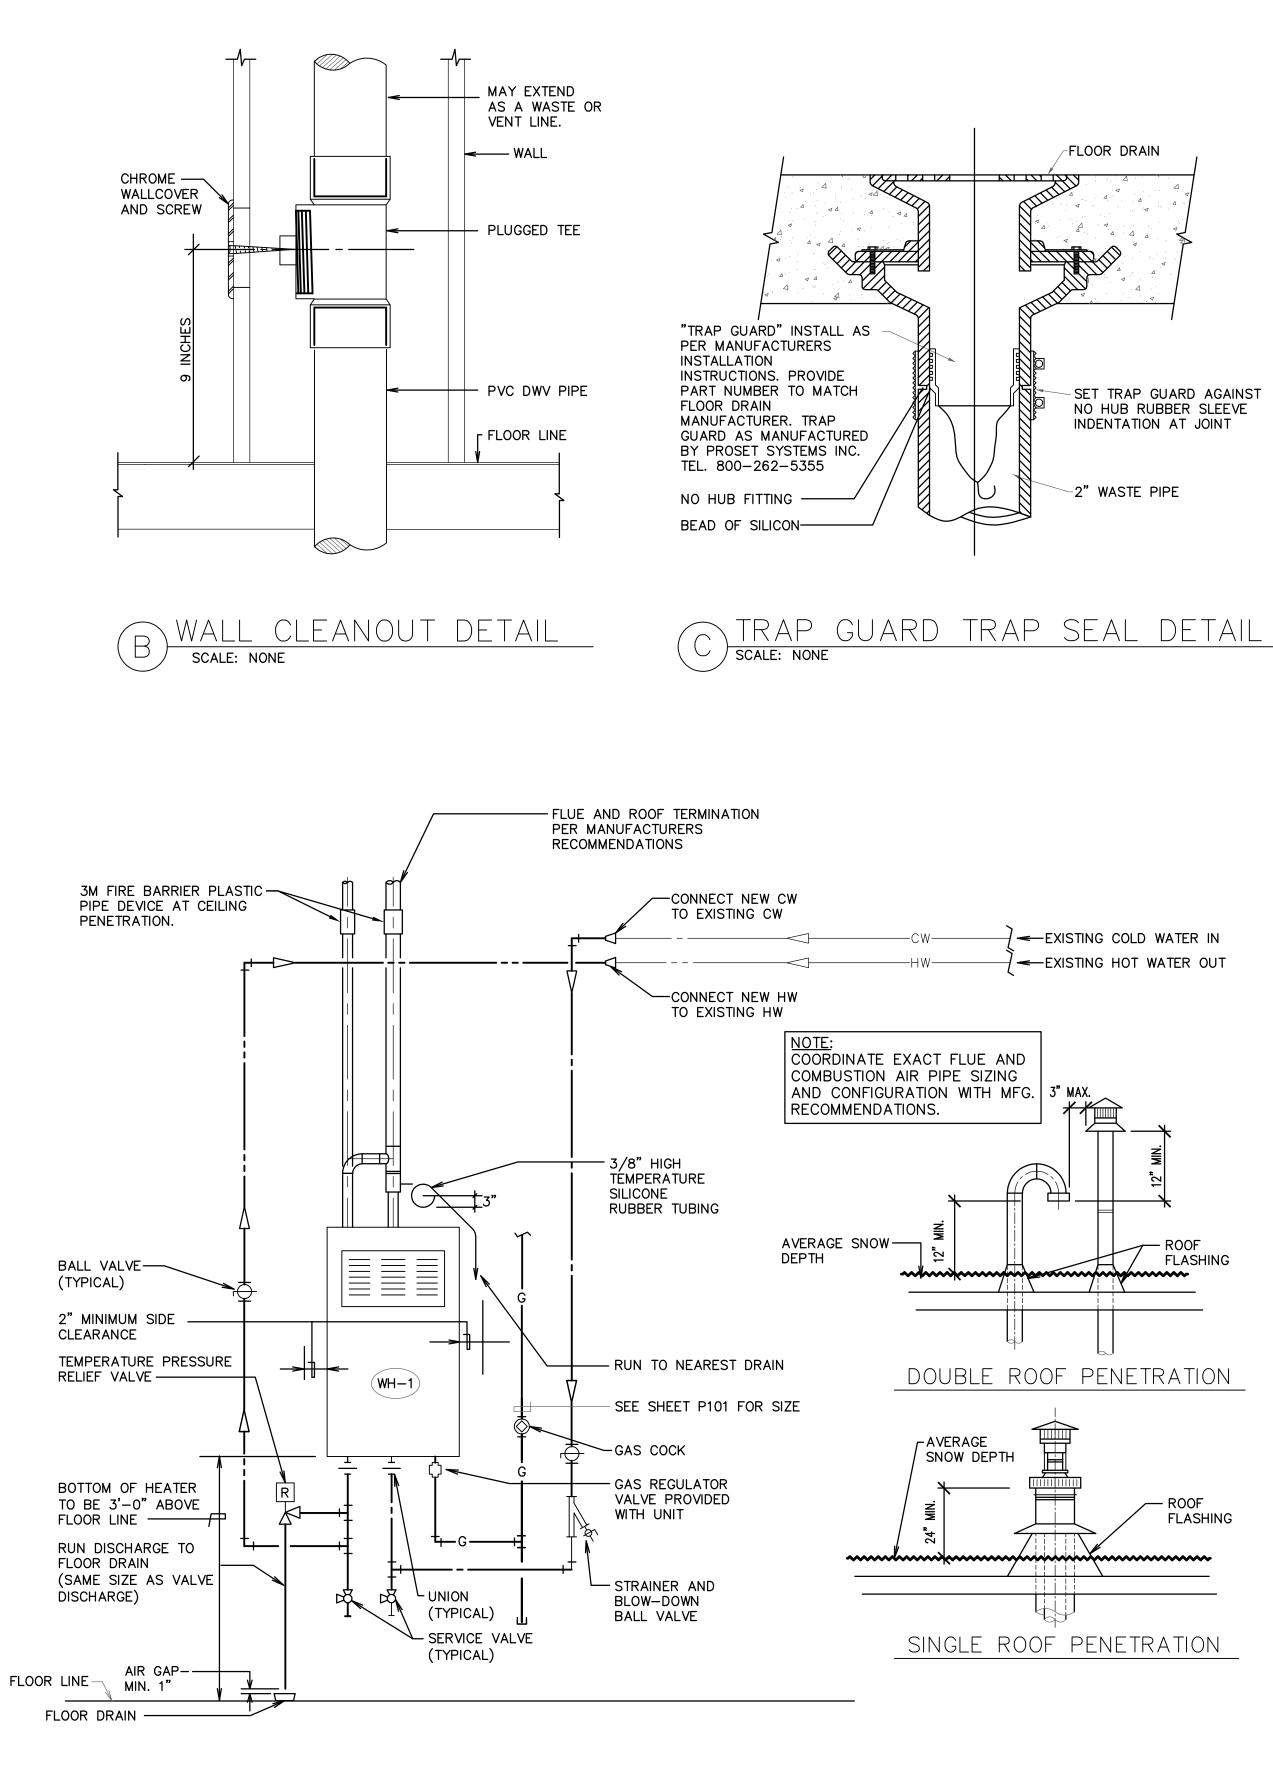


- SET TRAP GUARD AGAINST NO HUB RUBBER SLEEVE INDENTATION AT JOINT



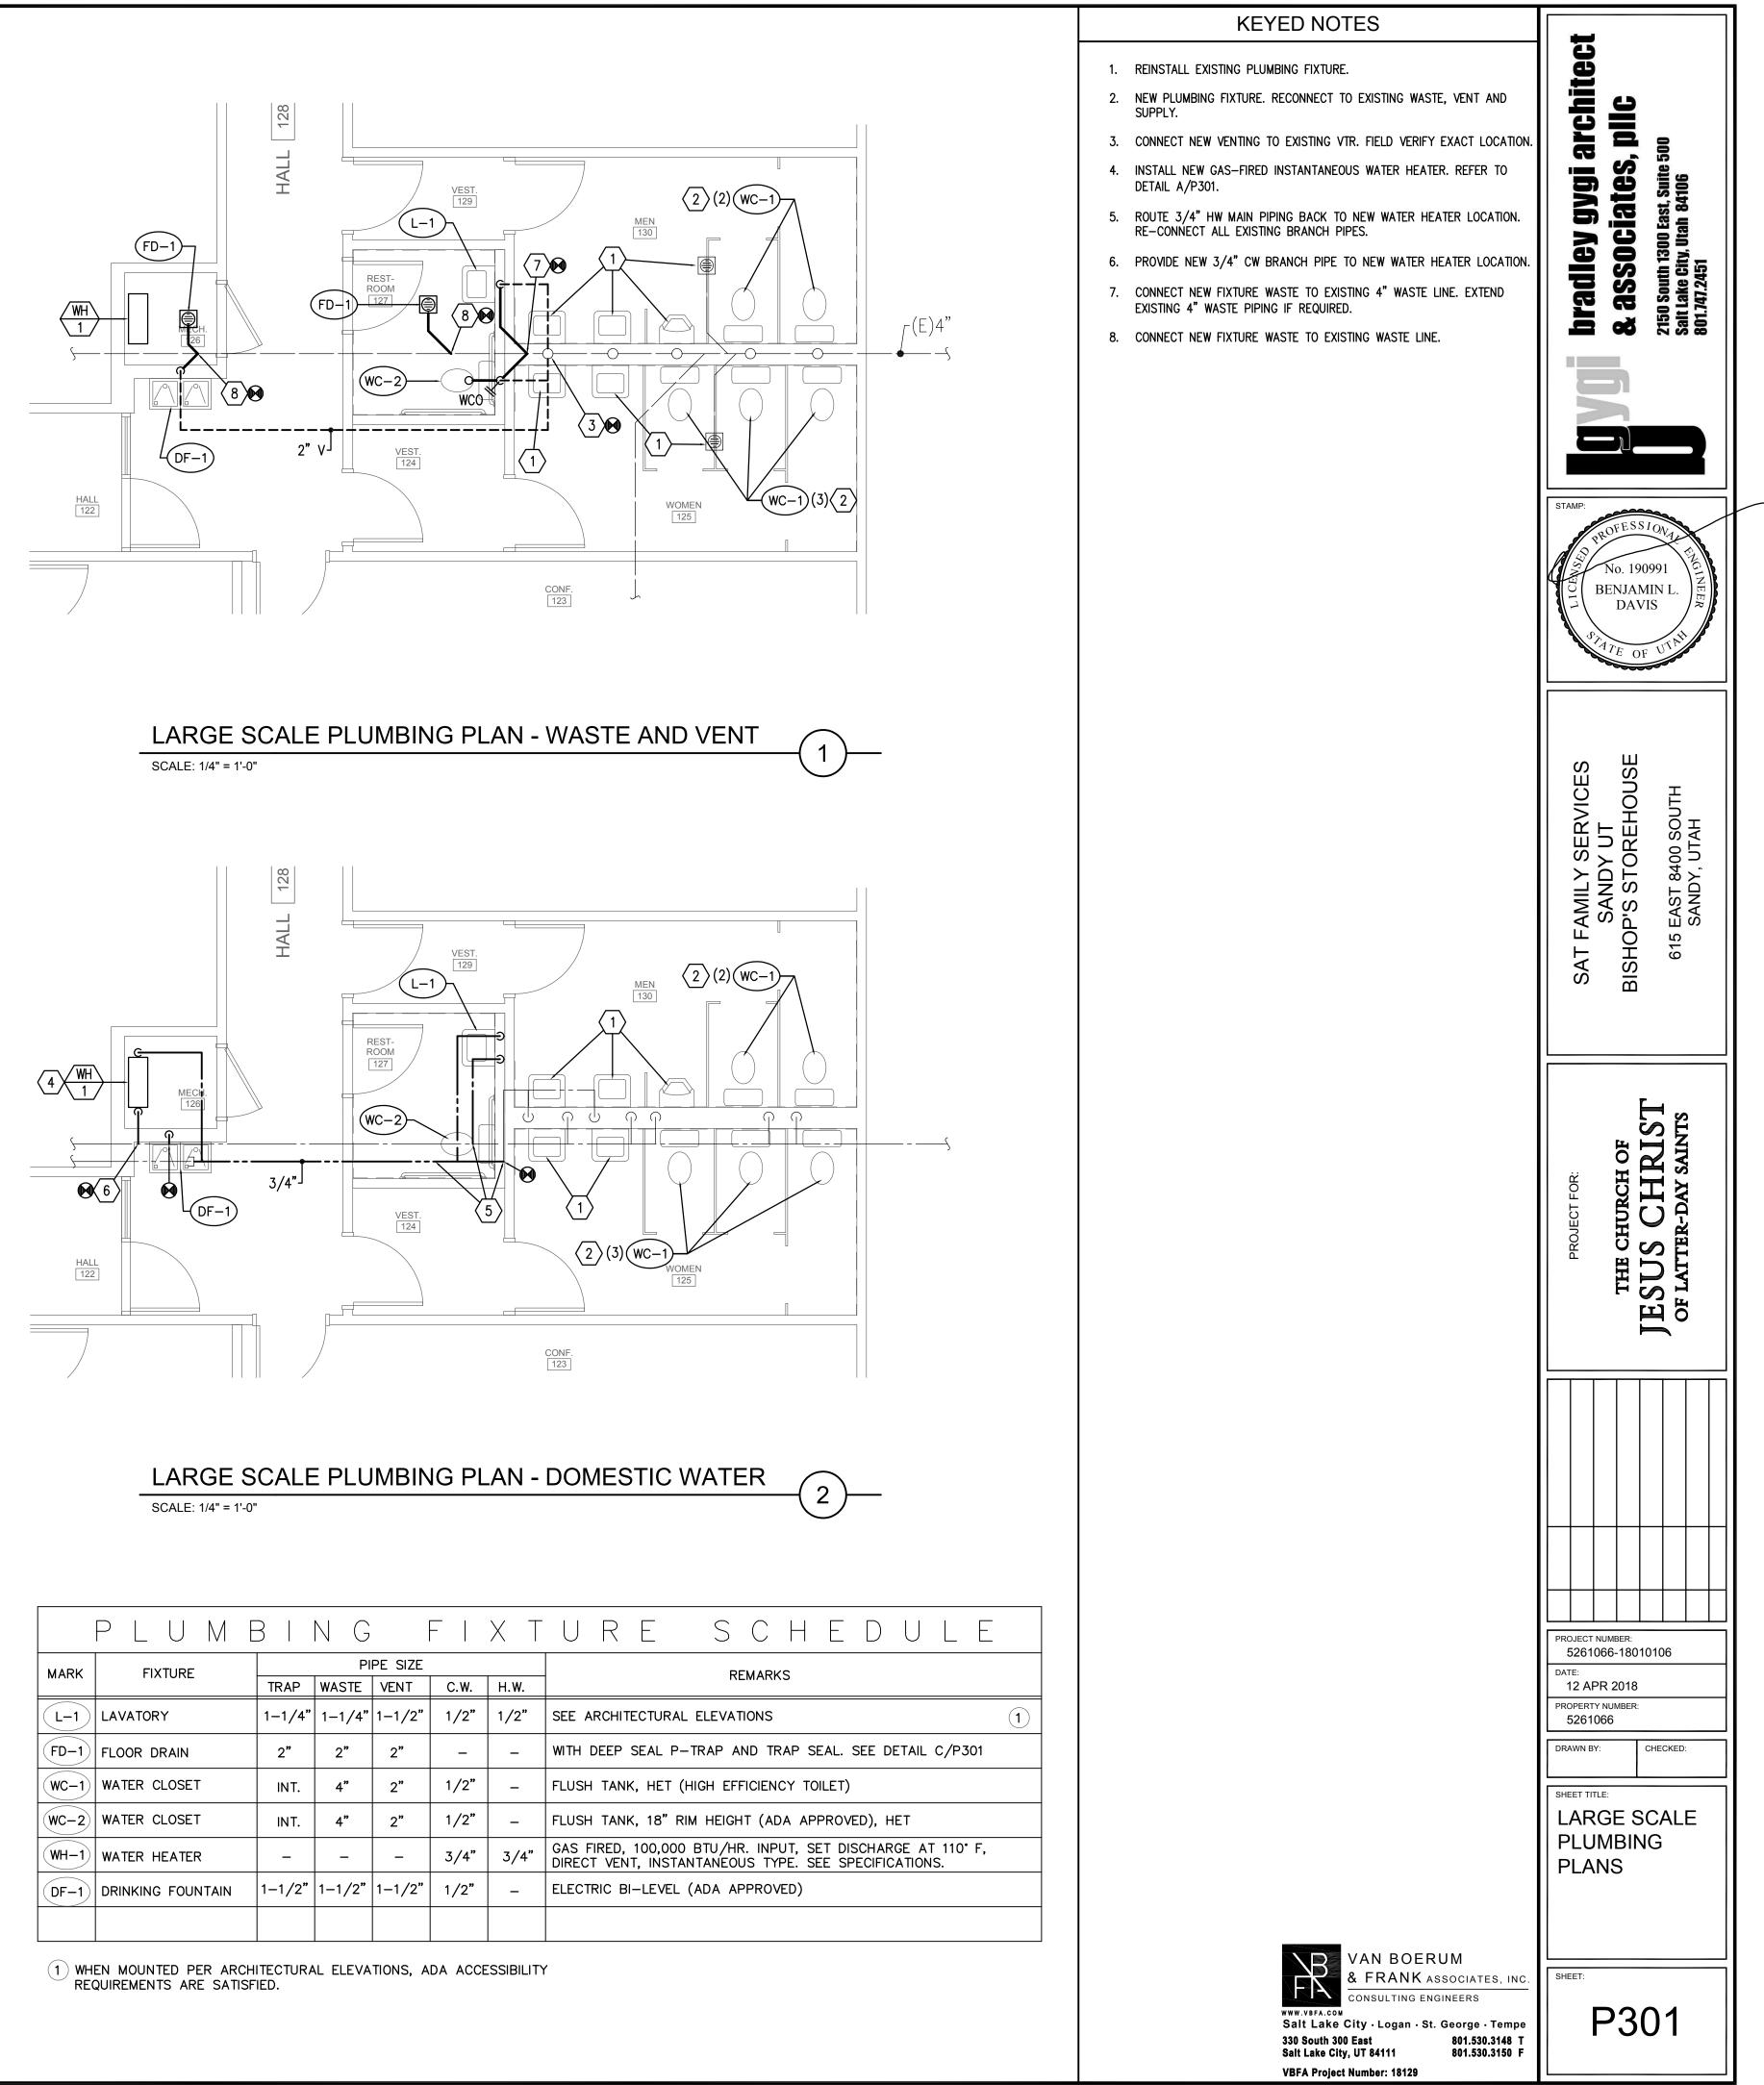



	PLUME	3	N G		-	ХТ	URE SC
MARK	FIXTURE		PI	PE SIZE			REMA
		TRAP	WASTE	VENT	C.W.	Н.W.	
L-1	LAVATORY	1-1/4"	1-1/4"	1-1/2"	1/2"	1/2"	SEE ARCHITECTURAL ELEVATION
FD-1	FLOOR DRAIN	2"	2"	2"	_	_	WITH DEEP SEAL P-TRAP AND
WC-1	WATER CLOSET	INT.	4"	2"	1/2"	_	FLUSH TANK, HET (HIGH EFFICIE
WC-2	WATER CLOSET	INT.	4"	2"	1/2"	_	FLUSH TANK, 18" RIM HEIGHT (
WH-1	WATER HEATER	_	_	_	3/4"	3/4"	GAS FIRED, 100,000 BTU/HR. IN DIRECT VENT, INSTANTANEOUS
DF-1	DRINKING FOUNTAIN	1-1/2"	1-1/2"	1-1/2"	1/2"	_	ELECTRIC BI-LEVEL (ADA APPRO

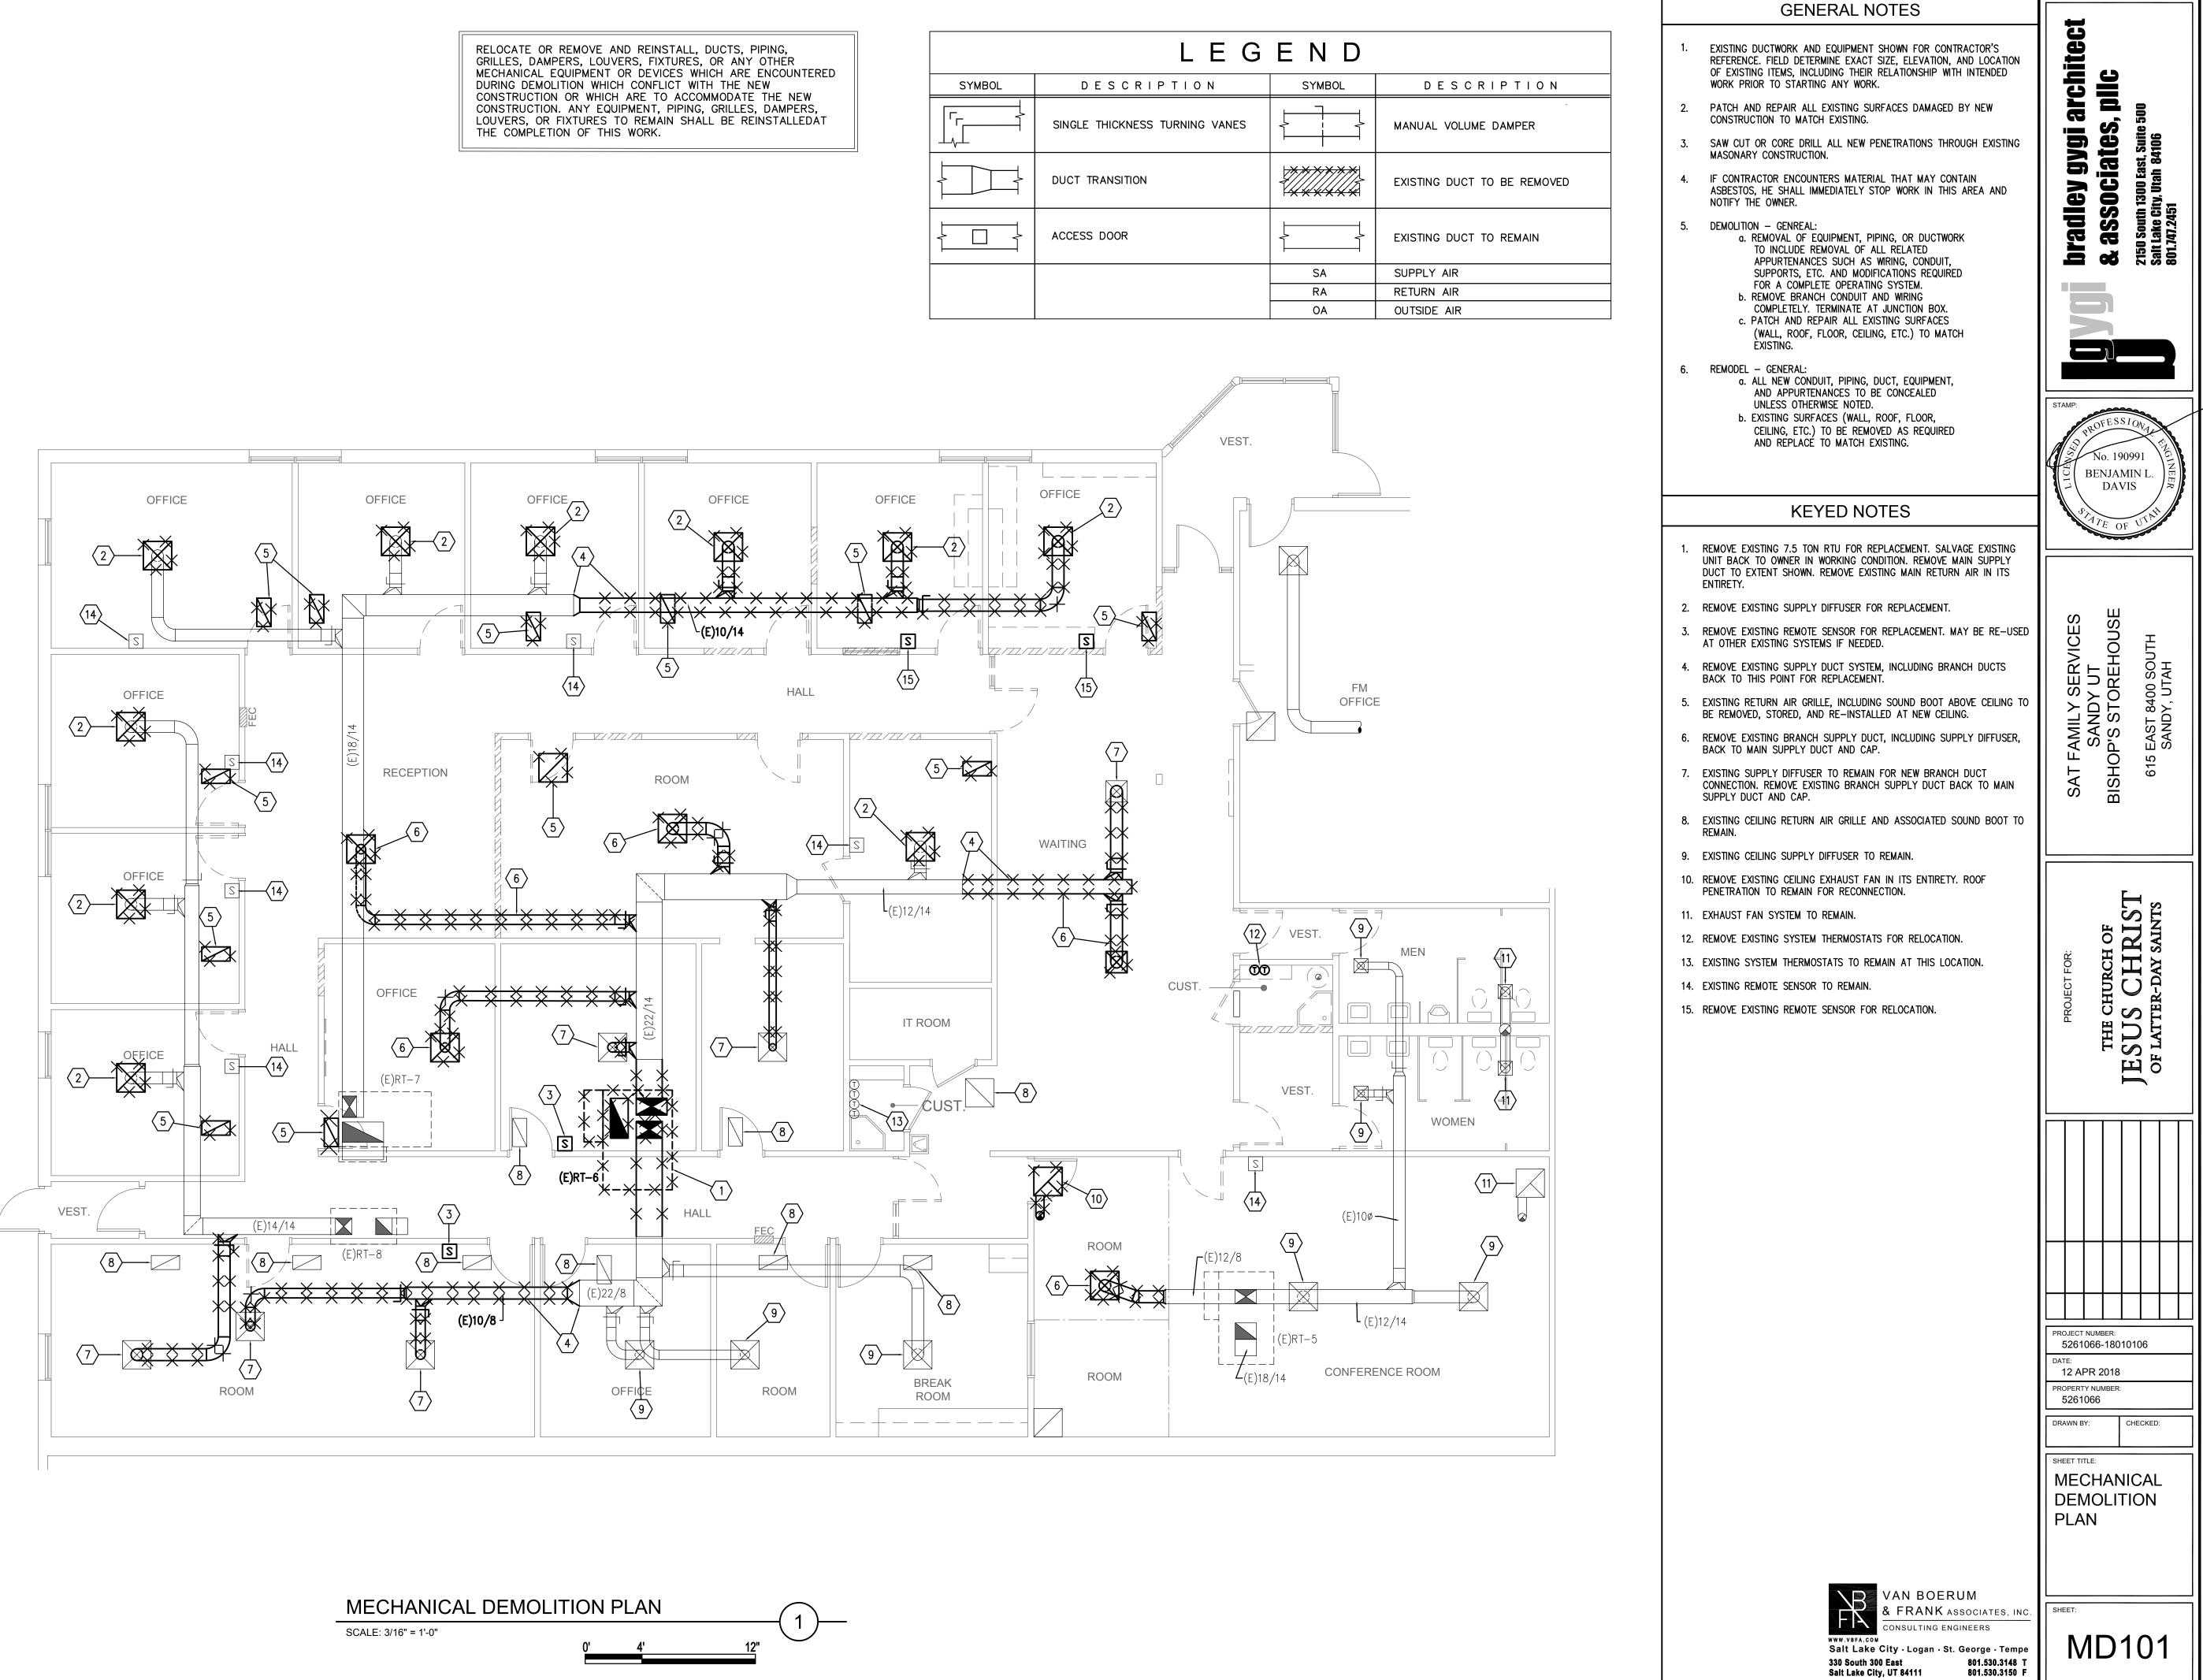


VBFA Project Number: 18129

Image:				
Image: Single thickness turning vanes Image: Single thickness turning vanes Image: Duct transition Image: Single thickness turning vanes		LEG	E N D	
Image: Sinvelle minimum of the sinvel	SYMBOL	DESCRIPTION	SYMBOL	
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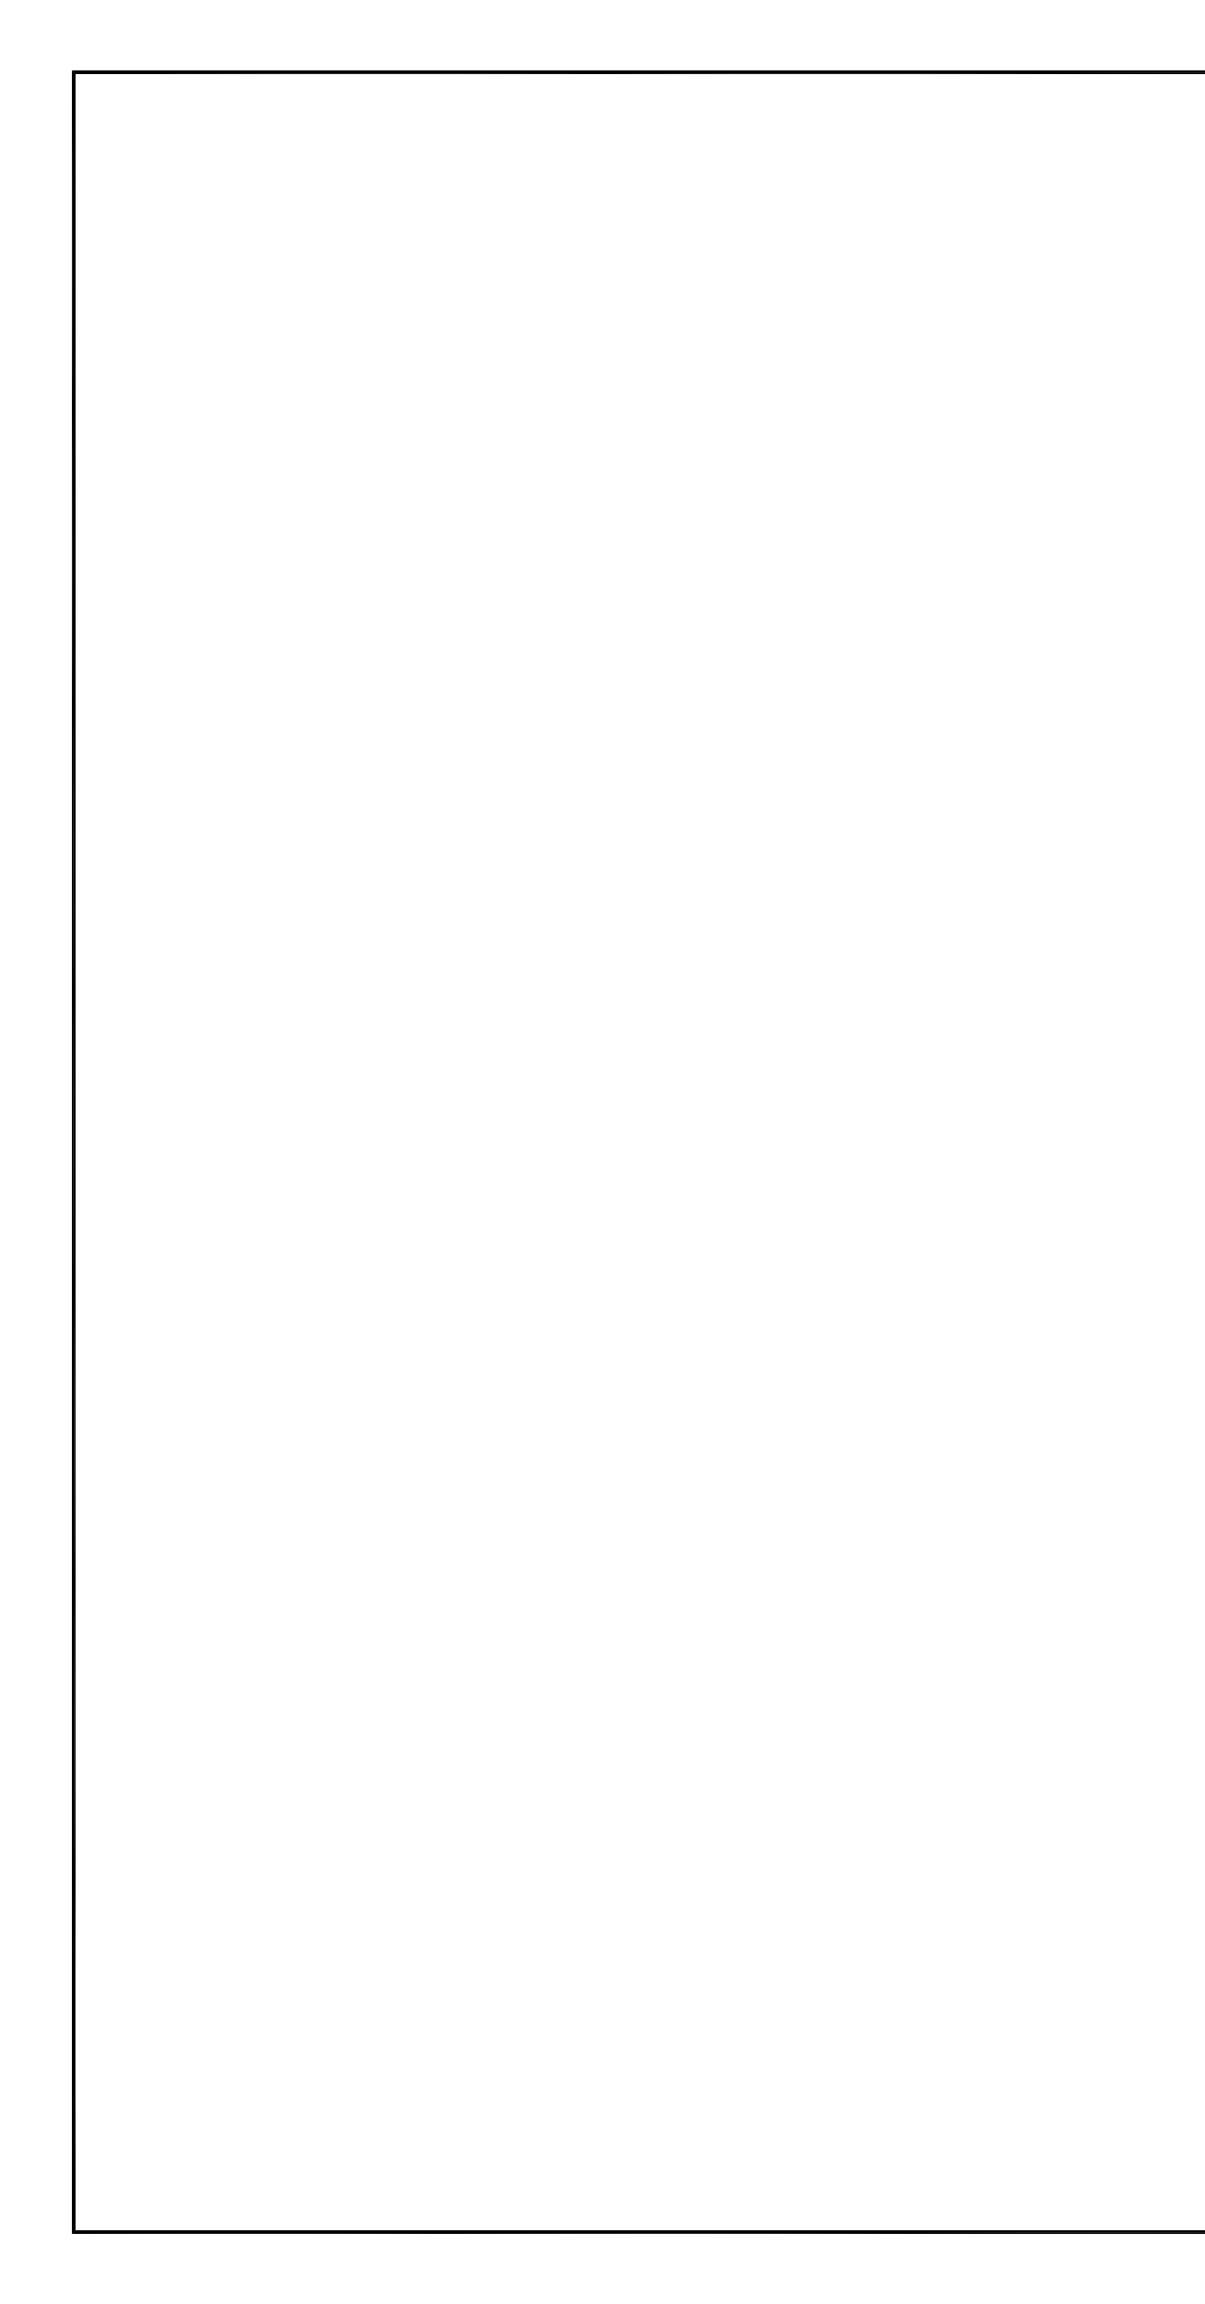
VBFA Project Number: 18129

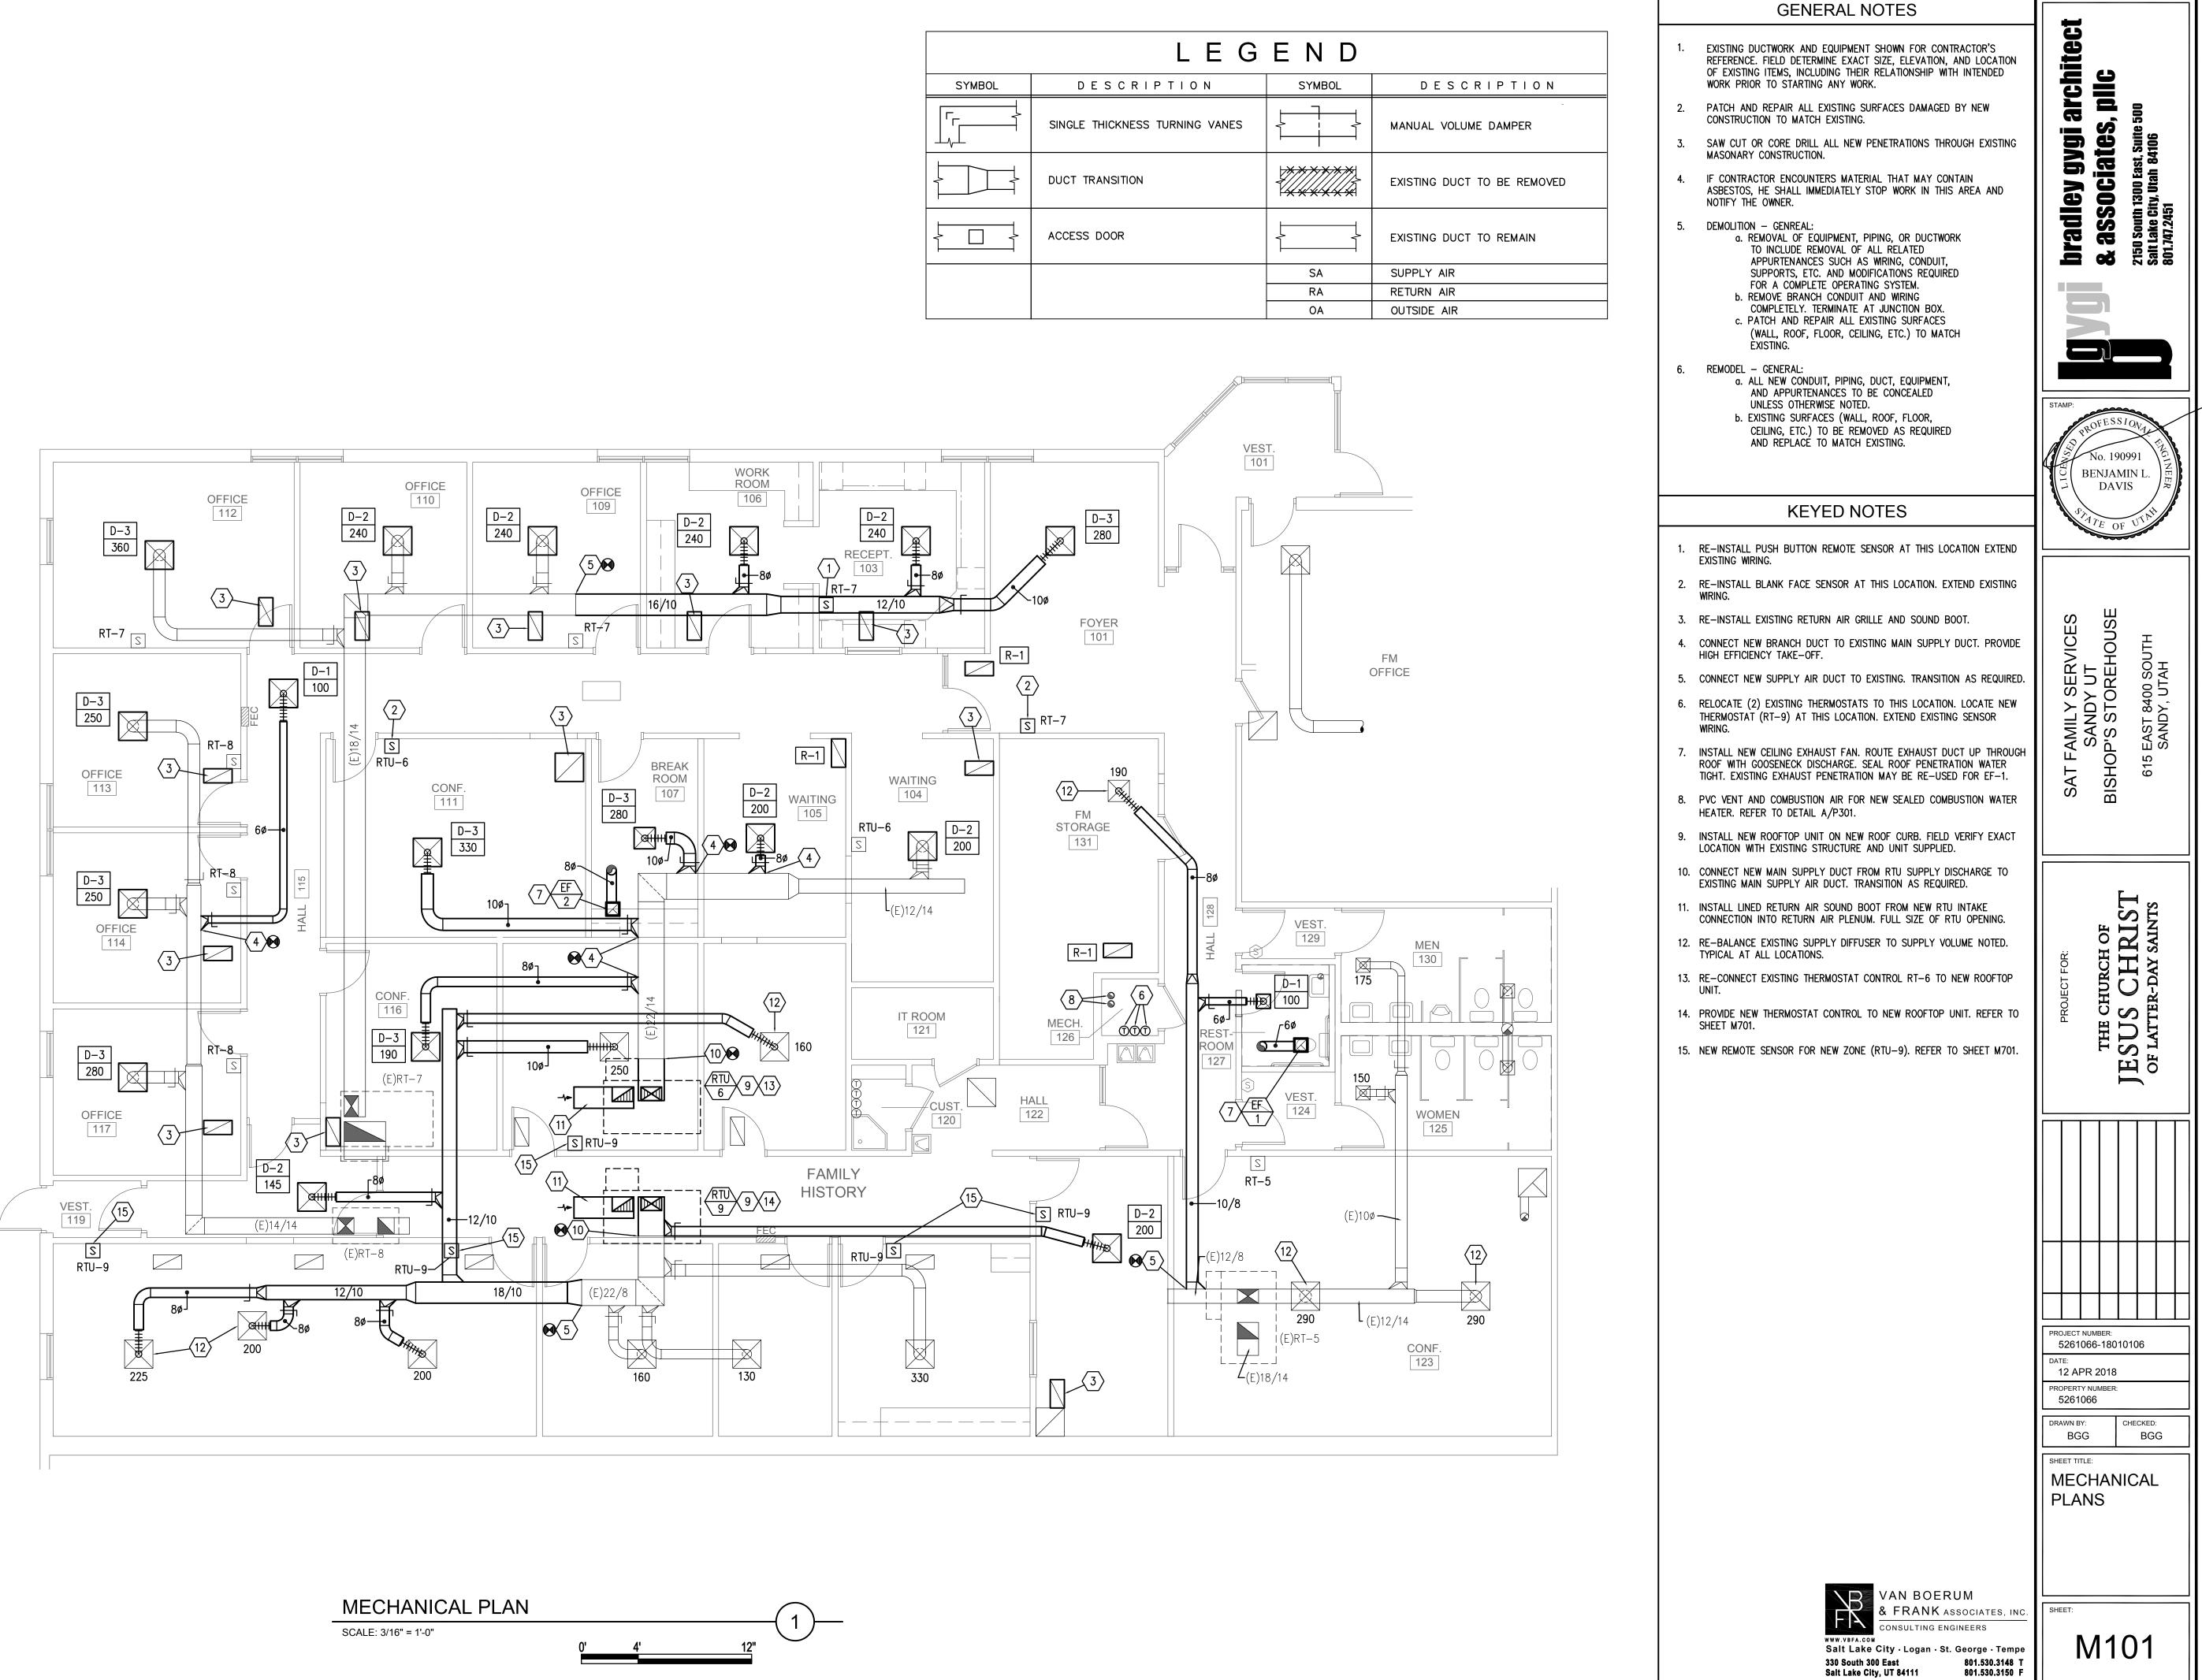

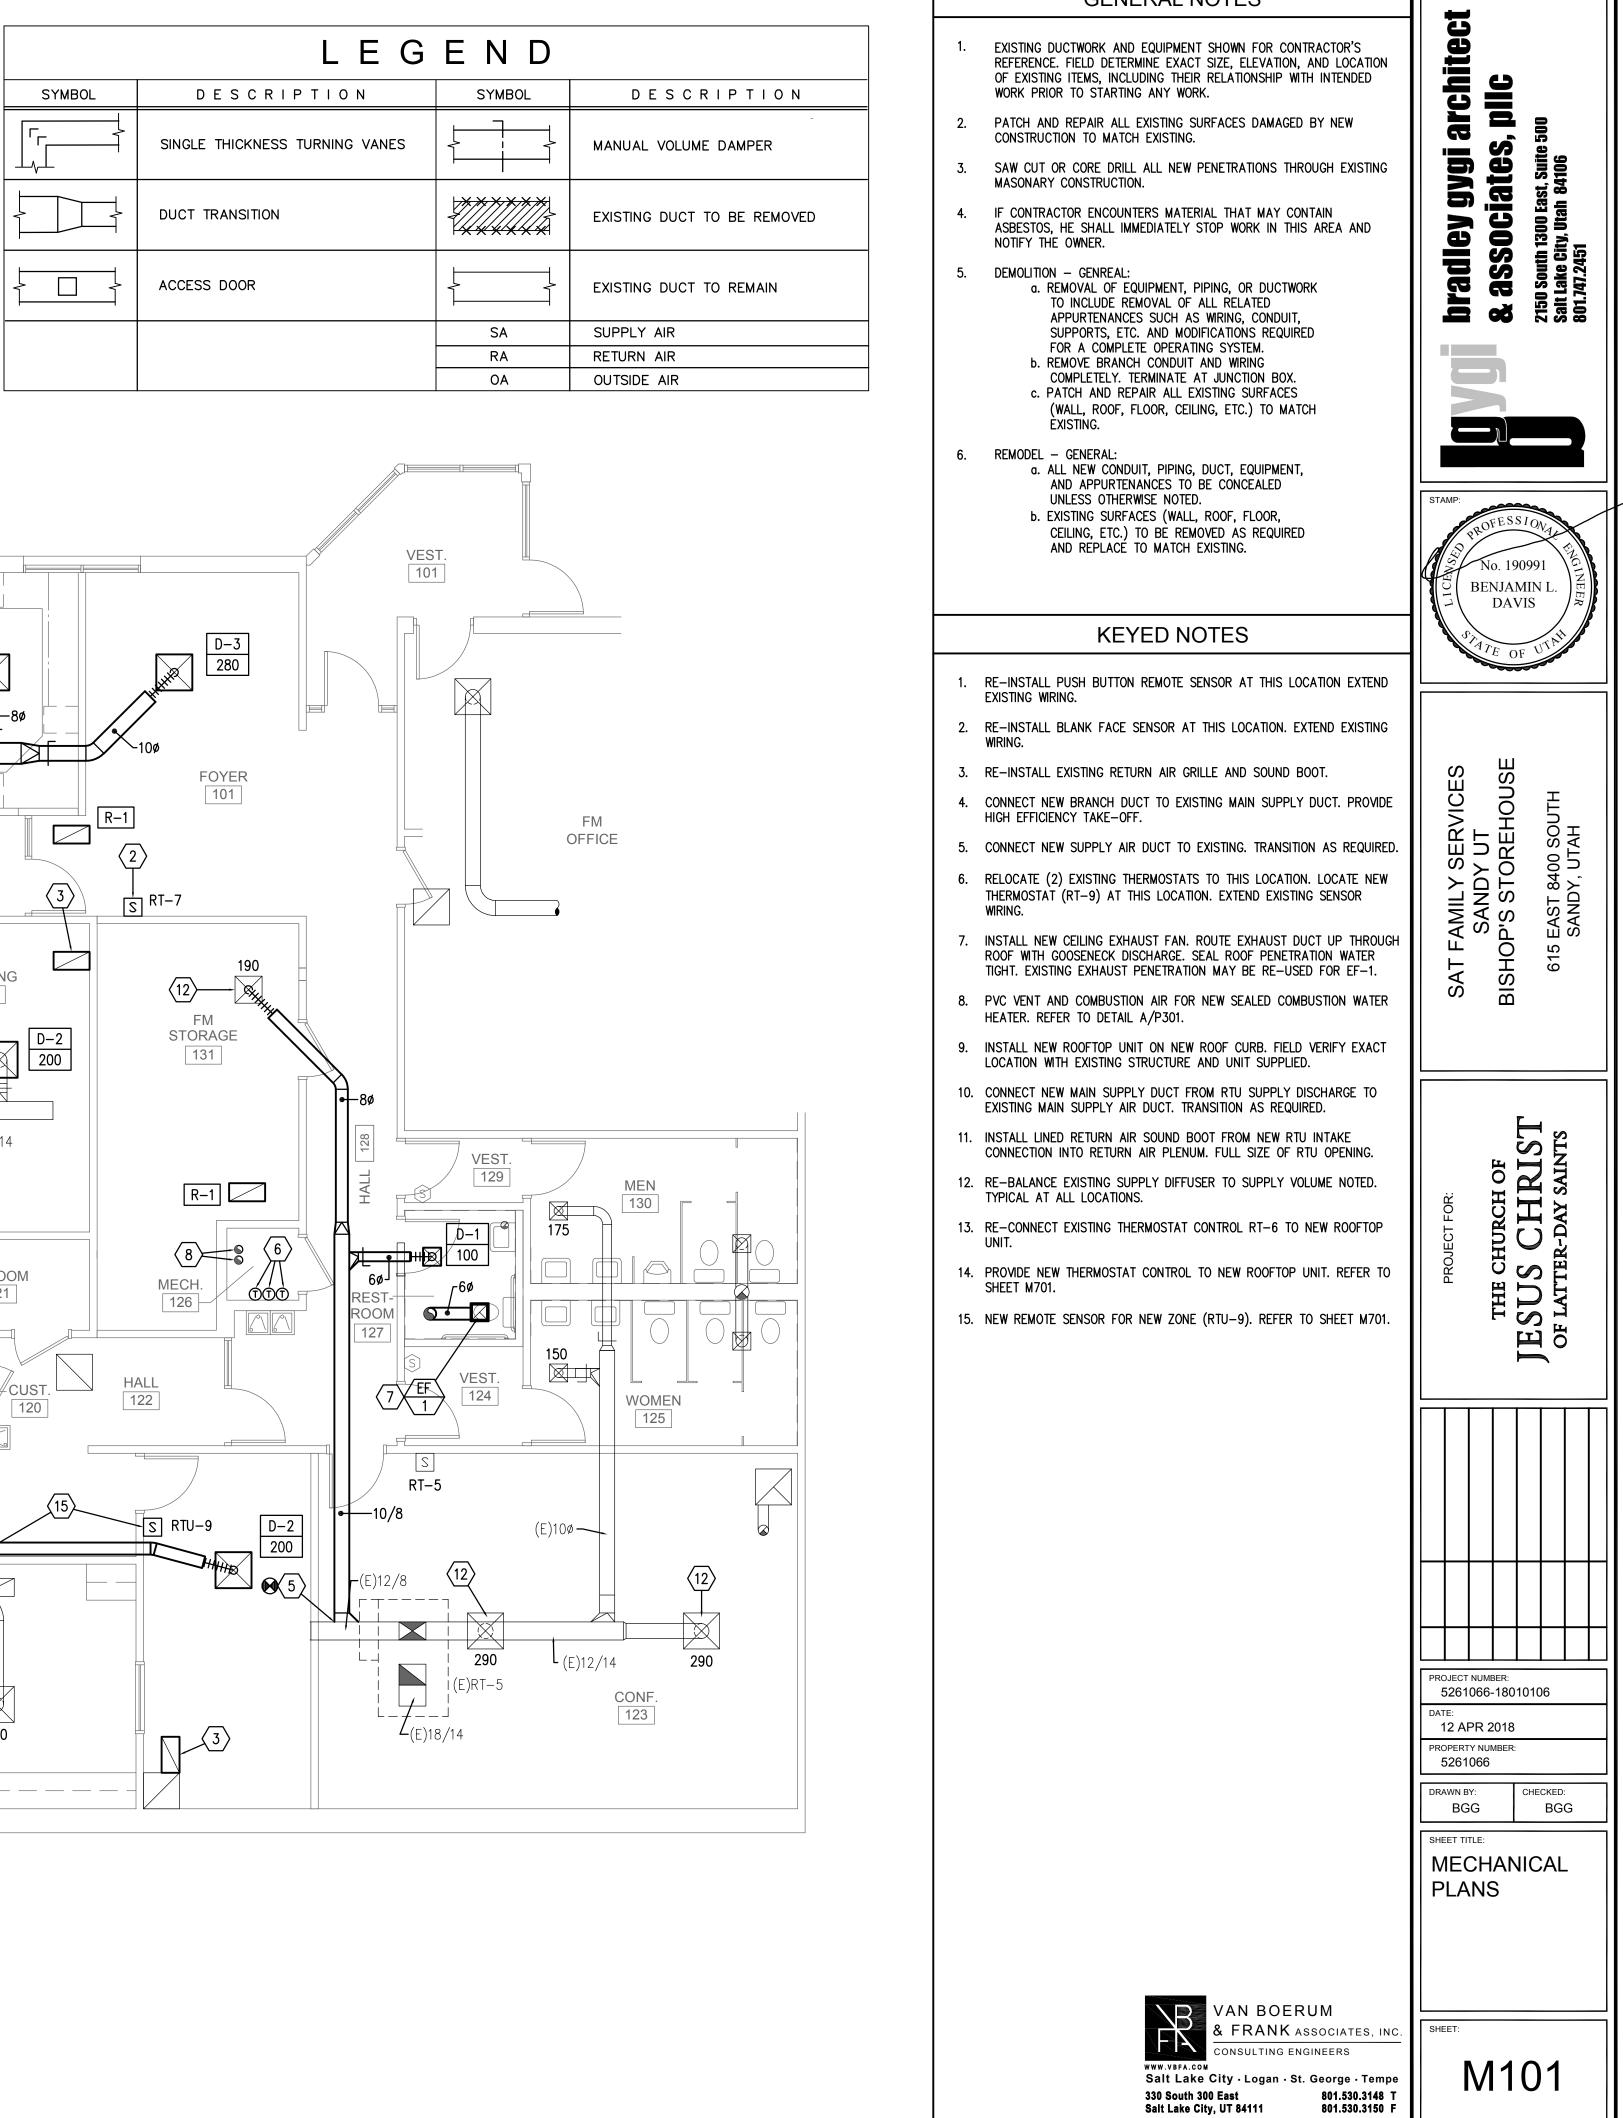	Dradley gygi architectBradley gygi architect& associates, pllc2150 South 1300 East, Suite 500Sait Lake City, Utah 84106B01.147.2451
	STAMP: PROFESSIONA No. 190991 BENJAMIN L. DAVIS $PROFUTATE OF UTATI$
	SAT FAMILY SERVICES SANDY UT BISHOP'S STOREHOUSE 615 EAST 8400 SOUTH SANDY, UTAH
	PROJECT FOR: THE CHURCH OF JESUS CHRIST OF LATTER-DAY SAINTS
	PROJECT NUMBER: 5261066-18010106 DATE: 12 APR 2018 PROPERTY NUMBER: 5261066
VAN BOERUM & FRANK ASSOCIATES INC.	DRAWN BY: BGG SHEET TITLE: MECHANICAL DETAILS
& FRANK associates, inc. CONSULTING ENGINEERS City · Logan · St. George · Tempe East 801.530.3148 T UT 84111 801.530.3150 F	M501

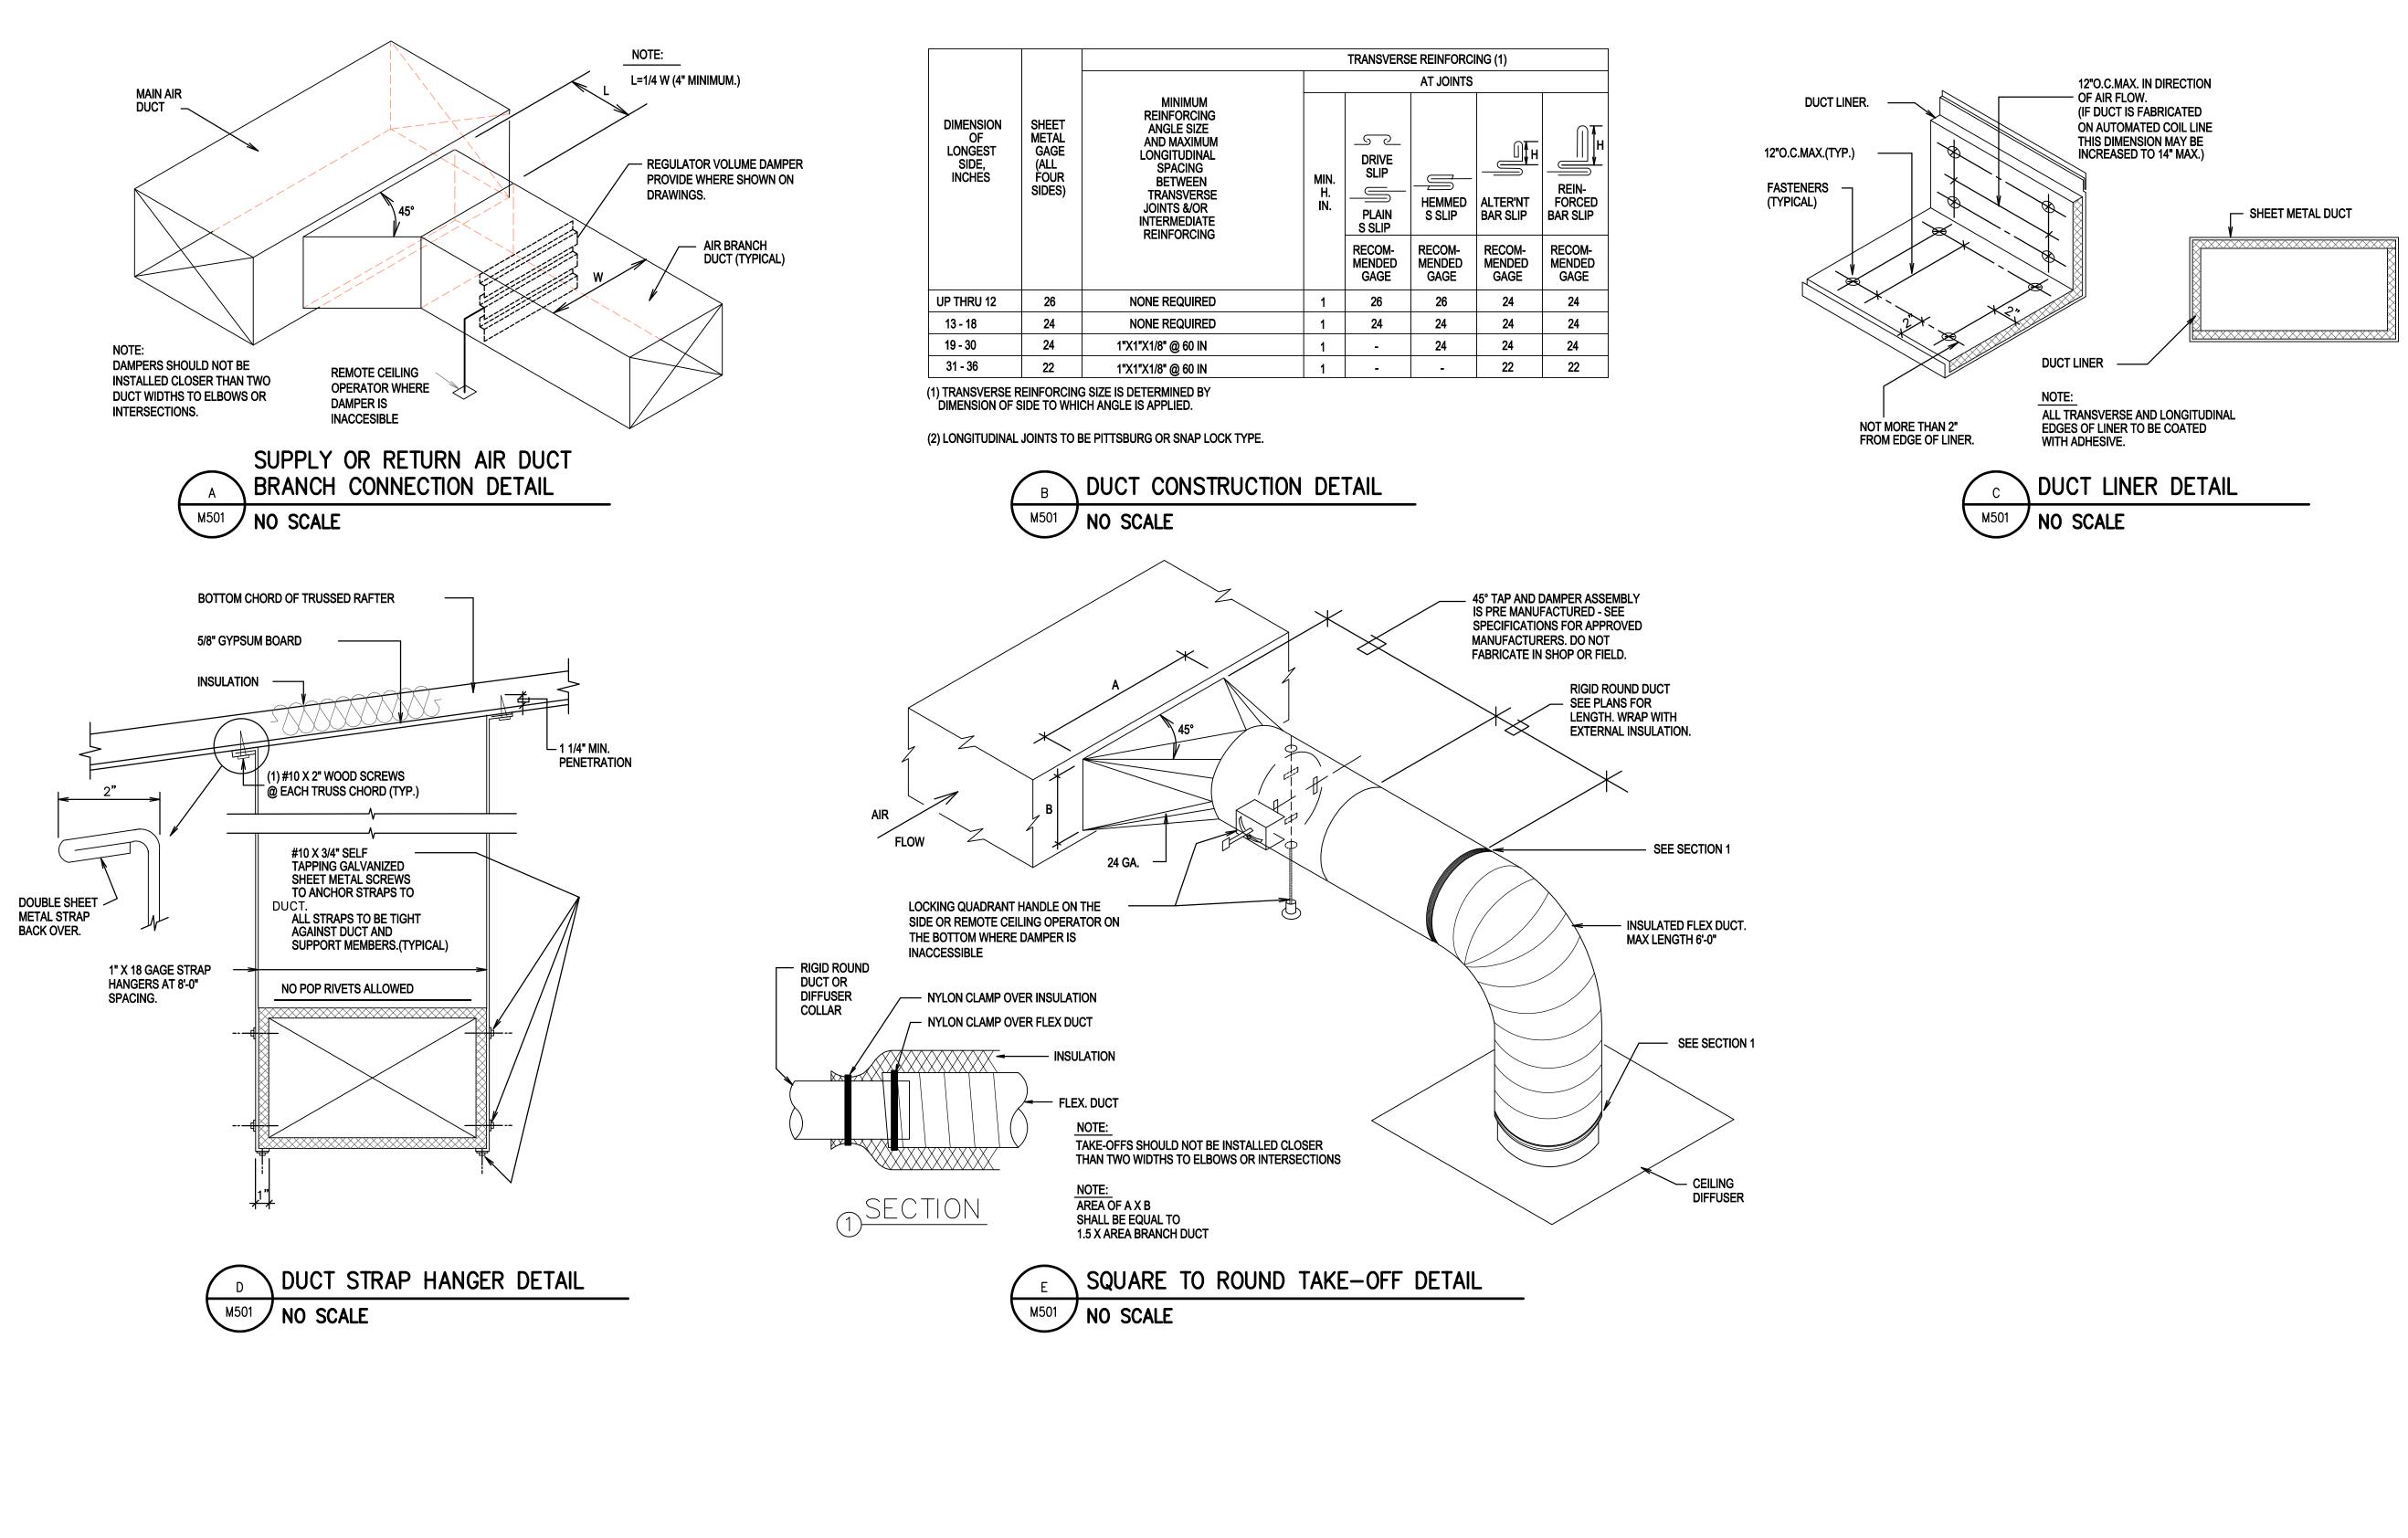

CONSULTING ENGINEERS Salt Lake City · Logan · St. George · Tempe 330 South 300 East 801.530.3148 T Salt Lake City, UT 84111 801.530.3150 F VBFA Project Number: 18129



								ROO	FTOF	P UN		SCHE	DUL	E						
		MIN.		EXT.	HEATING	CAPACITY		ARI	C O O L	ING	САРА	СІТҮ		FAN	N			MINIMUM	NAT. GAS	
MARK	TYPE	NOMINAL SIZE (TONS)	MINIMUM A.C.F.M.	S.P. IN.W.G.				MIN. REG)'D. CAP.	E	AT	L	AT.	MINIMUM	RPM	MIN. CIRCUIT		OUTSIDE AIR	CONNECTION SIZE	NOTES
		(TONS)	,	IIN. W.G.	INPUT	OUTPUT	AMBIENT	TOT.MBH	SEN.MBH	DB F	WB F	DB F	WB F	H.P.		AMPS	MOCP	A.C.F.M	SIZE	
RTU 6	PACKAGED GAS FIRED	5.0	2000	0.6	61.5	50	98	52.7	49.9	86.3	65.2	59.1	55.7	1.5	1205	38.7	50	290	1/2"	1, 2, 3, 4,
RTU 9	PACKAGED GAS FIRED	3.0	1200	0.6	41	32.8	98	27.3	22.3	84.2	63.7	57.4	54.1	1.5	975	29.6	40	210	1/2'	1, 2, 3, 5

NOTES:

1. CAPACITIES AT 4500' ELEVATION.

2. DRY BULB ECONOMIZER AND HOOD. 3. PROVIDE 12" ROOF CURB.

4. UNIT TO BE YORK ZE060N07 COMPLETE 1-STAGE COOLING, 2-STAGE HEATING, AND

LOW AMBIENT COOLING CONTROLS. 5. UNIT TO BE YORK ZE036H05 COMPLETE WITH 1-STAGE COOLING, 1-STAGE HEATING,

AND LOW AMBIENT COOLING CONTROLS.

	DIF	FUSER	R SO	CHED	ULE		24
MARK	C.F.M. RANGE	DIFFUSER	NECK	BLOW	PATTERN	AIR DIS	T./SIDE
	C.I.M. KANGE	SIZE	CONN.	BLOW	FATILIN	A (%)	B (%)
D-1	60–120	6x6	6"ø	4 WAY	▲ A ⊲ _ ▶B ♥	25	25
D-2	125-240	9x9	8"ø	4 WAY	A ⊲_⊳B ♥	25	25
D-3	245-360	12x12	10 " ø	4 WAY	▲ A ⊲ _ ▶B ♥	25	25

	REGISTER,LC	UVER	& GRIL	LE S	CHEDULE
MARK	ТҮРЕ	SERVICE	CFM (1) RANGE	NOMINAL SIZE	REMARKS
R-1	CEILING MOUNTED (4	RA	100-360	12x24	56

REGISTER, LOUVER AND DIFFUSER SCHEDULE NOTES:

(1) MAXIMUM NC=25 @ MAXIMUM CFM NOTED.

(2) SHALL BE TITUS TDC TYPE 3 OR EQUAL BY OTHER APPROVED MANUFACTURERS.

(3) SEE SPECIFICATIONS FOR APPROVED MANUFACTURERS.

(4) FINISH SHALL BE OFF-WHITE BAKED ENAMEL.

(5) COMPLETE WITH ACOUSTICAL SOUND BOOT TO MATCH EXISTING SOUND BOOTS.

(6) PROVIDE SURFACE MOUNT OR LAY-IN FRAME FOR CEILING TYPE. FIELD VERIFY.

NOTES:

1- THE MECHANICAL CONTRACTOR SHALL VERIFY MOTOR VOLTAGES WITH THE ELECTRICAL DRAWINGS BEFORE ORDERING MOTORIZED EQUIPMENT & CONTROLS. MOTOR NAME PLATE VOLTAGE SHALL BE NEMA STANDARD 200 VOLT FOR 208 VOLT THREE PHASE SYSTEM AND SHALL BE NEMA STANDARD 230 VOLT FOR 240 VOLT THREE PHASE OR SINGLE PHASE SYSTEM. STARTER HEATERS INSTALLED SHALL BE COORDINATED WITH THE NAME PLATE DATA.

2- S.C.F.M. LISTED IS STANDARD AIR. A.C.F.M. IS ACTUAL SITE CFM.

EXHAUST

SERVES ROOM	MIN. S.C.F.M.	STATIC PRESSURE IN. W.G.	MIN. () HP/WATTS	REMARKS
RESTROOM	70	0.2	81 W	34
BREAK ROOM	150	0.2	166 W	24

FAN SCHEDULE

④ CEILING EXHAUST FAN COMPLETE WITH BACKDRAFT DAMPER.

① VOLTAGE IS 115/1PHASE/60

MARK

EF 1

/EF\ 2


(2) CONTROLS: 0-60 MINUTE WALL TIMER BY DIV. 26.

(3) CONTROLS: INTERLOCK WITH LIGHTS BY DIV. 26.

NOTES:


1- THE MECHANICAL CONTRACTOR SHALL VERIFY MOTOR VOLTAGES WITH THE ELECTRICAL DRAWINGS BEFORE ORDERING MOTORIZED EQUIPMENT & CONTROLS. MOTOR NAME PLATE VOLTAGE SHALL BE NEMA STANDARD 200 VOLT FOR 208 VOLT THREE PHASE SYSTEM AND SHALL BE NEMASTANDARD 230 VOLT FOR 240 VOLT THREE PHASE OR SINGLE PHASESYSTEM. STARTER HEATERS INSTALLED SHALL BE COORDINATED WITH THE NAME PLATE DATA.

2- S.C.F.M. LISTED IS STANDARD AIR. A.C.F.M. IS ACTUAL SITE CFM.

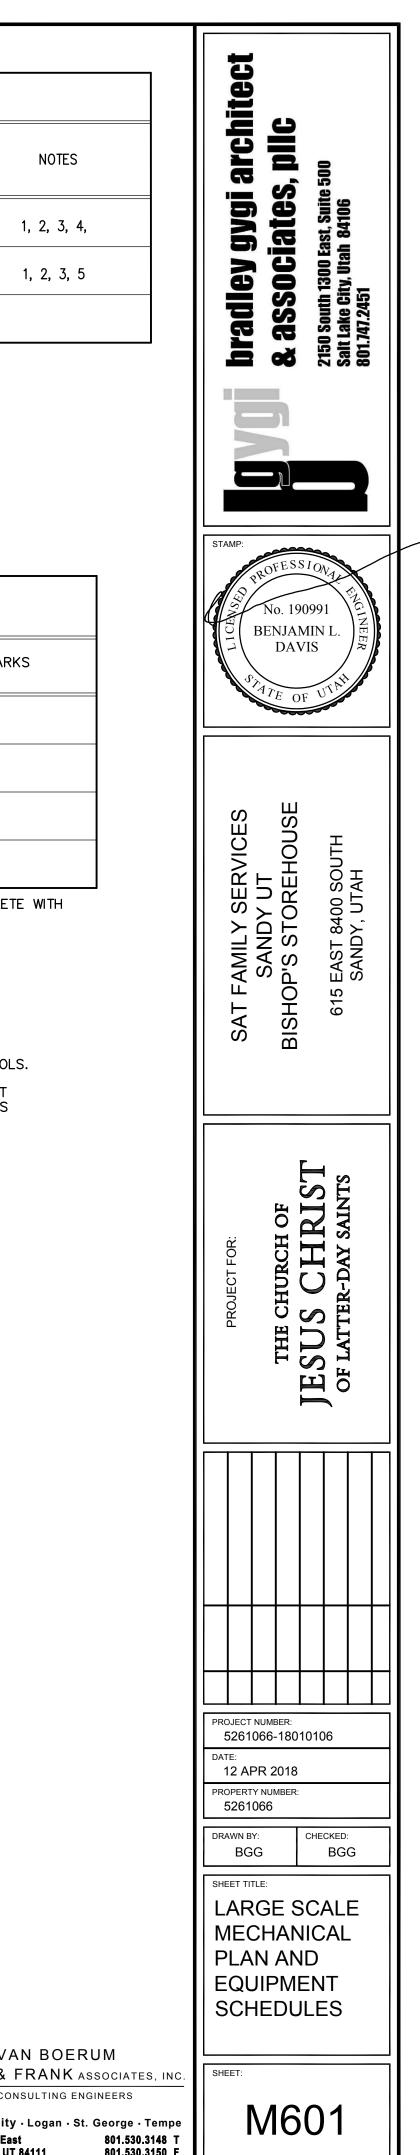



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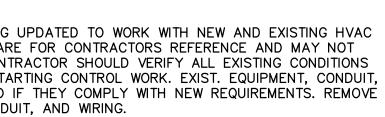
SHOW EXACT CONDITIONS. CONT PRIOR TO BIDDING AND/OR STA AND WIRING MAY BE RE-USED	

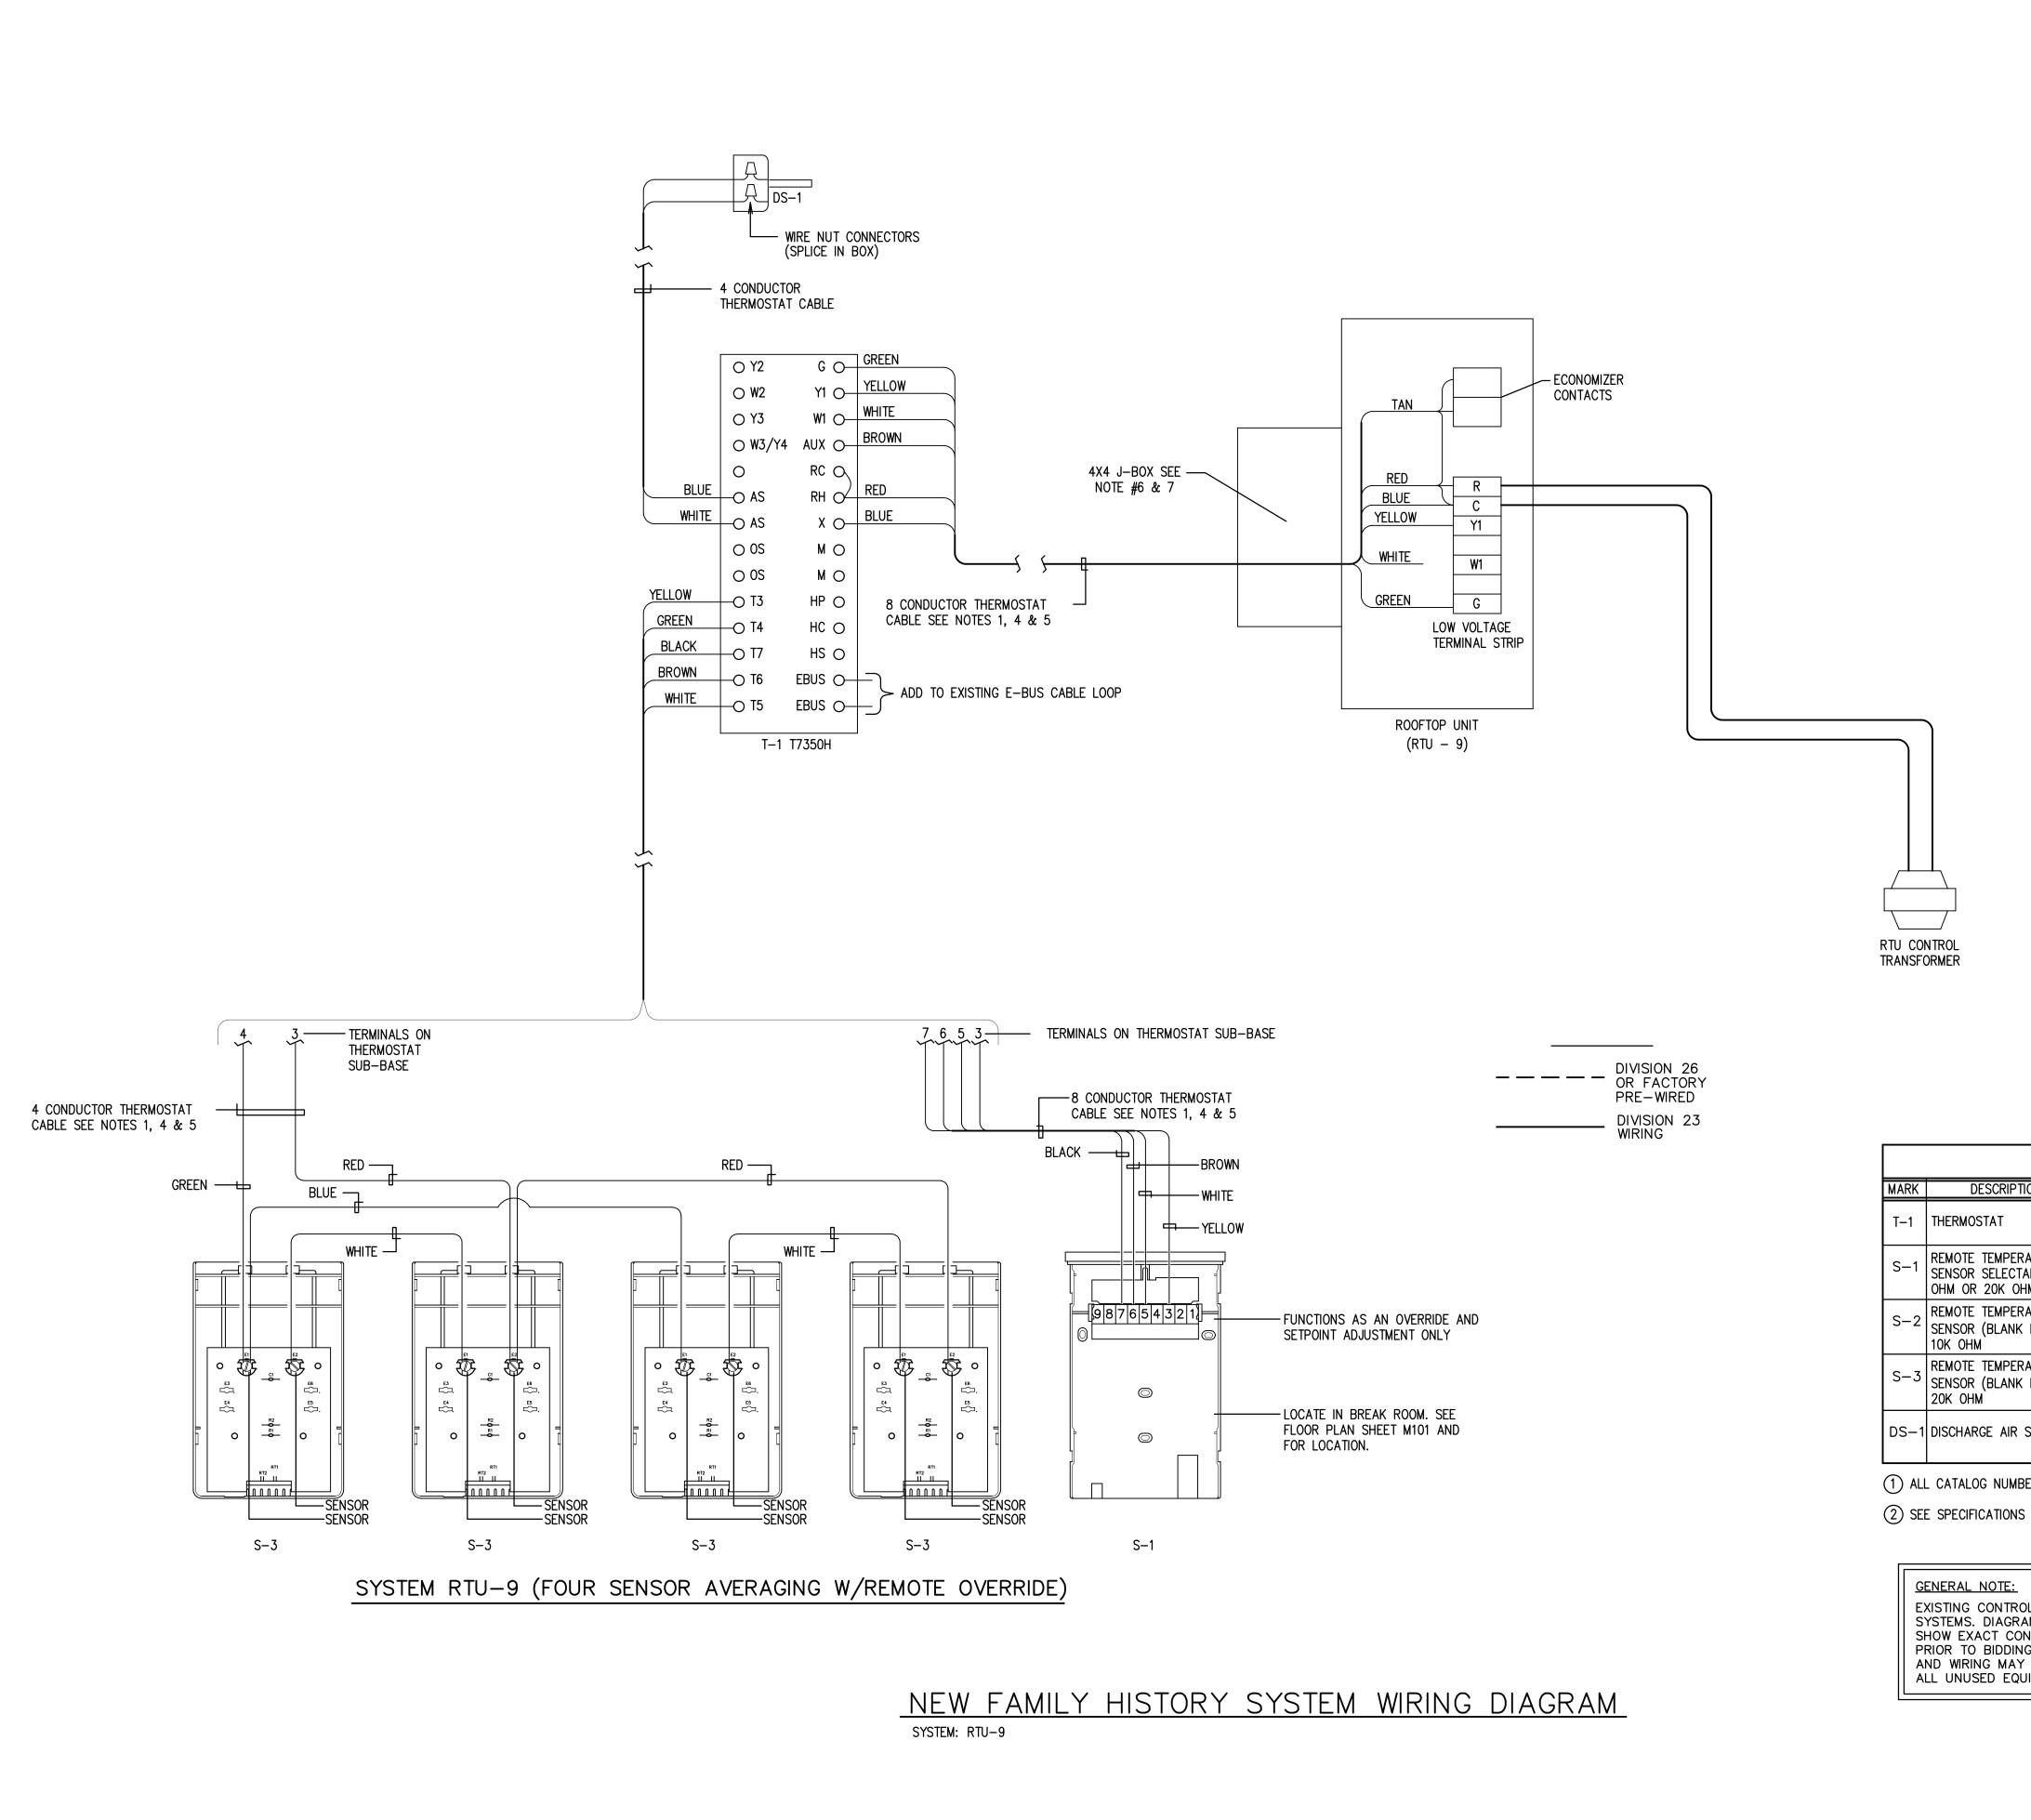1) ALL CATALOG NUMBERS SHOWN ARE HONEYWELL UNLESS NOTED OTHERWISE.

	СС	NTROL	EQ	UIPMENT	_
MARK	DESCRIPTION	CAT. NO.(1)	MARK	DESCRIPTION	CAT. NO.(1)
T–1	THERMOSTAT	T7350H1009			
S-1	REMOTE TEMPERATURE SENSOR SELECTABLE 10K OHM OR 20K OHM	T7771A1005			
S-2	REMOTE TEMPERATURE SENSOR (BLANK FACE) 10K OHM	TR21-A			
S-3	REMOTE TEMPERATURE SENSOR (BLANK FACE) 20K OHM	TR21			
DS-1	DISCHARGE AIR SENSOR	C7041B2005			

NOTES:

- 1. THERMOSTAT CABLE- 4, 8 OR 12 CONDUCTOR- 18 AWG SOLID COPPER WIRE INSULATED WITH HIGH DENSITY POLYETHYLENE. CONDUCTORS PARALLEL. ENCLOSED IN BROWN PVC JACKET. (NO 22 AWG CABLE ALLOWED).
- 2. IF COMPRESSOR UNITS HAVE THEIR OWN POWER SUPPLY IT MAY BE NECESSARY TO ADD ADDITIONAL RELAYS IN COMPRESSOR UNIT TO PROPERLY INTERFACE CONTROLS.
- 3. USE WIRE NUT CONNECTORS FOR SPLICING CONDUCTORS IN SPECIFIED LOCATIONS. AND TYTON TYPE CRIMP CONNECTORS FOR TERMINAL CONNECTIONS. NO TERMINAL CONNECTORS REQUIRED AT THERMOSTAT OR SENSOR.
- 4. DO NOT RUN ANY OTHER WIRING IN THIS CONDUIT EXCEPT THERMOSTAT CABLE.
- 5. DO NOT SPLICE WIRE IN RUNS FROM SENSOR TO THERMOSTAT, THERMOSTAT TO FURNACE, AND THERMOSTAT TO DISCHARGE AIR SENSOR.
- 6. PROVIDE CHASE NIPPLE W/PLASTIC BUSHING WHEN ATTACHING J-BOX TO EQUIPMENT.
- 7. PROVIDE CABLE CLAMP SO THAT CABLES CANNOT BE PULLED OUT OF J-BOX.
- 8. CONDUIT TO BE 1/2" UNLESS OTHERWISE NOTED. ALL WIRING IS TO BE ROUTED IN CONDUIT.



G bradley gygi architeC & associates, pllc 2150 South 1300 East, Suite 500 Salt Lake City, Utah 84106 801.747.2451 No. 190991 BENJAMIN L DAVIS T FAMILY SERVICES SANDY UT HOP'S STOREHOUSE SE 5 EAST 8400 SOUTH SANDY, UTAH BISHOF 615 SAT THE CHURCH OF JESUS CHRIST OF LATTER-DAY SAINTS PROJECT NUMBER: 5261066-18010106 DATE: 12 APR 2018 PROPERTY NUMBER: 5261066 DRAWN BY: CHECKED: BGG BGG SHEET TITLE: AUTOMATIC TEMPERATURE CONTROL WIRING AND EQUIPMENT SCHEDULE **FRANK** ASSOCIATES, INC. SHEET: M701 www.vвғѧ.coм Salt Lake City · Logan · St. George · Tempe 801.530.3148 T 801.530.3150 F

VAN BOERUM


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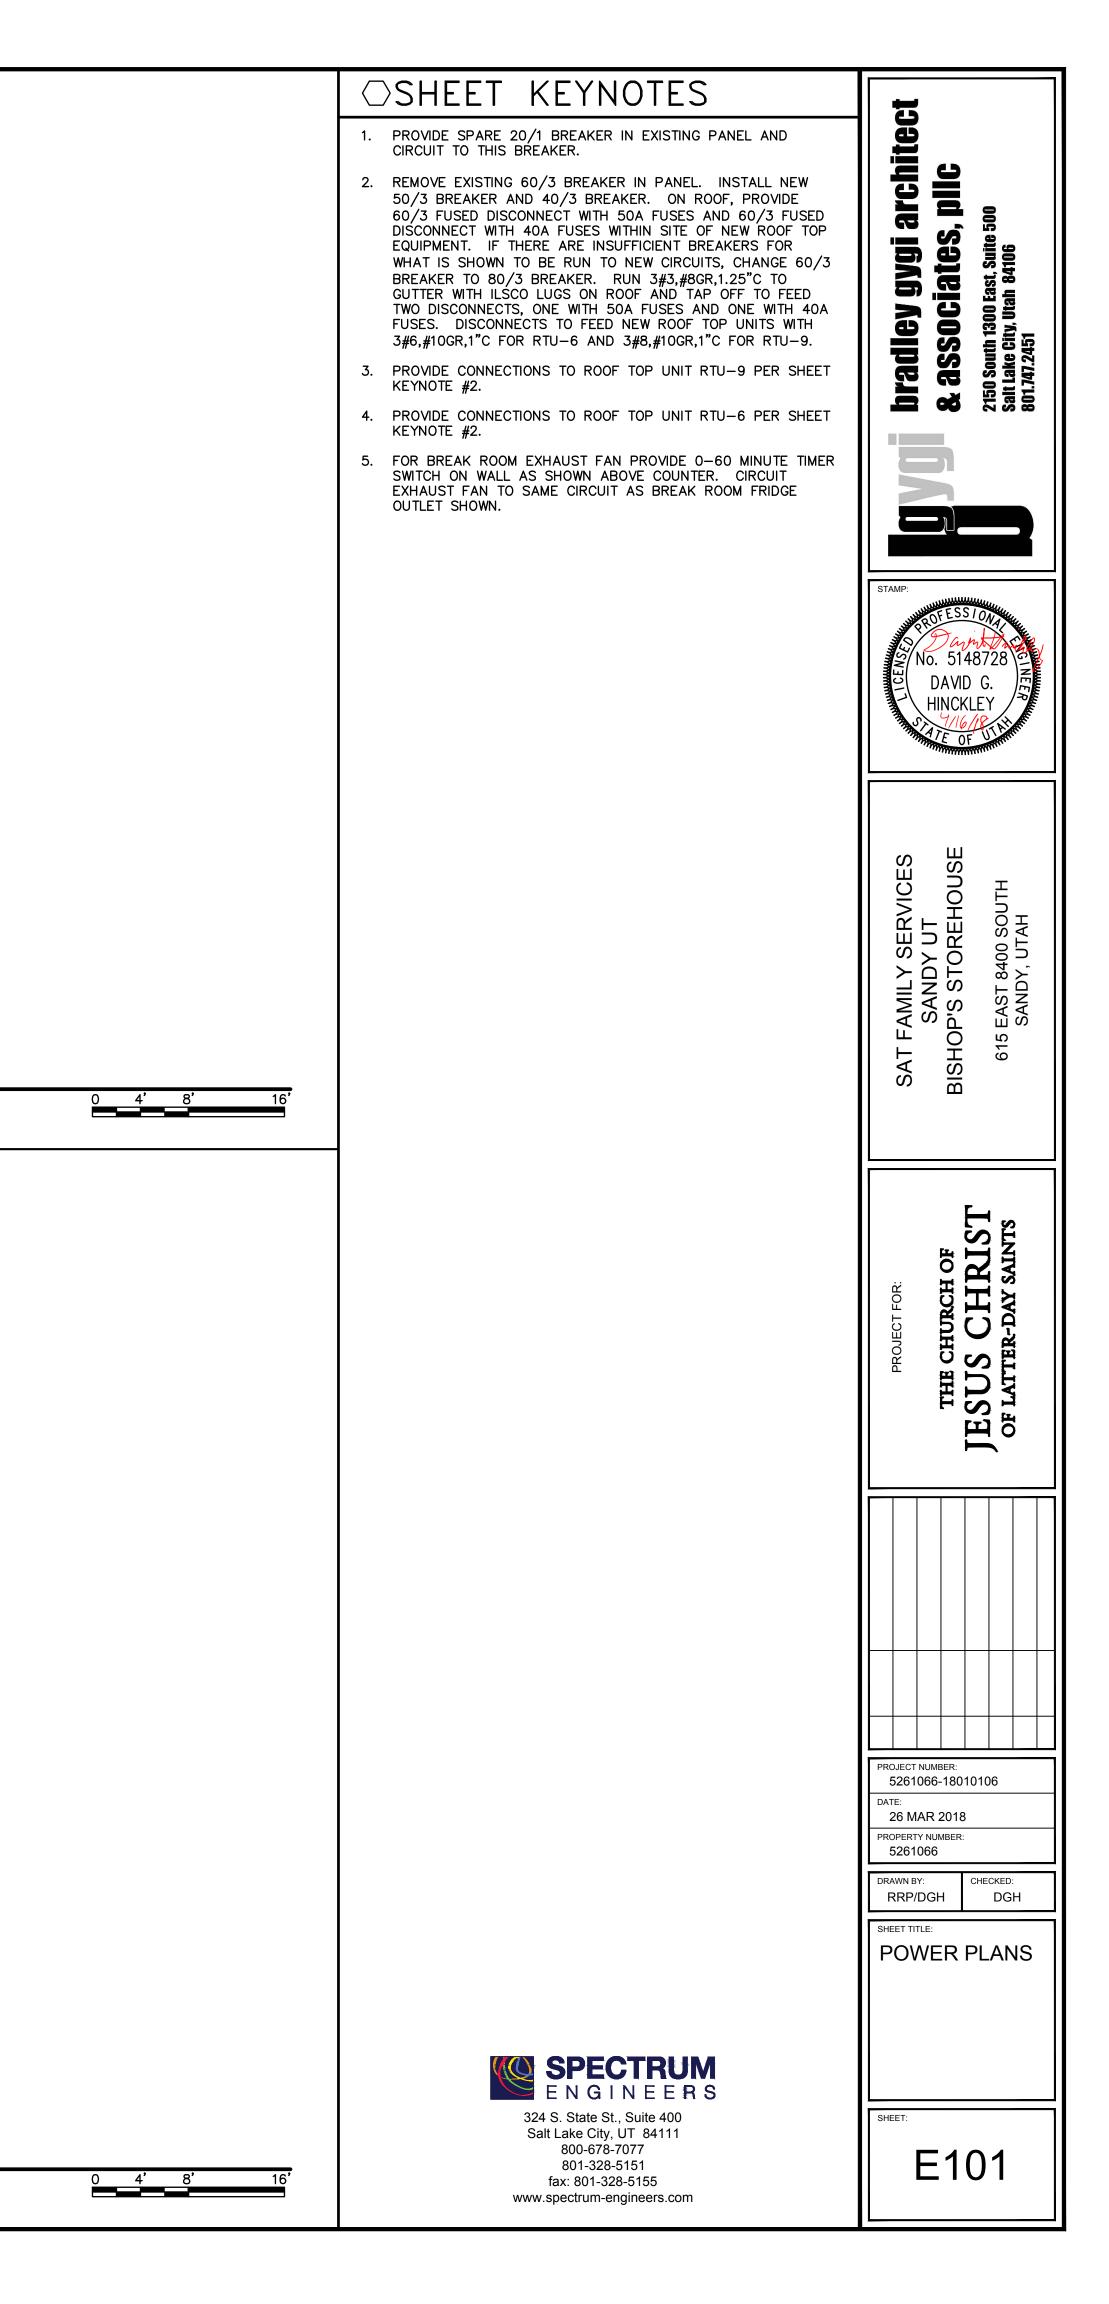
330 South 300 East


Salt Lake City, UT 84111

VBFA Project Number: 18129




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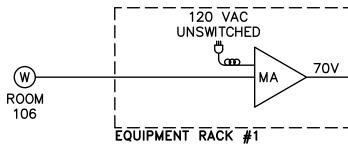
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	⊖SHEET KEYNOTES	
	1. REMOVE EXISTING LIGHT FIXTURE AND RE-INSTALL ON NEW	
	CEILING IN SAME LOCATION. 2. REMOVE EXISTING LIGHT FIXTURE AND RE-INSTALL IN NEW	bradley gygi architec & associates, plic alt Lake City, Utah 84106 601.747.2451
	LOCATION. 3. RE-INSTALLED EXISTING LIGHT FIXTURE IN SAME LOCATION.	archi , pllc
	4. RE-INSTALLED EXISTING LIGHT FIXTURE IN NEW LOCATION.	radley gygi 3 associates, 0 South 1300 East, Suite 5 t Lake City, Utah 84106 .747.2451
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		bradley gygi al & associates, p 2150 South 1300 East, Suite 500 Salt Lake City, Utah 84106 801.747.2451
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		No. 5148728 DAVID G. HINCKLEY
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		PROJECT NUMBER: 5261066-18010106
		DATE: 26 MAR 2018 PROPERTY NUMBER:
		5261066 DRAWN BY: CHECKED:
		RRP/DGH DGH
		LIGHTING
	ENGINEERS	
	324 S. State St., Suite 400 Salt Lake City, UT 84111 800-678-7077	
0 4' 8' 16'	801-328-5151 fax: 801-328-5155 www.spectrum-engineers.com	E151

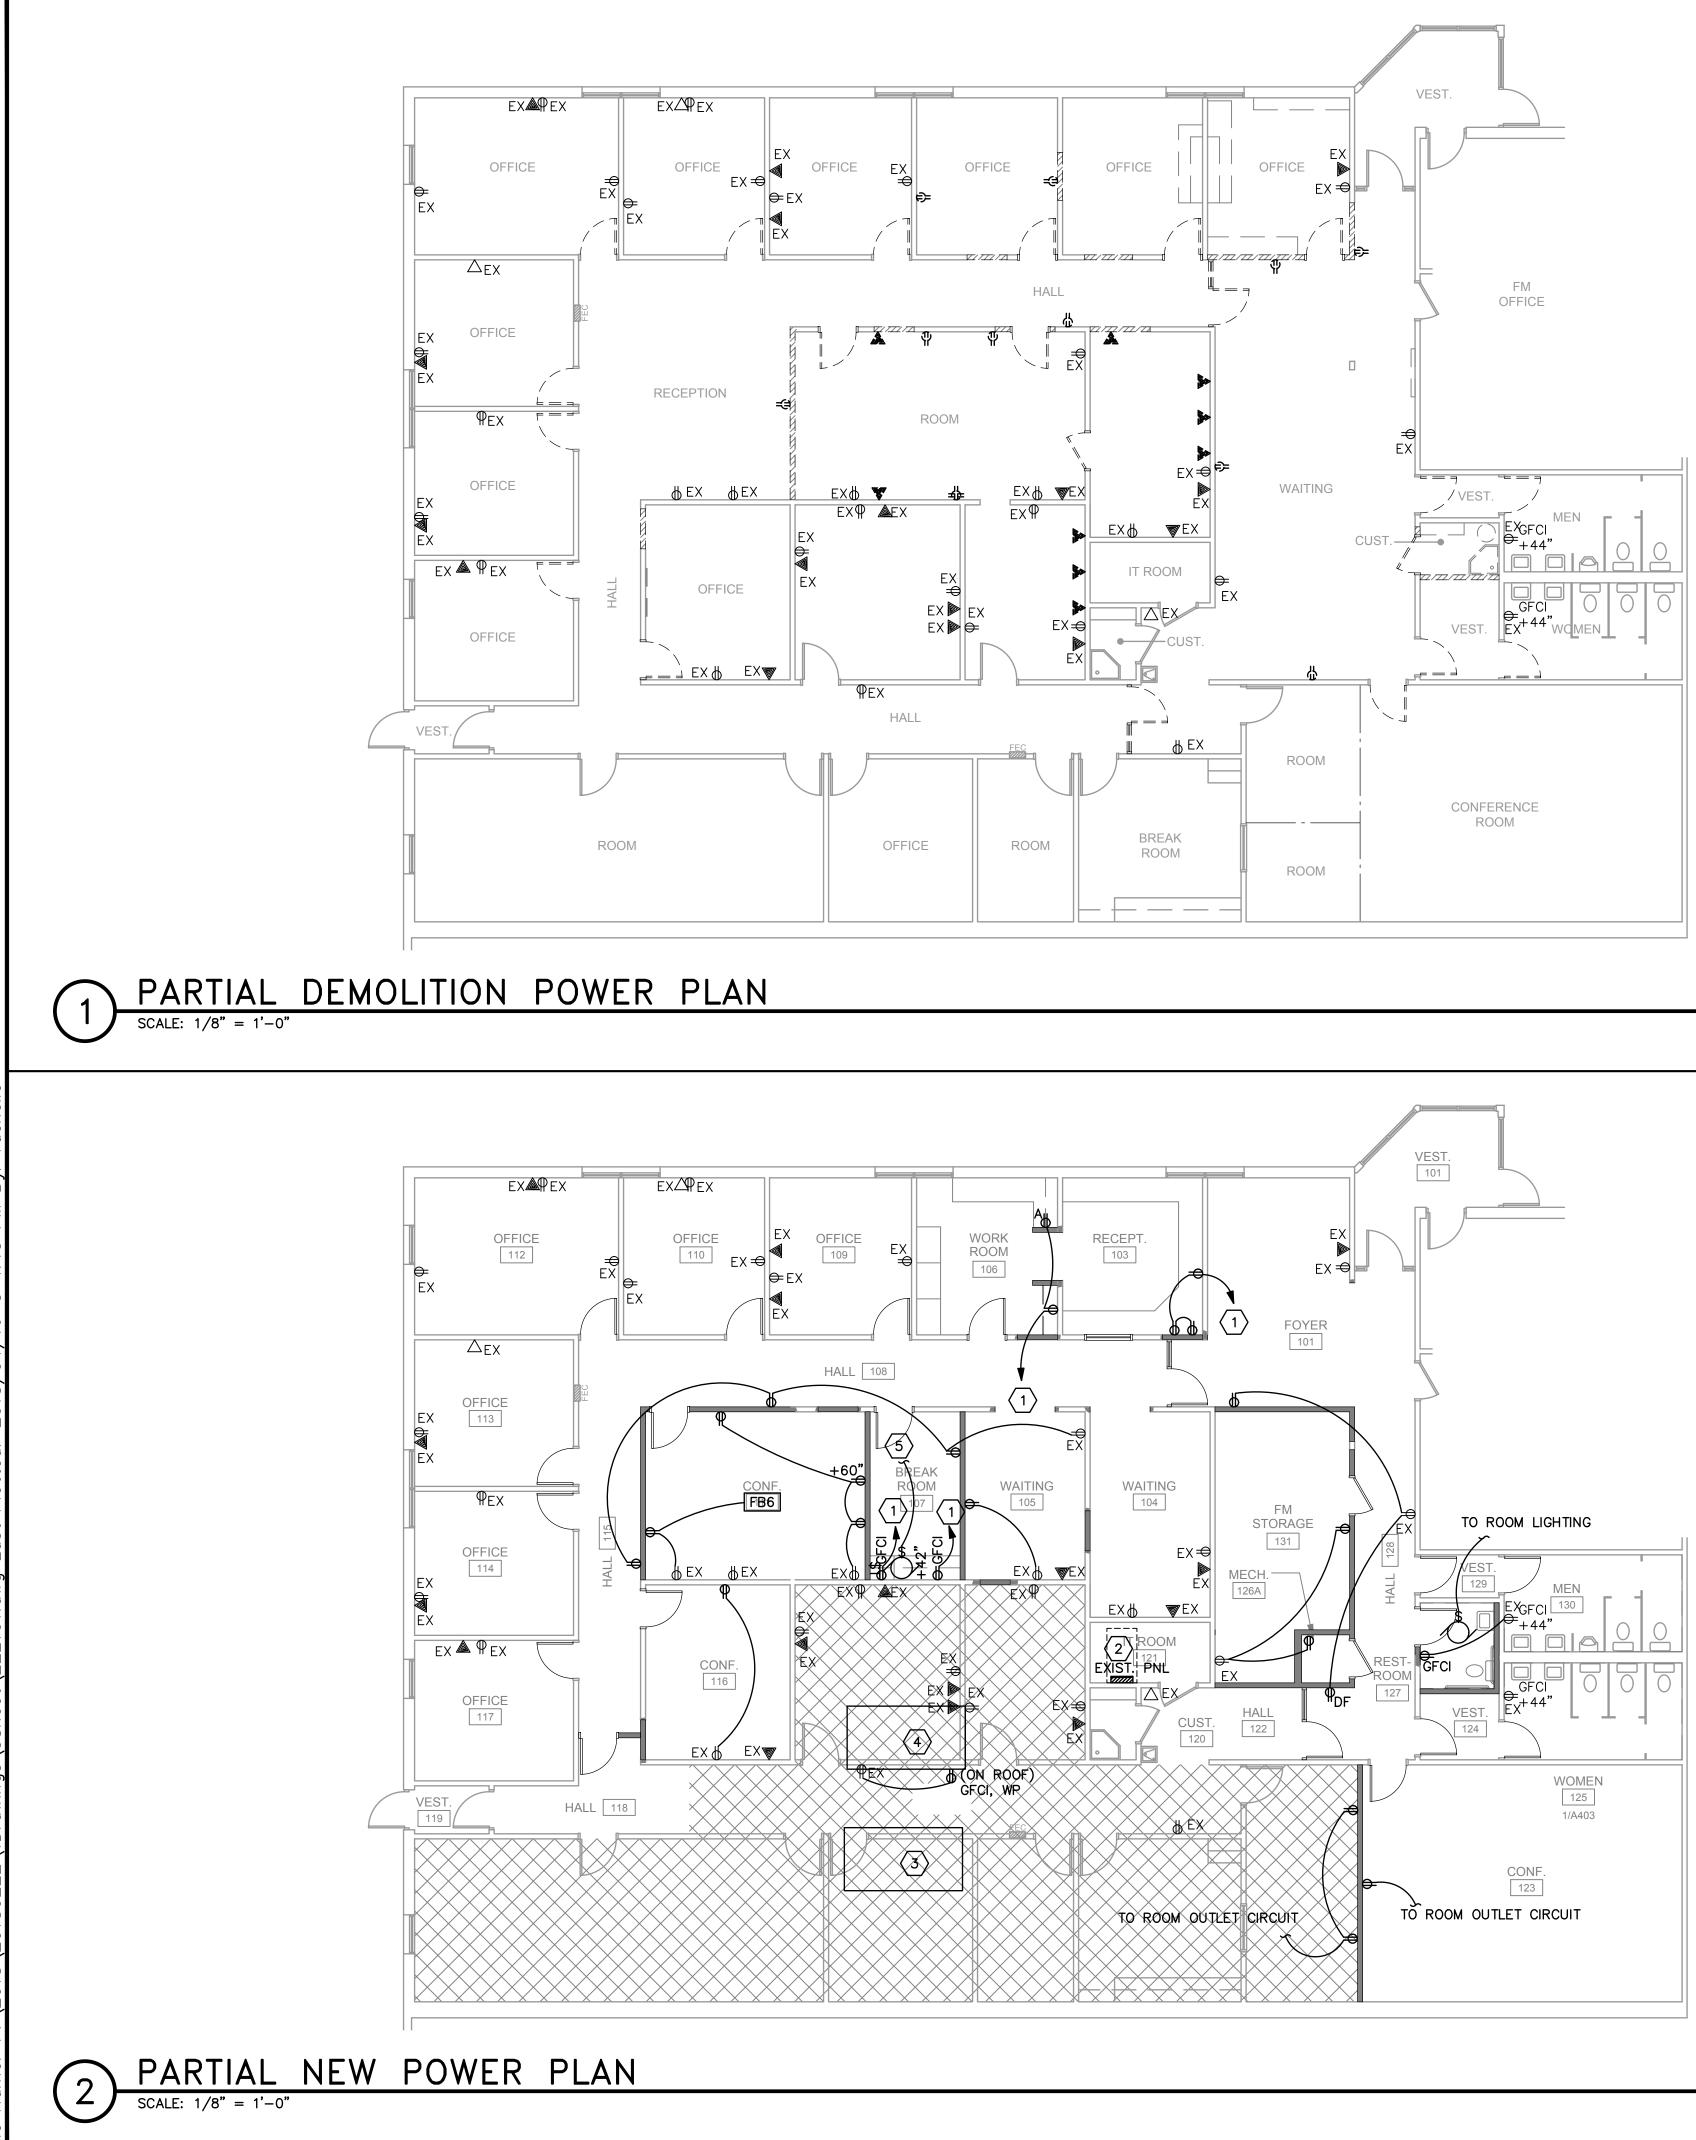

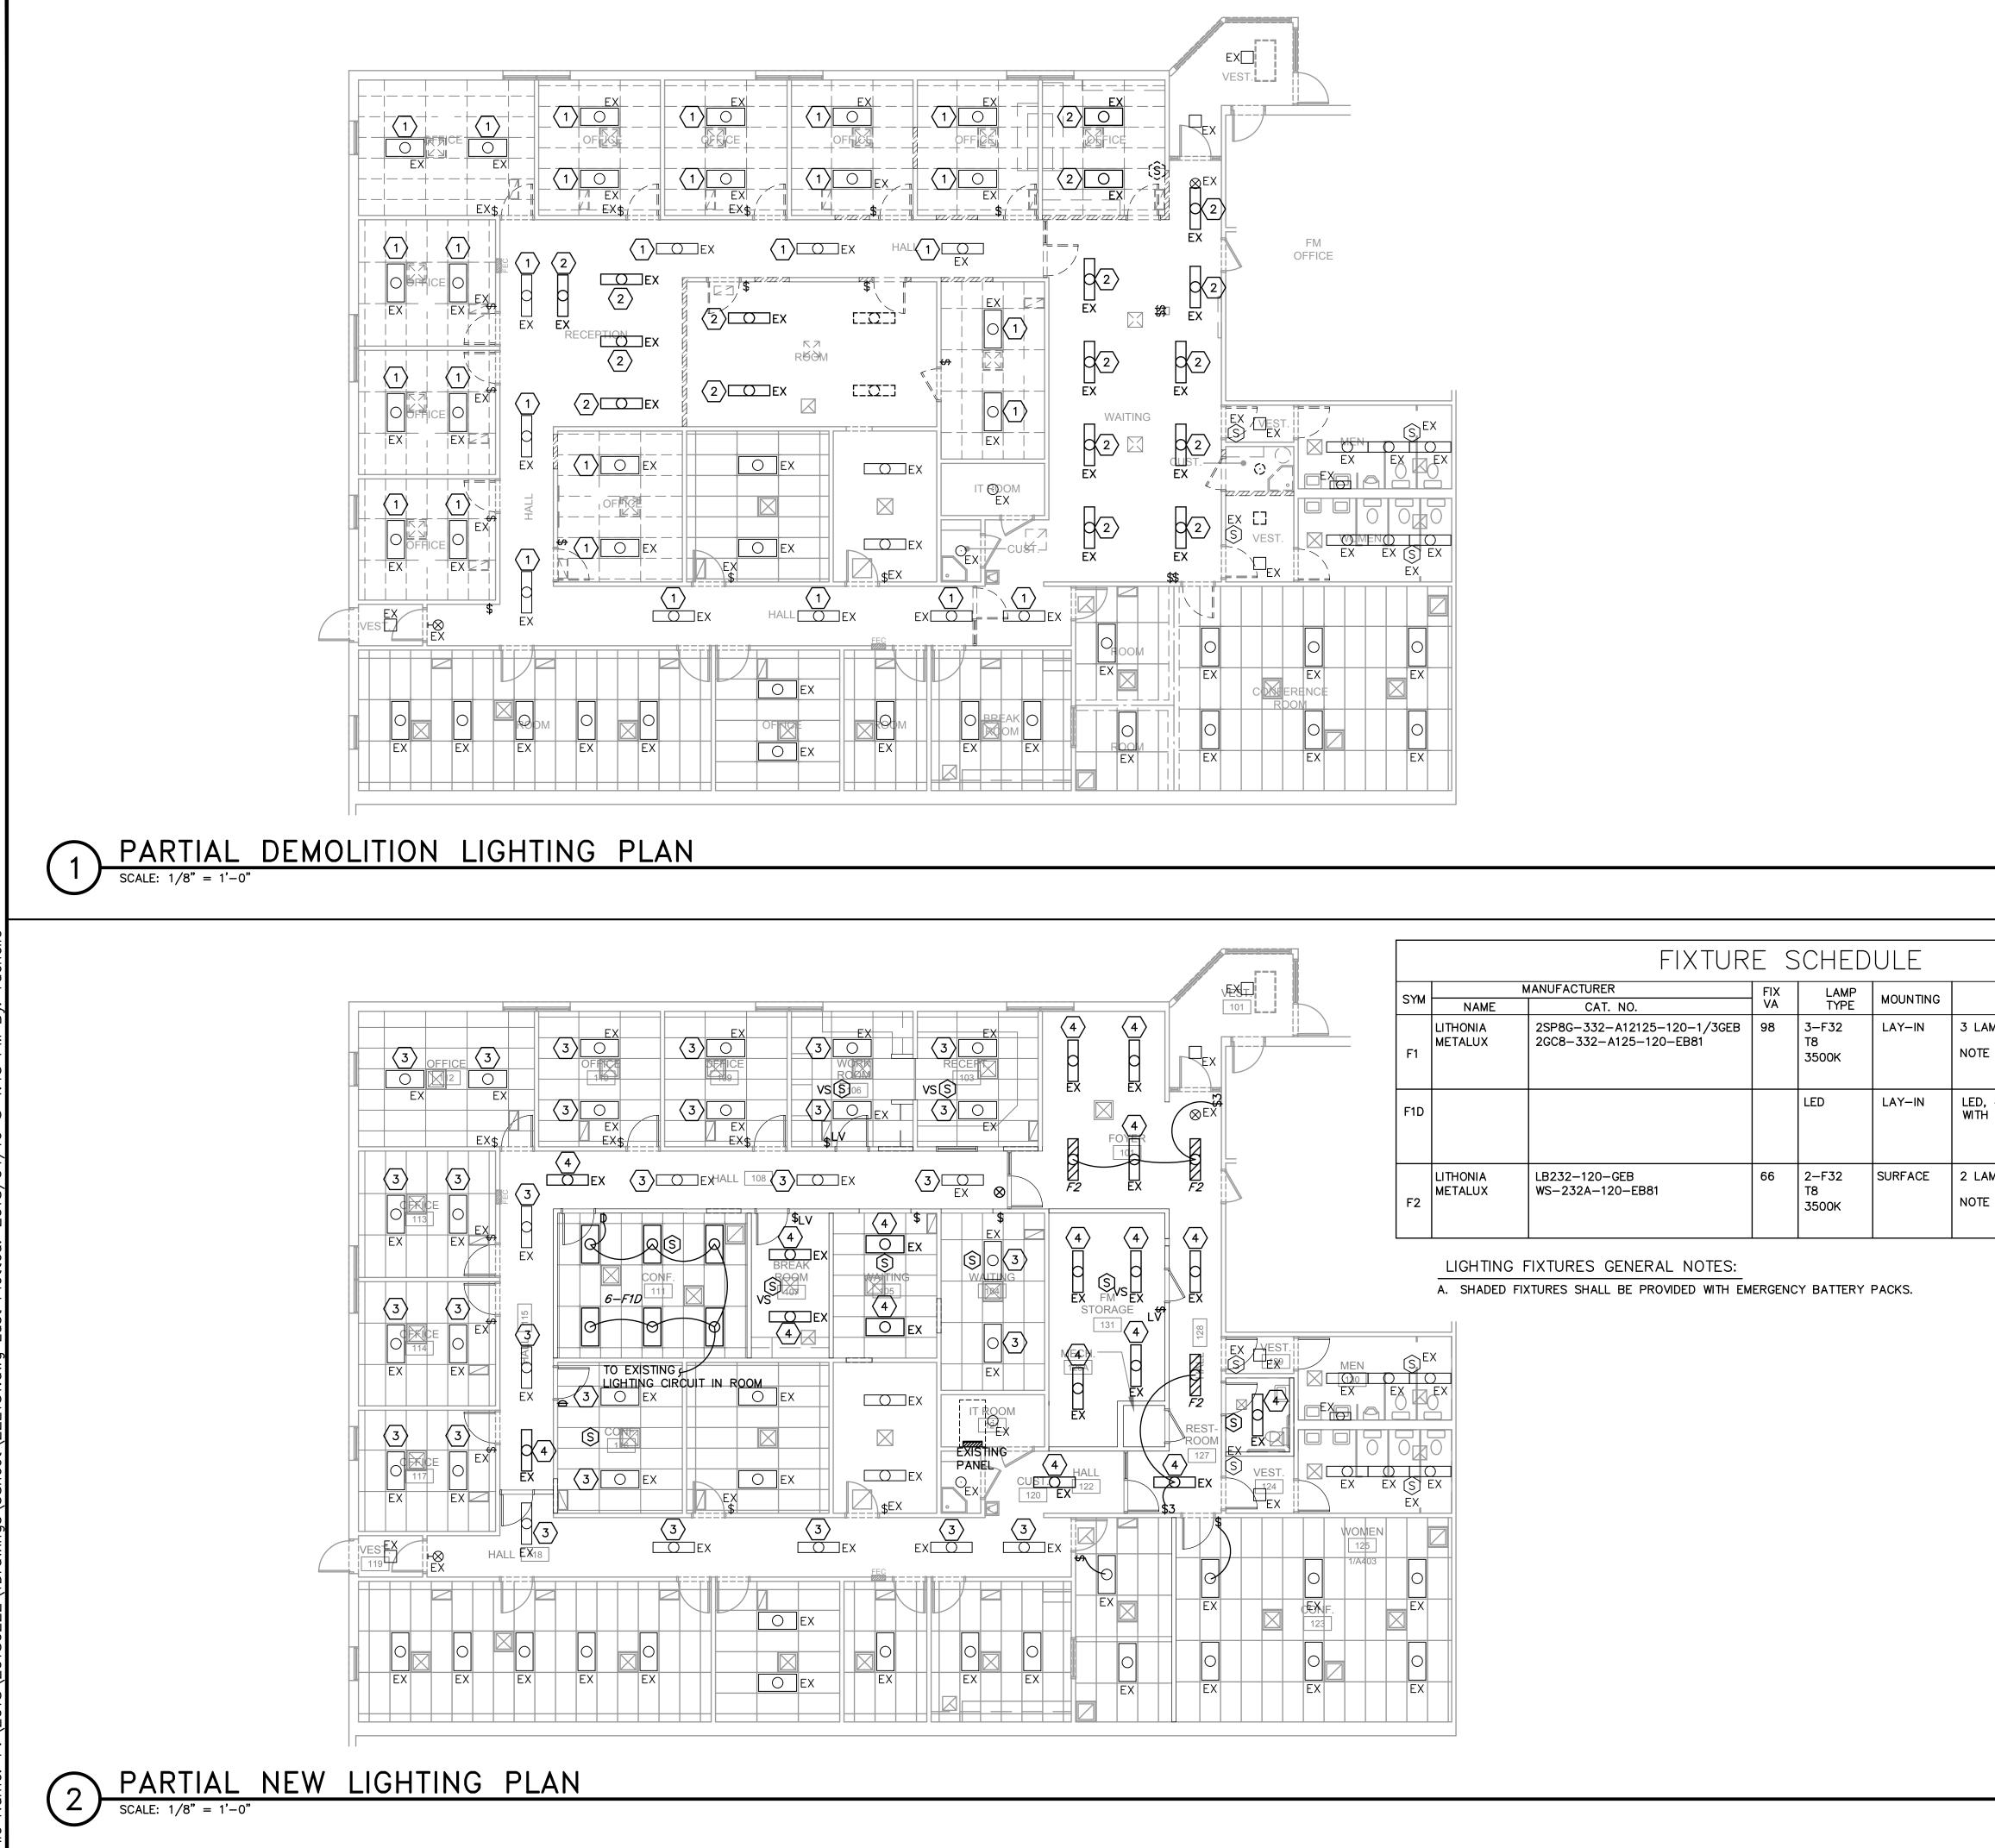0	4'	8'	

<u>CE-DATA SYSTEM EQU</u>	JIPMENT/CABLE LIST
LLOWING IS A PARTIAL LIST OF MATERIALS FOR THE DATA I FOR FULL REQUIREMENTS. VERIFY ALL PART NUMBERS DTIFY CONSULTANT OF DISCREPANCIES PRIOR TO BIDDING. TO PROVIDE A COMPLETE SYSTEM.	WITH MANUFACTURER'S CATALOG NUMBERS
DESCRIPTION	ACCEPTABLE TYPES
PATCH PANEL, DATA, 48–PORT W/ CAT 6 INSERT, BLUE (QUANTITIES OF PORTS AS REQUIRED +25%)	SEE SPECIFICATION 271501
STATION CABLE, DATA-CAT 6, DATA, BLUE JACKET (#) INDICATES NUMBER OF CABLES IF MORE THAN ONE	SEE SPECIFICATION 271501
DATA OUTLET SINGLE GANG BEZEL	SEE SPECIFICATION 271501
BEZEL INSERTS	SEE SPECIFICATION 271501
CAT 6 JACK-DATA (1)	SEE SPECIFICATION 271501
3" DEEP DOUBLE GANG BOX MOUNTED AT ELECTRICAL OUTLET HEIGHT WITH SINGLE GANG PLASTER RING, OR USE EXISTING BOX	
VOICE-DATA OUTLET SINGLE GANG BEZEL	SEE SPECIFICATION 271501
BEZEL INSERTS	SEE SPECIFICATION 271501
CAT 6 JACK-DATA (2)	SEE SPECIFICATION 271501
3" DEEP DOUBLE GANG BOX MOUNTED AT ELECTRICAL OUTLET HEIGHT WITH SINGLE GANG PLASTER RING, OR USE EXISTING BOX	
COPPER CAT 6 PATCH CABLES	SEE SPECIFICATION 271501
CAT 6 J-HOOKS	CADDY CAT32Z34
HORIZONTAL WIRE MANAGER HORIZONTAL WIRE MANAGER SHALL NOT HAVE A DEPTH OF MORE THAN 3"	SEE SPECIFICATION 271501
NETWORK SWITCH, LDS STANDARD (IEA-IS FOR INTERNET ENABLED APPLIANCES)	OWNER FURNISHED-CONTRACTOR INSTALLED
RACK MOUNT SHELF	MIDDLE ATLANTIC
NOTE: ALL PATCH PANELS AND ACCESSORIES SHALL B	E BLACK IN COLOR

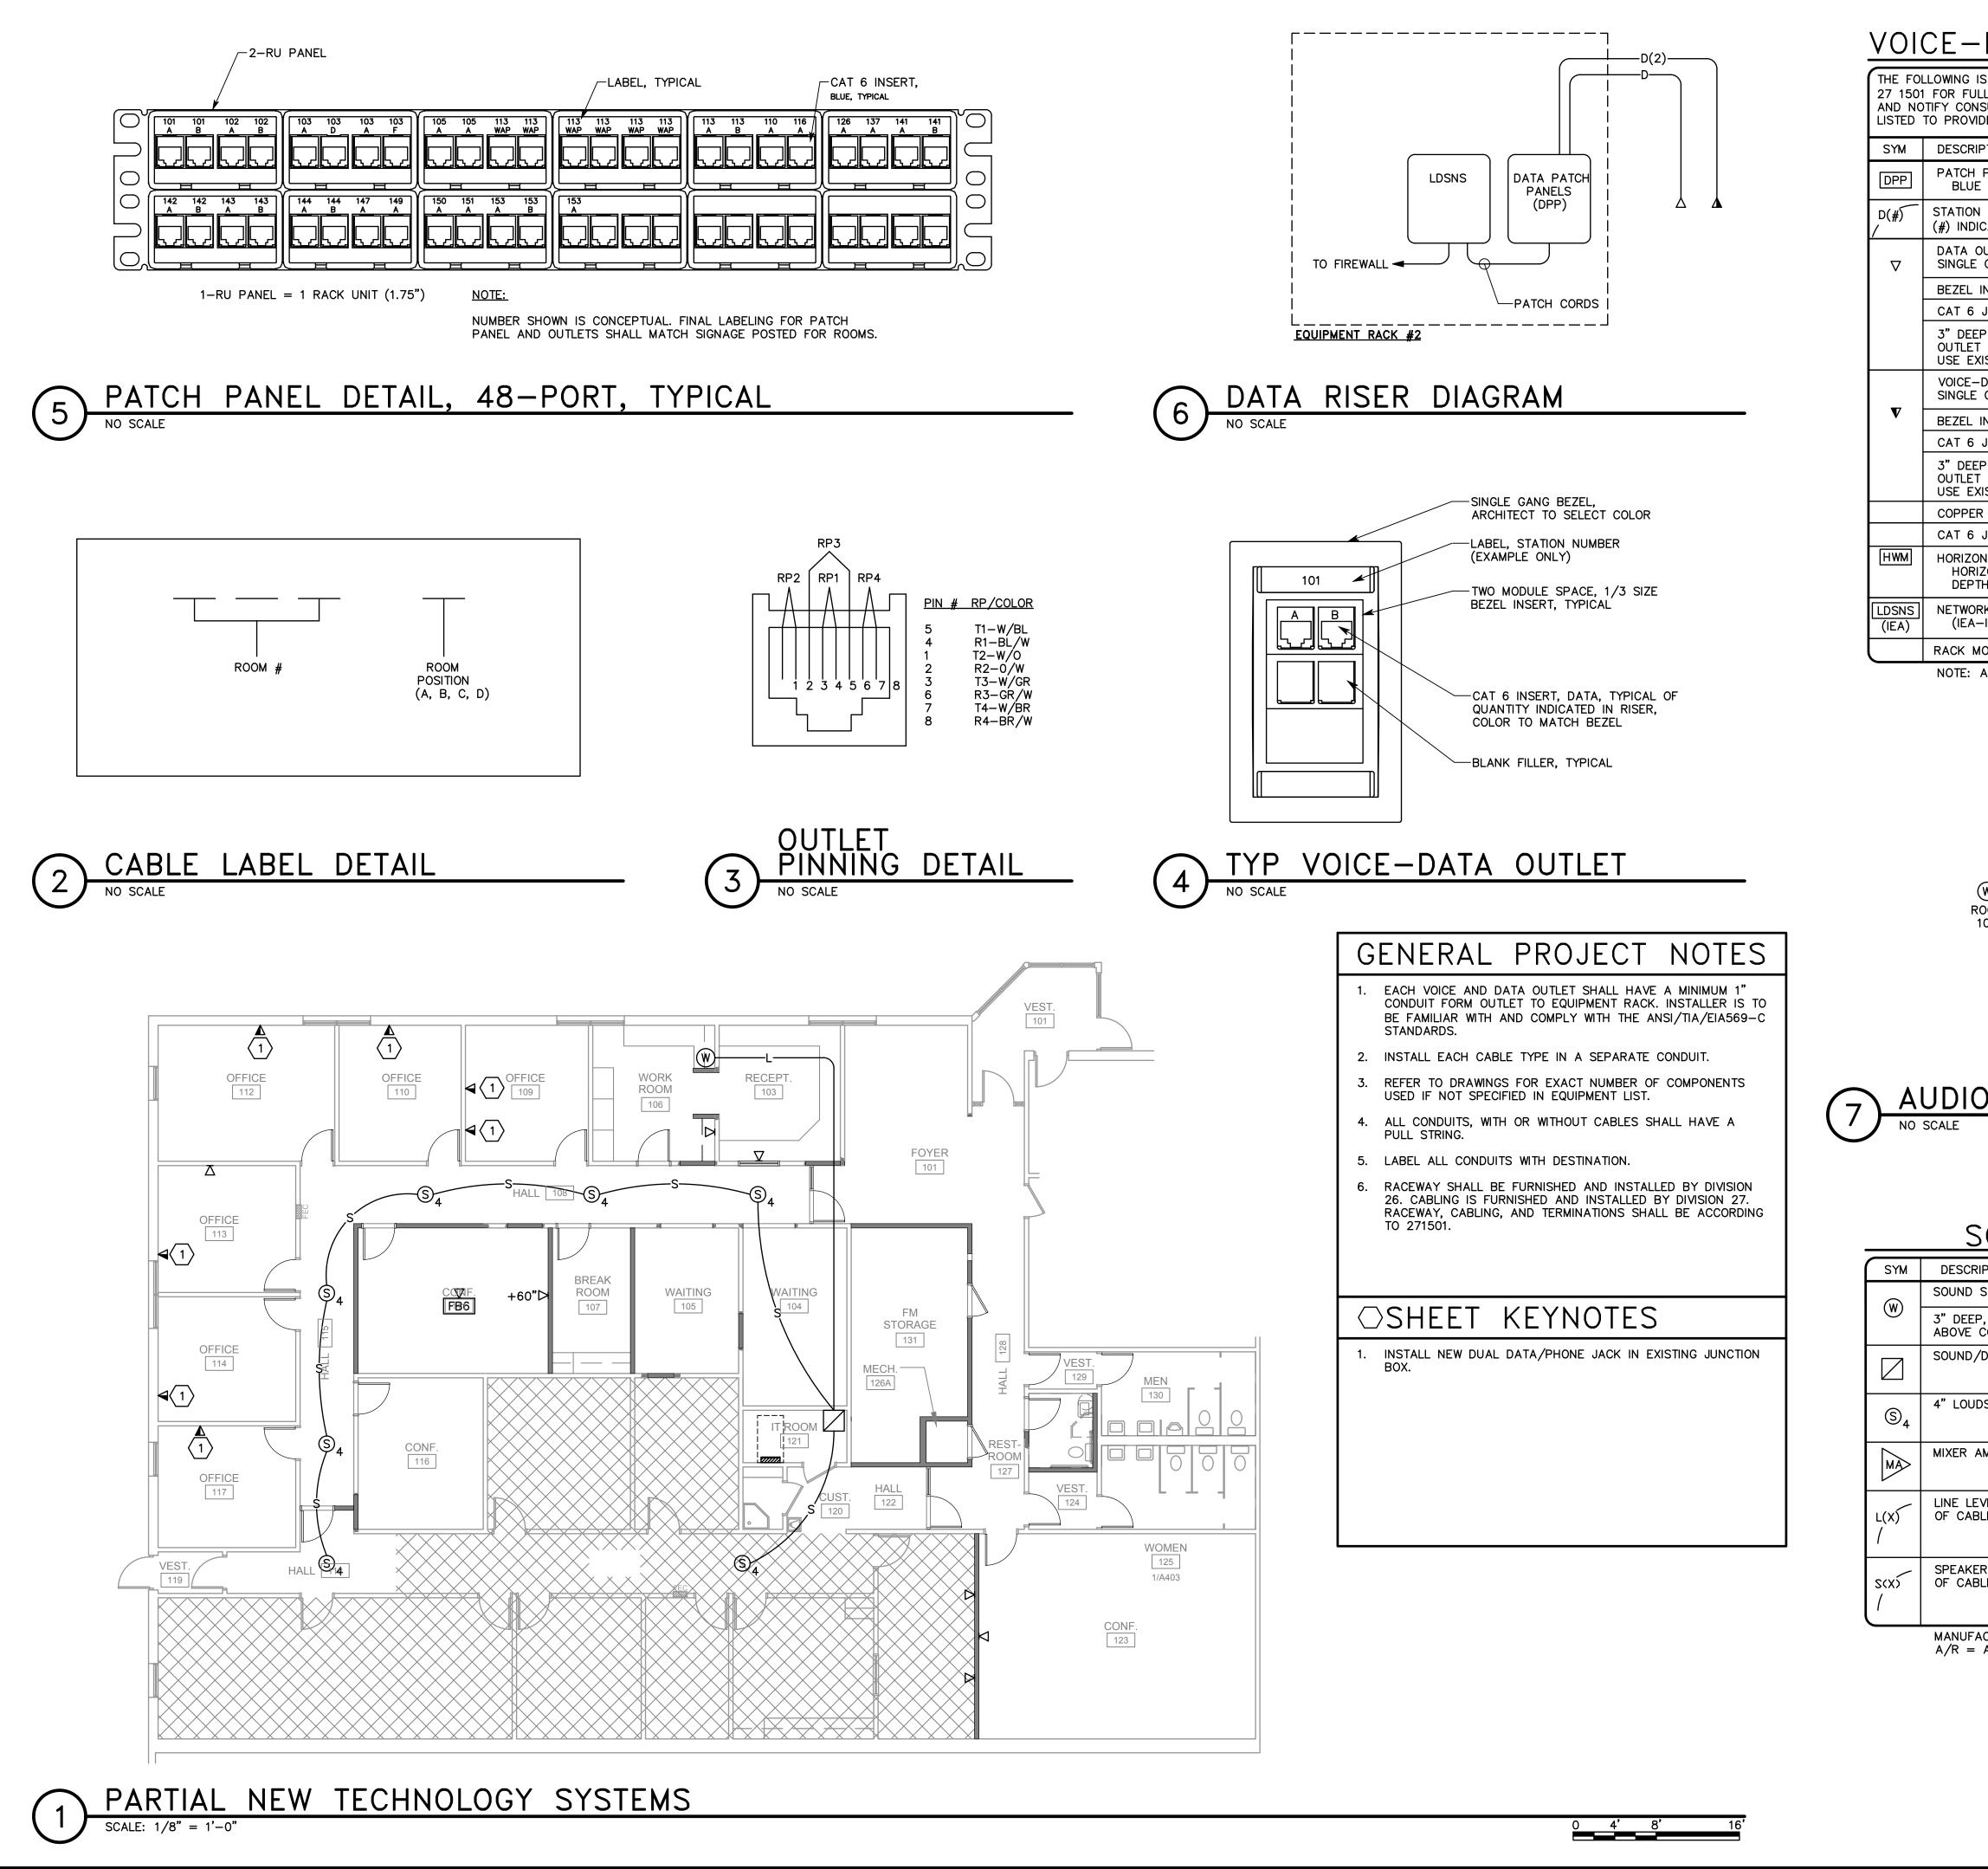

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AUDIO RISER DIAGRAM

SOUND SYSTEM EQUIPMENT LIST

RIPTION	QTY	ACCEPTABLE TYPES
SYSTEM INPUT	1	EMTECH MSC-W 3 RU
P, SINGLE GANG BOX MOUNTED COUNTER	1	
/DATA EQUIPMENT RACK, EXISTING	0	
DSPEAKER	OFP	ATLAS SOUND FC104T72 LOWELL JR410-T470 ELECTRO-VOICE 205-4T
AMPLIFIER	1	TOA BG-2035 W/ RACK KIT W/ EMTECH SMG-100 MODULE
EVEL CABLE, (X) INDICATES NUMBER BLES, IF MORE THAN ONE	A/R	BELDEN 9451 WEST PENN 454 LIBERTY 22–1P–EZ OR AS APPROVED BY CONSULTANT
ER CABLE, (X) INDICATES NUMBER BLES, IF MORE THAN ONE	A/R	BELDEN 8471 WEST PENN 225 LIBERTY 16–2C–GRY OR AS APPROVED BY CONSULTANT
ACTURER'S NAMES AND TELEPHONE NUM	BERS AF	RE LISTED IN THE SPECIFICATIONS

A/R = AS REQUIRED



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STAMP: POFESSION No. 5148728 DAVID G. HINCKLEY
SAT FAMILY SERVICES SANDY UT BISHOP'S STOREHOUSE 615 EAST 8400 SOUTH SANDY, UTAH
PROJECT FOR: THE CHURCH OF JESUS CHRIST OF LATTER-DAY SAINTS
PROJECT NUMBER: 5261066-18010106 DATE: 26 MAR 2018 PROPERTY NUMBER:
5261066 DRAWN BY: RRP/DGH DGH SHEET TITLE: TECHNOLOGY SYSTEMS
SHEET: ET101