

NEW JUNCTION BOX FOR

NEW SPEAKER RELAY

NEW EXHAUST FAN SOFFIT

GRILLE - SEE

ENLARGED REFLECTED

CEILING PLAN

MECHANICAL SHEETS

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GENERAL NOTES

This and any other drawings are not intended to be all-inclusive, nor to define the scope of all work required for this project. Demolition drawings are shown only to aid the Contractor in preparing his bid and performing the work. The Contractor and subcontractors shall examine all Contract Documents and visit the site during bidding as required to determine the total extent and scope of the demolition portion of this work. The Contractor shall perform this inspection prior to submitting a bid for the work. Submission of a bid will be construed as evidence that such an examination has been made and later claims will not be recognized for extra labor, equipment, or materials required because of difficulties encountered which could have been foreseen during the required site inspection. All items that

are not required to remain shall be of the demolition work whether shown specifically or not. The Contractor shall be responsible for all demolition work required to carry out the work as shown in the Contract Documents.

. Coordinate this sheet with all other Contract Documents.

Dimensions are to finished face of wall or finished face of ceiling unless otherwise noted.

Protect all items to be salvaged for reinstallation during construction from damage and from dust. Clean all salvaged items prior to reinstallation.

OWNER-FURNISHE	OWNER-FURNISHED ITEMS								
ITEM	FURNISHED BY	INSTALLED BY							
Baby Changing Station	Owner	Contractor							
Soap Dispenser	Owner	Contractor							
Paper Towel Dispenser	Owner	Contractor							

Toilet Tissue Dispenser Owner Contractor

ITEM	LOCATION	SALVAGED TO
Visual Display Board	Room 101	FM Group
Volume Control Switch	Room 101	FM Group



PLOTTED: 6/20/2017 7:32 AM

JESUS CHRIST OF LATTER-DAY SAINTS

Roxborough Park, Harvestland, aylorsville UT North Central Sta

SHEET TITLE:

ENLARGED PLANS, ELEVATIONS, AND DETAILS

| | ----- F====== COMPACT SEWER LINE TRENCH EXTEND NEW 4" SEWER BACKFILL. REPAIR LANDSCAPING LINE TO EXISTING SEWER AND IRRIGATION SYSTEM AS LATERAL - SEE PLUMBING NECESSARY - REPLACE THREE SHEETS. EXISTING SHRUBS WITH SAME TYPE OF NEW 5 GALLON

- ADD 12" MINIMUM

ALL AROUND NEW

WATER LINE CHASE

LOOSE FILL INSULATION

INSULATION

SEAL AROUND TRUSS

CHORD/FRAMING WITH EXPANDING FOAM

6"x6" PREFINISHED WHITE TRANSFER GRILLE —

GRILLES IN LOCATIONS AS

DIRECTED BY ARCHITECT

GRILLE BLACK. PROVIDE

PAINT AREA ABOVE

AND INSTALL THREE

2" RIGID INSULATION -

COLD WATER LINE


ATTIC WATER LINE DETAIL

SCALE: 1" = 1'-0"

FRAMING


TAPE JOINTS IN RIGID INSULATION

NOTCHED AROUND

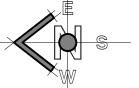

SHRUBS.

A101

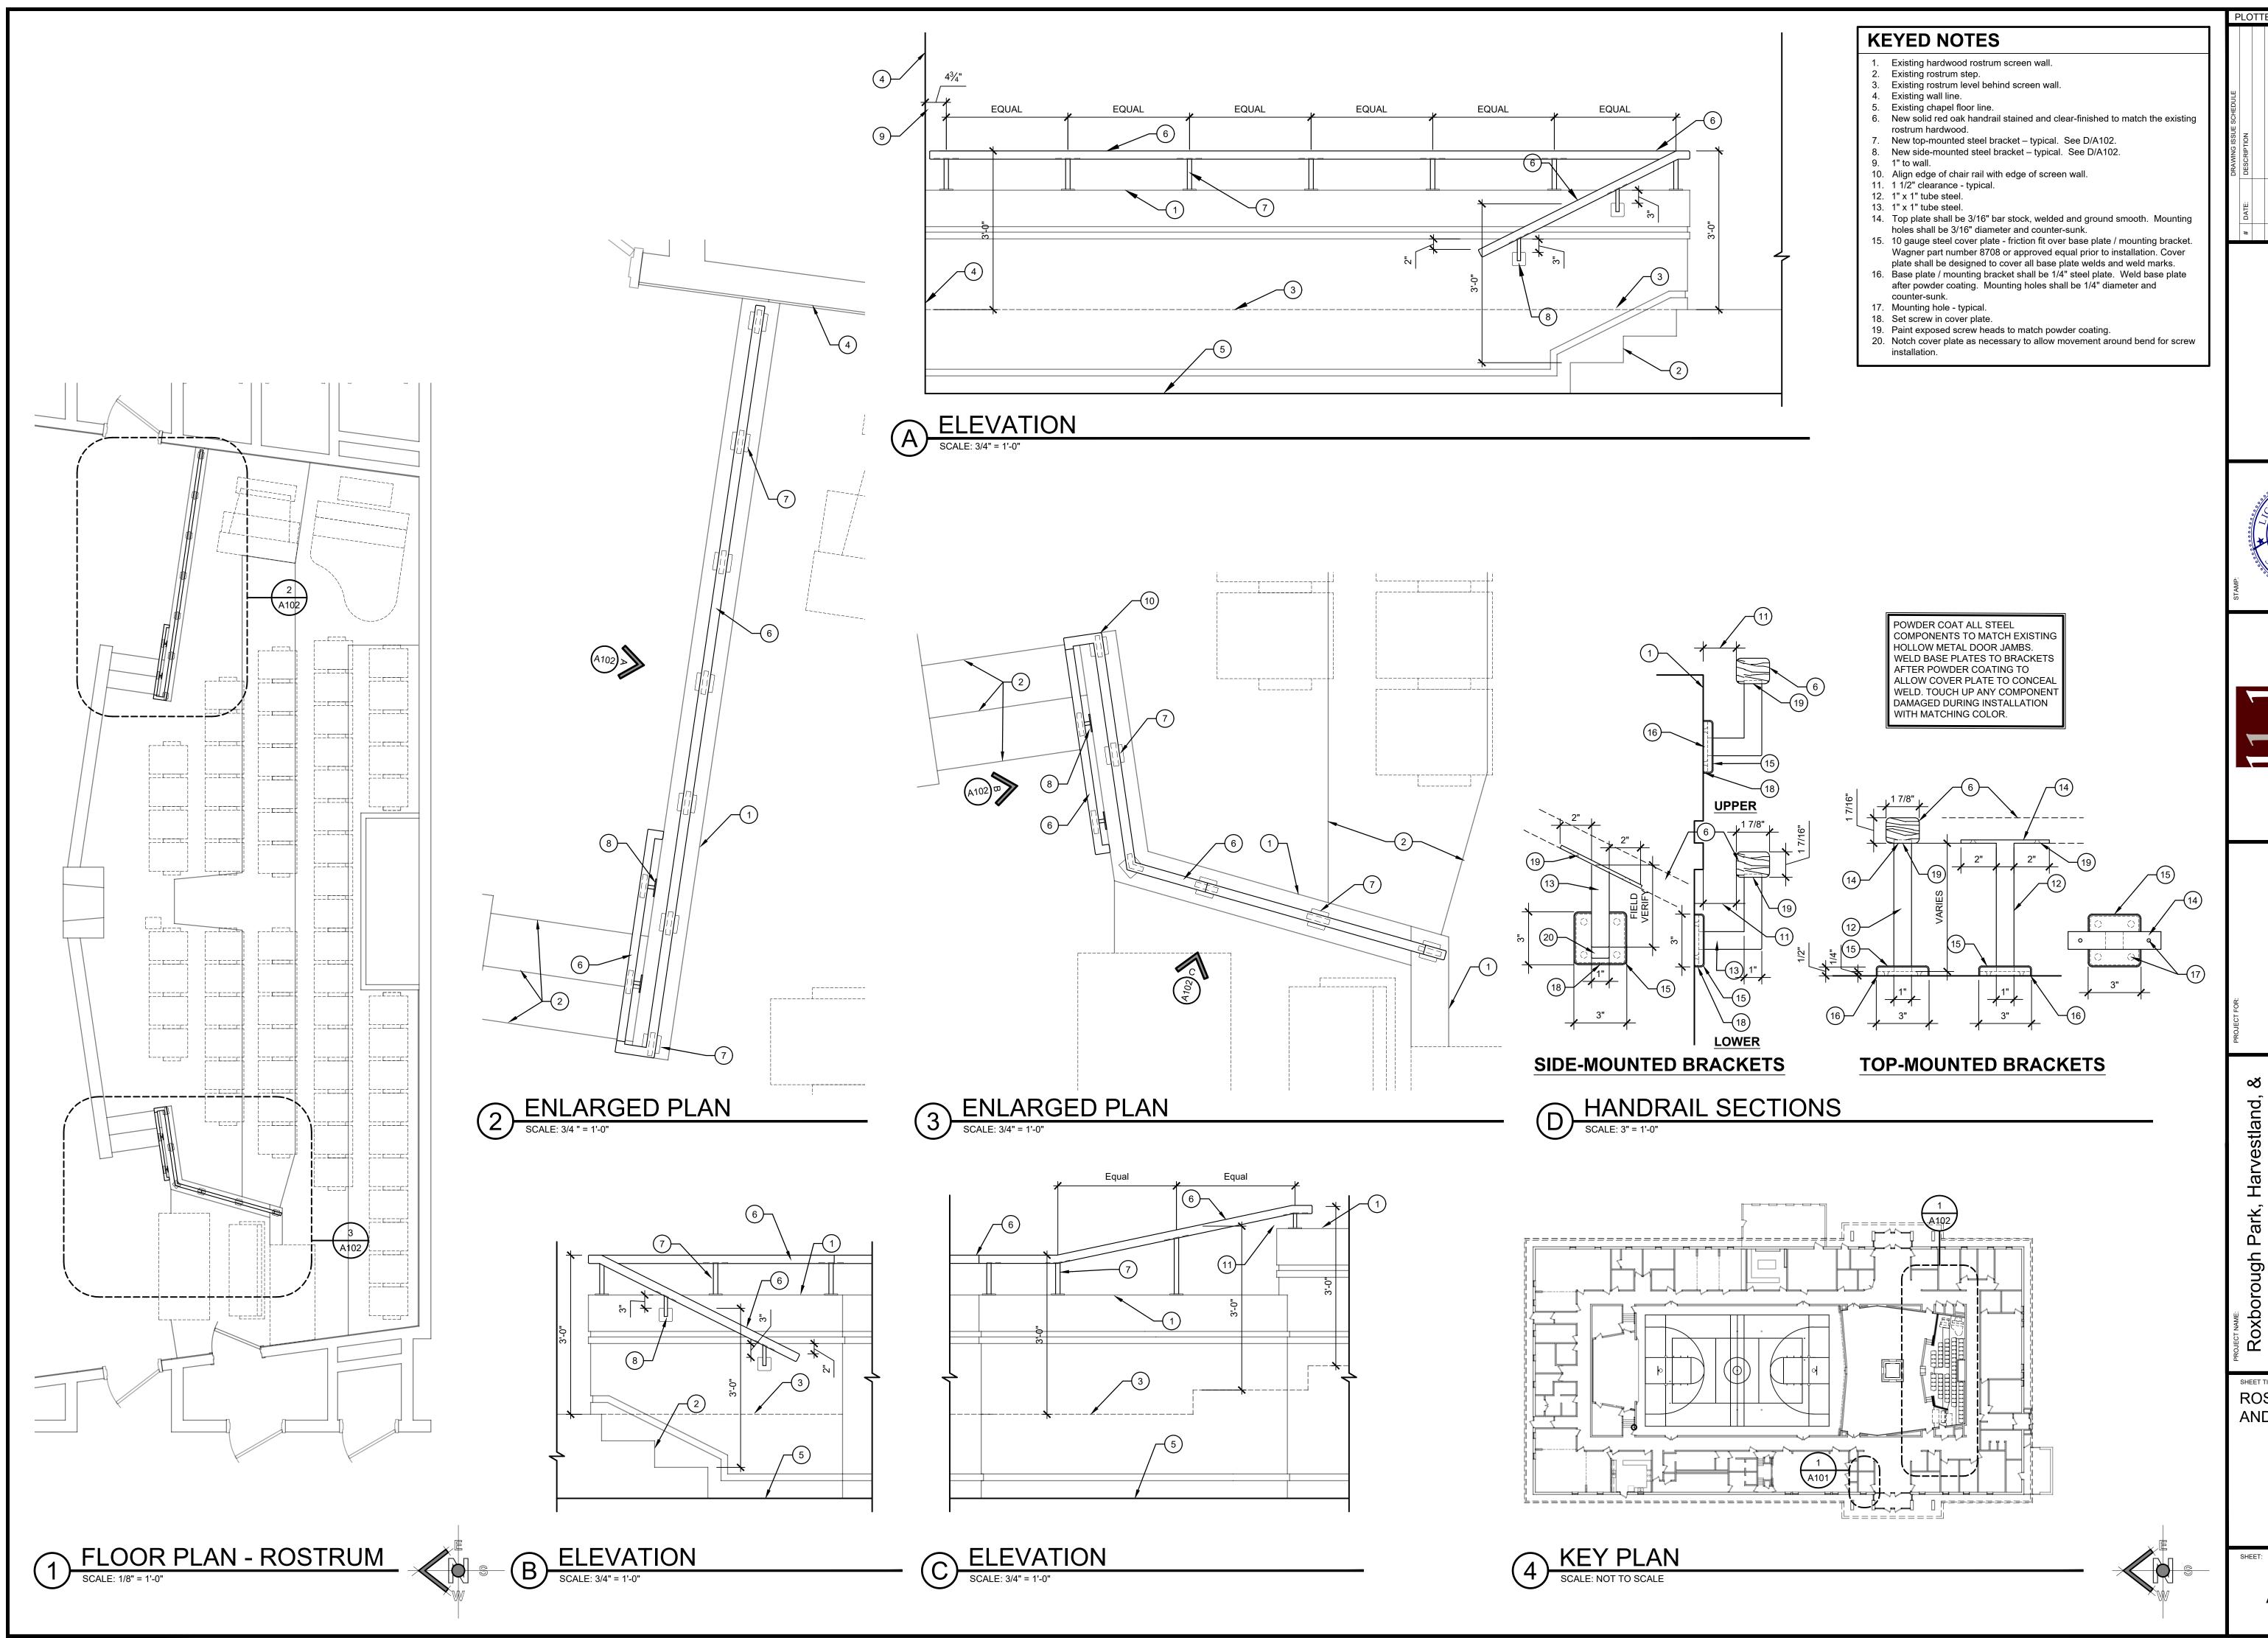

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ROSTRUM PLAN AND DETAILS

A102

	MECHANICAL SYMBOLS
	YMBOLS MAY NOT BE USED. D SYMBOLS INDICATE EXISTING EQUIPMENT, ETC
SYMBOL	EXPLANATION
ø	ROUND MEASUREMENT.
	RETURN AIR
+\$+	SUPPLY AIR
	EXHAUST AIR
	EXHAUST FAN
(A)	MECHANICAL EQUIPMENT SYMBOL
(# >	KEYED NOTE REFERENCE
#"ø #	DUCT SIZE FROM MAIN DUCT TO DIFFUSER. DIFFUSER OR GRILLE BALANCED TO CFM.
—SA—	SUPPLY AIR DUCTWORK
—RA—	RETURN AIR DUCTWORK
—EA—	EXHAUST AIR DUCTWORK

GENERAL MECHANICAL NOTES:

- ALL FRESH AIR INTAKES SHALL BE 10 FEET MIN. FROM ALL EXHAUST & PLUMBING VENTS.
- COORDINATE ALL WORK WITH OTHER TRADES AS REQUIRED.
 MECHANICAL CONTRACTOR SHALL VISIT THE PROJECT SITE DURING
- THE BIDDING PROCESS.

 4. REMOVE OR RELOCATE ANY EXISTING VENTURATION DUCTWORK AN
- 4. REMOVE OR RELOCATE ANY EXISTING VENTILATION DUCTWORK AND ASSOCIATED SUPPLY AIR/RETURN AIR REGISTERS IN CONFLICT WITH THIS MECHANICAL PLAN. COORDINATE ALL REQ'S WITH OWNER. EXTEND OR REMOVE & TERMINATE ANY DUCTWORK AS REQUIRED. MAINTAIN FUNCTIONALITY OF ALL DOWNLINE REGISTERS. RETURN ANY REMOVED EQUIPMENT TO OWNER OR DISPOSE AS DIRECTED BY OWNER. VERIFY ALL ITEMS WITH OWNER.

MECHANICAL PERFORMANCE NOTES:

M1. COORDINATE EXACT LOCATION OF ALL MECHANICAL UNITS WITH GENERAL CONTRACTOR. VERIFY IN FIELD.

SEISMIC SUPPORT NOTES:

BRACING FOR SUSPENDED DUCTWORK, ETC

- PER ASCE STANDARD 7-10 SEISMIC SUPPORTS ARE NOT REQUIRED FOR EITHER OF THE FOLLOWING CONDITIONS:

 A. HVAC DUCTS ARE SUSPENDED WITH HANGERS 12" OR
- LESS IN LENGTH.
 B. HVAC DUCTS HAVE A CROSS—SECTIONAL AREA OF LESS
 THAN 6 SQUARE FEET.
- 2. IF INSTANCES OCCUR WHERE HVAC DUCT IS SUSPENDED WITH HANGERS GREATER THAN 12" IN LENGTH AND HVAC DUCT HAS A CROSS—SECTIONAL AREA GREATER THAN 6 SQUARE FEET SYSTEM CONNECTORS AND COMPONENTS SHALL BE COMPATIBLE AND DESIGNED FOR THE APPLICATION THAT THEY ARE USED FOR. SHALL HAVE A MINIMUM OF TWO TRANSVERSE BRACES PER STRAIGHT DUCT RUN WITH A MAXIMUM DISTANCE OF 30' BETWEEN TRANSVERSE BRACES. SHALL HAVE A MINIMUM OF ONE LONGITUDINAL BRACE PER STRAIGHT DUCT RUN WITH A MAXIMUM DISTANCE OF 40' BETWEEN LONGITUDINAL BRACES. BRACING SHALL ONLY OCCUR AT OR NEAR AREAS WHERE SUFFICIENT DUCT STIFFNESS IS PRESENT (AT OR NEAR JOINT CONNECTIONS).
- . FOR SEISMIC BRACING OF MECHANICAL EQUIPMENT AN INDEPENDENT SEISMIC AND VIBRATION CONTROL SUBCONTRACTOR WITH EXPERIENCE, COMPUTING CAPABILITIES. AND MANUFACTURED PRODUCTS SHALL BE FURNISHED BY MECHANICAL CONTRACTOR. INDEPENDENT SEISMIC CONSULTANT SHALL PROVIDE REQUIRED COMPUTATIONS, SHOP DRAWINGS, AND MANUFACTURED PRODUCTS TO MEET THE MINIMUM REQUIREMENTS OF ASCE 7-10 AND INTERNATIONAL BUILDING CODES (LATEST ADOPTED EDITION) FOR THE RESPECTIVE SEISMIC DESIGN FOR SEISMIC ZONE WITH IMPORTANCE FACTOR 1.5. SEISMIC SUBCONTRACTOR SHALL EXERCISE THE QUALITY CONTROL FOR THIS WORK AND SHALL NOT BE LIMITED TO INSTRUCTIONS DIRECTED TO THE MECHANICAL CONTRACTOR. THE SEISMIC SUBCONTRACTOR SHALL CERTIFY IN WRITING THAT THEY HAVE INSPECTED THE INSTALLATION AND THAT ALL ISOLATION ANCHORS AND SEISMIC RESTRAINT MATERIALS ARE INSTALLED CORRECTLY AND FUNCTIONING PROPERLY. CERTIFICATION SHALL BE PROVIDED AFTER ALL CORRECTIVE WORK HAS BEEN COMPLETED.

SEISMIC SUPPORT NOTES:

- BRACING FOR SUSPENDED PIPING, ETC
- PER ASCE STANDARD 7-10 SEISMIC SUPPORTS ARE NOT REQUIRED FOR THE FOLLOWING CONDITION:

 A. PIPING IS SUPPORTED BY ROD HANGERS 12" OR LESS IN LENGTH FROM THE TOP OF THE PIPE TO THE
 - SUPPORTING STRUCTURE.

 B. HIGH-DEFORMABILITY PIPING IS USED.
- 2. IF INSTANCES OCCUR WHERE PIPING IS SUSPENDED BY HANGERS GREATER THAN 12" IN LENGTH. SYSTEM CONNECTORS AND COMPONENTS SHALL BE COMPATIBLE AND DESIGNED FOR THE APPLICATION THAT THEY ARE USED FOR. SHALL HAVE A MINIMUM OF TWO TRANSVERSE BRACES PER STRAIGHT PIPING RUN. THE MAXIMUM DISTANCE BETWEEN TRANSVERSE BRACES WILL BE DETERMINED BY PIPE SIZE AND PIPING COMPOSITION. SHALL HAVE A MINIMUM OF ONE LONGITUDINAL BRACE PER STRAIGHT DUCT RUN. IF LENGTH OF PIPING EXCEEDS LONGITUDINAL BRACE SPACING, ADDITIONAL LONGITUDINAL BRACES WILL BE REQUIRED.
- FOR SEISMIC BRACING OF PLUMBING EQUIPMENT AND PIPING AN INDEPENDENT SEISMIC AND VIBRATION CONTROL SUBCONTRACTOR WITH EXPERIENCE, COMPUTING CAPABILITIES, AND MANUFACTURED PRODUCTS SHALL BE FURNISHED BY PLUMBING CONTRACTOR. INDEPENDENT SEISMIC CONSULTANT SHALL PROVIDE REQUIRED COMPUTATIONS, SHOP DRAWINGS, AND MANUFACTURED PRODUCTS TO MEET THE MINIMUM REQUIREMENTS OF ASCE 7-10 AND INTERNATIONAL BUILDING CODES (LATEST ADOPTED EDITION) FOR THE RESPECTIVE SEISMIC DESIGN FOR SEISMIC ZONE WITH IMPORTANCE FACTOR 1.5. SEISMIC SUBCONTRACTOR SHALL EXERCISE THE QUALITY CONTROL FOR THIS WORK AND SHALL NOT BE LIMITED TO INSTRUCTIONS DIRECTED TO THE PLUMBING CONTRACTOR. THE SEISMIC SUBCONTRACTOR SHALL CERTIFY IN WRITING THAT THEY HAVE INSPECTED THE INSTALLATION AND THAT ALL ISOLATION ANCHORS AND SEISMIC RESTRAINT MATERIALS ARE INSTALLED CORRECTLY AND FUNCTIONING PROPERLY. CERTIFICATION SHALL BE PROVIDED AFTER ALL CORRECTIVE WORK HAS BEEN

PLUMBING SYMBOLS

NOTES: 1. ALL SYMBOLS MAY N 2. DOTTED SYMBOLS IN	NOT BE USED. DICATE EXISTING EQUIPMENT, ETC	15
—s——s—	SANITARY OR WASTE PIPING	
	VENT PIPING	1 16
сw	COLD WATER PIPING	
———HW———	HOT WATER PIPING	
———GAS———	GAS PIPING	
SD	STORM DRAIN PIPING	
——ss——	UNDERGROUND STORM SEWER PIPING	P
RD	ROOF DRAIN PIPING	P:
——ORD——	OVERFLOW ROOF DRAIN PIPING] -
OSD	OVERFLOW STORM DRAIN PIPING	P:
———GR———	GREASE PIPING]
—— RW ——	RECIRCULATION WATER PIPING	- P
0	PIPE RISER OR FIXTURE CONNECTION	P!
+	WALL HYDRANT/HOSE BIBB	
(FLOOR DRAIN] L
0	AREA DRAIN	1
PRV—	PRESSURE REDUCING VALVE STATION	
────	GATE VALVE & BACKFLOW PREVENTOR	

GENERAL PLUMBING NOTES:

- 1. SEE WASTE AND VENT PIPING SCHEMATIC(S) FOR ADDITIONAL INFORMATION ON PIPING SIZES.
- 2. SEE WATER PIPING SCHEMATIC(S) FOR ADDITIONAL INFORMATION ON PIPING SIZES.
- 3. CONTRACTOR SHALL VERIFY LOCATION, SIZE, AND DEPTH OF ALL UTILITIES PRIOR TO BEGINNING OF CONSTRUCTION.
- 4. COORDINATE ALL WORK WITH OTHER TRADES AS REQUIRED.

5. CONCEAL ALL PIPING IN FINISHED AREAS.

- 6. PROVIDE AND INSTALL ALL REQUIRED VALVES IN PIPING SYSTEM.
- 7. INSULATE ALL HOT AND COLD WATER PIPING PER APPLICABLE
- 8. MAKE PROVISIONS FOR A TRAP GUARD WHERE REQUIRED.
- 9. PLUMBING CONTRACTOR SHALL VISIT THE PROJECT SITE DURING THE BIDDING PROCESS.
- 10. PLUMBING CONTRACTOR SHALL DETERMINE ACTUAL PIPE ROUTING IN FIELD PER AVAILABLE SPACE AND BUILDING CONSTRUCTION.
- 11. PROVIDE AND INSTALL ALL REQUIRED CLEANOUTS. CLEANOUTS FOR HORIZONTAL DRAINS SHALL BE INSTALLED NO MORE THAN 100' APART. CLEANOUTS SHALL BE INSTALLED AT EACH CHANGE OF DIRECTION GREATER THAN 45". A CLEANOUT SHALL BE PROVIDED AT THE BASE OF EACH WASTE OR SOIL STACK. CLEANOUTS SHALL BE ACCESSIBLE AND THE SAME SIZE AS THE WASTE LINES ON WHICH THEY ARE INSTALLED.
- 12. ALL PLUMBING VENTS MUST BE A MINIMUM 10-FEET FROM ALL FRESH AIR INTAKES.
- 13. WATER PIPING MATERIAL SHALL MEET THE STANDARDS SET FORTH IN IPC TABLES 605.3, 605.4 & 605.5.
- 14. SANITARY WASTE AND VENT PIPING MATERIAL SHALL MEET THE STANDARDS SET FORTH IN IPC TABLES 702.1, 702.2 AND 702.3 & 702.4.
- 15. REMOVE OR RELOCATE ANY EXISTING PLUMBING FIXTURES & ASSOCIATED PIPING IN CONFLICT WITH THIS PLUMBING PLAN. COORDINATE ALL REQ'S WITH OWNER. EXTEND OR REMOVE & TERMINATE ANY PIPING AS REQUIRED. MAINTAIN FUNCTIONALITY OF ALL DOWNLINE FIXTURES. RETURN ANY REMOVED FIXTURES & PIPING TO OWNER OR DISPOSE FIXTURES AND PIPING AS DIRECTED BY OWNER. VERIFY ALL ITEMS WITH OWNER.
- 16. TRENCHES THAT ARE EXCAVATED BELOW THE INSTALLATION LEVEL OF PIPE (SUCH THAT THE TRENCH BOTTOM DOES NOT FORM THE BED FOR THE PIPE) SHALL BE BACKFILLED TO THE INSTALLATION LEVEL OF THE BOTTOM OF THE PIPE WITH SAND OR FINE GRAVEL PACED IN LAYERS OF 6 INCHES MAXIMUM DEPTH. THE BACKFILL SHALL BE COMPACTED AFTER EACH PLACEMENT. IPC 306.2.1


PLUMBING PERFORMANCE NOTES:


- P1. MAKE CONNECTION TO EXISTING WATER SUPPLY LINE. FIELD LOCATE AND VERIFY SIZE AND ALL REQUIREMENTS.
- P2. MAKE CONNECTION TO EXISTING SEWER LINE. MODIFY SEWER LINE TO ACCOMMODATE NEW PLUMBING FIXTURES. PROVIDE AND INSTALL ALL REQUIRED CLEANOUTS.
- P3. PLUMBING CONTRACTOR SHALL PROVIDE AND INSTALL WATER
 TEMPERING DEVICE (SHALL CONFORM TO ASSE 1070) FOR ALL
 HAND WASH AREAS IN PROJECT. HOT WATER TEMPERATURE SHALL
 HAVE A MAXIMUM TEMPERATURE OF 110° F. 2015 IPC 607.1.2.
- P4. COORDINATE ALL REQUIRED SAW CUTTING OF EXISTING FLOOR OR SLAB FOR DRAIN PIPING, ETC. WITH GENERAL CONTRACTOR. REPAIR FLOOR OR SLAB AS DIRECTED BY GENERAL CONTRACTOR.
- P5. PLUMBING CONTRACTOR TO INSTALL WATER LINE IN ATTIC WITHIN BUILDING THERMAL ENVELOPE. IT WILL BE NECESSARY TO BUILD A BOX AROUND WATER LINE AND ENSURE THAT THE BOX IS COVERED BY ATTIC INSULATION. WATER LINE SHALL BE INSULATED FROM COLD ATTIC.

DRAWING ISSUE SCHEDULE

DESCRIPTION

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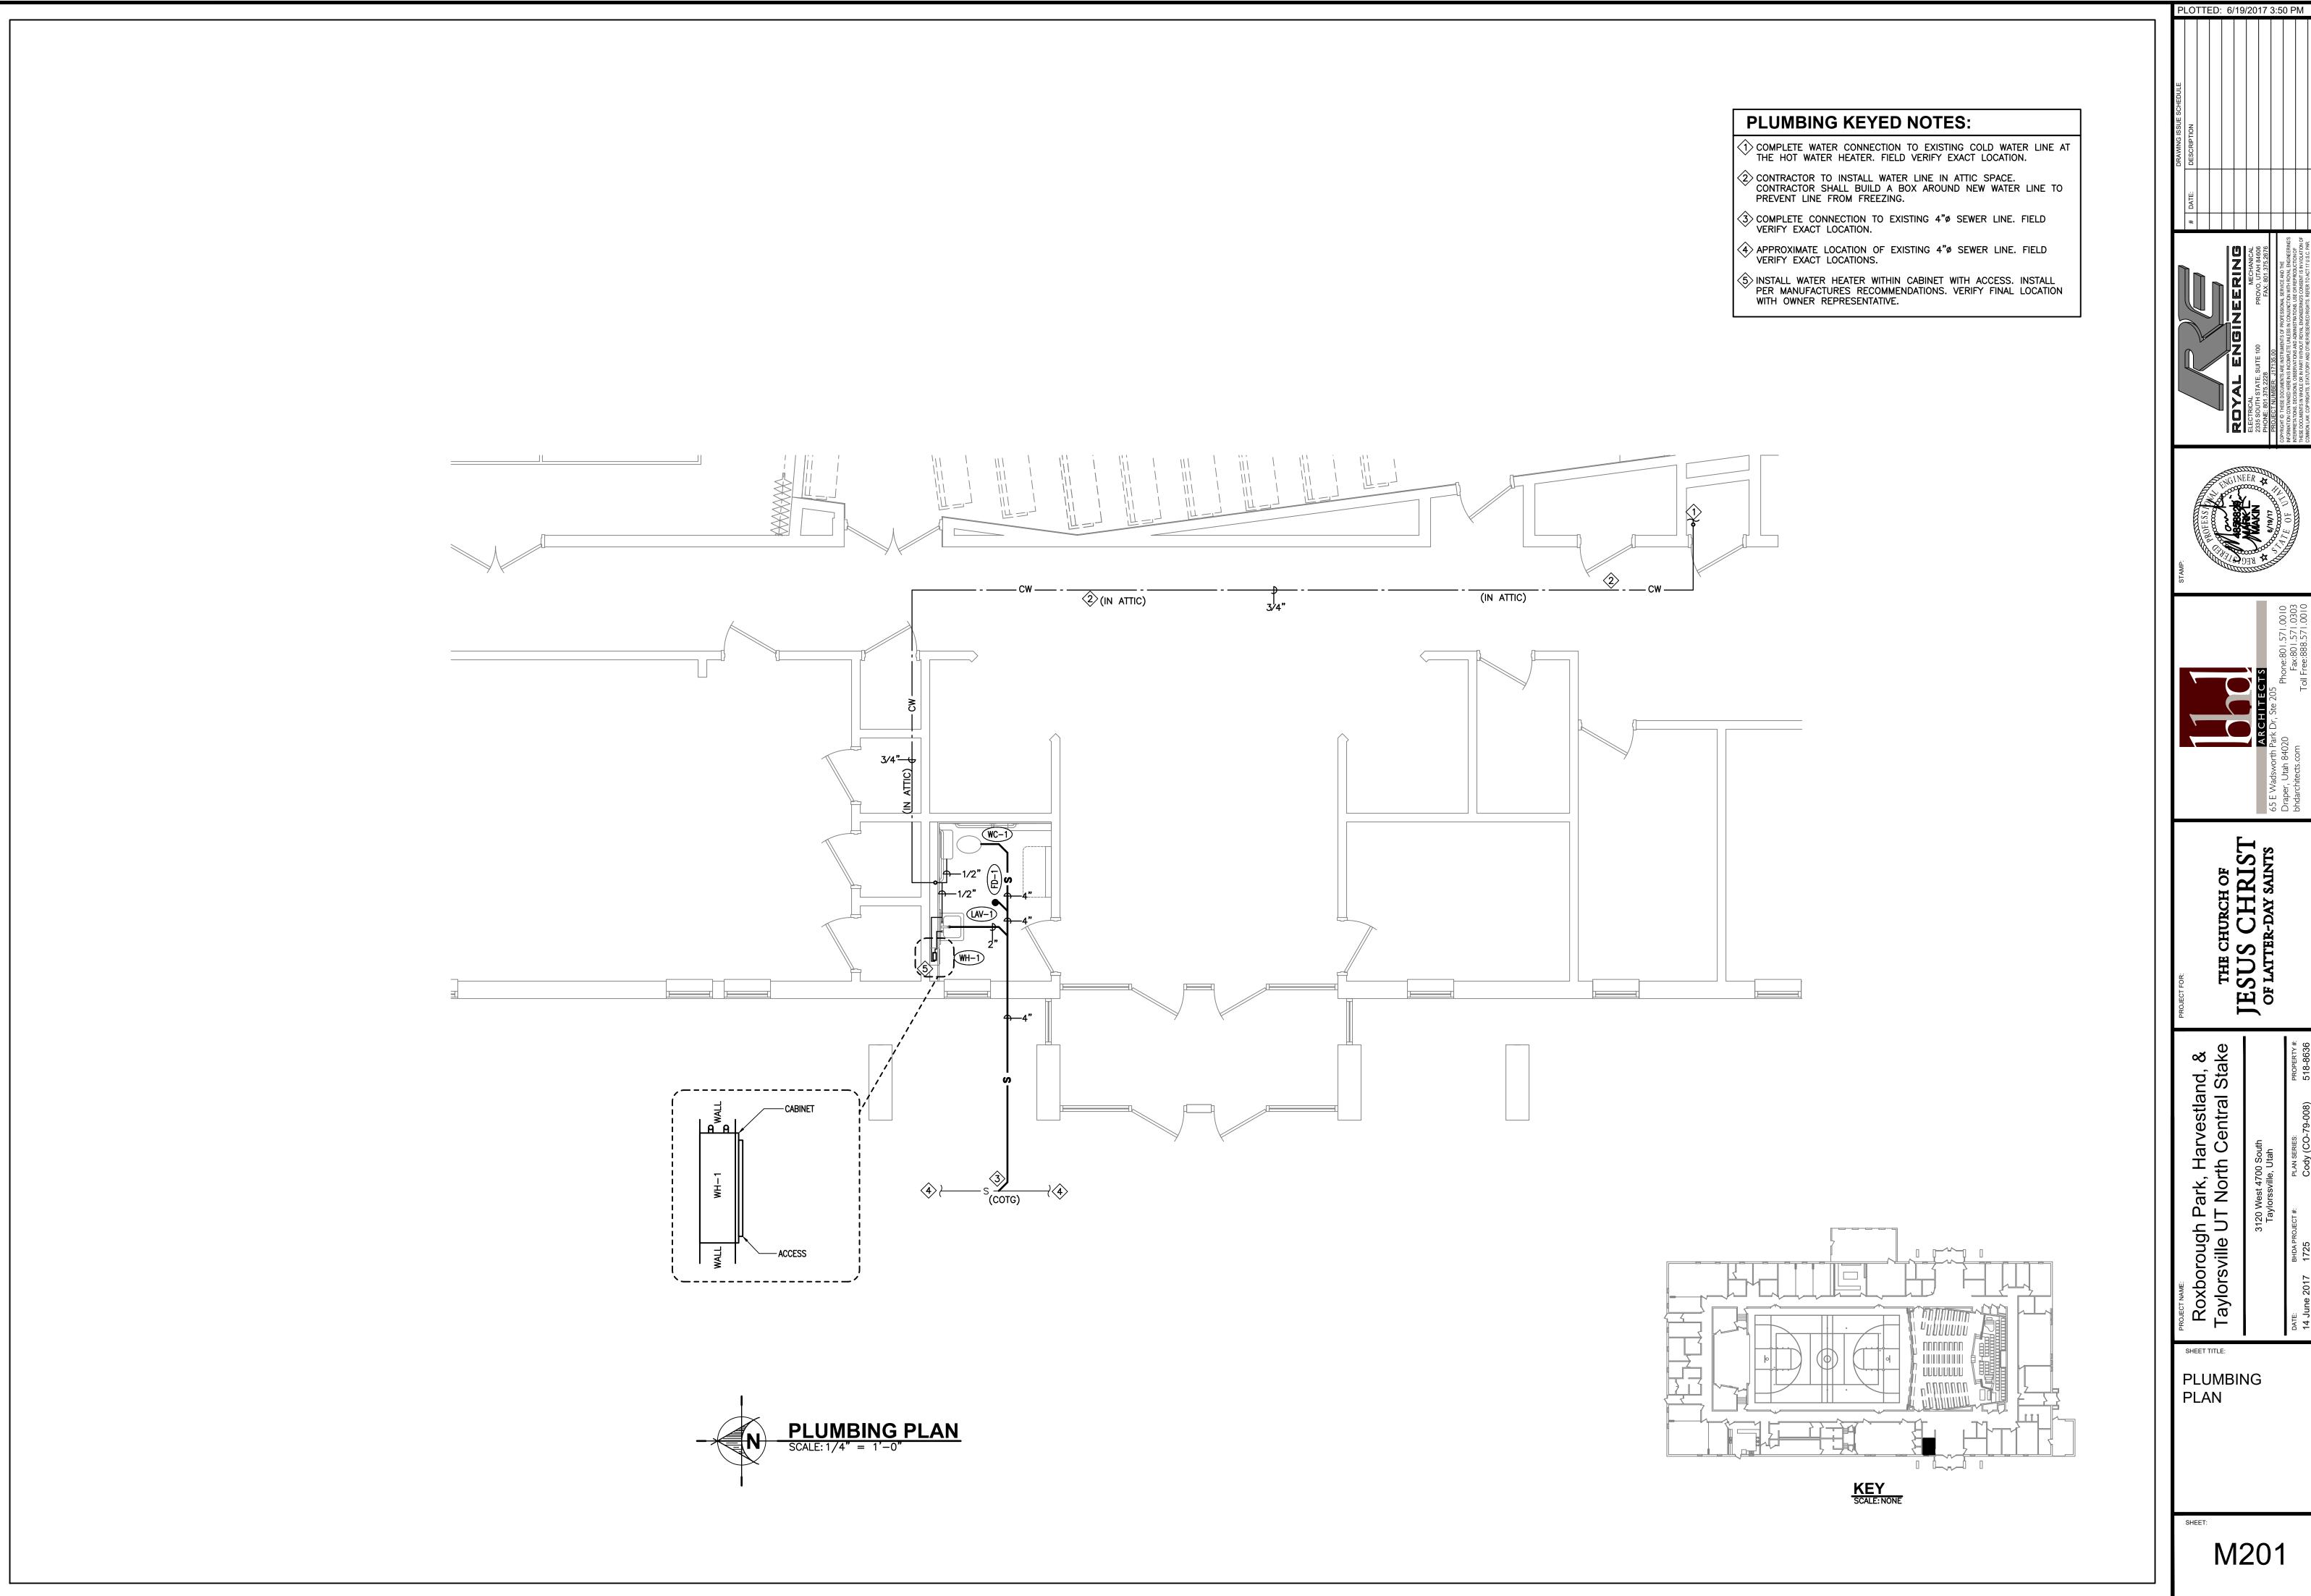
JESUS CHRIST OF LATTER-DAY SAINTS

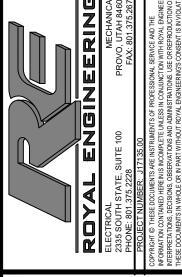4700 South rille, Utah

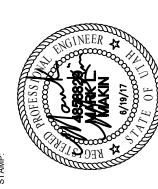Roxborough Park,
Taylorsville UT Nort


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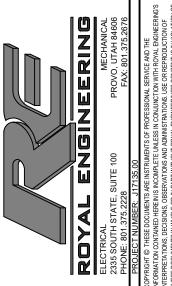
NOTES & SYMBOLS











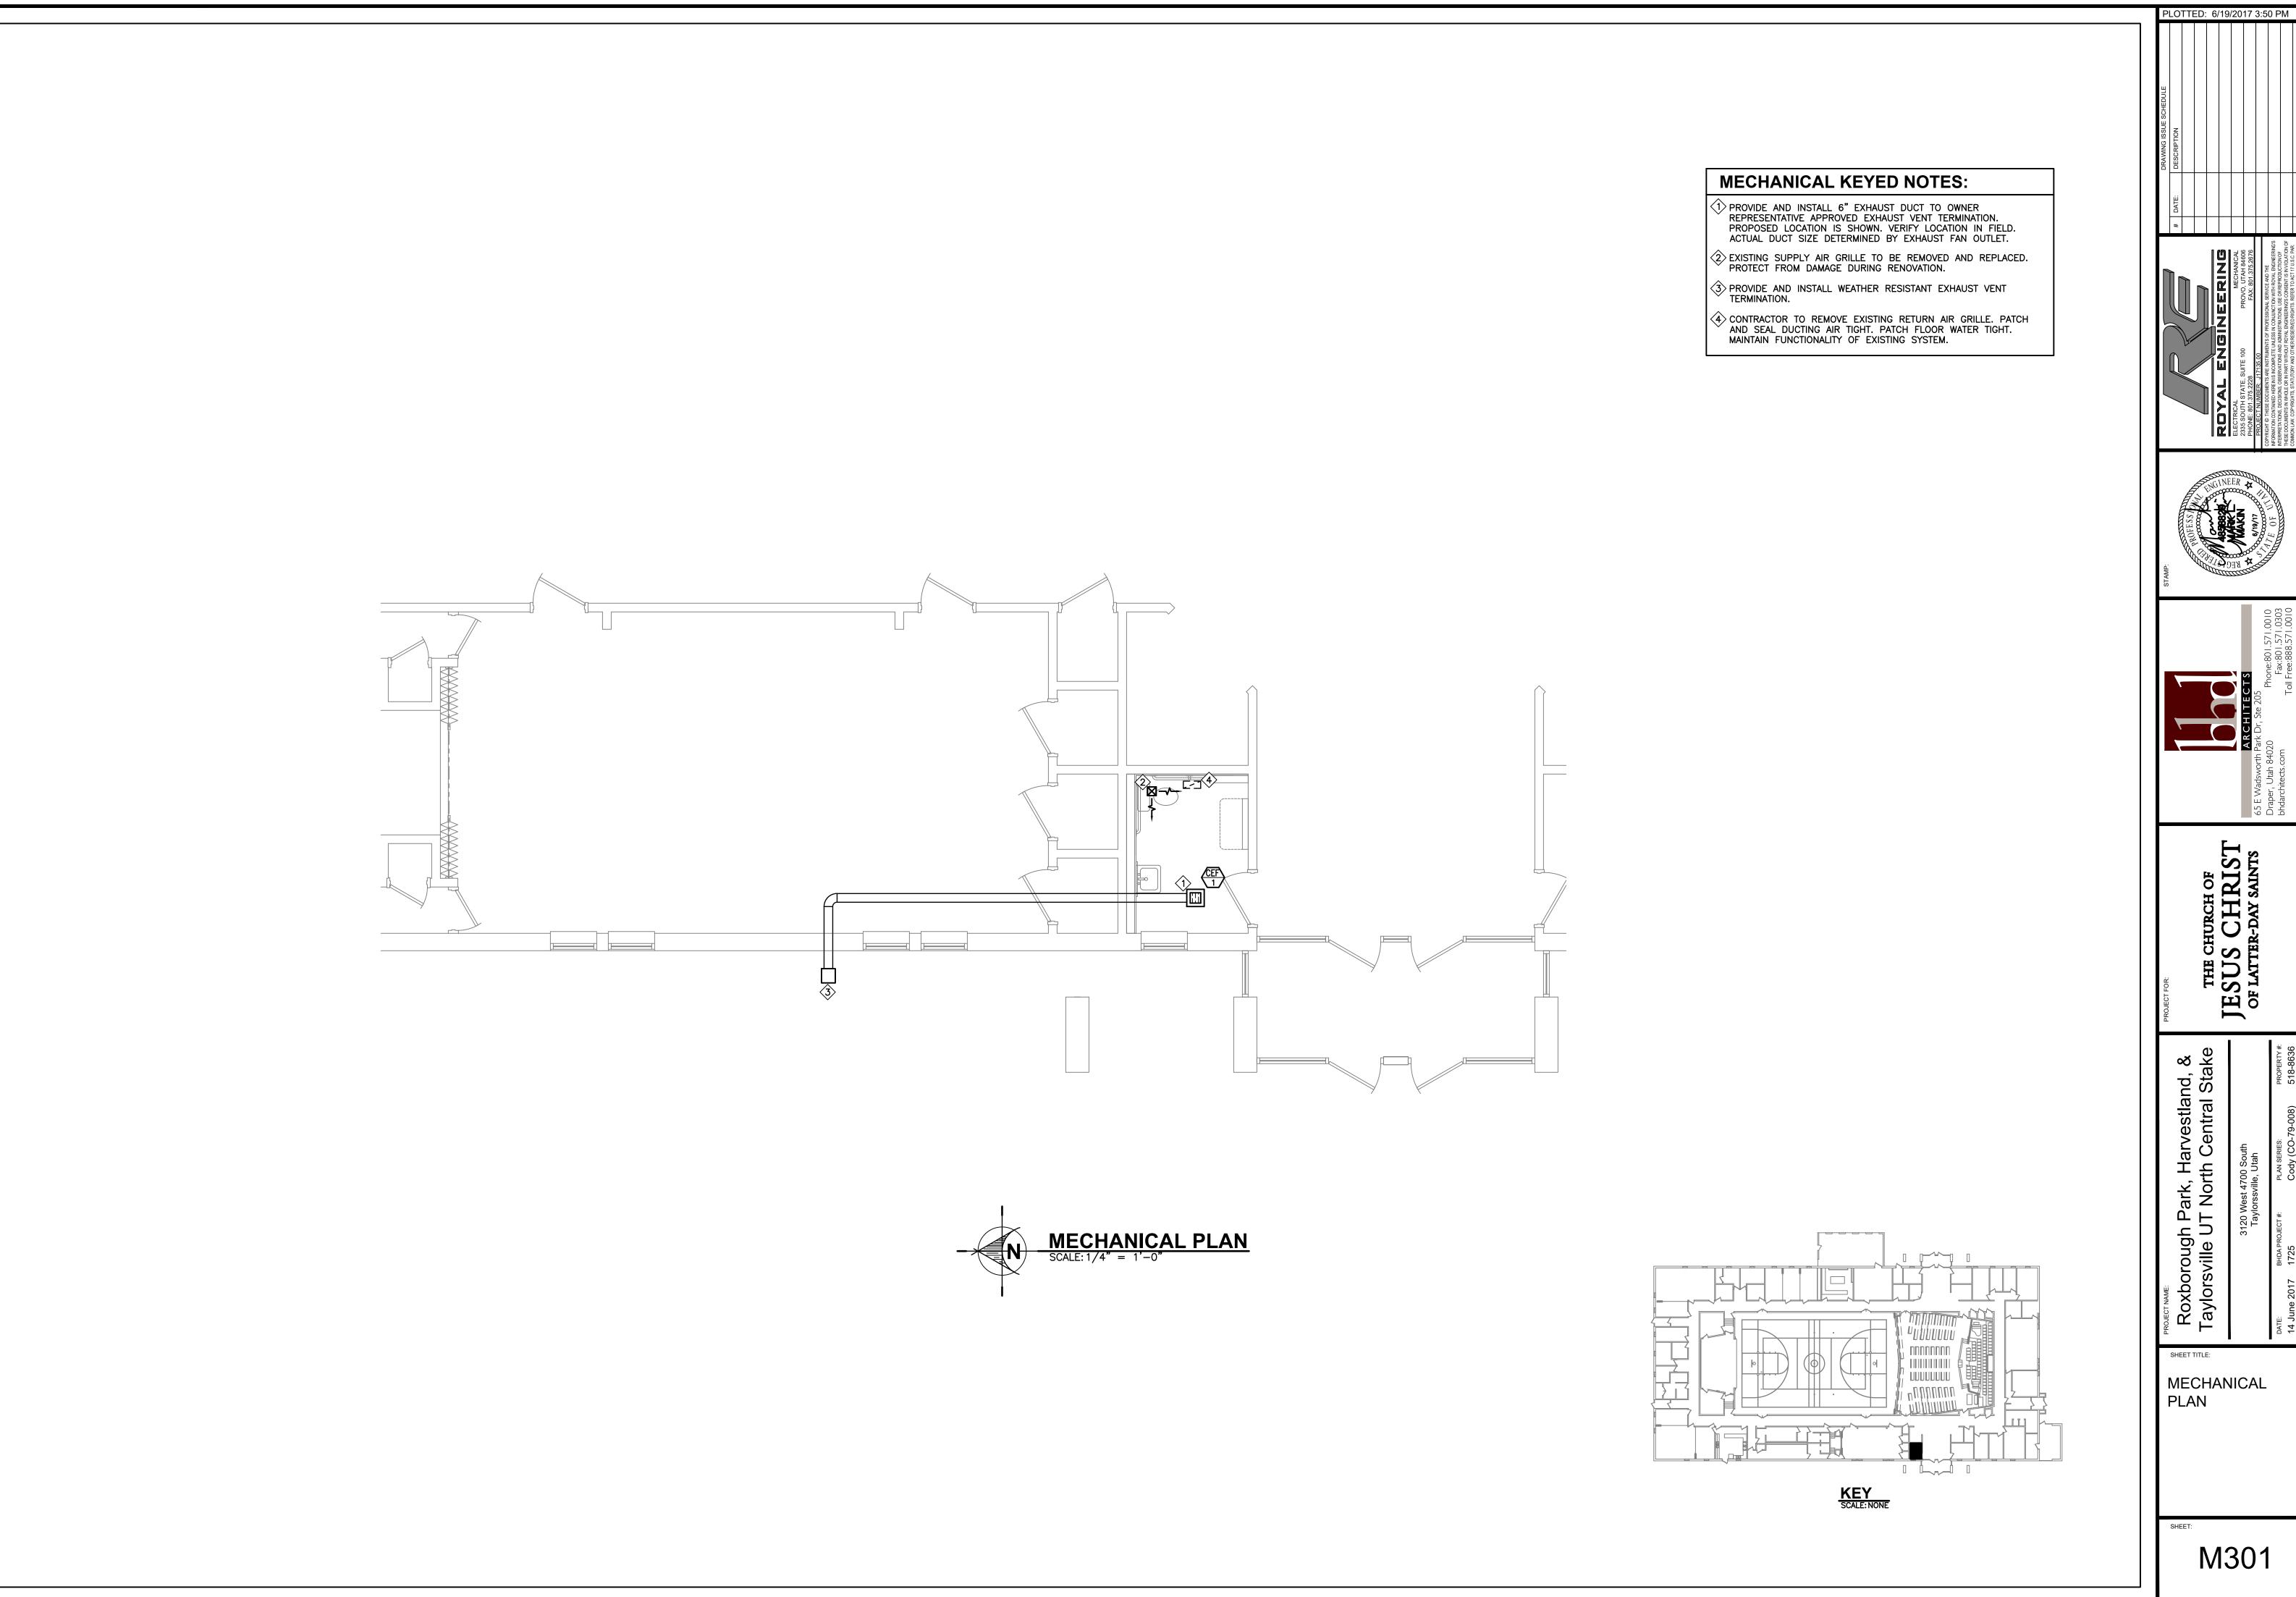


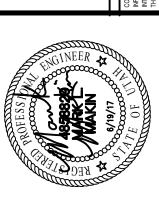



JESUS CHRIST OF LATTER-DAY SAINTS

MECHANICAL

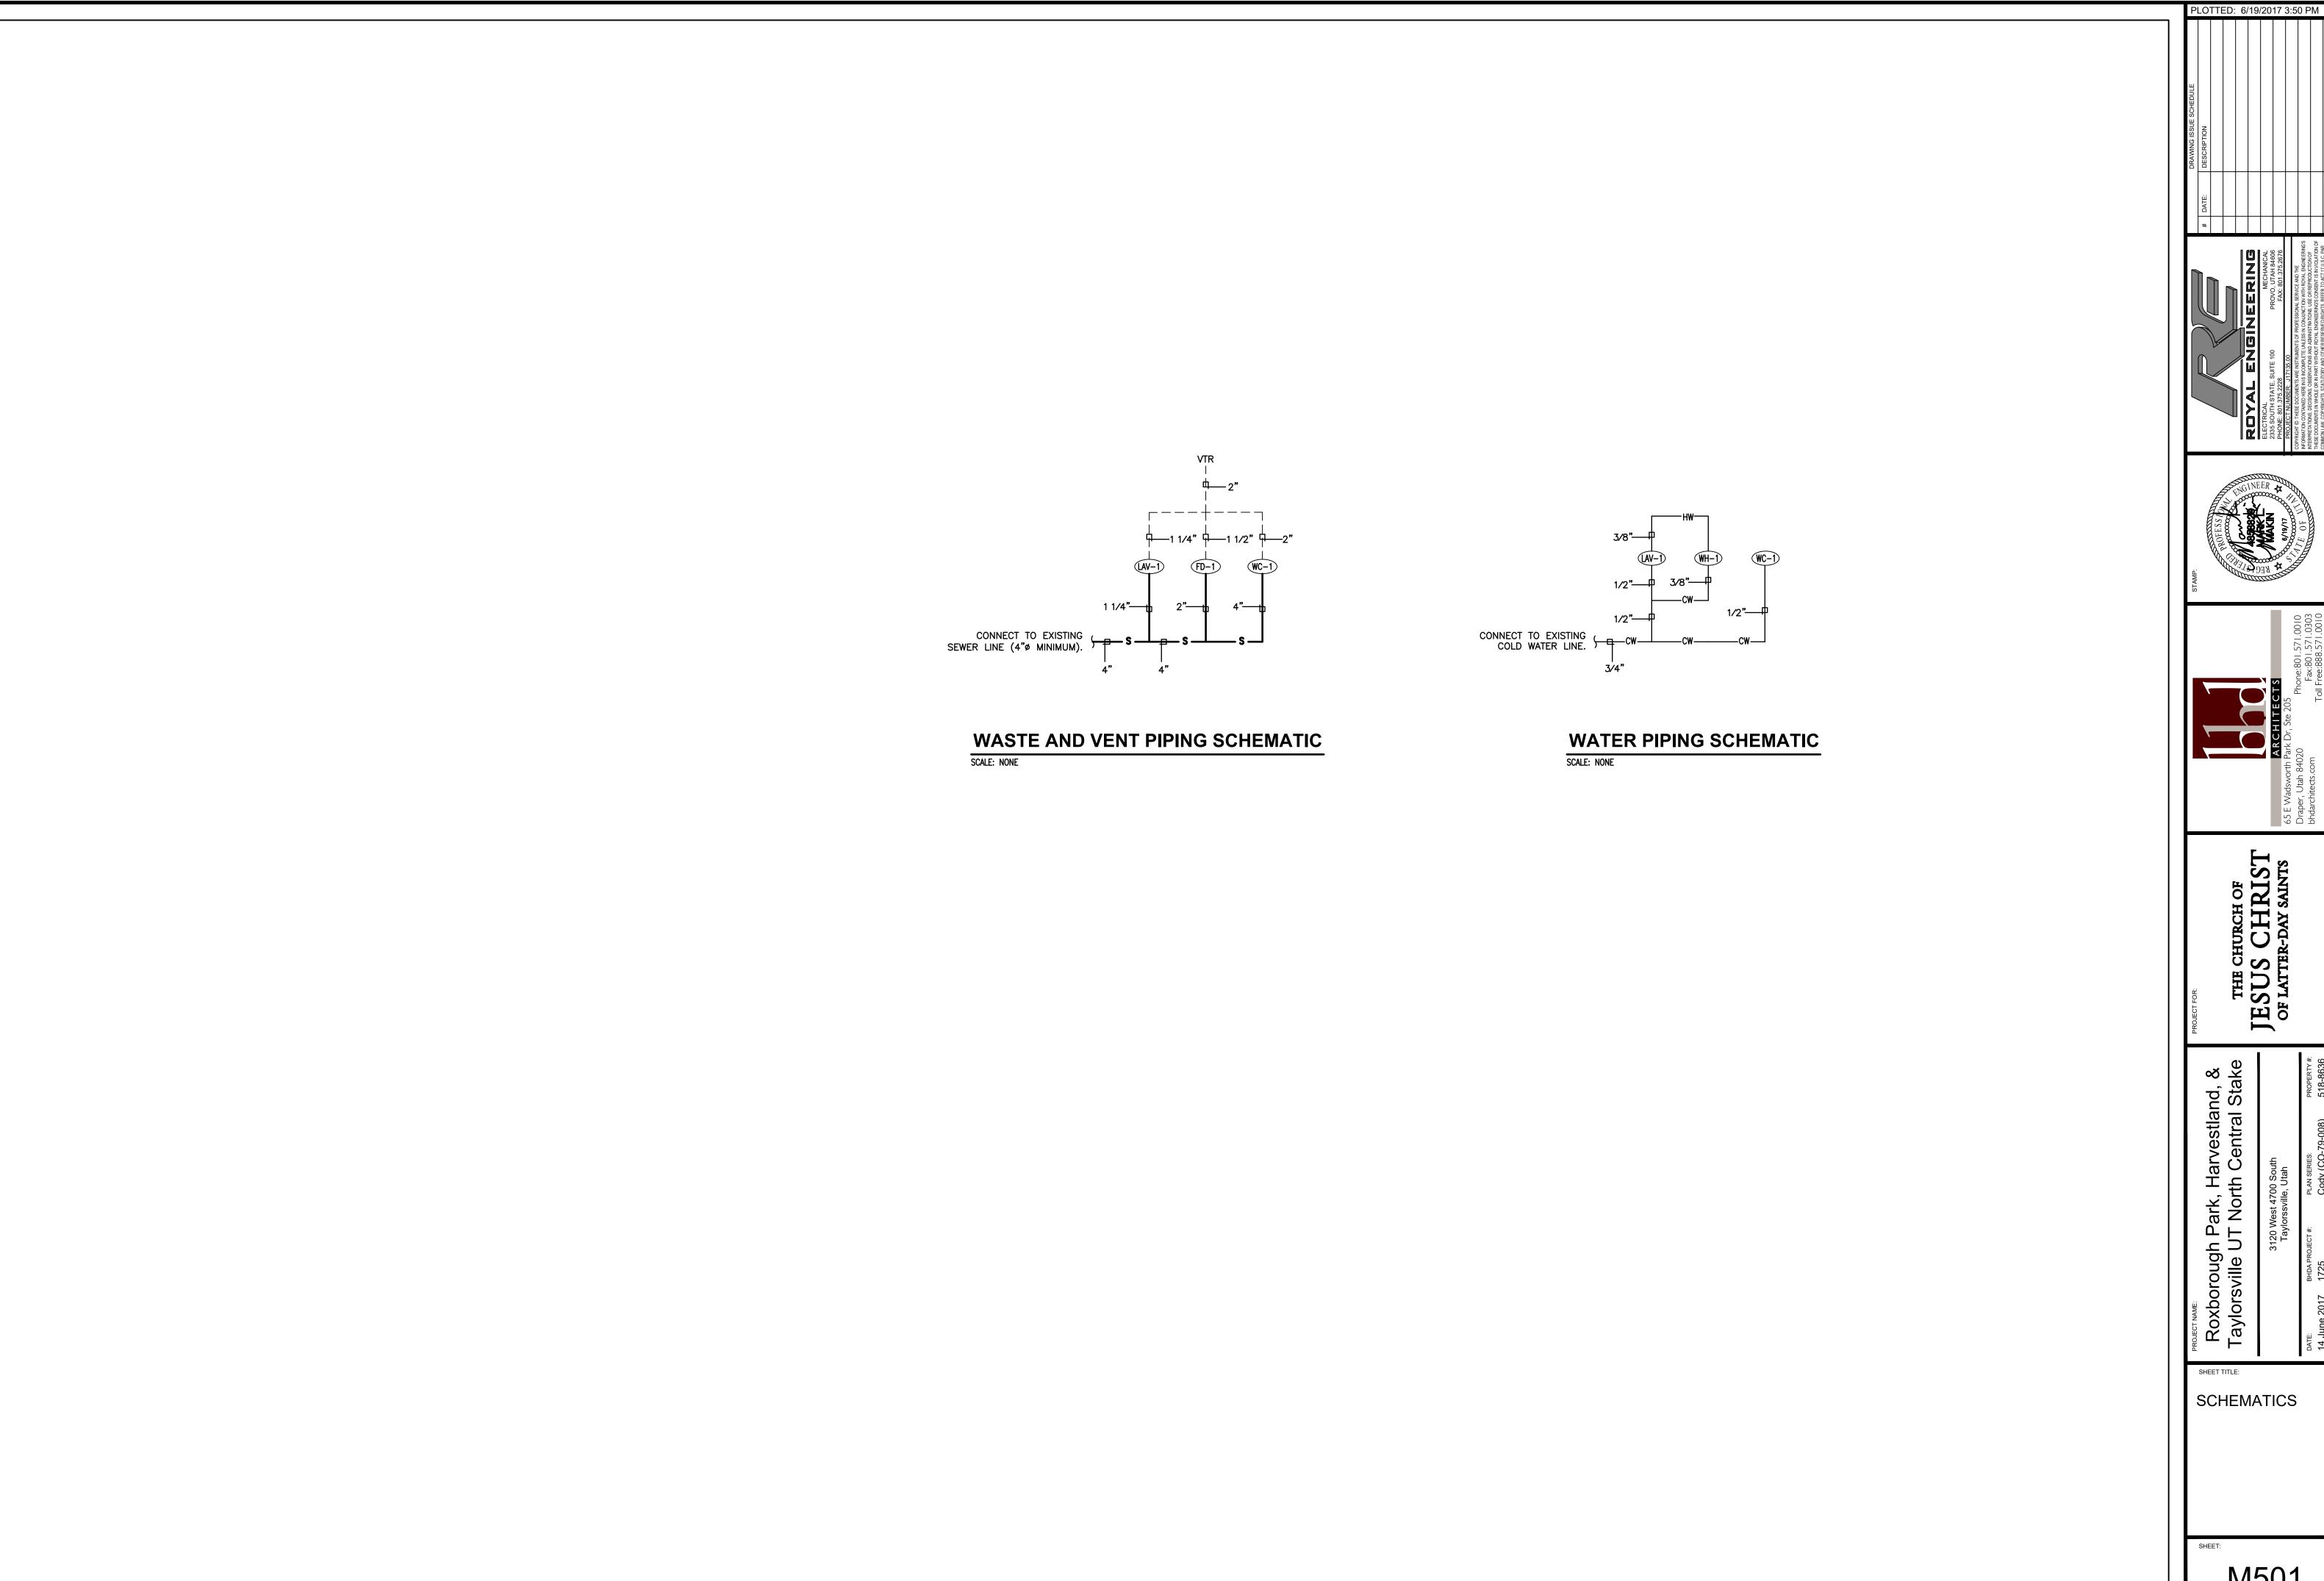

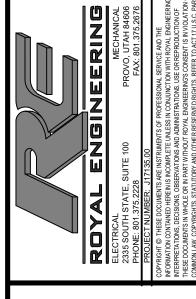


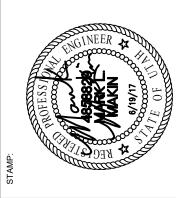

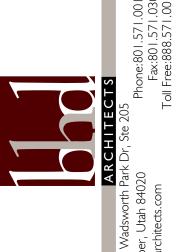


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SCHEMATICS

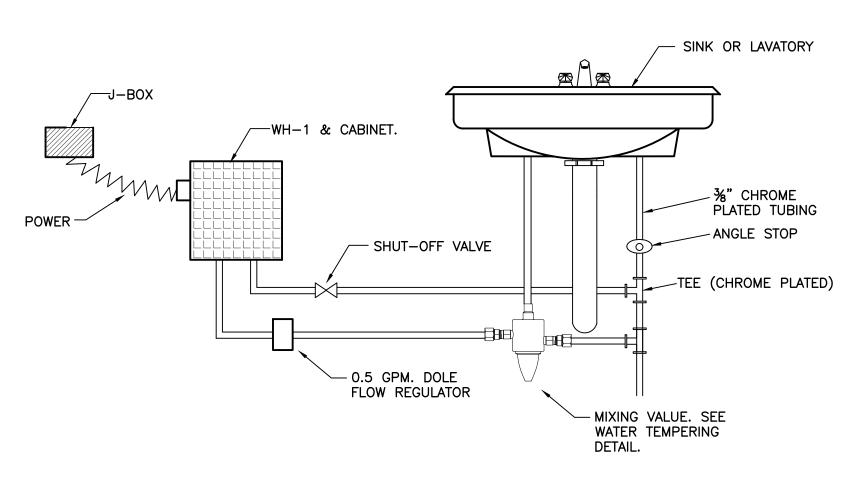

INSTANTANEOUS WATER HEATER DETAIL SCALE: NONE

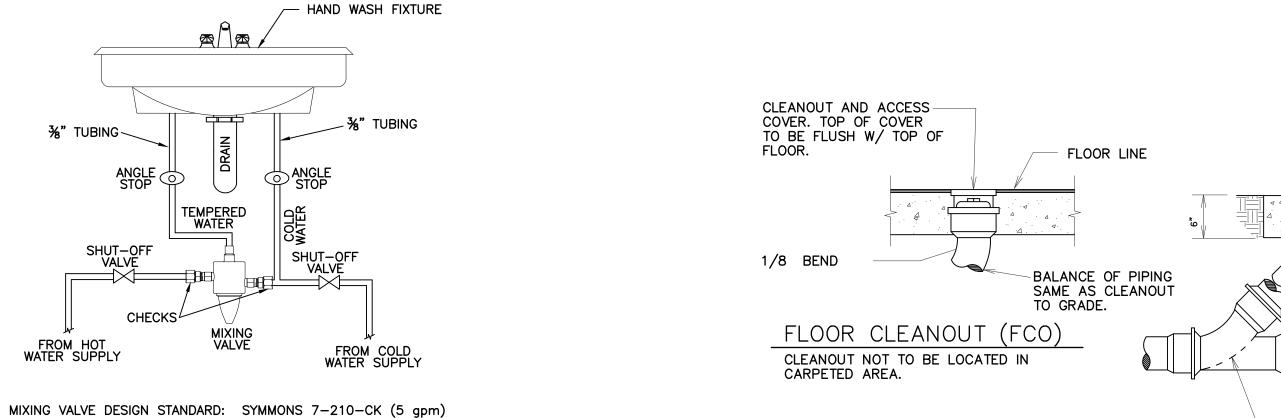

NOTES:

1. PROVIDE WITH SEPARATE CHECKS AND WALL MOUNTING BRACKET.


2. SHALL CONFORM TO ASSE 1070 — LIMIT THE TEMPERED WATER TEMPERATURE TO A MAXIMUM OF 110 deg F. IPC 2015, 607.1.2.

3. SET MIXING VALVE TEMPERATURE WHEN INSTALLATION IS COMPLETE.


4. FOLLOW ALL MANUFACTURER INSTALLATION AND OTHER INSTRUCTIONS.

5. APPROVED MANUFACTURERS: SYMMONS, POWERS, LEONARD, BRADLEY, WATTS, LAWLER.


6. INSTALL HANDY—SHIELD, AS MANUFACTURED BY PLUMBEREX SPECIALTY PRODUCTS, SAFETY COVERS ON ALL SUPPLY PIPING AND WASTE PIPING BENEATH HANDICAPPED LAVATORIES. SHIELDS SHALL MEET THE REQUIREMENTS OF UNIFORM FEDERAL ACCESSIBILITY STANDARDS 4.19.4 GSA AND ANSI DOCUMENT A117—1—1980.

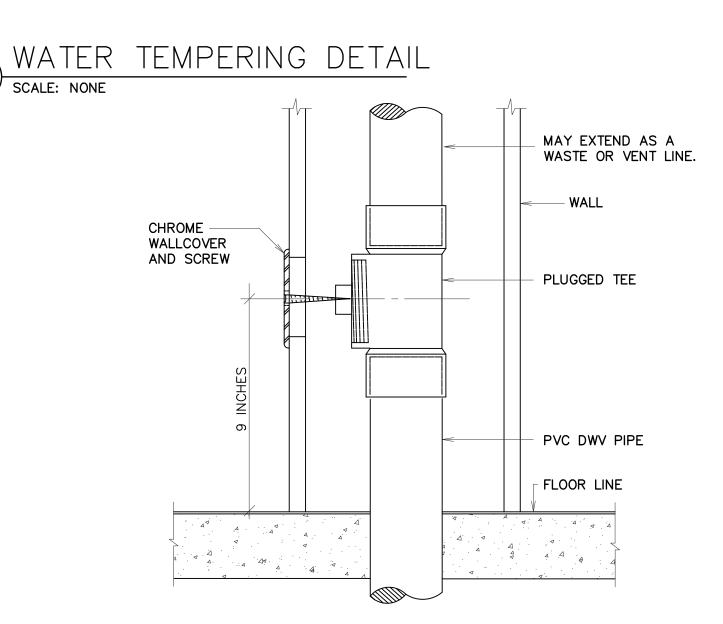


WALL CLEANOUT DETAIL (E) SCALE: NONE

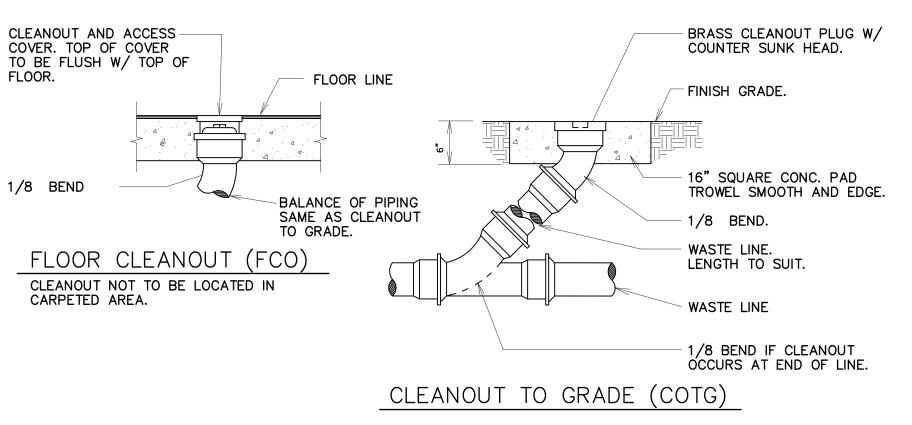

CLEANOUT DETAILS SCALE: NONE

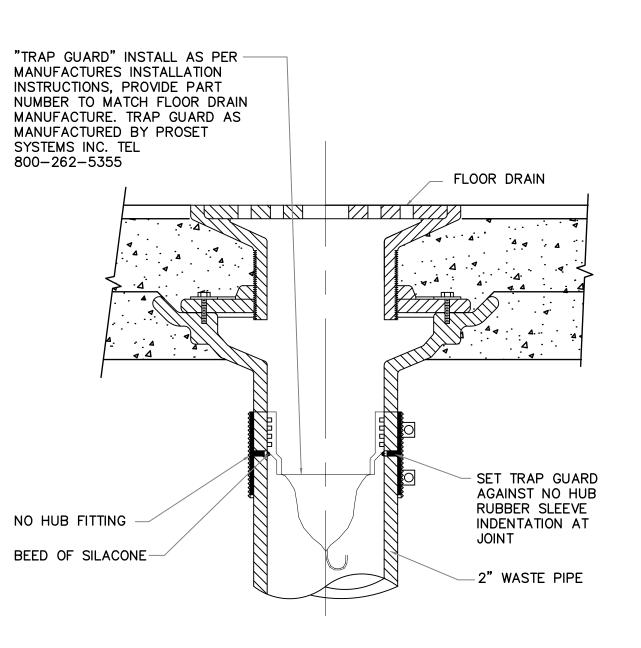

TRAP GUARD TRAP SEAL DETAIL SCALE: NONE

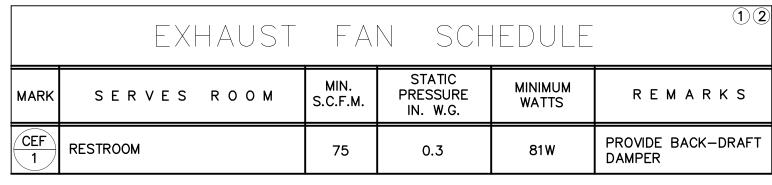


1 CONTROL BY DIVISION 26.

2 VOLTAGE IS 115V/1 PHASE/60HZ


	P L U M E	3 I	N G		FΙ	X T	URESCHEDULE	1						
MARK	FIXTURE		PI	PE SIZE			REMARKS							
WAIN	TIXTORE	TRAP	WASTE	VENT	C.W.	H.W.	- INEMAINS							
WC-1	WATER CLOSET	INT.	4"	2"	1/2"	_	FLUSH TANK, FLOOR MOUNT							
(LAV-1)	LAVATORY	1-1/4"	1-1/4"	1-1/2"	1/2"	1/2"	SELF SUPPORTING 20"X18"							
		2"	2"	2"	-	_	WITH DEEP SEAL P-TRAP							
	ELECTRIC WATER HEATER (POINT OF USE)	1	1	_	1/2"	1/2"	TANKLESS WATER HEATER: DESIGN STANDARD: EEMAX EX3512 W/ NEMA 4X CA (WHITE), 120V, 3.5KW. 48 deg F RISE @ 0.5 GPM. (OR OWNER APPROVED EC	ABINET QUAL)						

1) NEW COLD WATER FIXTURE UNITS (SEE SCHEMATICS). NEW WASTE WATER FIXTURE UNITS (SEE SCHEMATICS).

(2) WHEN MOUNTED PER ARCHITECTURAL ELEVATIONS, ADA ACCESSIBILITY REQUIREMENTS ARE SATISFIED.

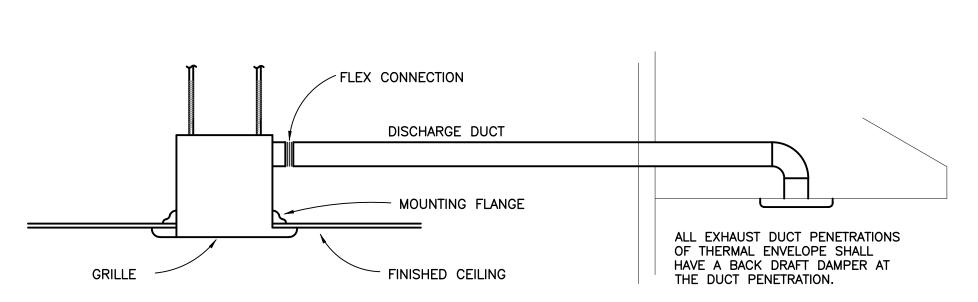


TYPICAL CEILING MOUNTED EXHAUST FAN

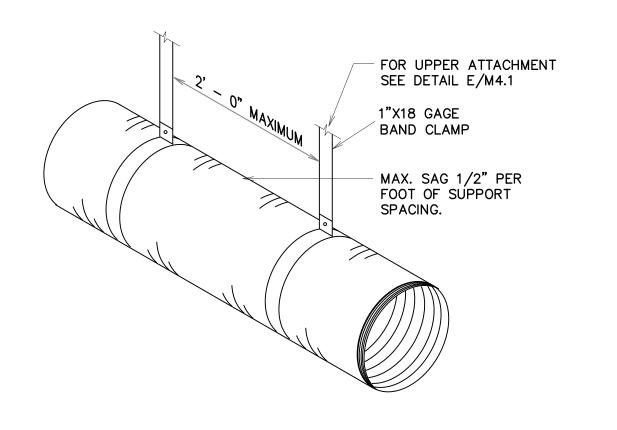

FLEXIBLE DUCT SUPPORT DETAIL SCALE: NONE

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Roxborough Park, Harvestland, Faylorsville UT North Central Sta

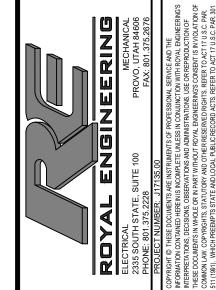SHEET TITLE:

SCHEDULES & DETAILS

ELECTRICAL GENERAL NOTES:

- ALL SALVAGEABLE MATERIALS AS DETERMINED BY THE ARCHITECT RESULTING FROM THE DEMOLITION OF THE EXISTING STRUCTURE AS INDICATED ON THE DEMOLITION PLAN AND WHICH ARE NOT TO BE RE-USED SHALL BECOME THE PROPERTY OF THE OWNER AND SHALL BE DISPOSED OF BY HIM. ALL MATERIALS NOT SO DESIGNATED AS SALVAGEABLE BY THE ARCHITECT SHALL REMAIN THE PROPERTY OF THE CONTRACTOR AND SHALL BE DISPOSED OF
- CONTRACTOR SHALL BE RESPONSIBLE FOR COORDINATING ALL FIELD ROUTING WITH EXISTING EQUIPMENT. PROVIDE ALL NECESSARY OFFSETS TO AVOID CONFLICTS WITH EXISTING EQUIPMENT OR OTHER OBSTRUCTIONS.
- ALL EXISTING FIXTURES, DEVICES, EQUIPMENT, ETC. IN PORTIONS OF THE BUILDING BEING REMODELED SHALL REMAIN IN WORKING CONDITION. RESTORE | 22. EXISTING ELECTRICAL DEVICES TO REMAIN UNLESS NOTED OTHERWISE. ALL INTERRUPTED BRANCH CIRCUITS, FEEDERS, ETC.
- ELECTRICAL CONTRACTOR IS TO VISIT THE PROJECT SITE DURING THE BIDING PROCESS TO DETERMINE THE TOTAL SCOPE OF THE DEMOLITION.
- ELECTRICAL CONTRACTOR IS TO REFER TO THE ARCHITECTURAL AND MECHANICAL DEMOLITION DRAWINGS. THE ARCHITECTURAL AND MECHANICAL DEMOLITION DRAWINGS ARE PART OF THIS CONTRACT.
- ALL BIDS SHALL TAKE THE EXISTING CONDITIONS INTO CONSIDERATION. THE LACK OF SPECIFIC INFORMATION ON THE DRAWINGS SHALL NOT RELIEVE THE CONTRACTOR OF ANY RESPONSIBILITY. NO SUBSEQUENT ALLOWANCE FOR TIME OR MONEY WILL BE ALLOWED FOR WORK OR CHANGES RESULTING FROM CONTRACTOR'S FAILURE TO EXAMINE SITE CONDITIONS.
- MULTI-WIRE BRANCH CIRCUITS: ELECTRICAL CONTRACTOR TO COMPLY WITH THE NATIONAL ELECTRICAL CODE, ARTICLE 210.4. MULTI-WIRE BRANCH CIRCUITS. ELECTRICAL CONTRACTOR TO ALLOW FOR MULTI-WIRE BRANCH CIRCUITS WIRE AMPACITY ADJUSTMENT AS PER ARTICLE 310, TABLE 310.15(B)(2)(A) OF THE NATIONAL ELECTRICAL CODE.
- REFER TO ARCHITECTURAL CABINET CASEWORK ELEVATION DRAWINGS FOR CLARIFICATION ON MOUNTING AND PLACEMENT OF ALL RACEWAY, RECEPTACLES, AND SWITCHES.
- MANY DEVICE MOUNTING LOCATIONS ARE DEPENDANT ON MILLWORK LOCATIONS. COORDINATE ALL APPLICABLE LOCATIONS WITH MILLWORK INSTALLER PRIOR TO BEGINNING WORK.
- . REMOVE OR RELOCATE ANY EXISTING ELECTRICAL DEVICES, AND CIRCUIT CONDUIT IN CONFLICT WITH THIS ELECTRICAL PLAN. COORDINATE ALL REQUIREMENTS WITH OWNER. REMOVE CIRCUIT CONDUIT BACK TO NEAREST JUNCTION BOX. MAINTAIN POWER TO DOWNLINE DEVICES. EXTEND CIRCUIT CONDUIT AS REQUIRED. RETURN ANY REMOVED DEVICES TO OWNER OR DISPOSE OF THEM AS DIRECTED BY OWNER.
- ALL WALL MOUNTED MOTION SENSORS SHALL BE A DUAL TECHNOLOGY MOTION SENSOR WITH INTEGRAL OVERRIDE SWITCH. MOTION SENSOR TO MOUNT IN A STANDARD SWITCH BOX. MOTION SENSOR TO HAVE A FIFTEEN MINUTE TIME DELAY SET AT TEN MINUTES. USE HUBBELL, SENSOR SWITCH, LEVITON, OR APPROVED EQUAL.
- 2. SUB-LETTERS NEXT TO SWITCHES INDICATE SWITCHING ASSIGNMENTS. ELECTRICAL CONTRACTOR IS TO FURNISH AND INSTALL ALL NECESSARY CONDUIT, WIRE JUNCTION BOXES, ETC., AS REQUIRED TO EXTEND CIRCUITING FROM WALL BOX AND/OR FROM THE LIGHTING CONTROL PANEL TO FIXTURES FOR SWITCHING ASSIGNMENTS. LOWER CASE LETTERS ON OR NEAR FIXTURES INDICATE CONTROLLING SWITCHES. SWITCH LEG(S) NOT SHOWN.
- 13. NEW INSTALLATION SHALL CONFORM TO THE NEC REVISION OBSERVED BY THE LOCAL AUTHORITY HAVING JURISDICTION.
- 4. CONTRACTOR SHALL PROVIDE AS-BUILT PANEL SCHEDULES, SWITCH LAYOUT & SWITCHING DIAGRAM TO THE OWNER.
- 15. ALL WORK SHALL BE CAREFULLY LAID OUT IN ADVANCE TO AVOID UNNECESSARY CUTTING, CHANNELING, CHASING OR DRILLING OF WALLS, PARTITIONS, FLOORS, CFILINGS OR OTHER SURFACES, WHERE SUCH WORK IS NEW. NECESSARY FOR THE PROPER INSTALLATION, SUPPORT OR ANCHORAGE OF RACEWAYS, OUTLETS OR OTHER ELECTRICAL WORK, IT SHALL BE CAREFULLY DONE IN SUCH A MANNER AS TO AVOID ANY DAMAGE TO THE EXISTING INSTALLATION. ALL DAMAGE SHALL BE REPAIRED TO THE SATISFACTION OF THE OWNER.
- . CONTRACTOR SHALL BE RESPONSIBLE FOR COORDINATING ALL FIELD ROUTING WITH EXISTING EQUIPMENT. PROVIDE ALL NECESSARY OFFSETS TO AVOID CONFLICTS WITH EXISTING EQUIPMENT OR OTHER OBSTRUCTION.
- . CONTRACTOR SHALL INCLUDED PROVISIONS IN THE BASE BID FOR ALL MATERIAL & LABOR REQUIRED FOR THE EXTENSIONS, REROUTING & RELOCATION OF EXISTING SYSTEM COMPONENTS. EQUIPMENT. WIRING. CONDUITS & CABLING, COORDINATION SHALL BE DONE TO MAINTAIN OPERATION OF ALL SYSTEMS THROUGHOUT THE BUILDING DURING DEMOLITION & CONSTRUCTION PHASES.
- . EXISTING RACEWAYS MAY BE REUSED IF LOCATION IS IN COMPLIANCE WITH THE CONTRACT DOCUMENTS. UPGRADE AND/OR PROVIDE NEW CONDUIT SUPPORTS FOR ALL RACEWAYS BEING REUSED AS REQUIRED. INSURE INTEGRITY OF EXISTING RACEWAYS BEFORE RE-USE.

- 19. MAINTAIN CIRCUIT INTEGRITY & CONTINUITY OF ALL EXISTING CIRCUITS, FEEDERS & SYSTEMS THAT INTERFERE WITH OR ARE INTERRUPTED BY REMODEL WORK, UNLESS THOSE CIRCUITS, FEEDERS & SYSTEMS ARE IN OPERATION DURING CONSTRUCTION. PROVIDE TEMPORARY PANELS, TEMPORARY WIRING & CONDUITS, ETC. AS REQUIRED.
- 20. DO NOT PENETRATE STRUCTURAL ELEMENTS OF FLOORS, WALLS, CEILINGS, ROOF. ETC.
- 21. ALL EXISTING FIXTURES, DEVICES, EQUIPMENT, ETC, IN PORTIONS OF THE BUILDING NOT BEING REMODELED SHALL REMAIN IN WORKING CONDITION. RESTORE ALL INTERRUPTED BRANCH CIRCUITS, FEEDERS, ETC.
- 23. CONCEAL ALL RACEWAY & WIRING IN EXISTING WALLS, CEILINGS, FLOORS,
- 24. ELECTRICAL CONTRACTOR SHALL REVIEW AND COORDINATE WITH ARCHITECTURAL, CIVIL, STRUCTURAL, MECHANICAL, PLUMBING AND OTHER DRAWINGS PRIOR TO BID.
- 25. ELECTRICAL CONTRACTOR SHALL NOTIFY AND COOPERATE WITH THE MECHANICAL CONTRACTOR SUCH THAT NO DUCTS, PIPING, OR EQUIPMENT FOREIGN TO THE OPERATION OF THE ELECTRICAL EQUIPMENT SHALL BE PERMITTED TO BE INSTALLED IN, ENTER, OR PASS THROUGH ELECTRICAL ROOMS OR SPACES, OR ABOVE OR BELOW ELECTRICAL EQUIPMENT IN OTHER
- 26. ELECTRICAL CONTRACTOR SHALL REVIEW ALL ARCHITECTS ELEVATIONS, SECTIONS AND FLOOR PLANS PRIOR TO ROUGH—IN OF ELECTRICAL DEVICE JUNCTION BOXES.
- 27. VERIFY EXACT LOCATION(S) OF ALL EQUIPMENT TO BE FURNISHED BY OTHERS PRIOR TO ROUGH-IN. REFER TO THE MECHANICAL SHEETS FOR THE EXACT LOCATION OF THE MECHANICAL EQUIPMENT.
- 28. ELECTRICAL CONTRACTOR SHALL VERIFY ALL EQUIPMENT DIMENSIONS AND LOCATIONS BEFORE BEGINNING ROUGH-IN. CONSULT CONTRACT DOCUMENT DRAWINGS AND SHOP DRAWINGS TO VERIFY AND MAINTAIN REQUIRED CLEARANCES.
- 29. WORK SHALL BE PERFORMED IN A WORKMANLIKE MANNER, PER INDUSTRY STANDARD AND TO THE SATISFACTION OF THE ARCHITECT AND ENGINEER.
- 30. WORK, MATERIALS AND EQUIPMENT SHALL CONFORM TO THE LATEST EDITIONS OF LOCAL, STATE AND NATIONAL CODES, STANDARDS AND ORDINANCES.
- 31. THE MINIMUM SIZE OF THE CONDUCTORS ARE TO BE #12 AWG THHN COPPER, UNLESS INDICATED OTHERWISE ON THE DRAWINGS. STRANDED CONDUCTORS ARE NOT ALLOWED IN THE THE CONDUCTORS SMALLER THAN #10 AWG.
- 32. DETAILS ARE SHOWN ON DIFFERENT SHEETS. THE CONTRACTOR SHALL REFER TO THOSE DETAILS WHETHER OR NOT CALLED IN REFERENCE NOTES.
- 33. ALL JUNCTION BOXES SHALL HAVE MINIMUM DEPTH OF 2-1/8" UNLESS OTHERWISE SPECIFIED. SECURE ALL JUNCTION BOXES AS SHOWN IN THE DETAILS. FURNISH AND INSTALL PROPER PLASTER RINGS.
- 34. LIGHT SWITCHES INSTALLED ADJACENT TO EACH OTHER, SHALL BE GANGED TOGETHER WITH ONE PIECE COVER PLATE.
- 35. USE EPOXY ANCHORS TO SUPPORT THE ELECTRICAL EQUIPMENT. EXPANSION ANCHOR BOLTS ARE NOT ACCEPTED.
- 36. AT THE END OF THE JOB. PROVIDE BLANK COVER PLATES TO MATCH THE OTHER COVER PLATES FOR ALL JUNCTION BOXES WHERE DEVICES HAVE NOT YET BEEN INSTALLED.
- 37. ALL MATERIALS USED IN THIS INSTALLATION SHALL BE U.L. APPROVED AND
- 38. NO WIRING SHALL RUN IN DUCT WORK.
- 39. THE ELECTRICAL CONTRACTOR SHALL TERMINATE THE ELECTRICAL CONNECTIONS TO ALL THE EQUIPMENT BY PROVIDING THE NECESSARY MALE/FEMAILE CONNECTOR, RECEPTACLE, PLUG, ETC.
- 40. CONTRACTOR SHALL MEASURE STEADY STATE LOAD CURRENTS AT EACH PANEL BOARD FEEDER FOR ALL ALTERED PANEL BOARDS. SHOULD THE DIFFERENCE BETWEEN PHASES EXCEED 20 PERCENT AT ANY PANEL BOARD, REARRANGE CIRCUITS IN PANEL BOARD TO BALANCE THE PHASE LOAD WITHIN 20 PERCENT. TAKE CARE TO MAINTAIN PROPER PHASING FOR MULTI-WIRE BRANCH CIRCUITS. UPDATE DIRECTORIES ACCORDINGLY.
- 41. CONTRACTOR SHALL PROVIDE MINIMUM OF ONE WEEK NOTICE IN WRITING TO THE OWNER PRIOR TO ANY POWER OUTAGE. OUTAGES SHOULD BE PLANNED AROUND HOLIDAYS OR WEEKENDS. CONTRACTOR SHALL OBTAIN WRITTEN APPROVAL FOR ALL POWER OUTAGES PRIOR TO COMMENCING WORK.
- 42. CONTRACTOR TO ENSURE THAT ALL AREAS OUTSIDE OF CONSTRUCTION AREA ARE KEPT CLEAN AND CLEAR OF DEBRIS AND OBSTRUCTIONS AT ALL TIMES.

			ELECTRICAL SYMBOLS		
SYMBOL	EXPLANATION	SYMBOL	EXPLANATION	SYMBOL	EXPLANATION
	BRANCH CIRCUIT CONCEALED IN CEILING OR WALL	F1	FIXTURE TYPE SYMBOL	†	TAMPER AND FLOW
	BRANCH CIRCUIT CONCEALED IN GROUND OR FLOOR	0	FLUORESCENT FIXTURE (TYPICAL)	FACP	FIRE ALARM CONTROL PANEL
A-1,3	BRANCH CIRCUIT HOMERUNS TO PANEL	0	EMERGENCY LIGHTING UNIT	RFAA	REMOTE FIRE ALARM ANNUNCIATOR PANEL
[135]	ROOM NUMBER		SURFACE OR PENDANT MOUNTED FIXTURE	NAC	FIRE ALARM NAC PANEL
CH 1	MECHANICAL EQUIPMENT SYMBOL		RECESSED FIXTURE	VOICE	FIRE ALARM VOICE PANEL
\Diamond	KEYED NOTE REFERENCE	9	WALL MOUNTED FIXTURE	D/H	DOOR HOLDER
42X	FEEDER TAG (SEE FEEDER SCHEDULE)	8	WALL PACK	F/S	FIRE/SMOKE DAMPER
	LIGHTING AND POWER PANELBOARD		FLUORESCENT STRIP	F	FIRE ALARM PULL STATION
- NON-FUSED - FUSED	DISCONNECT SWITCH	∇ ∇	TRACK LIGHTING	Ø	FIRE ALARM STROBE
⊣⊠ NON-FUSED ⊣⊠ FUSED	DISCONNECT SWITCH WITH MOTOR STARTER	6	EMERGENCY LIGHTING UNIT		FIRE ALARM HORN/STROBE
\boxtimes	MOTOR STARTER	⊬⊗	WALL MOUNTED EXIT LIGHT (SINGLE FACE)		FIRE ALARM HORN/STROBE (LF = LOW FREQUENCY)
VFD	VARIABLE FREQUENCY DRIVE	⊬⊠	WALL MOUNTED EXIT LIGHT (DOUBLE FACE)		FIRE ALARM HORN/STROBE WITH PROTECTIVE COVER
©	CONDUIT STUB	8	CEILING MOUNTED EXIT LIGHT		FIRE ALARM SPEAKER/STROBE
0	JUNCTION BOX	፟	CEILING MOUNTED EXIT LIGHT (DOUBLE FACE)	⊠⊲LF	FIRE ALARM SPEAKER/STROBE (LF = LOW FREQUENCY)
	ELECTRIC VEHICLE CHARGING STATION	⊗)	EXIT LIGHT WITH PROTECTIVE COVER		FIRE ALARM SPEAKER
	DUPLEX RECEPTACLE OUTLET	\$	SINGLE POLE SWITCH (SUBSCRIPT AS INDICATED BELOW)		FIRE ALARM SPEAKER (LF = LOW FREQUENCY)
	WPMODIFIER	2 3	TWO POLE SWITCH 3-WAY SWITCH		FIRE ALARM HORN
	WP WEATHERPROOF COVER & LISTED WEATHER RESISTANT DEVICE	4	4-WAY SWITCH DIMMER SWITCH		FIRE ALARM HORN (LF = LOW FREQUENCY)
	GFCI PROTECTED BY FAULT CIRCUIT INTERRUPTER	K	KEYED SWITCH	8	FIRE ALARM STROBE CEILING MOUNTED
	+44 MOUNTING HEIGHT ABOVE FLOOR OR GRADE GIVEN IN INCHES.	T M	TIMER SWITCH MANUAL STARTER WITH THERMAL OVERLOAD	<u>&</u>	FIRE ALARM HORN/STROBE CEILING MOUNTED
	REF REFRIGERATOR DW DISHWASHER	F OC	PADDLE FAN SPEED CONTROL. (CANARM "CN" SERIES) OCCUPANCY SENSOR SWITCH		FIRE ALARM HORN/STROBE CEILING MOUNTED
	DISP DISPOSAL	LV	LOW VOLTAGE CONTROL SWITCH LOW VOLTAGE CONTROL SWITCH WITH DIMMER	Ø\$\dLF	(LF = LOW FREQUENCY)
	WASH WASHING MACHINE EWC ELECTRIC WATER COOLER	LV/D OC/D	OCCUPANCY SENSOR CONTROL SWITCH WITH DIMMER	Ø	FIRE ALARM HORN CEILING MOUNTED
	USB COOPER TR7746 OR EQUAL DUPLEX PLUS USB CHARGER TR TAMPER RESISTANT	0C/2	DUAL RELAY OCCUPANCY SENSOR CONTROL SWITCH		FIRE ALARM HORN CEILING MOUNTED (LF = LOW FREQUENCY)
₩-	QUAD RECEPTACLE OUTLET	\$ \$	DOUBLE GANG SWITCH	0	SMOKE DETECTOR (SUBSCRIPT AS INDICATED BELOW)
←	SPLIT WIRED DUPLEX RECEPTACLE OUTLET	\$a,b,c S	LOW VOLTAGE MULTI BUTTON CONTROL SWITCH (LETTER INDICATES CONTROL OF CORRESPONDING FIXTURES)	B C	SMOKE ALARM BATTERY-BACKED SMOKE/CARBON MONOXIDE ALARM COMBO BATTERY-BACKED
€	220V RECEPTACLE OUTLET	\$ª\$ ^b	CONTROLLING SWITCH (LETTER INDICATES CONTROL OF CORRESPONDING FIXTURES)	D P	DUCT SMOKE DETECTOR SMOKE DETECTOR WITH ADDRESSABLE RELAY
⊕ =	ISOLATED GROUND RECEPTACLE	<u>(S)</u>	OCCUPANCY SENSOR (CEILING MOUNTED)	s	SMOKE DETECTOR WITH ADDRESSABLE RELAT SMOKE DETECTOR WITH SOUNDER BASE
	RECEPTACLE FLOOR DEVICE	Ş _{DT}	DUAL TECHNOLOGY OCCUPANCY SENSOR (CEILING MOUNTED)	(1)	HEAT DETECTOR
	CEILING MOUNTED DEVICE	(RC)	ROOM CONTROLLER	0	GAS DETECTOR
	SPECIAL RECEPTACLE	(LS)	DAYLIGHT SENSOR	со	CARBON MONOXIDE DETECTOR
4	MOTOR OUTLET	®	PHOTOCELL	CO/NO2	CARBON MONOXIDE/NITROGEN DIOXIDE SENSOR (GARAGE) ADA TWO-WAY COMMUNICATIONS SYSTEM
	EXHAUST FAN	⊗	VOLUME CONTROL	KP	DOOR ACCESS CONTROL KEY PAD
	THERMOSTAT OUTLET		WALL SPEAKER	CR	DOOR ACCESS CONTROL CARD READER
	REMOTE SENSOR OUTLET		CEILING SPEAKER		
S				SDS	DOOR ACCESS CONTROL DOOR STRIKE
\\\\\\\\\\\\\\\\\\\\\\\\\\\\\\\\\\\\\\	TELEPHONE OUTLET COMPLIED DATA OUTLET (#) INDICATES LACK QUANTITIES		SURVEILLANCE CAMERA	ML	DOOR ACCESS CONTROL MAG LOCK
\(\nabla(\pi)\)	COMPUTER DATA OUTLET (#) INDICATES JACK QUANTITIES	DVR	SURVEILLANCE DIGITAL VIDEO RECORDER	DS	DOOR ACCESS CONTROL DOOR SENSOR
₩	NETWORK AND VOICE OUTLET	NURSE	NURSE CALL ANNUNCIATOR PANEL	0	DOOR ACCESS CONTROL REQUEST TO EXIT
	WIRELESS ACCESS POINT CEILING MOUNTED	\ \ \ \ \ \ \ \	NURSE CALL EMERGENCY CALL DEVICE	•	PUSHBUTTON
NOTE: ALL SYMB	TELEVISION OUTLET DLS MAY NOT BE USED.	M	NURSE CALL EMERGENCY CALL LIGHT	-B	BELL
ALL SIMO					

			ABBREVIATI	ONS	SINDEX		
#	NUMBER	DISP	DISPOSAL	MATV	MASTER ANTENNA TELEVISION	(R)	RELOCATE
ф	PHASE	DRY	DRYER	MAX	MAXIMUM	RECP	RECEPTACLE
1φ	SINGLE PHASE	DW	DISHWASHER	МВ	MAIN BUS	REF	REFRIGERATOR
2P	TWO-POLE	DWG	DRAWING	мсв	MAIN CIRCUIT BREAKER	REQ	REQUIRED
Зф	THREE PHASE	EC	EMPTY CONDUIT	мсс	MOTOR CONTROL CENTER	RLA	RATED LOAD AMPS
4P	FORE-POLE	EM	EMERGENCY	мсм	1000 CIRCULAR MILLS	RMS	ROOT MEAN SQUARE
AC	ALTERNATING CURRENT	EMG	EMERGENCY GENERATOR	МН	MANHOLE	SE	SERVICE ENTRANCE
AFF	ABOVE FINISHED FLOOR	EMT	ELECTRICAL METALLIC TUBING	MIC	MICROPHONE	SPD	SURGE PROTECTION DEVICE
AFG	ABOVE FINISHED GRADE	EP0	EMERGENCY POWER OFF	MIN	MINIMUM	SPEC	SPECIFICATION
AFP	ARC FAULT PROTECTOR	EWC	ELECTRIC WATER COOLER	MLO	MAIN LUGS ONLY	SPK	SPEAKER
AIC	AMP INTERRUPTING CURRENT (SYMMETRICAL)	EWH	ELECTRIC WATER HEATER	MNF	MANUFACTURER	SS	SELECTOR SWITCH
AL	ALUMINUM	EX	EXISTING	MTG	MOUNTING	SW	SWITCH
AM	AMPS METER	(F)	FUTURE	MTR	MOTOR	SWBD	SWITHBOARD
AMP	AMPERE	FA	FIRE ALARM	мw	MICROWAVE	SWGR	SWITCHGEAR
ANN	ANNUNCIATOR	FACP	FIRE ALARM CONTROL PANEL	(N)	NEW	πв	TELEPHONE TERMINAL BOARD
ATS	AUTOMATIC TRANSFER SWITCH	FC	FOOT CANDELA	N/A	NOT APPLICABLE	TBC	TELEPHONE TERMINAL CABINET
AUX	AUXILIARY	FLA	FULL LOAD AMPS	NC	NORMALLY CLOSED	TV	TELEVISION
AWG	AMERICAN—WIRE GAUGE	FT	FOOT	NEC	NATIONAL ELECTRICAL CODE	TYP	TYPICAL
BC	BARE COPPER	FRZ	FREEZER	NEMA	NATIONAL MANUFACTURING ASSOCIATION	UG	UNDERGROUND
BFG	BELOW FINISH GRADE	FS	FUSED SWITCH	NFC	NATIONAL FIRE CODE	UNO	UNLESS NOTED OTHERWISE
c	CONDUIT	GFCI	GROUND FAULT CIRCUIT INTERRUPTER	NFPA	NATIONAL FIRE PROTECTION ASSOCIATION	UPS	UNINTERRUPTIBLE POWER SUPPLY
CAB	CABINET	GFP	GROUND FAULT PROTECTOR	NFS	NON FUSED SWITCH	l v	VOLT (KV-KILOVOLT)
CATB	COMMUNITY ANTENNA TELEVISION	GRC	GALVANIZED RIGID CONDUIT	NIC	NOT IN CONTRACT	VA/R	VOLT-AMPS/REACTIVE
CATV	CABLE TELEVISION	GRD	GROUND	NL	NIGHT LIGHT	l vw	VOLT METER
CFCI	CONTRACTOR FURNISHED CONTRACTOR INSTALLED	HP	HORSE POWER	NO	NORMALLY OPEN	w	WATTS
СКТ	CIRCUIT	HZ	HERTZ	NTS	NOT TO SCALE	W/	WITH
CLG	CEILING	IG	ISOLATED GROUND	OFCI	OWNER FURNISHED CONTRACTOR INSTALLED	WASH	WASHER
CNTR	CONTRACTOR	IMC	INTERMEDIATE METALLIC CONDUIT	OFOI	OWNER FURNISHED OWNER INSTALLED	WH	WATTHOUR
СО	CONDUIT ONLY	IN	INCH	OS&Y	OUTSIDE SCREW AND YOKE	W/O	WITHOUT
CRT	COMPUTER TERMINAL	J-BOX	JUNCTION BOX	PB	PUSH BUTTON	W _P	WEATHER PROOF
СТ	CURRENT TRANSFORMER	κν	KILOVOLT	PF	POWER FACTOR	XFMR	TRANSFORMER
CU	COPPER	KVA	KILOVOLT AMPERES	PFR	PHASE FAILURE RELAY	XFMR-SW	TRANSFORMER SWITCH
C/W	CONDUIT WITH	KVAR	KILOVARS	PNL	PANEL	XP	EXPLOSION PROOF
(D)	DEMOLISH/DELETE	KW	KILOWATT	PT	POTENTIAL TRANSFORMER		
DB	DECIBEL	LRA	LOCKED ROTOR AMPS	PV	PHOTOVOLTAIC		
DC	DIRECT CURRENT	LTG	LIGHTING	PVC	POLYVINYL CHLORIDE CONDUIT		

NOTE: THIS IS A TYPICAL ABBREVIATION LIST. NOT ALL ABBREVIATIONS MAY BE USED ON THIS PROJECT.

DESIGN CONTACTS

	ELECTRICAL ENGINEER:	STEVE GRIFFITHS
	ELECTRICAL PROJECT MANAGER:	STEVE GRIFFITHS
	ELECTRICAL DESIGNER:	KURT HAACKE

CHEET INDEX

		SHEET INDEX
	SHEET NUMBER	SHEET TITLE
	E001	ELECTRICAL COVER SHEET
	E101	ELECTRICAL PLANS
ſ	F201	FLECTRICAL SCHEDULES


COMMISSIONING NOTES:

<u> 2408.3 LIGHTING SYSTEM FUNCTIONAL TESTING.</u> CONTROLS FOR AUTOMATIC LIGHTING SYSTEMS SHALL COMPLY WITH SECTION

C408.3.1 FUNCTIONAL TESTING.


TESTING SHALL ENSURE THAT CONTROL HARDWARE AND SOFTWARE ARE CALIBRATED, ADJUSTED, PROGRAMMED AND IN PROPER WORKING CONDITION IN ACCORDANCE WITH THE CONSTRUCTION DOCUMENTS AND MANUFACTURER'S INSTALLATION INSTRUCTIONS. THE CONSTRUCTION DOCUMENTS SHALL STATE THE PARTY WHO WILL CONDUCT THE REQUIRED FUNCTIONAL TESTING. WHERE REQUIRED BY THE CODE OFFICIAL, AN APPROVED PARTY INDEPENDENT FROM THE DESIGN OR CONSTRUCTION OF THE PROJECT SHALL BE RESPONSIBLE FOR THE FUNCTIONAL TESTING AND SHALL PROVIDE DOCUMENTATION TO THE CODE OFFICIAL CERTIFYING THAT THE INSTALLED LIGHTING CONTROLS MEET THE PROVISIONS OF SECTION C405. WHERE OCCUPANT SENSORS, TIME SWITCHES, PROGRAMMABLE SCHEDULE CONTROLS, PHOTOSENSORS OR DAYLIGHTING CONTROLS ARE INSTALLED, THE FOLLOWING PROCEDURES SHALL BE PERFORMED:

CONFIRM THAT THE PLACEMENT, SENSITIVITY AND TIME-OUT ADJUSTMENTS FOR OCCUPANT SENSORS YIELD ACCEPTABLE PERFORMANCE.

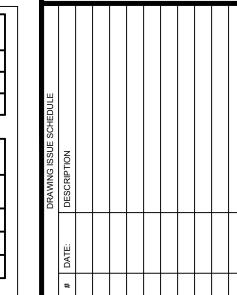

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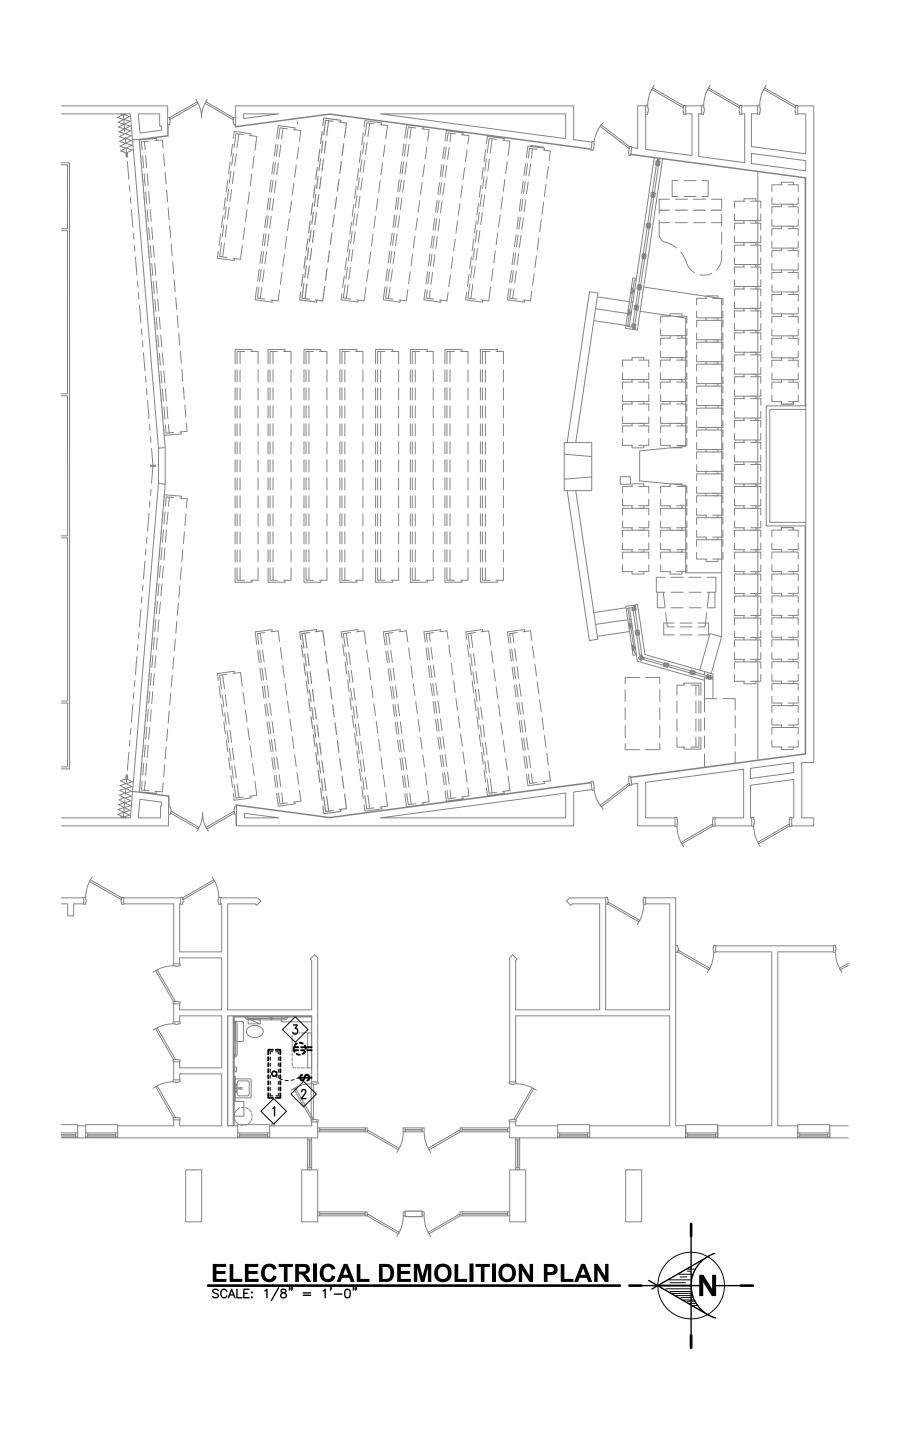



ST

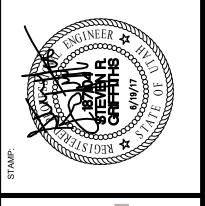Park, IT Nort Roxborough F Taylorsville UT

ELECTRICAL COVER SHEET

E001



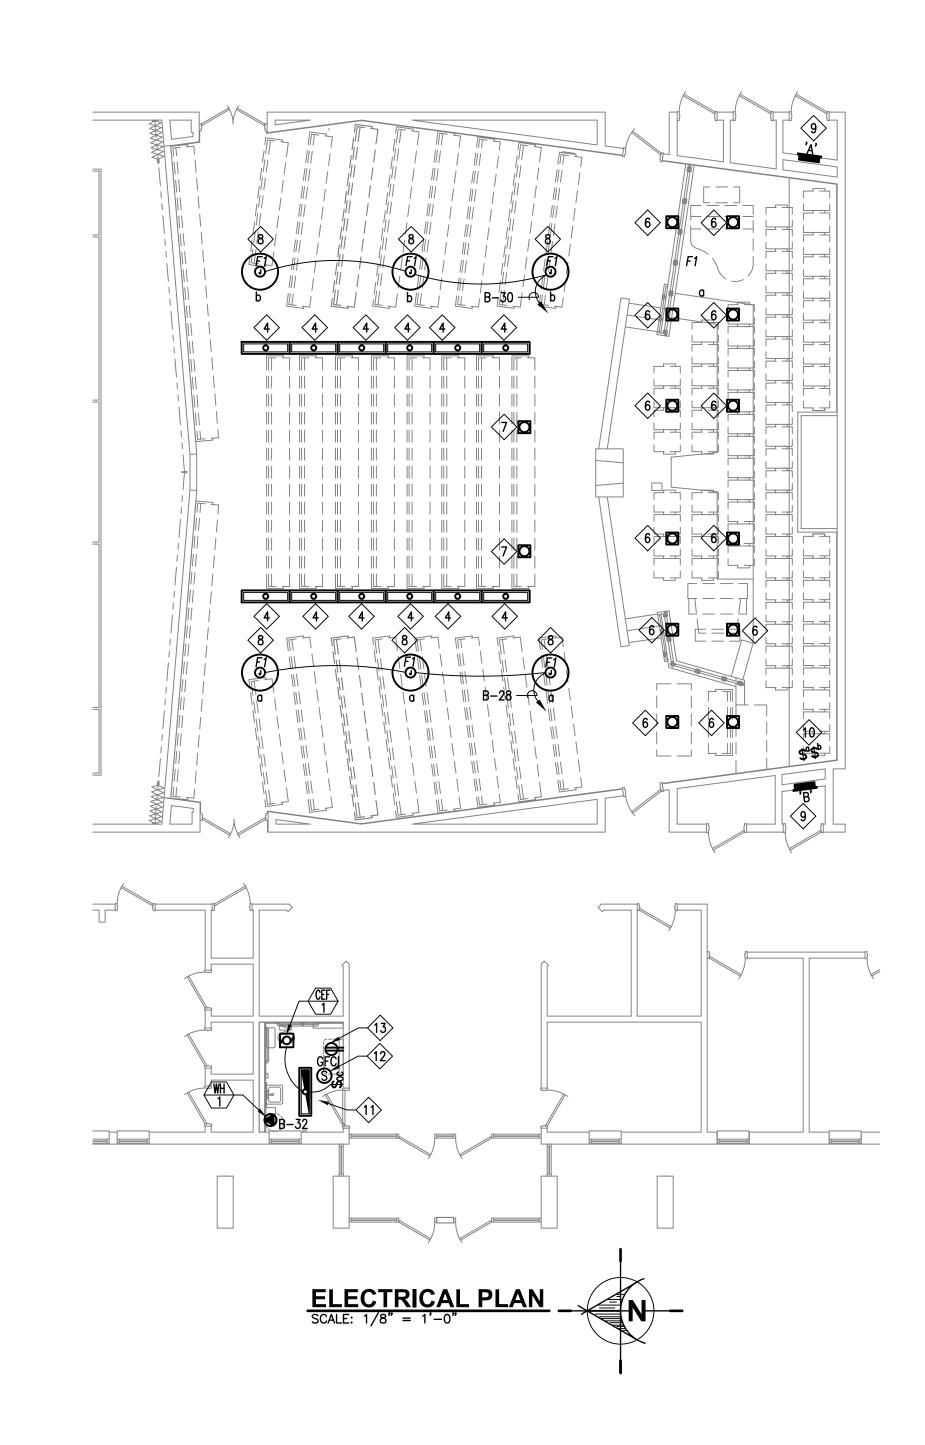

KEYED NOTES:

- CONTRACTOR SHALL CLEAN THE FIXTURE AND REPLACE THE LAMPS WITH 4100K LAMPS. UPGRADE FIXTURE TO F32/T8 TYPE LAMPS.
- 5 OMITTED
- $\langle 6 \rangle$ relamp recessed downlight with 150 watt par 38 flood 3000k LED REPLACEMENT LAMP. SATCO #18PAR38/LED/40'/3000K/120V/D
- 7> RELAMP RECESSED FLOODLIGHT WITH 150 WATT PAR 38 SPOT 3000K LED REPLACEMENT LAMP. SATCO #18PAR38/LED/40'/3000K/120V/D
- $\langle 8 \rangle$ new led pendant chandelier. Field verify location with facilities MANAGER PRIOR TO ROUGH-IN. FACILITIES MANAGER CONTACT INFORMATION: JOE GLEDHILL, 801.840.8451 OFFICE AND 801.793.3659 MOBILE.
- $\langle 9 \rangle$ existing panelboard.
- $\langle 11 \rangle$ refer to the reflected ceiling plan on sheet a101.
- OCCUPANCY WALL SWITCH.
- 13> NEW GFCI DUPLEX RECEPTACLE AND COVERPLATE.




1> REMOVE AND RETAIN FIXTURE FOR RE-INSTALLATION. MAINTAIN EXISTING CONDUIT AND WIRE. ELECTRICAL CONTRACTOR TO CLEAN AND RE-LAMP FIXTURE WITH TWO NEW LAMPS. UPGRADE FIXTURE TO T-8 TYPE LAMPS. UPGRADE TO EMERGENCY ELECTRONIC BALLAST.

- (2) REMOVE SINGLE POLE SWITCH (DEVICE) AND COVERPLATE. MAINTAIN EXISTING CONDUIT AND WIRE.
- REMOVE DUPLEX RECEPTACLE (DEVICE) AND COVERPLATE. MAINTAIN EXISTING CONDUIT AND WIRE.
- 4> TWO LAMP SURFACE MOUNTED FIXTURE TO REMAIN. ELECTRICAL
- OR EQUAL, PROVIDE LAMP EXTENDERS.

- NEW FLUSH MOUNTED SWITCHES MOUNTED AT HEIGHT AS DIRECTED BY THE FACILITIES MANAGER.
- EXISTING WHITE NOISE SPEAKER TO REMAIN. ELECTRICAL CONTRACTOR TO PROVIDE A RELAY TO ACTIVATE THE WHITE NOISE SPEAKER WITH THE

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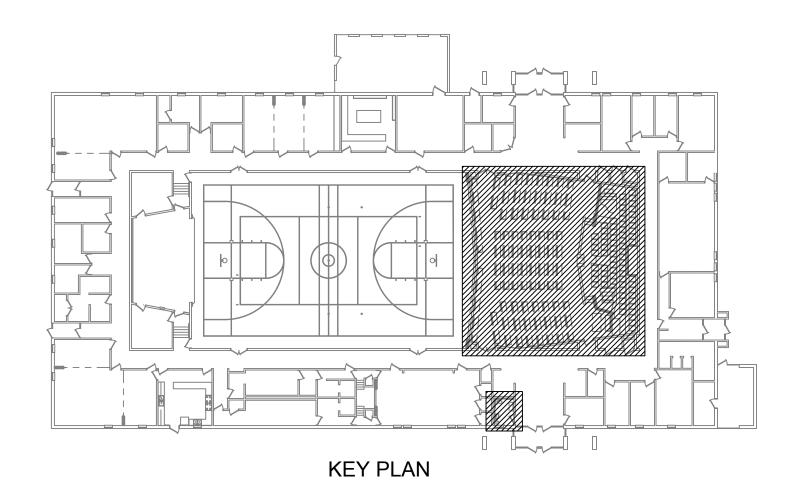
JESUS CHRIST OF LATTER-DAY SAINTS

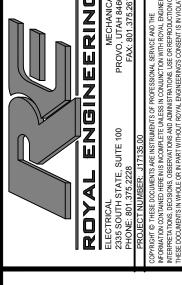Roxborough Park, Harvestland, & Faylorsville UT North Central Stake

SHEET TITLE:

ELECTRICAL PLANS

E101



No. AM	T		ER I		T	RE: FEED	ER	CKT	LOAD	LOA	D/PHASE	(VA)	CKT. L	OAD	FE	EDER			CIF	CUIT	<u> </u>
	MPS F	POLE	MOD.	CIRCUIT NAME	С	WIRE	GRD	DEMAND FACTOR	WATTS	ØA	ØB	øс	WATTS	DEMAND FACTOR	GRD	WIRE	С	CIRCUIT NAME	MOD.	POLE	Ξ
1 /	20	1	EX	EXISTING CLASSRM RCPT	3/4"	#12	#12	1.00	900	1,800			900	1.00	#12	#12	3/4"	EXISTING CLASSRM RCPT	EX	1	-
3 2	20	1	ΕX	EXISTING CLASSRM RCPT	3/4"	#12	#12	1.00	900		1,800		900	1.00	#12	#12	3/4"	EXISTING CLASSRM RCPT	EX	1	1
5 2	20	1	EX	EXISTING FOYER LTG	3/4"	#12	#12	1.25	1,200			1,700	500	1.25	#12	#12	3/4"	EXISTING STAKE LTG	EX	1	1
7 2	20	1	EX	EXISTING FOYER LTG	3/4"	#12	#12	1.25	1,200	1,200				1.00				EXISTING FURNACE	EX		1
9 2	20	1	EX	EXISTING FOYER LTG	3/4"	#12	#12	1.25	1,200		1,200			1.00				EXISTING FURNACE	EX		1
11 2	20	1	EX	EXISTING HEAT CABLE	3/4"	#12	#12	1.00	1,000			1,000		1.00				EXISTING FURNACE	EX		
13 2	20	1	EX	EXISTING CHAPEL LTG	3/4"	#12	#12	1.25	1,500	2,000			500	1.00	#12	#12	3/4"	EXISTING AC UNIT	EX	1	
15 2	20	1	EX	EXISTING CHAPEL LTG	3/4"	#12	#12	1.25	1,500		3,900		2,400	1.00	#10	#10	3/4"	-	-	3	٦
17 2	20	1	EX	EXISTING PANEL LTG	3/4"	#12	#12	1.25	200			2,600	2,400	1.00	-	#10	-	-	-	-	
19 2	25	3	EX	EXISTING AC UNIT	3/4"	#12	#12	1.00	2,000	4,400			2,400	1.00	-	#10	-	-	-	-	
21	-	-	-	-	-	#12	-	1.00	2,000		3,200		1,200	1.00	#12	#12	3/4"	EXISTING BISHOP AC UNIT	EX	2	
23	-	-	-	-	-	#12	-	1.00	2,000			3,200	1,200	1.00	-	#12	-	-	-	-	
25 2	20	1	EX	EXISTING HALL RCPT	3/4"	#12	#12	1.00	180	680			500	1.25	#12	#12	3/4"	EXISITING	EX	1	Ī
27 3	30	3	EX	EXISTING AC UNIT	3/4"	#10	#10	1.00	2,400		3,600		1,200	1.25	#12	#12	3/4"	NEW CHAPEL LTG	NEW	1	
29	-	-	-	-	-	#10	-	1.00	2,400			3,600	1,200	1.25	#12	#12	3/4"	NEW CHAPEL LTG	NEW	1	
31	-	-	-	-	-	#10	-	1.00	2,400	5,900			3,500	1.00	#10	#10	3/4"	NEW WH-1	NEW	1	Ī
33			-	SPACE				1.00			0							SPACE	-		Ī
35			-	SPACE				1.00				0		1.00				SPACE	-		
37			-	SPACE				1.00		0				1.00				SPACE	-		
39			-	SPACE				1.00			0			1.00				SPACE	-		
41			-	SPACE				1.00				0		1.00				SPACE	-		


		LIGI	HT FIXTU	JRE S	CHE	DULE			
FIXTURE	FIXTURE	FIXTURE	LAMP	S		FIXT	URE	DESCRIPTION	REMARKS
NUMBER	MANUFACTURER	CATALOG #	TYPE	QTY.	VOLTS	WATTS	MOUNTING		
F1	CRAFT METAL PRODUCTS, INC LIGHTWAY INDUSTRIES VICTOR ILLUMINATING, INC. LE LAMPISTE	SC3612L-EEF-PC-SASS120/277-STD-LDS W/DBL BOWL PFBH-28-LED-U-84W-4-SCBAWSA VLD4136-ACC 87LED-3K-SA-XX-120-SD-DM7 BWL-S-D-30/XX-36-LED/106-DBWL-LDS-CLA-SA	VARIES	VARIES	120	270 ALLOWED	PENDANT	FIXTURE WITH MACHINED ALUMINUM TRIM	PROVIDE LED REPLACEMENT LAMPS IN THE FIXTURE. ELECCTRICAL CON TRACTOR IS TO SUBMIT A FIXTURE CUT SHEET TO THE ARCHITECT FOR APPROVAL DURING THE BIDDING PROCESS.


	EQUIPMENT SCHEDULE													
CYMPOL	SERVICE DISCONNECT LOAD		DISCONNECT		DISCONNECT		LC		LOAD			DEMARKS		
SYMBOL	DESCRIPTION	VOLTS	PHASE	SIZE	FUSE	STARTER	HP/TON	VA	AMPS	REMARKS				
WH-1	ELECTRIC WATER HEATER	120 V	1Ø	PLUG/ CORD	-	-	-	3,500	29.2 A					
CEF-1	EXHAUST FAN	120 V	1Ø	INTEGRAL PLUG	-	-		100	0.8 A					
NOTES:														


4. DISCONNECTING MEANS NOT REQUIRED FOR EQUIPMENT WITHIN SIGHT (AS DEFINED IN NEC) OF BRANCH PANEL SERVING EQUIPMENT. SEE NEC 422.31 (B).

5. DISCONNECTING MEANS NOT REQUIRED FOR APPLIANCES NOT OVER 300 VA. SEE NEC 422.31 (A).

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JESUS CHRIST OF LATTER-DAY SAINTS

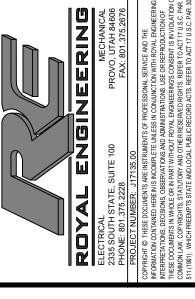Roxborough Park, Harvestland, & Taylorsville UT North Central Stake

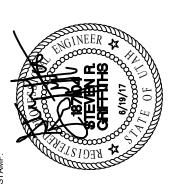SHEET TITLE:

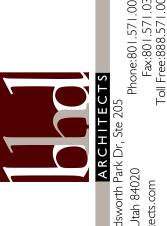ELECTRICAL SCHEDULES

E201