
INNOVATE INTERIOR FINISHES REMODEL LIGHTING REPLACEMENT AND CONTROLS

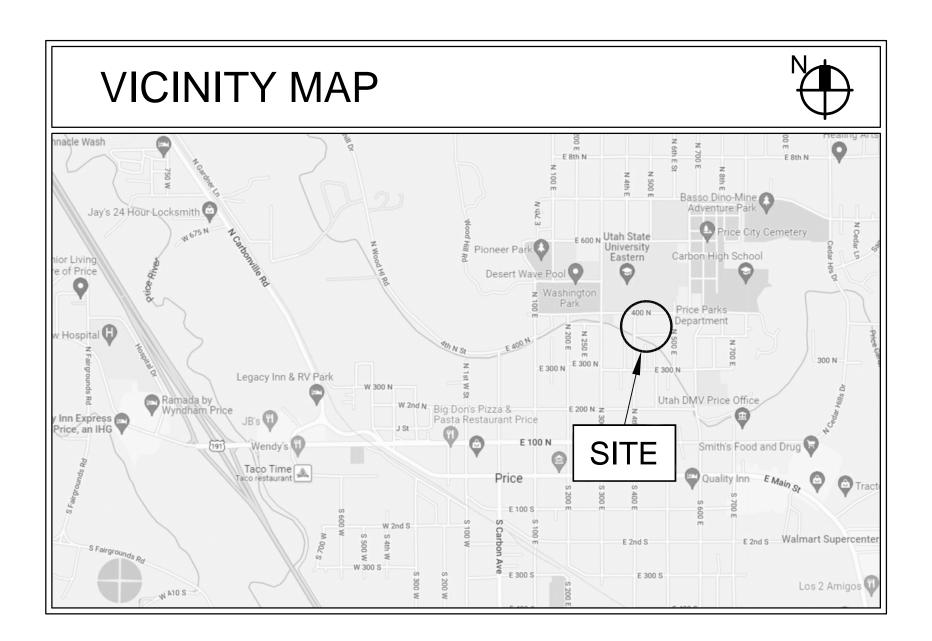

PRICE UT INSTITUTE

SITE: 410 EAST 400 NORTH - PRICE, UTAH THE CHURCH OF JESUS CHRIST OF LATTER-DAY SAINTS PROJECT NUMBER: 5404304-22010301




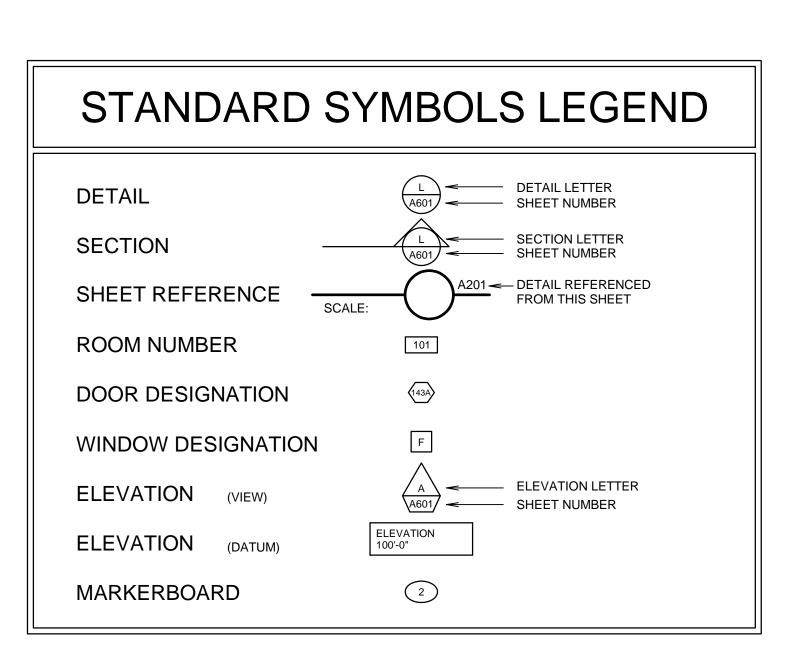



	Image: constraint of the second sec	Dradley gygi architect Bradley gygi architect E associates, pllc P0 Box 521048 Salt Lake City, UT 84152 B01 · 747 · 2451
		ATITUTE PRICE UT INSTITUTE 410 EAST 400 NORTH PRICE, UT
	DRAWING INDEX	PROJECT FOR: THE CHURCH OF JESUS CHRUST OF LATTER-DAY SAINTS
SHEET	SHEET TITLE	
NUMBER G001	GENERAL COVER SHEET AND INDEX ARCHITECTURAL	
A101 A601	FLOOR PLANS FINISH SCHEDULE AND DETAILS	PROJECT NUMBER: 5404304-22010301 DATE: 7 APR 2022 PROPERTY NUMBER: 5404304
EG101 ED101 ED10\2 EL101 EL102	ELECTRICAL SYMBOLS AND NOTES LOWER LEVEL LIGHTING DEMOLITION PLAN MAIN LEVEL LIGHTING DEMOLITION PLAN LOWER LEVEL LIGHTING PLAN	DRAWN BY: CHECKED: BGG BGG
EL102 EL601 EL602	MAIN LEVEL LIGHTING PLAN LIGHT FIXTURE SCHEDULE AND LIGHTING CONTROLS LIGHTING CONTROL DIAGRAMS	G001

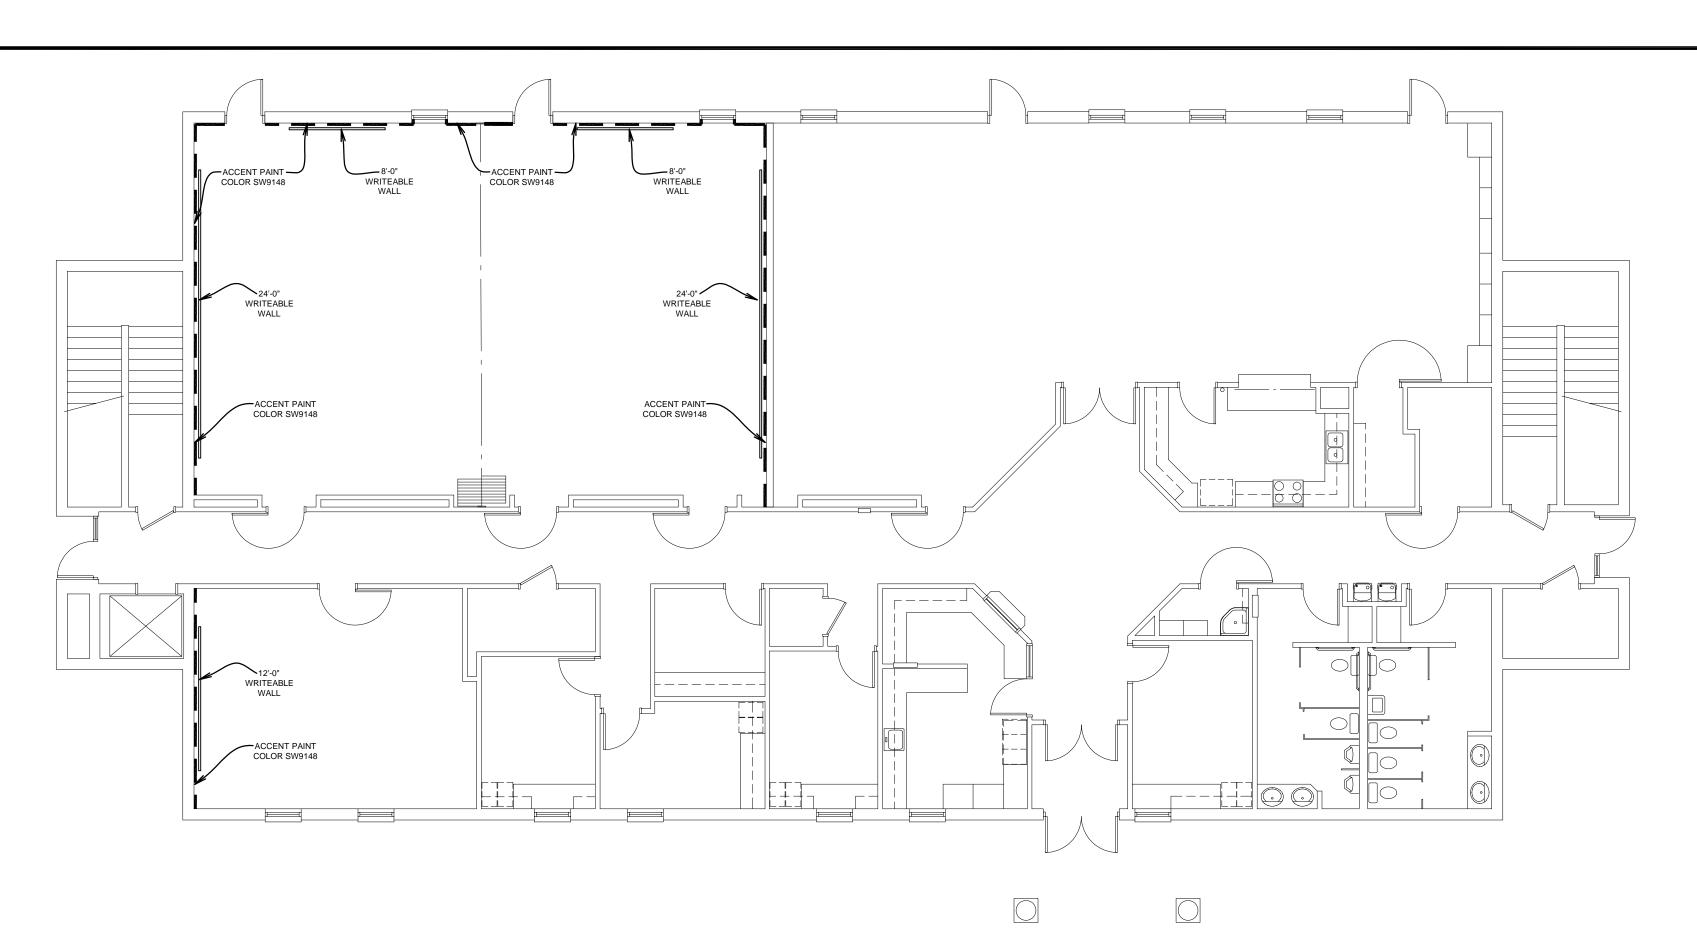

ACCENT COLOR AND WRITABLE WALLS PLAN

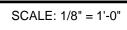

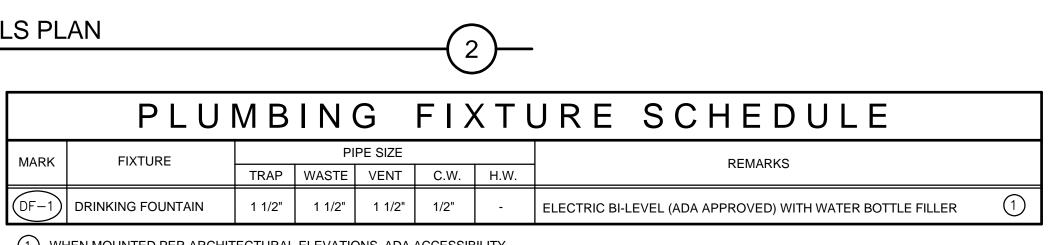

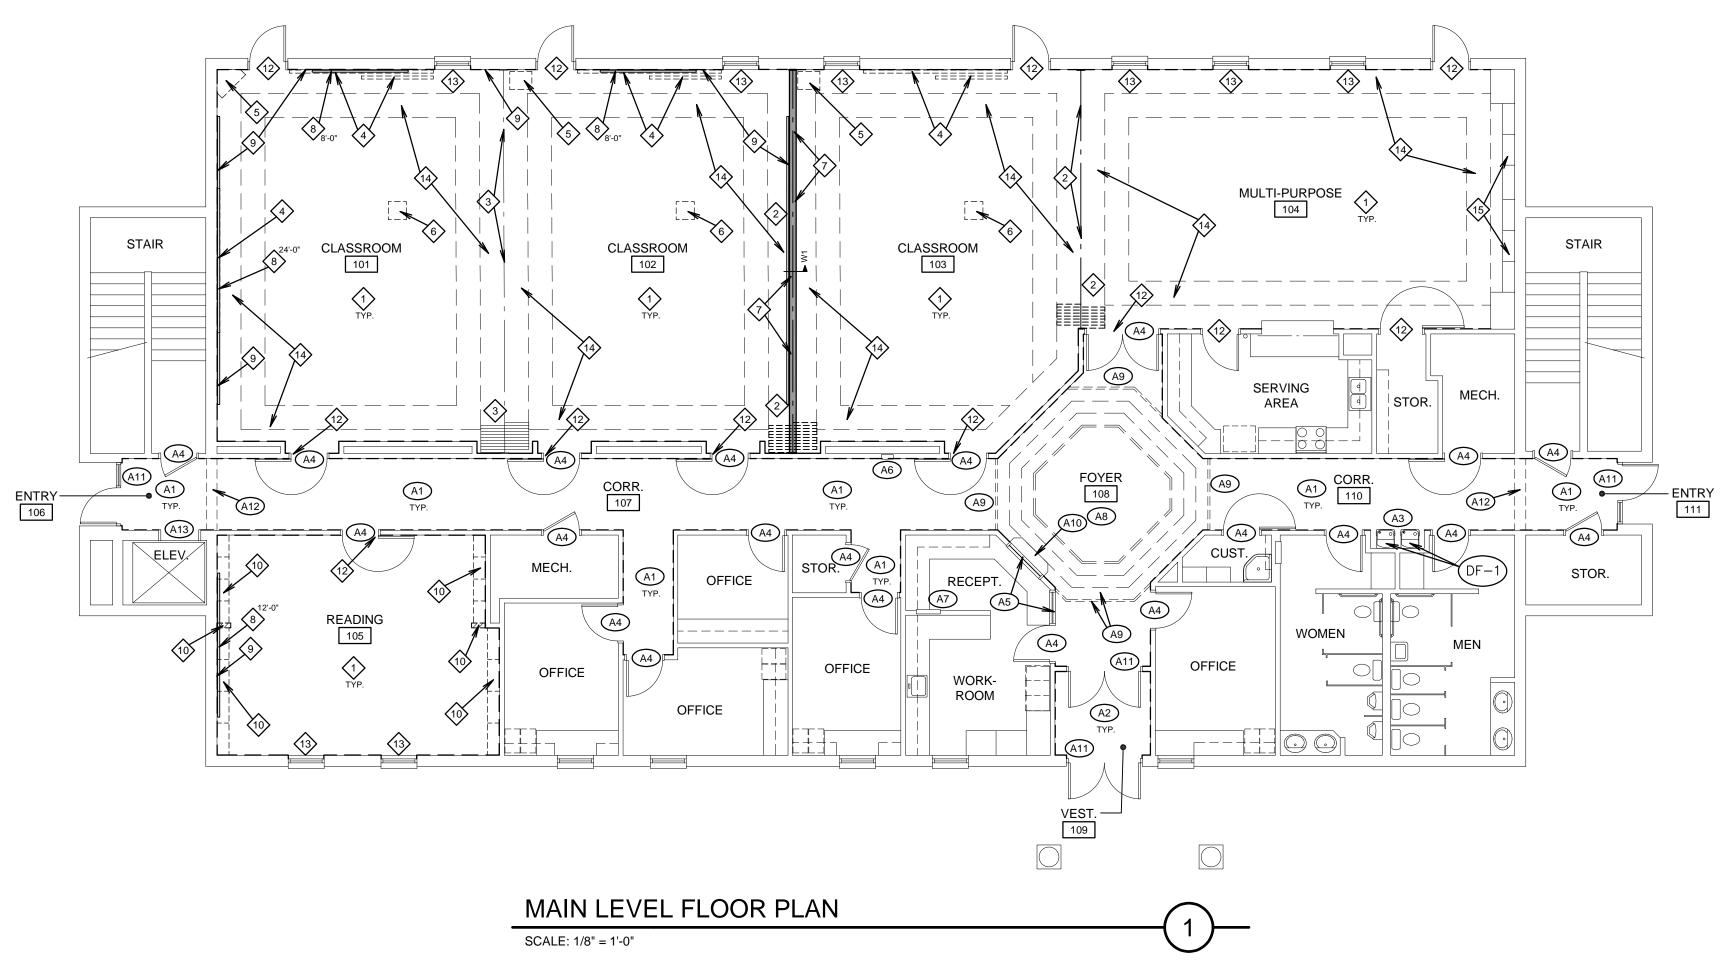

(1) WHEN MOUNTED PER ARCHITECTURAL ELEVATIONS, ADA ACCESSIBILITY REQUIREMENTS ARE SATISFIED.

(A1)	CORRIDOR AND FOYE ACOUSTIC WALL CAR CHAIR RAIL, CEILING ENTIRE ROOM. TYPIC GYPSUM BOARD TO M DEMOLITION WORK A SEAL, SKIM COAT, PR HEIGHT WITH HOLY SI PAINT ALL WALLS. NE PAINTED POPLAR CEI GUARDS AT ALL OUTS UP 8'-0" TALL - D/A601
A2	VESTIBULE WALLS: RI CARPETING, CARPET AND DOOR CASING TI SEAL, SKIM COAT, PR HEIGHT WITH HOLY SI PAINT ALL WALLS. NE PAINTED POPLAR CEI NOTE #5.
A3	REMOVE EXISTING CE WALLS AND PAVER TH WAINSCOT AND COVE EXTEND UP 5'-0" ABOY EXISTING 12"x12" PAV FLOOR. NEW GYPSUM TILE WAINSCOT TO C FOUNTAINS AND REP WITH WATER BOTTLE REQUIRED. SEE PLUM
<u>A4</u>	CAULK, LIGHTLY SAN HOLLOW METAL DOO WINDOW LITE IN DOO FRAMES ONLY. NEW S INTO CORRIDORS.
<u>A5</u>	REMOVE HARDWOOD WINDOWS. CAULK, LIO EXISTING HOLLOW MI OF FRAME ONLY.
(A6)	EXISTING FIRE EXTIN
(A7)	EXISTING FIRE ALARM REMAIN.
A8	PAINT EXISTING RAIS BOARD SOFFITS. EXIS EXISTING HARDWOOD CENTER.
<u>A9</u>	PAINT EXISTING HARI AND PAINTED GYPSU TEXTURE TO REMAIN
(A10)	EXISTING SHELF AND REINSTALL OR PROTE WALL COLOR.
(A11)	RECAULK EXISTING S WALLS.
A12	NEW PAINTED CEILIN HEADER. PAINT GYPS REMAIN.
A13	CAULK EXISTING ELE
	ALTERNATE
	CONTRACTOR SHALL

CONTRACTOR SHALL OF ALL WORK LISTED NOTES TO BE ADDED BY THE OWNER. ALTE SEPARATELY ON THE
OWNER SHALL HAVE THE BASIS OF EITHER COMBINED AMOUNT

		PAIN	Г (
<u>C</u>	lassroom V SW0050	Valls and Sof	fits Cla
M	letal Door F SW0050		Cla
0	other Finish SW0050	<u>es shown to</u>)	be Cla
N R	/here show oom Numb	AINT COLOR on by Keyed I ers listed bel drawings, no	Not low
R	oom	Accent Col	or
1(01 02 05	SW9148 SW9148 SW9148	

ALTERNATE #1 KEYED NOTES

- (A1) CORRIDOR AND FOYER WALLS: REMOVE ALL EXISTING RPETING, CARPET BASE WITH WOOD TRIM, G TRIM, AND DOOR CASING TRIM. TYPICAL CAL ENTIRE ROOM. PATCH EXISTING MATCH WHERE DISTURBED BY AND ADD CORNER BEADS WHERE NEEDED. RIME AND TEXTURE ALL WALLS FULL SMOOTH OR 80/20 SANTA FE TEXTURE. IEW CARPET BASE BY OWNER. NEW EILING TRIM - SEE C/A601. INSTALL CORNER TSIDE 90° AND 45° CORNERS FROM BASE . SEE GENERAL NOTE #5.
 - REMOVE ALL EXISTING ACOUSTIC WALL T BASE WITH WOOD TRIM, CEILING TRIM, TRIM. PATCH EXISTING GYPSUM BOARD. RIME AND TEXTURE ALL WALLS FULL SMOOTH OR 80/20 SANTA FE TEXTURE. IEW CARPET BASE BY OWNER. NEW EILING TRIM - SEE C/A601. SEE GENERAL
 - CERAMIC TILE AND BACKER BOARD AT TILE AT FLOORS. NEW CERAMIC TILE VED BASE ON NEW TILE BACKER BOARD, OVE FLOOR WITH BULLNOSE TOP COURSE. VER TILE WITH TERRAZZO METAL EDGE AT JM BOARD, TEXTURE AND PAINT ABOVE CEILING. REMOVE EXISTING DRINKING PLACE WITH NEW HI-LOW CONFIGURATION E FILLER. RE-ROUGH PLUMBING AS JMBING FIXTURE SCHEDULE AND F/A601.
 - ND, PREPARE AND PAINT EXISTING OR FRAME AND METAL FRAME AROUND OR (WHERE OCCURS). CORRIDOR SIDE OF SMOKE GASKETS AT DOORS SWINGING
 - D WINDOW CASINGS AT METAL FRAMED LIGHTLY SAND, PREPARE AND PAINT METAL WINDOW FRAME. CORRIDOR SIDE
 - NGUISHER CABINET TO REMAIN.
 - RM PANEL OR ELECTRICAL PANEL TO
 - ISED CEILING AREA AND STEPPED GYPSUM ISTING TEXTURE TO REMAIN. PAINT DD TRIM. CEILING TILE TO REMAIN AT
 - RDWOOD CEILING TRIM AT CEILING TILE UM BOARD CEILING. EXISTING CEILING
 - SUPPORTS TO REMAIN. REMOVE AND TECT IN PLACE. PAINT SUPPORTS NEW
 - STOREFRONT FRAMING AT NEW PAINTED
 - NG TRIM C/A601 AT GYPSUM BOARD SUM BOARD. EXISTING TEXTURE TO
 - EVATOR DOOR FRAME.

TE #1 BID INSTRUCTIONS:

PROVIDE A BID AMOUNT FOR THE COST D IN THE ABOVE ALTERNATE #1 KEYED TO THE BASE BID AMOUNT IF ACCEPTED TERNATE WORK IS ALSO LISTED IE FINISH SCHEDULE ON SHEET A601.

E DISCRETION TO TO AWARD THE BID ON IER THE BASE BID AMOUNT OR THE IT OF THE BASE BID PLUS ALTERNATE #1.

COLOR SCHEDULE

lassic Light Buff

lassic Light Buff

<u>e painted:</u> Classic Light Buff

ote #9 on Drawings v correspond to room number as shown on room signage in the building.

Color Name (Sherwin Williams)

Smoky Azurite Smoky Azurite Smoky Azurite

	GENERAL NOTES		5	152
1.	 DEMOLITION: DEMOLITION DRAWINGS ARE SHOWN TO ASSIST CONTRACTOR ONLY, AND ARE NOT INTENDED TO BE ALL-INCLUSIVE OR TO LIMIT EXTENT OF DEMOLITION WORK REQUIRED. CONTRACTOR SHALL VISIT SITE PRIOR TO BIDDING AND COORDINATE WITH ALL TRADES AND DRAWINGS TO DEFINE EXTENT OF DEMOLITION WORK REQUIRED TO PERFORM NEW WORK AND TO CARRY OUT THE INTENT OF THESE CONTRACT DRAWINGS. OWNER HAS FIRST RIGHTS TO SALVAGE. SEE ALL OTHER DOCUMENTS FOR ADDITIONAL DEMOLITION WORK TO BE PERFORMED. COORDINATE. 	avai architer	iates, plic	8 Salt Lake City, UT 84 801 · 747 · 2451
2.	PROTECT EXISTING FINISHES WHICH ARE TO REMAIN THROUGHOUT THE CONSTRUCTION PERIOD, INCLUDING CARPET, CEILING TILE, CASEWORK, WOOD TRIM AND OTHER WORK.		assoc	52104
3.	LIGHTING AND CONTROLS: SEE ELECTRICAL DRAWINGS FOR ADDITIONAL NOTES REGARDING REPLACEMENT OF LIGHT FIXTURES, SWITCHES AND LIGHTING CONTROLS.	u	ι 2 3	PO Box
4.	PLUMBING, MECHANICAL, HVAC, ELECTRICAL, AV: EXISTING AS REQUIRED TO ACCOMMODATE NEW WORK/FINISHES AND STORE FOR REINSTALLATION WHERE APPLICABLE.			
5.	TYPICAL ALL AREAS: REMOVE, SALVAGE AND REINSTALL ALL ELECTRICAL AND FIRE ALARM DEVICES, EXIT SIGNS, DOOR HOLD OPENS, FIRE EXTINGUISHER CABINETS, ROOM SIGNS, COAT RACKS, ACCESSORIES, THERMOSTATS, GRILLES, DOOR STOPS AND MAGNETIC HOLD OPEN DEVICES, AND OTHER WALL-MOUNTED WORK AS REQUIRED TO ACCOMMODATE NEW WALL FINISH WORK. OWNER WILL REMOVE ALL EXISTING ARTWORK AND NON-PERMANENT DECORATIONS PRIOR TO START OF THIS WORK.	STAMP:		R C 11 - 1 - 1 - 1 - 1 - 1 - 1 - 1 - 1 -
	KEYED NOTES	1 1	BRAD	
		Miles.	47 A 7	0 F
↔	CLASSROOM, MULTI-PURPOSE AND READING ROOM WALLS: REMOVE ALL EXISTING ACOUSTIC WALL CARPETING, CARPET BASE WITH WOOD TRIM, CHAIR RAIL, CEILING TRIM, AND DOOR CASING TRIM. TYPICAL ENTIRE ROOM. PATCH EXISTING GYPSUM BOARD TO MATCH WHERE DISTURBED BY DEMOLITION WORK AND ADD CORNER BEADS WHERE NEEDED. SEAL, SKIM COAT, PRIME AND TEXTURE ALL WALLS FULL HEIGHT WITH HOLY SMOOTH OR 80/20 SANTA FE TEXTURE. PAINT ALL WALLS. ACCENT PAINT COLOR ON WALL(S) WHERE NOTED. NEW CARPET BASE BY OWNER. SEE GENERAL NOTE #5.			RTH
2	REMOVE EXISTING FOLDING PANEL PARTITION, INCLUDING HEADER TRACK AND TRIM AND WALL JAMBS AND TRIM. DISCONNECT POWER TO MOTOR FOR OPERATING DOOR AND REMOVE KEYED SWITCH. PATCH IN NEW GYPSUM BOARD, TEXTURE TO MATCH EXISTING CEILING TEXTURE AND PAINT. LEAVE EXISTING WALL JAMBS BETWEEN 103 AND 105 AND PAINT IF ALTERNATE #1 IS NOT INCLUDED.		PRICE UI INSTITUTE	410 EAST 400 NORTH PRICE, UT
	EXISTING FOLDING PANEL PARTITION TO REMAIN.			4
	REMOVE EXISTING VISUAL DISPLAY BOARD AND PROJECTION SCREEN.			
<5>	REMOVE EXISTING WALL-MOUNTED AV CABINET. REMOVE ALL EQUIPMENT, CABLES, ADAPTERS AND RELATED WORK IN EXISTING CABINETS AND SALVAGE TO OWNER (FM). AT ADJACENT WALL BOXES, TUCK EXISTING AV WIRING INTO BOX AND INSTALL BLANK COVER PLATE. MAINTAIN EXISTING ELECTRICAL OUTLETS AND CIRCUITS AT THESE LOCATIONS.			
<u>6</u>	REMOVE EXISTING CEILING-MOUNTED PROJECTOR AND SALVAGE TO OWNER (FM). TUCK AV CABLES INTO CEILING AND INSTALL BLANK COVER PLATE.		H OF	SAINT
	NEW WALL TYPE W1. TEXTURE AND FINISH PER KEYED NOTE #1.	PROJECT FOR	URCH	
8	NEW WRITEABLE WALL ON FINISHED PAINTED WALL. BY OWNER UNDER SEPARATE CONTRACT. MOUNTED ON WALLS FROM 2'-0" AFF TO 8'-0" AFF.	PROJE	THE CH	US (
9	ACCENT PAINT COLOR THIS WALL. FLOOR TO CEILING, CORNER TO CORNER. SEE COLOR SCHEDULE.		Ë ;	ECI OF L
	REMOVE EXISTING STEM WALLS AND RELATED WORK. PATCH ADJACENT WALLS AND FINISH PER OTHER NOTES.			
	REMOVE EXISTING BOOKSHELVES.			
12	CAULK, LIGHTLY SAND, PREPARE AND PAINT EXISTING HOLLOW METAL DOOR FRAME AND METAL FRAME AROUND WINDOW LITE IN DOOR (WHERE OCCURS). ROOM SIDE OF FRAMES ONLY.			
13	REMOVE EXISTING MINI BLINDS. PROTECT EXISTING MARBLE WINDOW STOOL. TEXTURE WALL BELOW STOOL PER NOTE #1 AND CAULK BEFORE PAINTING. NO NEW WINDOW TREATMENTS.			
1 4	PAINT EXISTING STEPPED CEILING SOFFIT AT PERIMETER OF ROOM (SHOWN DASHED) AND UPPER CEILING TO EDGES OF CEILING TILE. EXISTING TEXTURE TO REMAIN.			
(15)	PROTECT EXISTING CABINETS TO REMAIN. TOUCH UP STAIN AND ADD ONE COAT FINISH.		T NUMBER: 4304-2201	0301

WALL TYPE SCHEDULE DESCRIPTION

MARK

2x6 STUDS AT 16" O.C. WITH 5/8" GYPSUM BOARD EACH SIDE. FULL W THICK ACOUSTICAL INSULATION. CAULK TOP AND BOTTOM.

A101

FLOOR PLANS

DATE:

7 APR 2022

PROPERTY NUMBER:

CHECKED:

BGG


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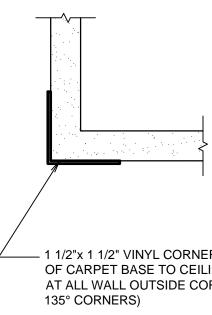
DRAWN BY:

SHEET TITLE:

SHEET:





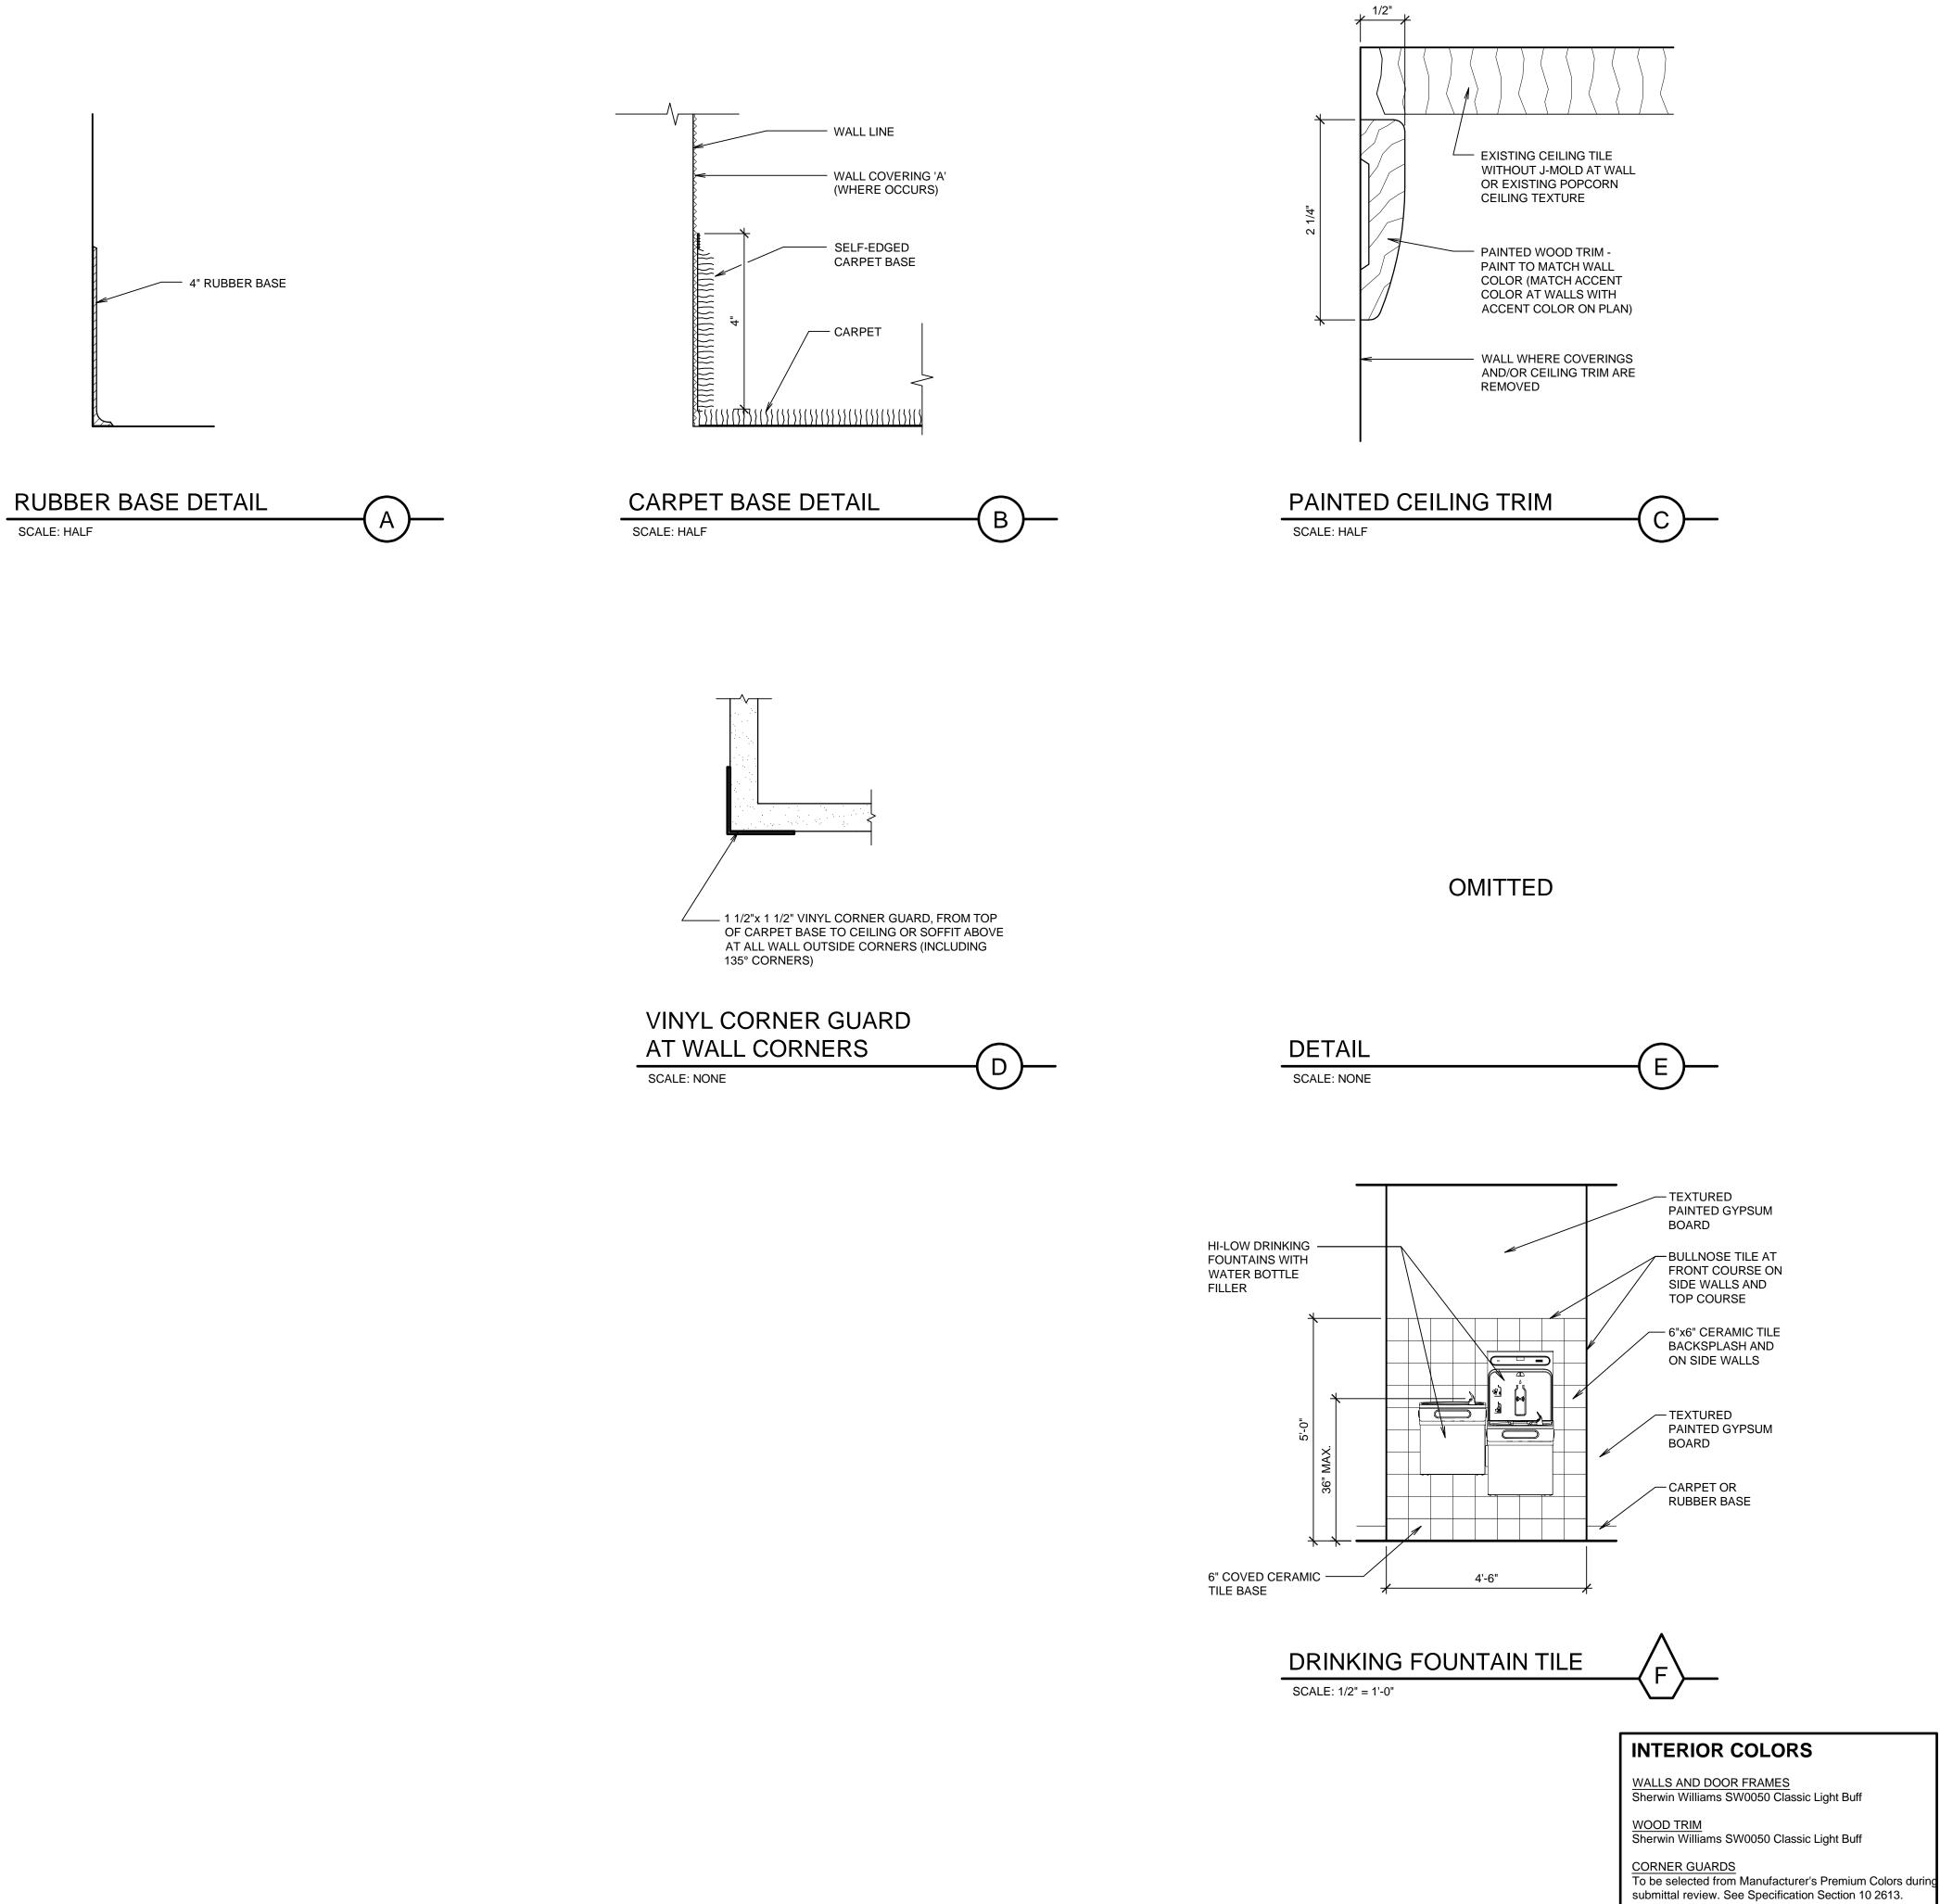

	FINISH SCHEDULE							
ROOM NO.	ROOM NAME	FLOOR	BASE	WALLS	CEILING	CEILING HEIGHT	SPECIAL TRIM OR EQUIPMENT	gygj archit ates, pllc Salt Lake City, UT 1 · 747 · 2451
BA 101 102 103 104 105	ASE BID WORK AT MAIN LEVEL CLASSROOM CLASSROOM MULTI-PURPOSE READING	F1 F1 F1 F1 F1	B1 B1 B1 B1 B1	W1 W1,W5 W1,W5 W1 W1	C2,C5 C2,C5 C2,C4,C5 C2,C4,C5 C5,C6		S1,S4,S5,S6,S7 S1,S4,S5,S6,S7 S1,S4,S5,S6 S1,S3,S5,S6,S8 S1,S2,S5,S6,S7	VGI bradley E associ P0 Box 521048 80
AL 106 107 108 109 110 111	TERNATE #1 WORK AT MAIN LEVEL ENTRY CORRIDOR FOYER VESTIBULE CORRIDOR ENTRY	F1 F1 F1 F1,F3 F1	B1 B1 B1 B1,B2 B1 	W2 W2 W3 W2,W4 W2	C5 C5 C4,C5 C5 C5 C5 C5	8'-0"± 8'-0"± 9'-10"± 8'-0"± 8'-0"±	\$1,\$2,\$6 \$1,\$2,\$4,\$6 \$1,\$2,\$4,\$6,\$10 \$1,\$2,\$4,\$6,\$10 \$1,\$2,\$4 \$1,\$2,\$3,\$4,\$6,\$9 \$1,\$2,\$3,\$4,\$6,\$9 \$1,\$2,\$3 \$1,\$2,\$3,\$4,\$6,\$9	STAMP:
								PRICE UT INSTITUTE 410 EAST 400 NORTH PRICE, UT
F F1 F2 F3 B1 B2 W W1	FLOOR EXISTING CARPET TO REMAIN. NEW CARPET BY OWNER EXISTING PAVER TILE AT DRINK REMAIN. PROTECT. BASE NEW RUBBER BASE A/A601 OR BY OWNER NEW COVED TILE BASE AT DRIN WALLS REMOVE ALL EXISTING ACOUS CARPET BASE WITH WOOD TR CEILING TRIM, AND DOOR CAS ENTIRE ROOM. PATCH EXISTIN TO MATCH WHERE DISTURBED WORK AND ADD CORNER BEAU SEAL, SKIM COAT, PRIME AND FULL HEIGHT WITH HOLY SMO	KING FOUN CARPET B NKING FOU TIC WALL C RIM, CHAIR SING TRIM. NG GYPSUN D BY DEMO DS WHERE TEXTURE	ITAINS TO ASE A/A601 JNTAINS CARPETING RAIL, TYPICAL M BOARD DLITION E NEEDED. ALL WALLS	C5 C6 5, <u>S</u>	PAIN PAIN VPP PAIN STE TEXT MAT REM EXIS WHE ADD TILE GYP TYPI REIN DEV EXT	T EXISTIN PER CEILIN T EXISTIN PPED GYF TURE AND TCH WHER MOVED. TING CEIL ERE DISTU PAINTED SUM BOA PECIAL CAL ALL A NSTALL AL TICES, EXIT INGUISHE	G PAINTED CEILING G STEPPED CEILING SOFFITS AND G TO TILE. G RAISED CEILING AREA AND SUM BOARD SOFFITS. PAINT NEW GYPSUM BOARD TO E PARTITION HEADER TRACK IS ING TO REMAIN. PATCH TO MATCH RBED. WOOD TRIM AT EDGES OF CEILING EXTURE, AND PAINT EXISTING RD WHERE SHELVES ARE REMOVED. TRIM OR EQUIPMENT REAS: REMOVE, SALVAGE AND L ELECTRICAL AND FIRE ALARM I SIGNS, DOOR HOLD OPENS, FIRE R CABINETS, ROOM SIGNS, COAT	PROJECT FOR: THE CHURCH OF JESUS CHRUST OF LATTER-DAY SAINTS
W2 W3	FE TEXTURE. PAINT ALL WALLS COLOR ON WALL(S) WHERE NO NOTE #5. REMOVE ALL EXISTING ACOUS CARPET BASE WITH WOOD TR CEILING TRIM, AND DOOR CAS ENTIRE ROOM. TYPICAL ENTIR EXISTING GYPSUM BOARD TO DISTURBED BY DEMOLITION W CORNER BEADS WHERE NEED PRIME AND TEXTURE ALL WAL HOLY SMOOTH OR 80/20 SANT. ALL WALLS. SEE GENERAL NO REMOVE ALL EXISTING ACOUS CARPET BASE WITH WOOD TR	S. ACCENT OTED. SEE TIC WALL (RIM, CHAIR BING TRIM. RE ROOM. F MATCH WH VORK AND / DED. SEAL, LLS FULL H A FE TEXT TE #5. TIC WALL (RIM, CEILING	PAINT GENERAL CARPETING RAIL, TYPICAL PATCH HERE ADD SKIM COAT EIGHT WITH URE. PAINT CARPETING G TRIM,	5, S2 S3 F, S4 H S, S5 S6 S7	DOC DEV REQ WOF NEW EXIS EXIS REM REIN VINY AND D/A6 NO W DOO	OR STOPS (ICES, AND QUIRED TO RK. PAINTED STING CEII TING FIRE (AIN. PRO NSTALL. (I CORNEF 0 45° CORN 601. VINDOW TI R FRAME I FEABLE W.	SSORIES, THERMOSTATS, GRILLES, AND MAGNETIC HOLD OPEN O OTHER WALL-MOUNTED WORK AS ACCOMMODATE NEW WALL FINISH POPLAR WOOD CEILING TRIM AT ING TILE. C/A601. EXTINGUISHER CABINET TO FECT IN PLACE OR REMOVE AND R GUARD(S) AT ALL ALL OUTSIDE 90° HERS FROM BASE UP 8'-0" TALL. SEE REATMENTS PAINTING - SEE FLOOR PLAN ALLS (BY OWNER)	
W4 W5	AND DOOR CASING TRIM. PATO BOARD. SEAL, SKIM COAT, PRI WALLS FULL HEIGHT WITH HOI SANTA FE TEXTURE. PAINT ALI GENERAL NOTE #5. NEW CERAMIC TILE BACKSLASI FOUNTAINS WITH BULLNOSE S COURSE. SEE F/A601. NEW GYPSUM BOARD AT NEW SMOOTH OR 80/20 SANTA FE T AND PAINT.	IME AND TE LY SMOOT L WALLS. S H AT DRINN SIDES AND WALL(S). H	EXTURE ALI H OR 80/20 SEE NKING TOP IOLY	L S9 S10	UP S NEW PAIN ADD ENERAI SCHE MATC SCHE MATC INCLU CASE SEE S AND CAUL	TAIN AND DRINKING TEXISTING TEXISTING DITIONAL N DITIONAL N DITIONAL N DITIONAL N DITIONAL N CHIFDIST CHIFDIST CHIFDIST CHIFDIST CHIFDIST CHIFDIST CHIFDIST CHIFDIST SHEETS AT WINDOW F LKING NOT	SHES ARE LISTED ON THIS STING IS TO REMAIN. PATCH TO JRBED BY THIS NEW WORK. TING FINISHES WHICH ARE TO REMAIN THE CONSTRUCTION PERIOD, LING TILE, HARDWOOD FLOORS, OOD TRIM AND OTHER WORK. 100, A101 AND A102 FOR DOOR FRAME TRAME PAINTING NOTES AND	PROJECT NUMBER: 5404304-22010301 DATE: 7 APR 2022 PROPERTY NUMBER: 5404304 DRAWN BY: BGG CHECKED: BGG SHEET TITLE: FINISH SCHEDULE AND DETAILS
					AND		MANENT DECORATIONS PRIOR TO	SHEET: A601


GENERAL PROJECT NOTES:

- 1. DIVISION 26000 CONTRACTOR IS RESPONSIBLE FOR READING AND APPLYING WHAT IS IN THE SPECIFICATIONS TO THIS PROJECT. ANYTHING THAT IS NOT INCLUDED ON THE PROJECT THAT IS CALLED OUT IN THE SPECIFICATION SHALL BE LISTED ON THE SUBSTANTIAL COMPLETION PUNCHLIST. THE CONTRACTOR WILL BE REQUIRED TO REMEDY THESE DEFICIENCIES WITHOUT ADDITIONAL COSTS TO OWNER. THERE WILL BE NO EXCEPTIONS.
- 2. THE CONTRACTOR MAY SCHEDULE A PRE-CONSTRUCTION MEETING AT THEIR DISCRETION, WITH THE ARCHITECT AND ELECTRICAL ENGINEER TO REVIEW THE DRAWINGS AND SPECIFICATIONS. THE MEETING SHALL BE A MAXIMUM OF ONE HOUR AND SHALL TAKE PLACE AT THE ENGINEER'S OFFICE.
- 3. THE FOLLOWING ITEMS ARE REQUIREMENTS OF THE PROJECT:
- A. THE CONTRACTOR SHALL PROVIDE SEISMIC SUPPORT AND BRACING FOR ALL LIGHT FIXTURES AND ELECTRICAL EQUIPMENT AS REQUIRED BY APPLICABLE LOCAL, STATE, AND NATIONAL CODES.
- 4. THE CONTRACTOR SHALL VISIT THE SITE BEFORE SUBMITTING THE BID, AND SHALL EXAMINE ALL PHYSICAL CONDITIONS WHICH MAY BE MATERIAL TO THE PERFORMANCE OF HIS WORK. NO ADDITIONAL PAYMENTS WILL BE ALLOWED TO THE CONTRACTOR AS A RESULT OF EXTRA WORK MADE NECESSARY BY HIS FAILURE TO DO SO. ANY CASE OF DISCREPANCY OR LACK OF CLARITY SHALL BE PROMPTLY IDENTIFIED TO THE OWNER'S REPRESENTATIVE AND THE ENGINEER FOR CLARIFICATION.

LIGHTING SYMBOLS			BRANCH CIRCUITING SYMBOLS				ELECTRICAL SYMBOL SCHEDULE GENERAL NOTES					
	TURE SYMBOLS ARE GENERAL IN NATURE AND MAY BE SHOWN ON	N THE DRAWINGS IN	VARIOUS SIZES AND SHAPES. REFER TO	SYMBOL	SYMBOL DESCRIPTION REMARKS		1. MOUNT	ALL OUTLI	ETS, DEVICES, AND EQUIPMENT AT HEIGHTS	INDICATED BELOW, UNLESS NOTED OTHERWISE ON THE DRAWINGS.		
	T FIXTURE SCHEDULE FOR SPECIFICATION INFORMATION. INDICATE AIMING DIRECTION.				1 CIRCUIT, 2 WIRE BRANCH CIRCUIT HOME RUN TO PANEL		ER OF ARROWS INDICATES NUMBER OF RED.			THERWISE, HEIGHTS ARE GIVEN FROM FINIS	SHED FLOOR TO CENTER OF OUTLET BOX. SUBSCRIPTS, REFER TO ABBREVIATION SCHEDULE FOR DEFINED	plic plic
SYMBOL	DESCRIPTION	MOUNTING	REMARKS		2 CIRCUIT, 4 WIRE BRANCH CIRCUIT HOME RUN TO PANEL	INDICATES NUME	NES: NUMBER OF SHORT CROSS LINES ER OF PHASE, TRAVELER, AND/OR SWITCHED EQUIRED IF GREATER THAN 1 (ONE).	REQUIRI	EMENTS.		THE SUBSCRIPT 'A', MOUNT AT 4" ABOVE COUNTER. IF COUNTER HAS A BACK	<mark>ygj al</mark> i tes, p salt Lake 747 · 2451
╏╏	ARM-MOUNTED SINGLE-HEAD LIGHT FIXTURE AND POLE	AS SPECIFIED OR DETAILED			3 CIRCUIT, 6 WIRE BRANCH CIRCUIT HOME RUN TO PANEL		ES: NUMBER OF LONG CROSS LINES ER OF NEUTRAL CONDUCTORS REQUIRED		, MOUNT A		ITECTURAL INTERIOR ELEVATIONS AND COORDINATE WITH CASEWORK	y gy ciat ^{18 Sa}
	ARM-MOUNTED DOUBLE-HEAD LIGHT FIXTURE AND POLE	AS SPECIFIED OR DETAILED			MULTIPLE WIRE BRANCH CIRCUITING BETWEEN FIXTURES,	EQUIPMENT GRC	UND AND ISOLATED GROUND CONDUCTORS: UND AND ISOLATED GROUND CONDUCTORS	4. NOT ALL	ELECTRI	CAL SYMBOLS MAY BE USED.		SSO
00	POST-TOP SINGLE-HEAD, LIGHT FIXTURE AND POLE	AS SPECIFIED OR DETAILED			SWITCHES, DEVICES, ETC. BRANCH CIRCUITING (U.N.O.) TURNED UP OR TOWARDS		I, BUT ARE REQUIRED AS NOTED ON THE THE SPECIFICATIONS.			GENEF	RAL SYMBOLS	
	WALL-MOUNTED FIXTURE	AS SPECIFIED OR DETAILED	REFER TO ARCHITECTURAL EXTERIOR ELEVATIONS FOR MOUNTING HEIGHT	o	OBSERVER.			SYMBOL		DESCRIPTION	REMARKS	
0 O	LIGHT BOLLARD	AS SPECIFIED OR DETAILED		•	BRANCH CIRCUITING (U.N.O.) TURNED DOWN OR AWAY FROM OBSERVER.			XX	KEYED) NOTE		
\triangleleft	FLOOD LIGHT	AS SPECIFIED OR DETAILED		<u></u>	BRANCH CIRCUITING (U.N.O.) CONTINUATION				DETAIL	REFERENCE	TOP NUMBER INDICATES DETAIL NUMBER; BOTTOM LETTER-NUMBER INDICATES WHERE DETAIL IS SHOWN.	
h	RECESSED WALL FIXTURE OR STEP LIGHT	AS SPECIFIED	REFER TO ARCHITECTURAL EXTERIOR		CONDUIT STUB-IN	CAP AND MARK		E-1				
ч /	LIGHT FIXTURES	OR DETAILED AS SPECIFIED	ELEVATIONS FOR MOUNTING HEIGHT	\mid	INCOMING SERVICE			2 E-2	ELEVA	TION REFERENCE	TOP NUMBER INDICATES ELEVATION NUMBER; BOTTOM LETTER-NUMBER INDICATES WHERE ELEVATION IS SHOWN.	
		OR DETAILED			JUNCTION BOX		ED. SUBSCRIPT 'F' INDICATES TO PROVIDE A	E-2				STAMP:
	1					FLOOR BOX WIT	H BLANK COVERPLATE		SECTIO	ON REFERENCE	TOP NUMBER INDICATES SECTION NUMBER; BOTTOM LETTER-NUMBER INDICATES WHERE SECTION IS SHOWN.	PROFESSION PROFESSION
	WALL-MOUNTED LINEAR LIGHT FIXTURE	AS SPECIFIED OR DETAILED			WIRING DEVICE SY	MBOLS		E-3				DAVID P. WHITTON
	LINEAR WALL WASHER	AS SPECIFIED OR DETAILED		SYMBOL		MOUNTING	REMARKS	100	ARCHI	TECTURAL ROOM NUMBER		No.264397
Ø	RECESSED DOWN LIGHT	AS SPECIFIED		⊅	SINGLE-POLE TOGGLE SWITCH SINGLE-POLE TOGGLE SWITCH	+48" +48"	SUBSCRIPT KEYS SWITCH TO FIXTURES	AHU	EQUIP	MENT NAME / NUMBER	TOP NUMBER ABBREVIATES EQUIPMENT NAME OR TYPE;	ATE OF UTA
	RECESSED WALL-WASHER OR DIRECTIONAL DOWNLIGHT	OR DETAILED AS SPECIFIED	IF SHOWN, ARROW INDICATES AIMING	⊅ ⁻ \$ 2	DOUBLE-POLE TOGGLE SWITCH	+48"	CONTROLLED.				BOTTOM NUMBER INDICATES EQUIPMENT NUMBER. REFER TO EQUIPMENT SCHEDULE.	2022/04/13
	SURFACE OR PENDANT-MOUNTED LIGHT FIXTURE	OR DETAILED AS SPECIFIED	DIRECTION	\$ ₃	THREE-WAY TOGGLE SWITCH	+48"		\land	REVISI	ION NUMBER	USED TO DENOTE CHANGES EITHER ISSUED BY ADDENDUM OR DURING CONSTRUCTION AND TO DENOTE RECORD DRAWING	
0		OR DETAILED		\$ 4	FOUR-WAY TOGGLE SWITCH	+48"				4 N. 	CHANGES.	
Ю	WALL-MOUNTED LIGHT FIXTURE	AS SPECIFIED OR DETAILED	REFER TO ARCHITECTURAL EXTERIOR ELEVATIONS FOR MOUNTING HEIGHT	\$ _K	KEY-OPERATED SINGLE-POLE TOGGLE SWITCH	+48"			BREAK	LINE	USED TO BREAK DRAWINGS.	
•	TRACK OR MONO-POINT LIGHT FIXTURE	AS SPECIFIED OR DETAILED	IF SHOWN, ARROW INDICATES AIMING DIRECTION	\$ _P \$ _{DIM}	SINGLE-POLE TOGGLE SWITCH WITH PILOT LIGHT DIMMER SWITCH	+48" +48"	RATE DIMMER SWITCH FOR MAXIMUM					КТН
D	WALL SCONCE	AS SPECIFIED		\$TIM	TIMER SWITCH	+48"	POSSIBLE WATTAGE					
	EGRESS LIGHT FIXTURE	OR DETAILED AS SPECIFIED	THIS IS AN <u>EXAMPLE</u> OF AN EGRESS LIGHT	\$ \$	(2) SINGLE-POLE TOGGLE SWITCH	+48"	DUAL LEVEL SWITCH OUTBOARD LAMPS	[
•		OR DETAILED	FIXTURE. EGRESS LIGHT FIXTURES ARE HALF-SHADED DIAGONALLY.	⊅ ⊅	MOMENTARY CONTACT SWITCH - LINE VOLTAGE	40"	SEPARATELY FROM INBOARD LAMPS. SEE LIGHTING CONTROL SCHEDULE					PRICE NSTITU EAST 400 PRICE,
	<u> </u>			Φ _{LV} \$ ^a _W	MOMENTARY CONTACT SWITCH - LINE VOLTAGE	+48" +48"	SEE LIGHTING CONTROL SCHEDULE		A	ABOVE COUNTER	BREVIATIONS MAY BE USED. ISO ISOLATED	
•	EMERGENCY (NON-EGRESS) LIGHT FIXTURE	AS SPECIFIED OR DETAILED	THIS IN AN <u>EXAMPLE</u> OF AN EMERGENCY (NON-EGRESS) LIGHT FIXTURE.		3-POSITION MAINTAINED CONTACT SWITCH				A ADJ	AMP OR AMPS ADJACENT	KVA KILO VOLT AMPERES KW KILOWATTS	410
			EMERGENCY FIXTURES ARE FULLY-SHADED.	\$PN		+48"	UP-ON; CENTER-OFF; DOWN-ON		AFF AHJ	ABOVE FINISHED FLOOR AUTHORITY HAVING JURISDICTION	LFMC LIQUID-TIGHT METAL CONDUIT LFNC LIQUID-TIGHT NONMETAL CONDUIT	
8	CEILING MOUNTED EXIT SIGN	CEILING	DARKENED PORTION OF SIGN INDICATES FACE(S); ARROW(S) INDICATE CHEVRON		OCCUPANCY SENSOR	AS NOTED	SEE LIGHTING CONTROL SCHEDULE		AL C	ALUMINUM CONDUIT	MCA MINIMUM CIRCUIT AMPS MLO MAIN LUGS ONLY	
KØ	WALL-MOUNTED EXIT SIGN	WALL ABOVE DOOR	DIRECTION(S)	● ●	SPLIT-WIRED DUPLEX RECEPTACLE SIMPLEX RECEPTACLE	+18" +18"			CB CKT	CIRCUIT BREAKER CIRCUIT	N.C.NORMALLY CLOSEDN.I.C.NOT IN CONTRACT	
KAR A	WALL-MOUNTED EXIT SIGN W/ EMERGENCY LIGHT FIXTURE	WALL ABOVE DOOR		₽	DUPLEX RECEPTACLE	+18"			C.O.'S CU	CONVENIENCE OUTLETS COPPER	N.L. NIGHT LIGHT N.O. NORMALLY OPEN	
				€	125/250V RECEPTACLE	+18"	RANGE NEMA 14-50R DRYER NEMA 14-30R			EACH ELECTRICAL	O.C. ON CENTER(S) OCP OVER CURRENT PROTECTION	H S
ТС	TIME CLOCK EMERGENCY LIGHT FIXTURE	+60" AS NOTED		•	FOURPLEX RECEPTACLE	+18"			EMT	EMERGENCY ELECTRIC METALLIC TUBING	QTY QUANTITY R REMOVE	
L L		ASNOTED		•	GROUND FAULT CIRCUIT INTERRUPTER DUPLEX RECEPTACLE	+18"			EQUIP	ELECTRIC NONMETALLIC TUBING EQUIPMENT ELECTRIC WATER COOLER	REQ. REQUIREMENTS RMC RIGID METAL CONDUIT RNC RIGID NONMETALLIC CONDUIT	
Ø	ELECTRIC PHOTOCELL	N/A	MOUNT ON ROOF FACING NORTH SKY	+	GROUND FAULT CIRCUIT INTERRUPTER FOURPLEX RECEPTACLE	+18"			E, EX	ELECTRIC WATER COOLER EXISTING EXPLOSION PROOF	RR REMOVE AND RELOCATE SS SURGE SUPPRESSION	HURCH CHI
XX	LIGHT FIXTURE CALLOUT (LETTER DENOTES FIXTURE TYPE)			•	EMERGENCY DUPLEX RECEPTACLE	+18"			FA	FIRE ALARM FIRE ALARM CONTROL PANEL	SCP SECURITY CONTROL PANEL TR TAMPER RESISTANT	
				_ ♥=	EMERGENCY FOURPLEX RECEPTACLE MULTI-OUTLET ASSEMBLY	+18" 4" ABOVE			FLA	FULL LOAD AMPS FLEXIBLE METAL CONDUIT	TYP TYPICAL TVSS TRANSIENT VOLTAGE SURGE SUPPRESSOR	
				0		BACKSPLASH			FOB	FREIGHT ON BOARD GROUND CONDUCTOR	UF UNDER FLOOR UG UNDERGROUND	
					POWER / TELEPHONE POLE	FLOOR/CEILING			HOA	HAND-OFF-AUTO HORSE POWER	U.N.O. UNLESS NOTED OTHERWISE W/ WITH	
				•	CORD DROP WITH DUPLEX RECEPTACLE SPECIAL PURPOSE OUTLET	+18"	REFER TO DETAIL SUBSCRIPT IN PARENTHESIS INDICATES		IG	ISOLATED GROUND	WP WEATHER PROOF	
				(5-20R)			SUBSCRIPT IN PARENTHESIS INDICATES NEMA CONFIGURATION IF SHOWN. REFER TO DRAWINGS AND/OR EQUIPMENT SCHEDULES. CONFIRM EXACT CONFIGURATION WITH OWNER PRIOR TO			INTERMEDIATE METAL CONDUIT INSULATED	XFMR TRANSFORMER	

INSTALLATION.


	1.1.1	NEOWATIO
LOOR	LFMC	LIQUID-TIGHT METAL CONDUIT
G JURISDICTION	LFNC	LIQUID-TIGHT NONMETAL CONDUIT
	MCA	MINIMUM CIRCUIT AMPS
	MLO	MAIN LUGS ONLY
	N.C.	NORMALLY CLOSED
	N.I.C.	NOT IN CONTRACT
TLETS	N.L.	NIGHT LIGHT
	N.O.	NORMALLY OPEN
	0.C.	ON CENTER(S)
	OCP	OVER CURRENT PROTECTION
	QTY	QUANTITY
IC TUBING	R	REMOVE
FALLIC TUBING	REQ.	REQUIREMENTS
	RMC	RIGID METAL CONDUIT
COOLER	RNC	RIGID NONMETALLIC CONDUIT
	RR	REMOVE AND RELOCATE
-	SS	SURGE SUPPRESSION
	SCP	SECURITY CONTROL PANEL
ROL PANEL	TR	TAMPER RESISTANT
	TYP	TYPICAL
ONDUIT	TVSS	TRANSIENT VOLTAGE SURGE SUPPRESSOR
D	UF	UNDER FLOOR
TOR	UG	UNDERGROUND
	U.N.O.	UNLESS NOTED OTHERWISE
	W/	WITH
)	WP	WEATHER PROOF
TAL CONDUIT	XFMR	TRANSFORMER

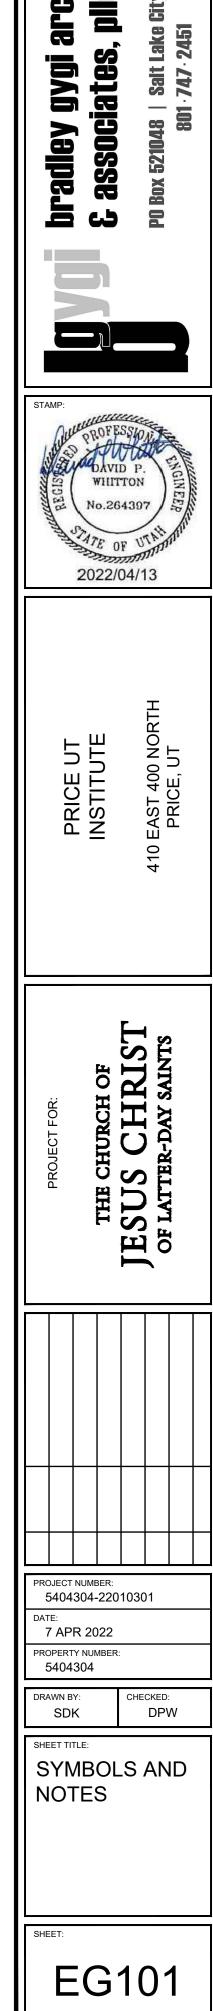

ENVISION

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240 East Morris Ave. Suite 200 South Salt Lake City, UT 84115

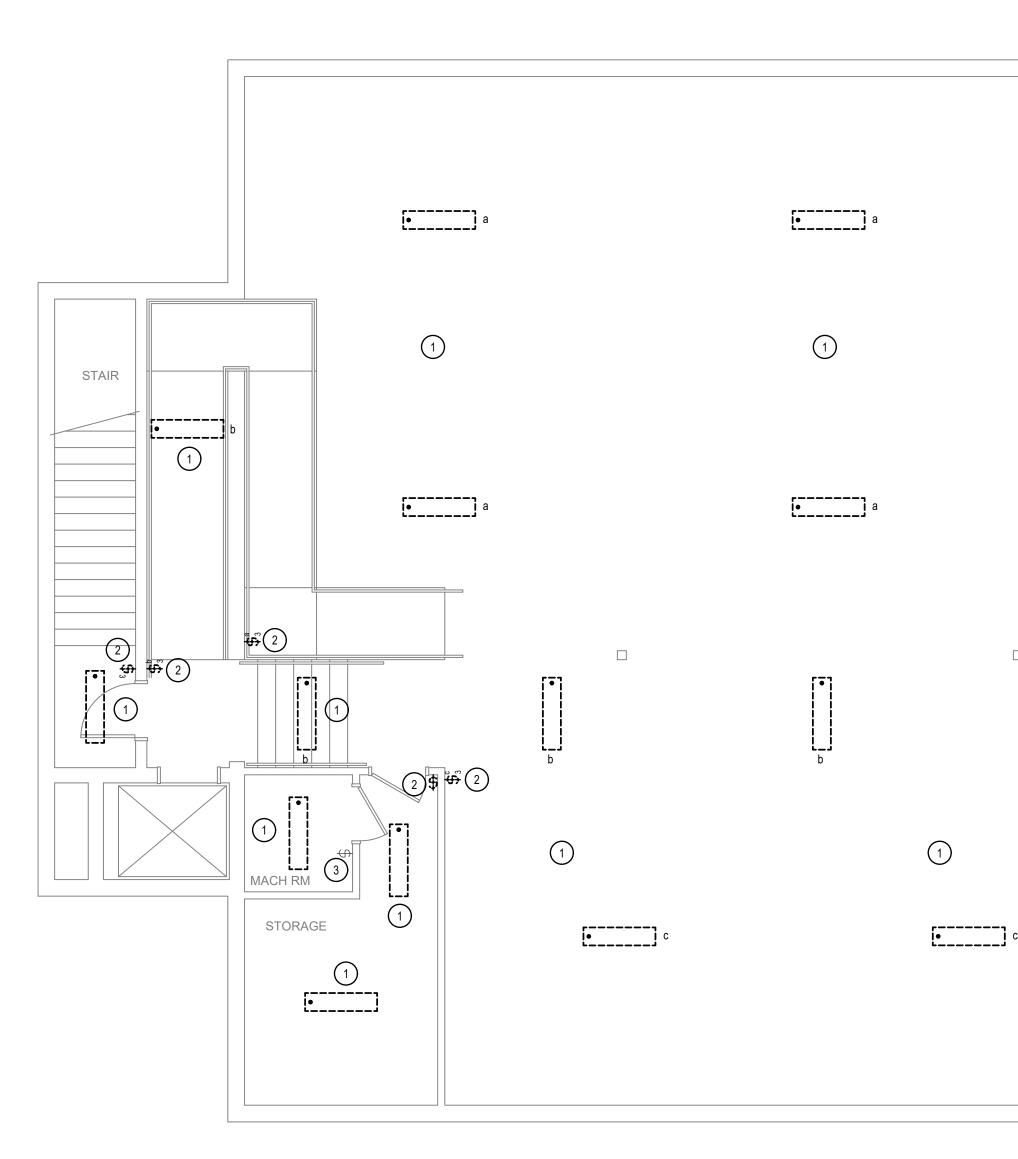

SCALE: 3/16" = 1'-0"

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GENERAL DEMOLITION NOTES:


- 1. UNLESS SPECIFICALLY NOTED OTHERWISE, REMOVE ALL ELECTRICAL ITEMS SHOWN IN DARK & DASHED LINES. LIGHT & SOLID ITEMS ARE TO REMAIN. DEMOLITION ITEMS ARE SHOWN TO GIVE A BASIC DESCRIPTION OF THE EXTENT OF DEMOLITION WORK, BUT MAY NOT BE INCLUSIVE. PROVIDE DEMOLITION WORK IN ACCORDANCE WITH THE FOLLOWING REQUIREMENTS:
- 1.1. DISCONNECT AND REMOVE ANY/ALL FIXTURES, DEVICES, EQUIPMENT, ETC. REQUIRED FOR PROPER COMPLETION OF THE WORK WHETHER SHOWN OR NOT.
- 1.2. RELOCATE, REWIRE, AND/OR RECONNECT ANY/ALL FIXTURES, DEVICES, EQUIPMENT, ETC. THAT FOR ANY REASON OBSTRUCTS CONSTRUCTION.
- LEAVE ALL EXISTING FIXTURES, DEVICES, EQUIPMENT, ETC. IN 1.3. PORTIONS OF THE BUILDING NOT BEING REMODELED, IN WORKING CONDITION. RESTORE ALL INTERRUPTED BRANCH CIRCUITS, FEEDERS, ETC.


1.4.


1.5.

- REMOVE AND DISPOSE OF ALL RACEWAYS, CONDUCTORS, BOXES, DEVICES, EQUIPMENT, ETC. THAT ARE NOT TO BE REUSED. TERMINATE AT ACCESSIBLE JUNCTION BOX BY PROVIDING PROPER KNOCK-OUT CLOSURE, TAPE CONDUCTORS, LABEL AS "SPARE" WITH CIRCUIT NO., ZONE NO, OR OTHER CHARACTERISTIC IDENTIFYING SOURCE.
- EXISTING RACEWAYS MAY BE REUSED, IF IN PLACE, WHERE POSSIBLE, AND WHERE IN COMPLIANCE WITH THE SPECIFICATIONS AND THE INTENT OF THE CONTRACT DOCUMENTS. UPGRADE AND OR PROVIDE NEW CONDUIT SUPPORTS WHERE NECESSARY FOR ALL RACEWAYS BEING REUSED. ENSURE INTEGRITY OF EXISTING RACEWAYS BEFORE REUSE.
- 1.6. CONCEAL ALL RACEWAY AND WIRING IN EXISTING WALLS, CEILINGS, FLOORS, ETC. THE USE OF WIREMOLD IS PERMITTED ONLY WHERE SPECIFICALLY NOTED ON DRAWING.
- 1.7. DO NOT PENETRATE STRUCTURAL ELEMENTS OF FLOORS, WALLS, CEILINGS, ROOFS, ETC. 1.8.
 - COORDINATE WITH OWNER WHAT EQUIPMENT SHOULD BE DISPOSED OF AND WHAT EQUIPMENT IS TO BE RETURNED TO OWNER.


LOWER LEVEL LIGHTING DEMOLITION PLAN

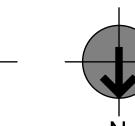

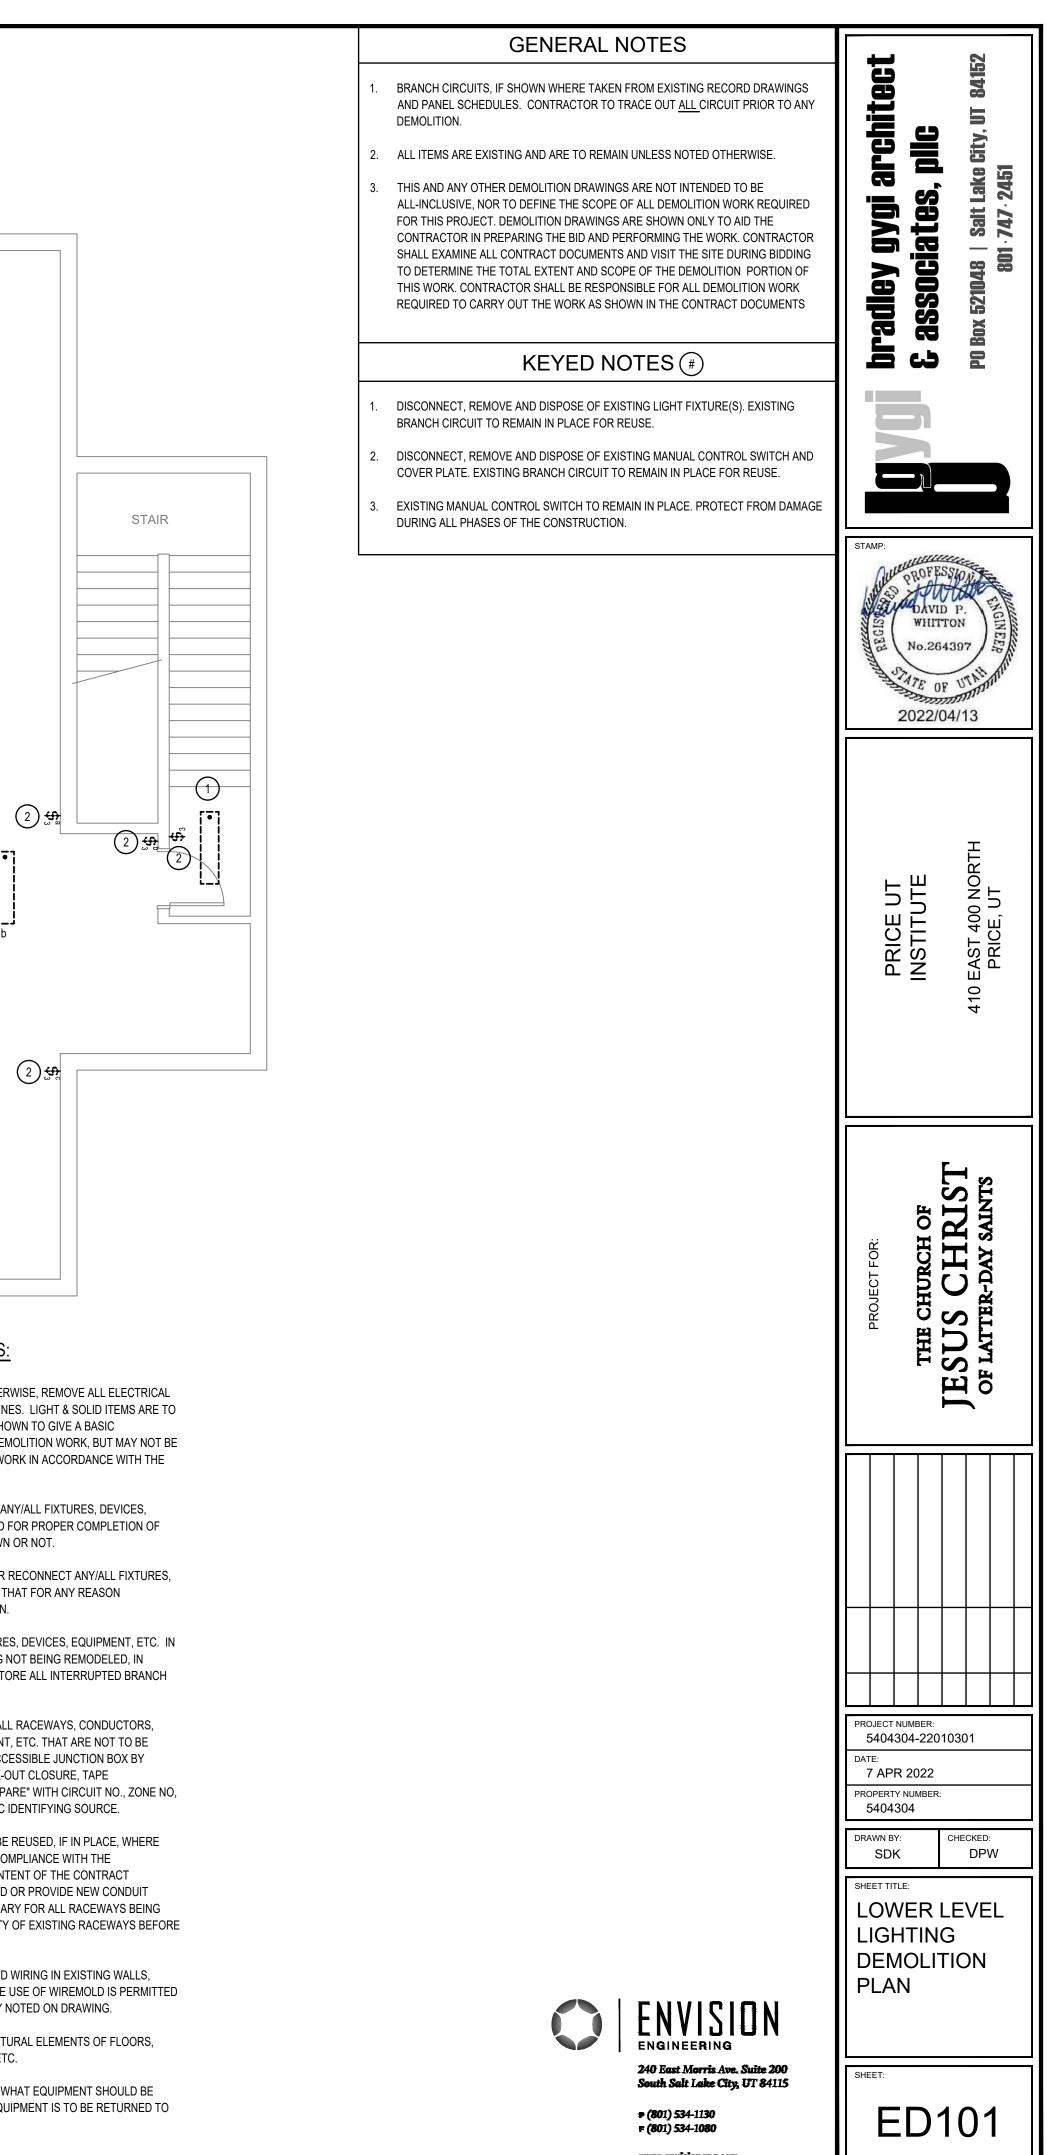


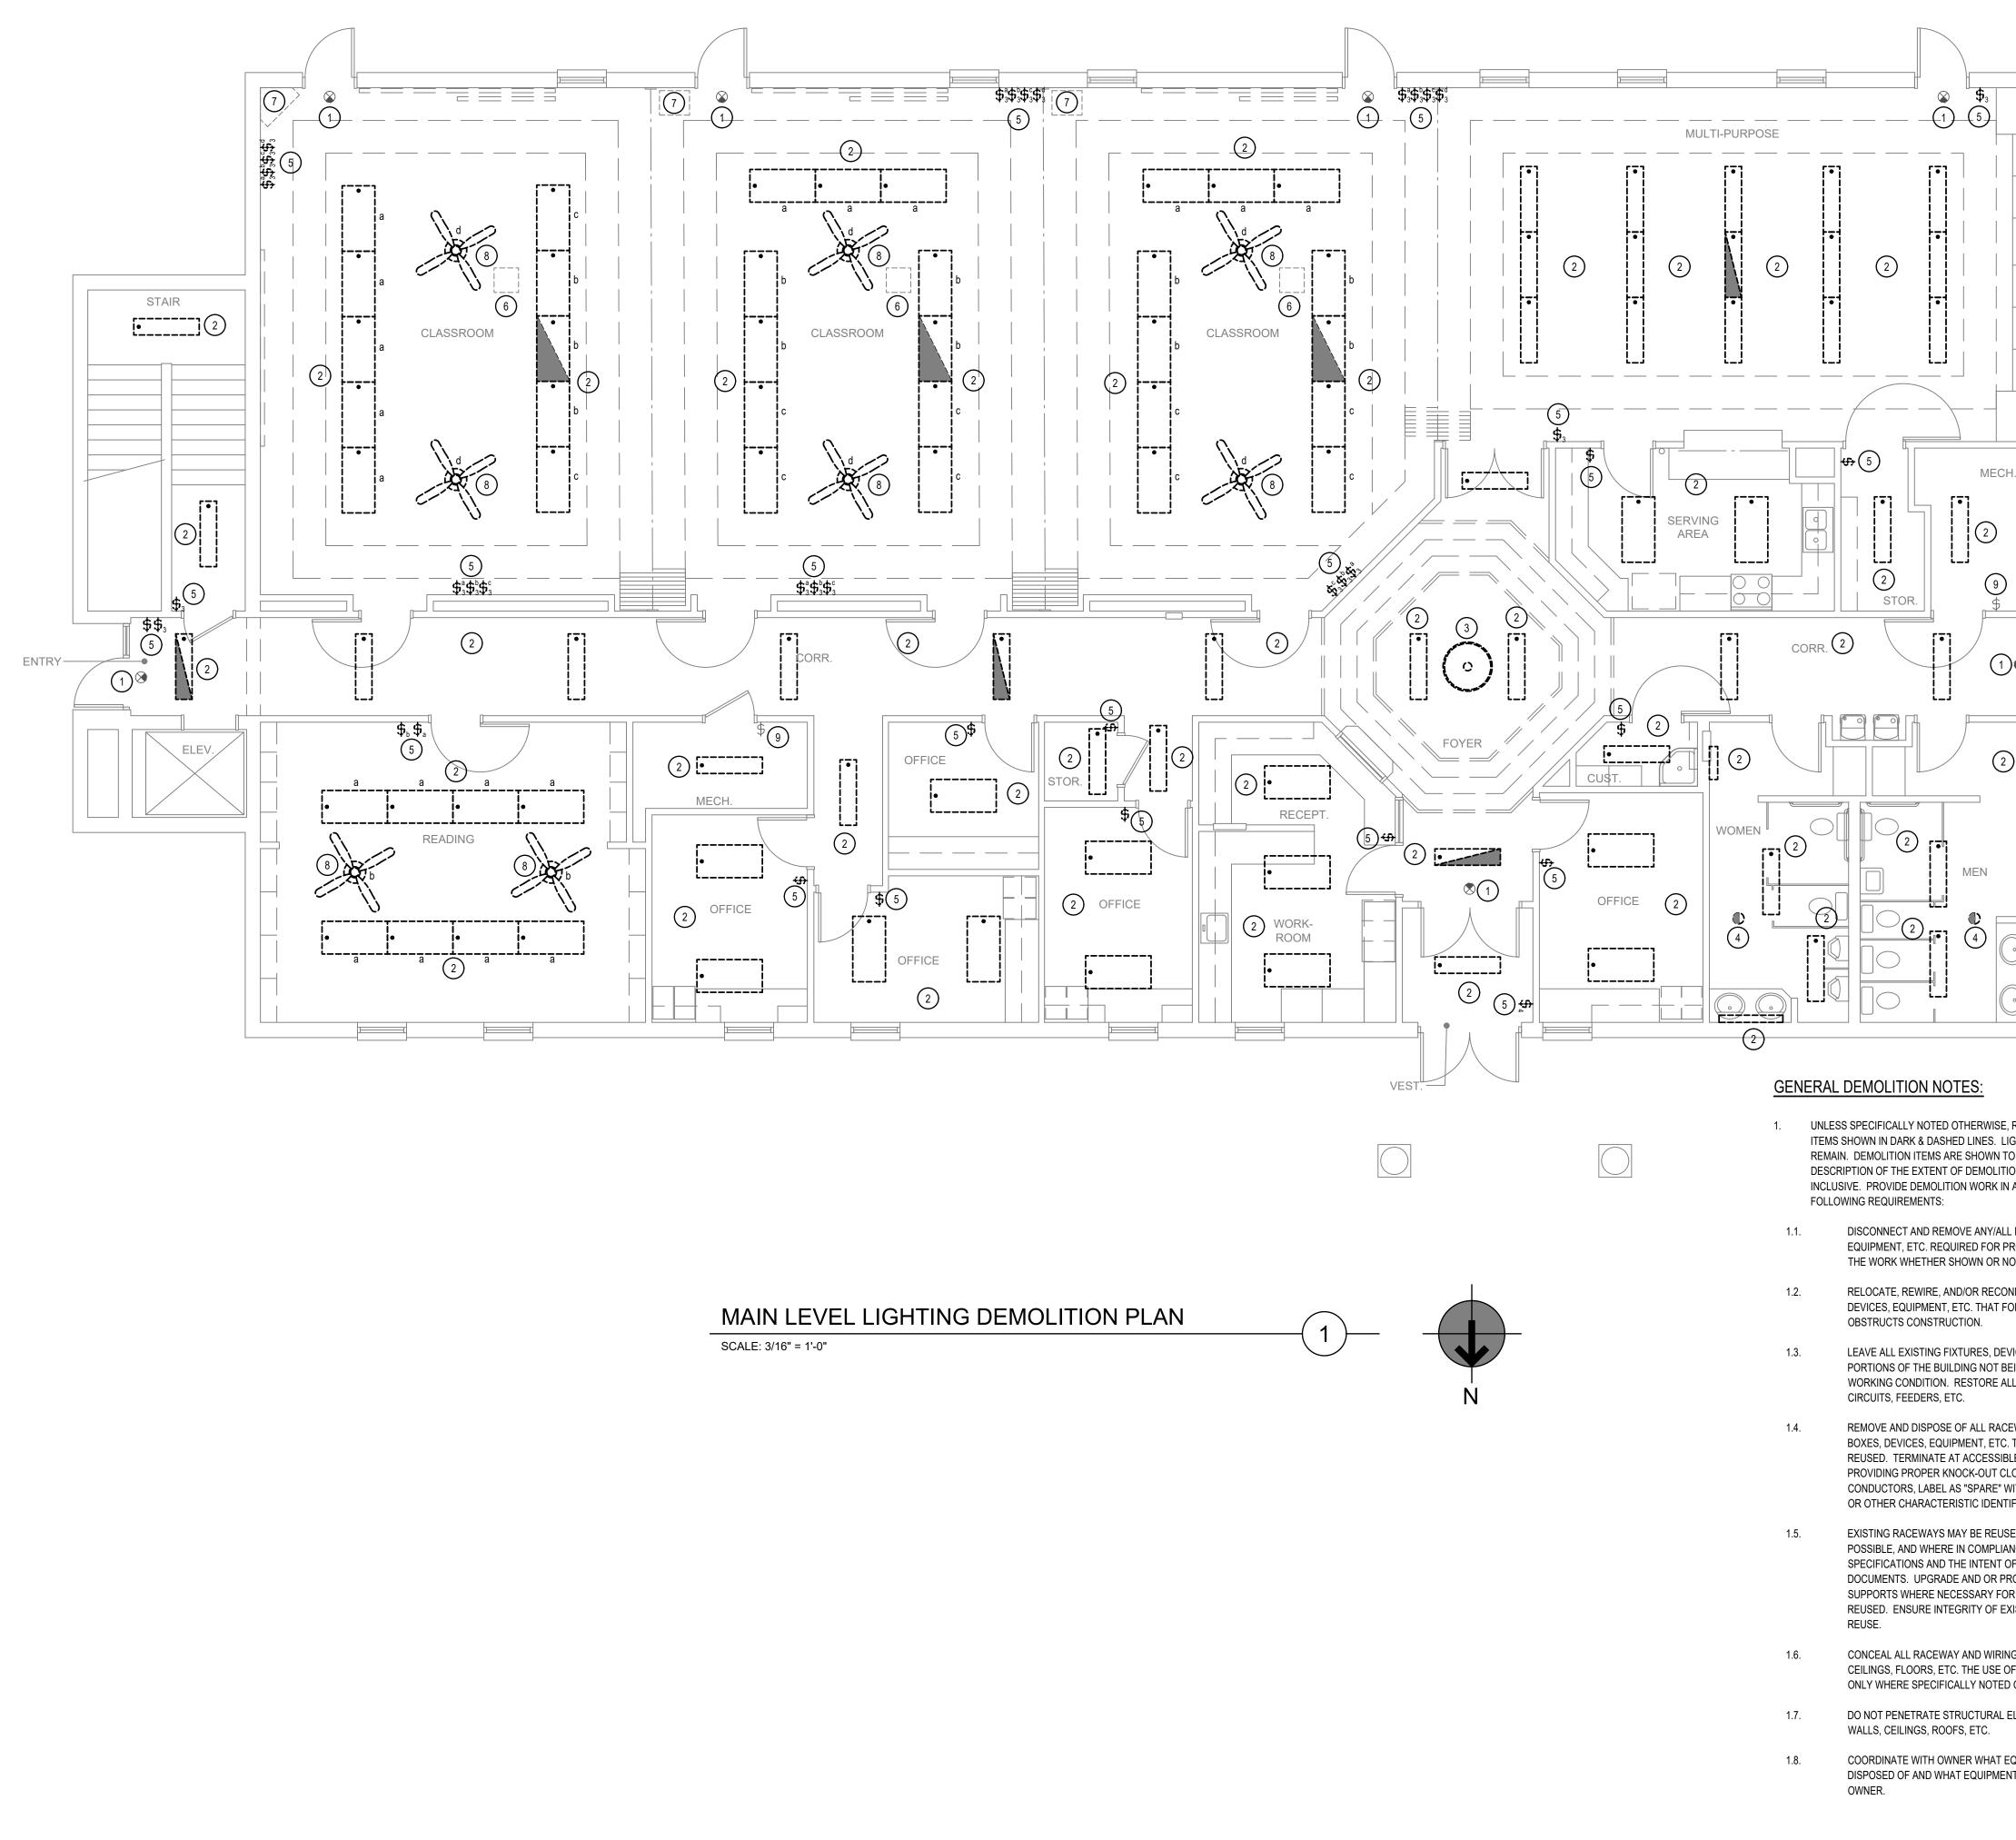

	GENERAL NOTES	it
	 BRANCH CIRCUITS, IF SHOWN WHERE TAKEN FROM EXISTING RECORD DRAWINGS AND PANEL SCHEDULES. CONTRACTOR TO TRACE OUT <u>ALL</u> CIRCUIT PRIOR TO ANY DEMOLITION. 	itect UT 84152
	2. ALL ITEMS ARE EXISTING AND ARE TO REMAIN UNLESS NOTED OTHERWISE.	arch , pllc ike City, 451
	3. THIS AND ANY OTHER DEMOLITION DRAWINGS ARE NOT INTENDED TO BE ALL-INCLUSIVE, NOR TO DEFINE THE SCOPE OF ALL DEMOLITION WORK REQUIRED FOR THIS PROJECT. DEMOLITION DRAWINGS ARE SHOWN ONLY TO AID THE	gygi archi l ates, pllc Salt Lake City, UT 1 · 747 · 2451
	CONTRACTOR IN PREPARING THE BID AND PERFORMING THE WORK. CONTRACTOR SHALL EXAMINE ALL CONTRACT DOCUMENTS AND VISIT THE SITE DURING BIDDING TO DETERMINE THE TOTAL EXTENT AND SCOPE OF THE DEMOLITION PORTION OF THIS WORK. CONTRACTOR SHALL BE RESPONSIBLE FOR ALL DEMOLITION WORK	
	THIS WORK. CONTRACTOR SHALL BE RESPONSIBLE FOR ALL DEMOLITION WORK REQUIRED TO CARRY OUT THE WORK AS SHOWN IN THE CONTRACT DOCUMENTS	bradley gygi E associates Po Box 521048 Salt La 801 · 747 · 2
	KEYED NOTES (#)	bra 6 a: Po Box
	1. EXISTING EXIT SIGN TO REMAIN IN PLACE. PROTECT FROM DAMAGE DURING ALL PHASES OF THE CONSTRUCTION.	
	2. DISCONNECT, REMOVE AND DISPOSE OF EXISTING LIGHT FIXTURE(S). EXISTING BRANCH CIRCUIT TO REMAIN IN PLACE FOR REUSE.	
[•] ②	3. DISCONNECT, REMOVE AND DISPOSE OF OR RETURN EXISTING PENDANT LIGHT FIXTURE TO THE OWNER, CONFIRM PRIOR TO REMOVAL. EXISTING BRANCH CIRCUIT TO REMAIN IN PLACE FOR REUSE.	STAMP:
STAIR	4. DISCONNECT, REMOVE AND DISPOSE OF EXISTING CEILING MOUNTED OCCUPANCY SENSOR. EXISTING BRANCH CIRCUIT TO REMAIN IN PLACE FOR REUSE.	AU PROFESSION
	5. DISCONNECT, REMOVE AND DISPOSE OF EXISTING MANUAL CONTROL SWITCH AND COVER PLATE. EXISTING BRANCH CIRCUIT TO REMAIN IN PLACE FOR REUSE.	No.264397
	 SEE ARCHITECTURAL DRAWINGS FOR PROJECTOR REQUIREMENTS. SEE ARCHITECTURAL DRAWINGS FOR PODIUM / AV CABINET REQUIREMENTS. 	STATE OF UTAL
	 SEE ARCHITECTORAL DRAWINGSTOR FOLIOW / AV CABINET REQUIREMENTS. BISCONNECT, REMOVE AND DISPOSE OF EXISTING CEILING FAN. EXISTING BRANCH CIRCUIT TO REMAIN IN PLACE FOR REUSE. 	2022/04/13
	9. EXISTING MANUAL CONTROL SWITCH TO REMAIN IN PLACE. PROTECT FROM DAMAGE DURING ALL PHASES OF THE CONSTRUCTION.	
		RTH
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		FOR: CCH OF HRIS AY SAINT
		ECT FOR CH CH
		THE CHURCI SUS CH LATTER-DAY
REMOVE ALL ELECTRICAL		THE CF JESUS OF LATTER
GHT & SOLID ITEMS ARE TO O GIVE A BASIC ON WORK, BUT MAY NOT BE ACCORDANCE WITH THE		
_ FIXTURES, DEVICES,		
ROPER COMPLETION OF OT.		
NNECT ANY/ALL FIXTURES, OR ANY REASON		
/ICES, EQUIPMENT, ETC. IN EING REMODELED, IN		
LL INTERRUPTED BRANCH		PROJECT NUMBER:
EWAYS, CONDUCTORS, THAT ARE NOT TO BE LE JUNCTION BOX BY .OSURE, TAPE		5404304-22010301 DATE: 7 APR 2022
VITH CIRCUIT NO., ZONE NO, IFYING SOURCE.		PROPERTY NUMBER: 5404304
ED, IF IN PLACE, WHERE NCE WITH THE)F THE CONTRACT		DRAWN BY: CHECKED: SDK DPW
ROVIDE NEW CONDUIT R ALL RACEWAYS BEING KISTING RACEWAYS BEFORE		SHEET TITLE: MAIN LEVEL LIGHTING
IG IN EXISTING WALLS,		DEMOLITION
OF WIREMOLD IS PERMITTED ON DRAWING. ELEMENTS OF FLOORS,		
QUIPMENT SHOULD BE	ENGINEERING 240 East Morris Ave. Suite 200 South Salt Lake City, UT 84115	SHEET:
IT IS TO BE RETURNED TO		ED102

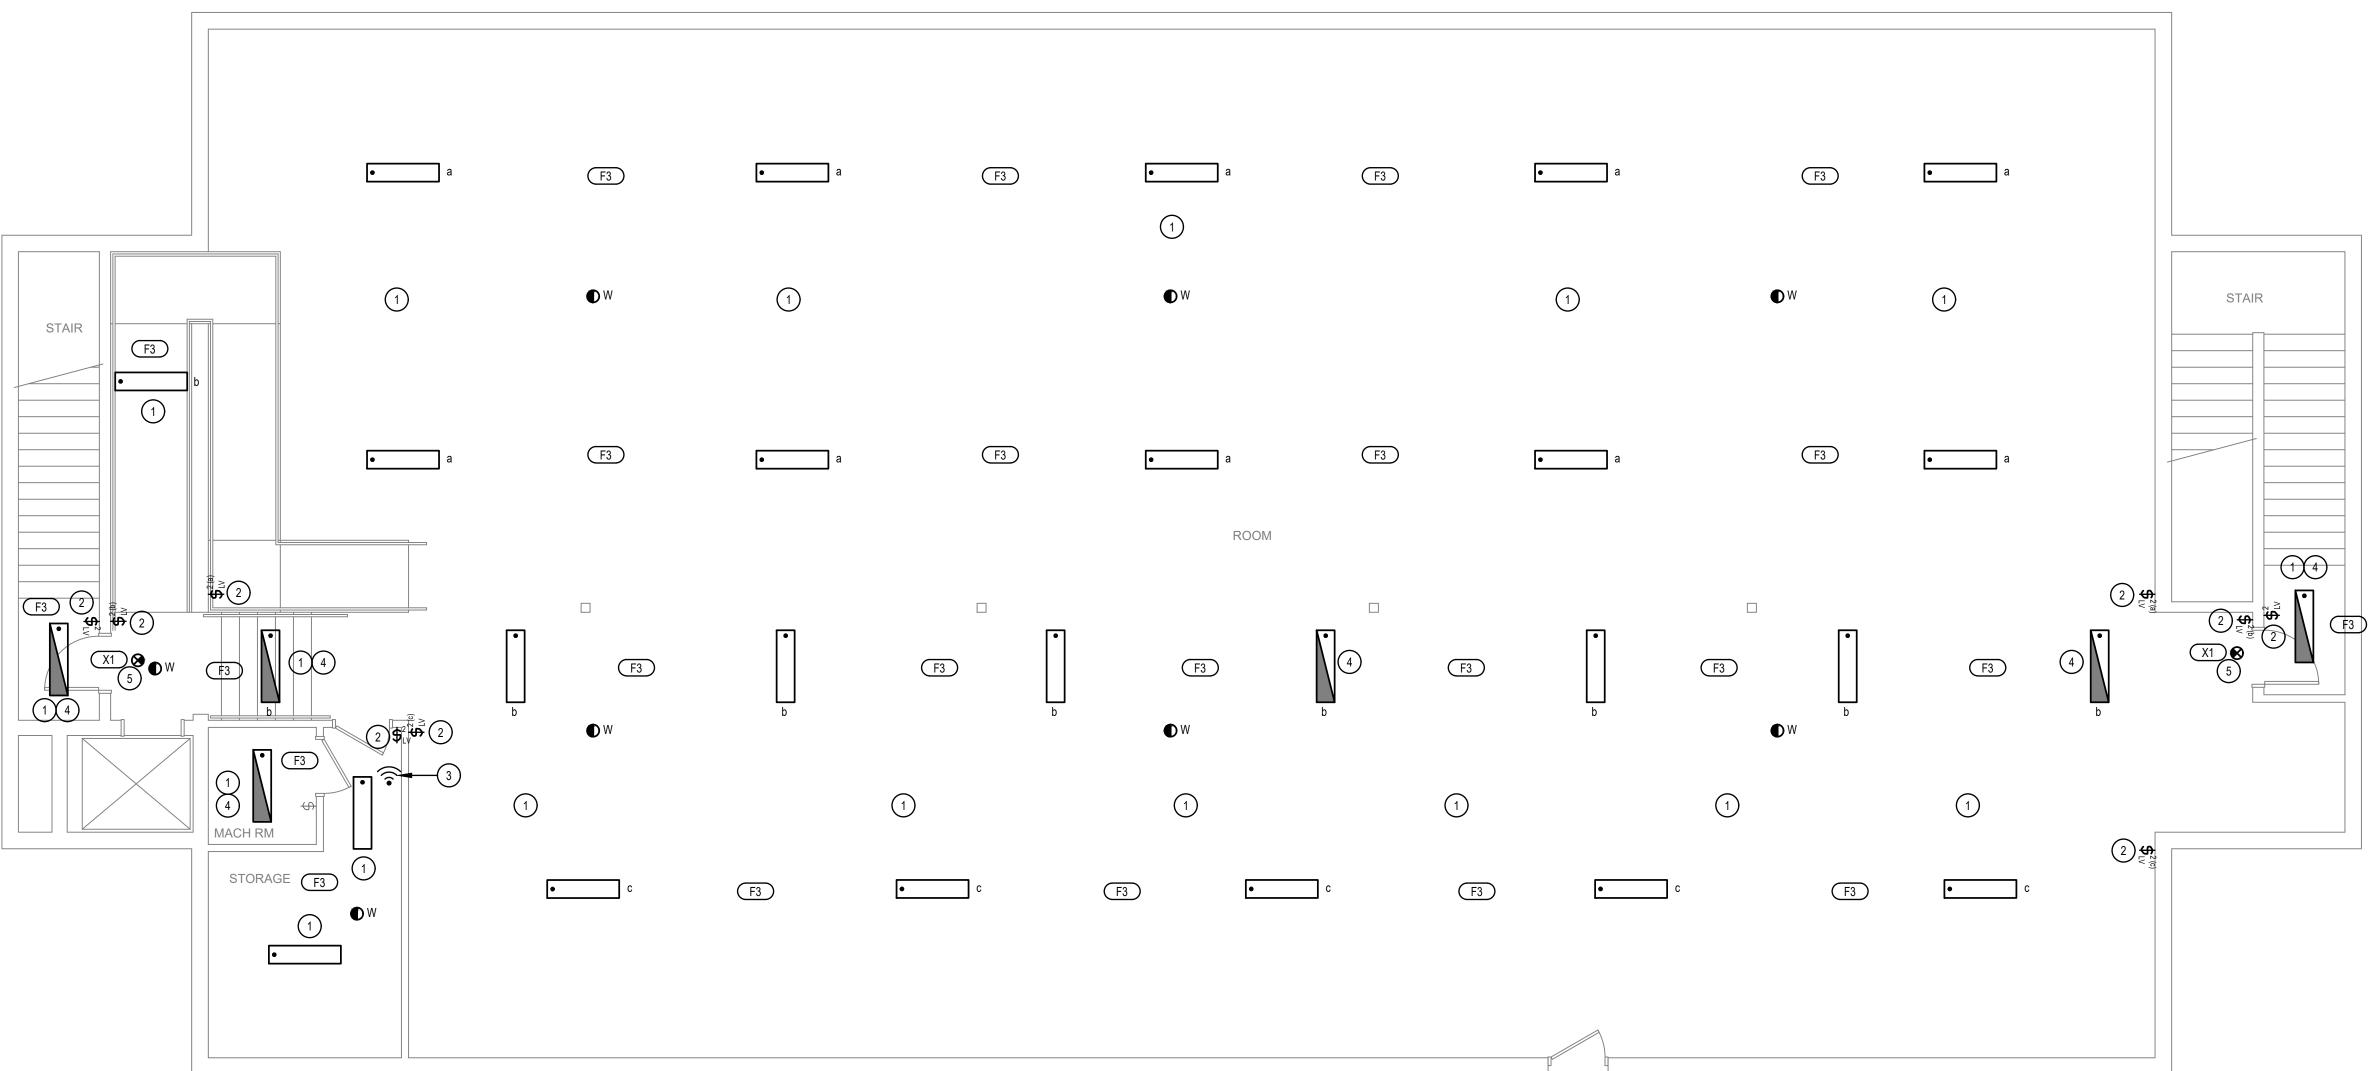

LOWER LEVEL LIGHTING PLAN SCALE: 3/16" = 1'-0"

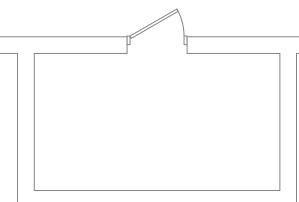

GENERAL NOTES <u>TYPICAL ALL AREAS:</u> REMOVE, SALVAGE AND REINSTALL ALL ELECTRICAL WIRING DEVICES, FIRE ALARM DEVICES, EXIT SIGNS, THERMOSTATS, AND MAGNETIC HOLD OPEN DEVICES, AND OTHER WALL-MOUNTED WORK AS REQUIRED TO ACCOMMODATE NEW WALL FINISH WORK. SEE ARCHITECTURAL DRAWINGS FOR ADDITIONAL INFORMATION AND REQUIREMENTS. REFER TO LIGHTING CONTROL SHEETS FOR TYPICAL CONTROL WIRING DIAGRAMS. PROVIDE COMPLETE SYSTEM WITH ALL REQUIRED CONDUIT, WIRING, SWITCHES, SENSORS, POWER PACK, ETC. LOCATE POWER PACKS AND ROOM CONTROLLERS ABOVE CEILING NEAR ROOM ENTRANCES. MARK EXACT LOCATION ON THE RED LINE AS-BUILT DRAWINGS. KEYED NOTES (#) INSTALL NEW LIGHT FIXTURE IN EXISTING LIGHT FIXTURE LOCATION. RECONNECT TO EXISTING BRANCH CIRCUIT THAT WAS IN PLACE PRIOR TO THE DEMOLITION. INSTALL NEW LIGHTING CONTROLS AS SHOWN. NEW COVER PLATE TO BE IN COLOR

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bradley gygi al & associates, j

DAVID WHITTON

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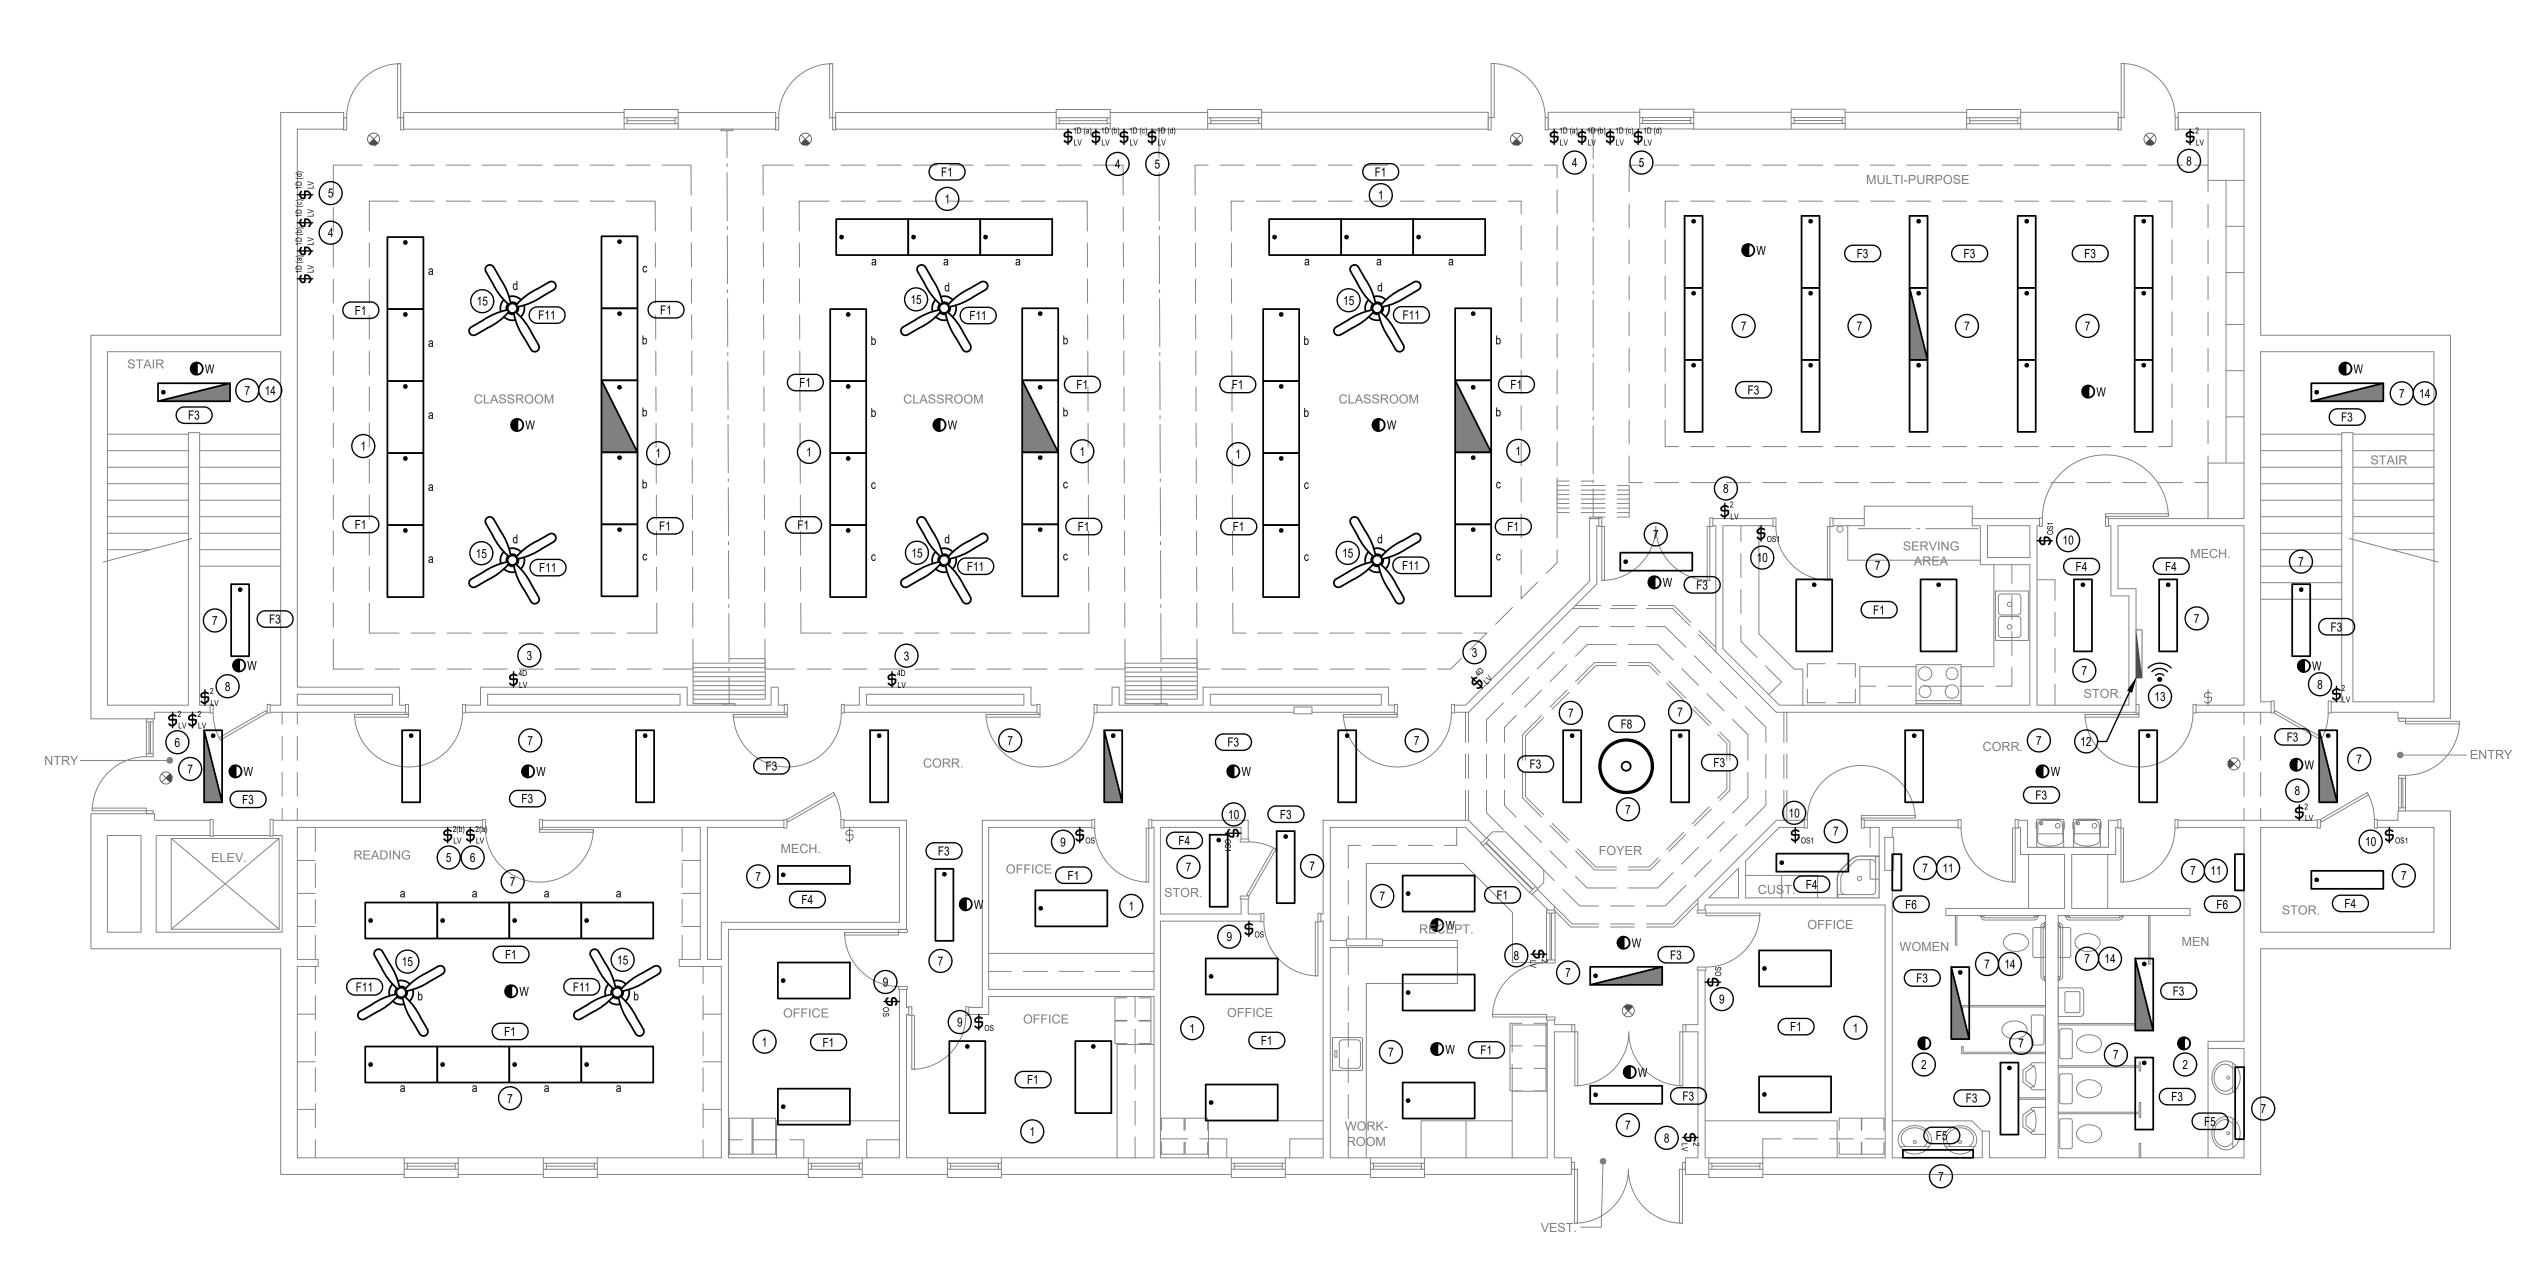
- AS DIRECTED BY THE ARCHITECT. RECONNECT TO THE EXISTING BRANCH CIRCUIT AS DIRECTED BY THE LIGHTING CONTROL SYSTEM SUPPLIER. CONTRACTOR TO PROVIDE ALL ADDITIONAL DIMMING CONDUCTORS AND CONNECTIONS TO THE ROOM CONTROLLER AS NECESSARY FOR A COMPLETE AND OPERATIONAL SYSTEM.
- WIRELESS AREA CONTROLLER. MOUNT IN LOCATION AS DIRECTED BY THE LIGHTING CONTROLS SYSTEM SUPPLIER. IF NO RECEPTACLE IS AVAILABLE, PROVIDE A 120V RECEPTACLE AT THE CONTROLLER LOCATION. CONNECT RECEPTACLE TO NEAREST CONVENIENCE OUTLET CIRCUIT.
- PROVIDE EMERGENCY BATTERY PACK IN THIS FIXTURE. CONNECT TO UNSWITCHED HOT CONDUCTOR ON EXISTING LIGHTING CIRCUIT.
- CONNECT NEW EXIT SIGN TO UNSWITCHED HOT CONDUCTOR ON EXISTING LIGHTING CIRCUIT.

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BRAWN BY: SDK CHECKED: SDK CHECKED: DPW SHEET TITLE: LOWER LEVEL LIGHTING PLAN
5404304-22010301 DATE: 7 APR 2022 PROPERTY NUMBER: 5404304 DRAWN BY: CHECKED: SDK DPW SHEET TITLE: LOWER LEVEL LIGHTING PLAN
SDK DPW SHEET TITLE: LOWER LEVEL LIGHTING PLAN
EL101



240 East Morris Ave. Suite 200 South Salt Lake City, UT 84115

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MAIN LEVEL LIGHTING PLAN SCALE: 3/16" = 1'-0"

 \bigcirc

- **GENERAL NOTES**
- TYPICAL ALL AREAS: REMOVE, SALVAGE AND REINSTALL ALL ELECTRICAL WIRING DEVICES, FIRE ALARM DEVICES, EXIT SIGNS, THERMOSTATS, AND MAGNETIC HOLD OPEN DEVICES, AND OTHER WALL-MOUNTED WORK AS REQUIRED TO ACCOMMODATE NEW WALL FINISH WORK. SEE ARCHITECTURAL DRAWINGS FOR ADDITIONAL INFORMATION AND REQUIREMENTS.
- REFER TO LIGHTING CONTROL SHEETS FOR TYPICAL CONTROL WIRING DIAGRAMS PROVIDE COMPLETE SYSTEM WITH ALL REQUIRED CONDUIT, WIRING, SWITCHES, SENSORS, POWER PACK, ETC.
- LOCATE POWER PACKS AND ROOM CONTROLLERS ABOVE CEILING NEAR ROOM ENTRANCES. MARK EXACT LOCATION ON THE RED LINE AS-BUILT DRAWINGS.

KEYED NOTES (#)

- INSTALL NEW LIGHT FIXTURE(S) IN EXISTING LIGHT FIXTURE LOCATION. RECONNE TO EXISTING BRANCH CIRCUIT THAT WAS IN PLACE PRIOR TO THE DEMOLITION. CONTRACTOR TO PROVIDE ALL REQUIRED DIMMING CONDUCTORS FROM THE LIG FIXTURE(S), ROOM CONTROLS, AND WALL SWITCHES AS NECESSARY FOR A COMPLETE AND OPERATIONAL SYSTEM. SEE EL601 FOR ADDITIONAL INFORMATIO
- INSTALL NEW LINE VOLTAGE CEILING MOUNTED OCCUPANCY SENSOR IN EXISTING SENSOR LOCATION. RECONNECT TO EXISTING BRANCH CIRCUIT THAT WAS IN PLA PRIOR TO THE DEMOLITION. CONTRACTOR TO PROVIDE ALL REQUIRED CONDUCTORS AND CONNECTIONS FROM THE LIGHT FIXTURES, ROOM CONTROLS AND WALL SWITCHES AS NECESSARY FOR A COMPLETE AND OPERATIONAL SYST SEE EL601 FOR ADDITIONAL INFORMATION.
- INSTALL NEW LIGHTING CONTROLS AS SHOWN. PROVIDE NEW 3-GANG DECORA PLATE, IN COLOR AS DIRECTED BY THE ARCHITECT. PROVIDE BLANK PLUGS IN TH EMPTY SPACES OF THE NEW COVER PLATE. PLUGS TO BE THE SAME COLOR AS T EXISTING COVER PLATE. RECONNECT TO THE EXISTING BRANCH CIRCUIT AS DIRECTED BY THE LIGHTING CONTROL SYSTEM SUPPLIER. CONTRACTOR TO PROVIDE ALL ADDITIONAL DIMMING CONDUCTORS AND CONNECTIONS TO THE RO CONTROLLER AS NECESSARY FOR A COMPLETE AND OPERATIONAL SYSTEM.
- INSTALL NEW LIGHTING CONTROLS AS SHOWN. PROVIDE NEW 4-GANG DECORA PLATE, IN COLOR AS DIRECTED BY THE ARCHITECT. RECONNECT TO THE EXISTIN BRANCH CIRCUIT AS DIRECTED BY THE LIGHTING CONTROL SYSTEM SUPPLIER. CONTRACTOR TO PROVIDE ALL ADDITIONAL DIMMING CONDUCTORS AND CONNECTIONS TO THE ROOM CONTROLLER AS NECESSARY FOR A COMPLETE AN OPERATIONAL SYSTEM.
- CONTRACTOR TO CONFIRM WITH THE LIGHTING CONTROL SYSTEM SUPPLIER THA THE LIGHTING CONTROLS AS SHOWN FOR THE FAN WILL OPERATE THE FAN CORRECTLY (SPEED ADJUSTMENT) PRIOR TO ORDERING THE LIGHTING CONTROL SYSTEM.
- INSTALL NEW LIGHTING CONTROLS AS SHOWN. PROVIDE NEW 2-GANG DECORA PLATE, IN COLOR AS DIRECTED BY THE ARCHITECT. RECONNECT TO THE EXISTIN BRANCH CIRCUIT AS DIRECTED BY THE LIGHTING CONTROL SYSTEM SUPPLIER.
- INSTALL NEW LIGHT FIXTURE IN EXISTING LIGHT FIXTURE LOCATION. RECONNECT EXISTING BRANCH CIRCUIT THAT WAS IN PLACE PRIOR TO THE DEMOLITION.
- INSTALL NEW MANUAL CONTROL SWITCH IN THE EXISTING LOCATION. RECONNEC TO THE EXISTING BRANCH CIRCUIT THAT WAS IN PLACE PRIOR TO THE DEMOLITIO LIGHTING TO FUNCTION THE SAME AS PRIOR TO THE DEMOLITION.
- INSTALL NEW LINE VOLTAGE WALL OCCUPANCY SENSOR IN THE EXISTING LOCATI RECONNECT TO THE EXISTING BRANCH CIRCUIT THAT WAS IN PLACE PRIOR TO T DEMOLITION. CONTRACTOR TO PROVIDE ALL REQUIRED DIMMING CONDUCTORS FROM THE SENSOR TO THE LIGHT FIXTURES AS NECESSARY FOR A COMPLETE AN OPERATIONAL SYSTEM.
- 0. INSTALL NEW LINE VOLTAGE WALL OCCUPANCY SENSOR IN THE EXISTING LOCATI RECONNECT TO THE EXISTING BRANCH CIRCUIT THAT WAS IN PLACE PRIOR TO TH DEMOLITION.
- 11. DO NOT SWITCH LIGHT FIXTURE. LIGHT FIXTURE TO OPERATE 24 HOURS.
- 12. EXISTING NETWORK AND COMMUNICATIONS DEMARK.
- 13. WIRELESS AREA CONTROLLER. MOUNT IN LOCATION AS DIRECTED BY THE LIGHTI CONTROLS SYSTEM SUPPLIER. IF NO RECEPTACLE IS AVAILABLE, PROVIDE A 120V RECEPTACLE AT THE CONTROLLER LOCATION. CONNECT RECEPTACLE TO NEARE CONVENIENCE OUTLET CIRCUIT.
- 4. PROVIDE EMERGENCY BATTERY PACK IN THIS FIXTURE. CONNECT TO UNSWITCHE HOT CONDUCTOR ON EXISTING LIGHTING CIRCUIT.
- 5. INSTALL NEW CEILING FAN IN EXISTING CEILING FAN LOCATION. RECONNECT TO EXISTING BRANCH CIRCUIT THAT WAS IN PLACE PRIOR TO THE DEMOLITION. CONFIRM ALL CONTROL REQUIREMENTS WITH THE LIGHTING CONTROL SYSTEM SUPPLIER.

ENVISION

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240 East Morris Ave. Suite 200 South Salt Lake City, UT 84115

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ND ION. HE ING ZST ED	PROJECT FOR: THE CHURCH OF JESUS CHRIST OF LATTER-DAY SAINTS
	PROJECT NUMBER: 5404304-22010301 DATE: 7 APR 2022 PROPERTY NUMBER: 5404304 DRAWN BY: CHECKED: DFW SHEET TITLE: MAIN LEVEL IGHTING PLAN
	EL102

	LIGHTING CONTROL SCHEDULE						
DEVICE	MOUNTING	DISCRIPTION					
	CEILING	WAVELINX - OAC-DT-2000-R. LINE VOLTAGE OCCUPANCY SENSOR					
●w	CEILING	WAVELINX - CWOD-1500. WIRELESS OCCUPANCY SENSOR					
\$ _{os}	WALL	GREENGATE- OSW-D-010-SCBA. LINE VOLTAGE OCCUPANCY SENSOR WITH RAISE/LOWER & ON/OFF.					
\$ _{0S1}	WALL	GREENGATE - OSW-P-0501-SCBA. LINE VOLTAGE OCCUPANCY SENSOR WITH ON/OFF.					
\$ ^{1D} _{LV}	WALL	WAVELINX - W1L-RL-SCBA. LINE VOLTAGE ONE BUTTON STATION, RAISE/LOWER & ON/OFF.					
\$ ² _{LV}	WALL	WAVELINX - W2L-SCBA. LINE VOLTAGE TWO BUTTON STATION, ON/OFF.					
\$ ^{4D} _{LV}	WALL	WAVELINX - W4S-RL-SCBA. LINE VOLTAGE FOUR BUTTON STATION, RAISE/LOWER & ON/OFF.					
((r	AS SHOWN	WAVELINX - WAC-POE / WPOE-120. WIRELESS AREA CONTROLLER AND POE INJECTOR.					
	ABOVE CEILING	WAVELINX - WSP-CA-010. LINE VOLTAGE SENSOR INPUT PACK. QUANTITY TO BE DETERMINED BY LIGHTING CONTROL SUPPLIER.					
	ABOVE CEILING	WAVELINX - WSP-UV-010. LINE VOLTAGE RELAY SWITCH PACK. QUANTITY TO BE DETERMINED BY LIGHTING CONTROL SUPPLIER.					
	AT NETWORK DEMARK	TRELLIX- TRX-TCPR02. TRELLIX CORE PRO.					

LIGHTING CONTROL GENERAL NOTES:

- PROVIDE ALL PROGRAMMING AS NECESSARY FOR THE LIGHTING CONTROL SYSTEM TO FUNCTION APPROPRIATELY, SEE LIGHTING CONTROL PROGRAMMING. PROVIDE TRAINING TO THE OWNERS FACILITIES MANAGER, SEE LIGHTING CONTROL SYSTEM REQUIREMENTS.
- PROVIDE AN OWNERS MANUAL THAT INCLUDES ALL CATALOG NUMBERS, CUTSHEETS AND AS-BUILT DRAWINGS FOR THE EQUIPMENT INSTALLED IN DIGITAL AND HARDCOPY FORM. PROVIDE ONE HARDCOPY. AS-BUILT DRAWINGS TO INDICATE EXACT LOCATION OF ALL WIRELESS AREA CONTROLLER, TRELLIX CORE, ROOM CONTROLLERS, POWER PACKS AND ANY EQUIPMENT LOCATED ABOVE THE CEILINGS.
- THE CONTRACTOR SHALL BE RESPONSIBLE FOR APPLYING FOR ANY AND ALL UTILITY INCENTIVES 3. AVAILABLE. THIS INCLUDES PROVIDING ALL DOCUMENTATION, FIXTURE COUNTS, INVOICES, BILL OF MATERIALS, ETC NECESSARY FOR THE OWNER TO CAPTURE THOSE INCENTIVES. CONFIRM ALL REQUIREMENTS WITH THE LOCAL UTILITY COMPANY PRIOR TO ANY WORK BEING DONE. CONTACT LOGAN TAGGART - 801.814.4394, LOGAN.TAGGART@EVERGREEN-EFFICIENCY.COM TO SCHEDULE ALL PRE-CONSTRUCTION VISITS AND VERIFY ALL INCENTIVE REQUIREMENTS AND REQUIRED DOCUMENTATION.
- THE OWNER HAS NATIONAL ACCOUNT CONTRACTS FOR THE LIGHTING CONTROLS LISTED IN THE LIGHTING CONTROL SCHEDULE AND SHOWN ON THE DRAWINGS. PLEASE CONTACT GARRET LEDGER WITH QUANTUM LIGHTING (801) 440.7415 OR gtledger@quantumltg.com FOR PRICING AND ORDERING.

OCCUPANCY SENSOR NOTES:

- 1. THE OCCUPANCY SENSOR SUPPLIER SHALL INSURE THAT THE SENSOR THAT IS FURNISHED IS ADEQUATELY SIZED FOR AREA SERVED.
- 2. THE CONTRACTOR SHALL VERIFY ALL MOUNTING REQUIREMENTS AND LOCATIONS WITH THE OCCUPANCY SENSOR SUPPLIER AND MANUFACTURES WRITTEN INSTRUCTIONS PRIOR TO ROUGH-IN.
- 3. SET ALL OCCUPANCY SENSORS FOR A MAXIMUM OF 30 MINUTES TO TURN OFF LIGHTS. UNLESS OTHERWISE DIRECTED BY THE TENANT.
- 4. DO NOT MOUNT ANY OCCUPANCY SENSORS WITH IN 3' OF ANY AIR DIFFUSERS. COORDINATE WITH MECHANICAL FOR DIFFUSER LOCATIONS.
- 5. IF OCCUPANCY SENSOR IS MOUNTED IN THE WRONG LOCATION OR IS NOT ADEQUATE FOR THE AREA. THE SUPPLIER AND CONTRACTOR SHALL REPLACE THE SENSOR OR RELOCATE THE SENSOR AT NO EXTRA CHARGE.

LIGHTING CONTROL PROGRAMMING:

CLASSROOM:

4-BUTTON STATION: BUTTON #1 (HALF LIGHTS) - TURN OFF ZONE a DIM ALL LIGHTS IN THE SPACE TO 50%. BUTTON #2 (FULL LIGHTS) - ALL LIGHTS TO 100%. BUTTON #3 (READ) - ALL LIGHTS TO 80%. BUTTON #4 (RELAX) - ALL LIGHTS TO 30%

1-BUTTON STATION: BUTTON #1 (FULL LIGHTS) - ALL LIGHTS TO 100% IN THE ZONE THE STA

CLASSROOM ROOM LIGHTS SHALL BE MANUAL ON AUTO OFF, UNLESS

WHEN LIGHTS ARE MANUALLY TURNED ON THEY SHALL DEFAULT TO 50%

CORRIDOR:

2-BUTTON STATION: BUTTON #1 (FULL LIGHTS) - ALL LIGHTS TO 100% IN THE ZONE THE STATION CONTROLS. BUTTON #1 (OFF) - ALL LIGHTS OFF IN THE ZONE THE STATION CONTROLS.

CORRIDOR LIGHTS SHALL BE AUTO ON AUTO OFF, UNLESS OTHERWISE DIRECTED BY THE OWNER. RESTROOM:

RESTROOM LIGHTS SHALL BE AUTO ON AUTO OFF, UNLESS OTHERWISE DIRECTED BY THE OWNER. OFFICES:

OFFICE LIGHTS SHALL BE MANUAL ON AUTO OFF, UNLESS OTHERWISE DIRECTED BY THE OWNER.

STORAGE / CUSTODIAL ROOMS:

LIGHTS SHALL BE MANUAL ON AUTO OFF, UNLESS OTHERWISE DIRECTED BY THE OWNER.

MECHANICAL / ELECTRICAL ROOM:

LIGHTS SHALL BE MANUAL ON MANUAL OFF USING EXISTING MANUAL SWITCHES. EMERGENCY LIGHTING:

EMERGENCY LIGHTING IN THE SPACE SHALL FUNCTION AS CALLED OUT IN THE SCENES. UPON POWER OUTAGE THE EMERGENCY LIGHTS TURN ON AND RAISE TO 100% AND OPERATE AT A MINIMUM OF 1,400 LUMENS FOR 90 MINUTES.

ELECTRICAL CONTRACTOR / LIGHTING CONTROL SYSTEM SUPPLIER REQUIREMENTS:

ELECTRICAL CONTRACTOR / LIGHTING CONTROL SYSTEM SUPPLIER SHALL PROVIDE ALL REQUIRED POWER PACKS, ROOM CONTROLLERS, WIRING ETC AS NECESSARY TO PROVIDE LIGHTING CONTROLS AS NOTED ABOVE. IF IT IS FOUND THE LIGHTING DOES NOT PERFORM AS INDICATED ABOVE THE ELECTRICAL CONTRACTOR AND LIGHTING SUPPLIER SHALL PROVIDE ALL THE REQUIRED EQUIPMENT, WIRING AND LABOR AS NECESSARY AT NO ADDITIONAL COST TO THE OWNER.

LIGHTING CONTROL SYSTEM SUPPLIER TO PROVIDE ALL REQUIRED PROGRAMMING OF THE LIGHTING CONTROLS, WIRELESS AREA CONTROLLERS AND TRELLIX SYSTEM. LIGHTING CONTROL SYSTEM SUPPLIER TO PROVIDE ALL REQUIRED TRELLIX SOFTWARE (INCLUDING FLOOR PLANS, LIGHTING LAYOUT) AND INSTALL ON OWNERS COMPUTER, PHONE APP'S, ETC FOR COMPLETE AND OPERATIONAL SYSTEM.

LIGHTING CONTROL SYSTEM SUPPLIER TO PROVIDE ALL REQUIRED COMMISSIONING ONCE THE SYSTEM IS COMPLETELY INSTALLED. LIGHTING CONTROL SYSTEM SUPPLIER TO REVIEW THE SYSTEM PRIOR TO COMMISSIONING AND INDICATE ANY REQUIRED CHANGES TO THE ELECTRICAL CONTRACTOR. CONTRACTOR TO UPDATE AND MAKE ALL CHANGES AS REQUIRED BY THE LIGHTING CONTROL SYSTEM SUPPLIER.


CONTRACTOR SHALL SCHEDULE A PRE-INSTALL MEETING WITH THE OWNER AND LIGHTING CONTROL SYSTEM SUPPLIER TO REVIEW THE INSTALLATION OF THE LIGHTING CONTROL SYSTEM PRIOR TO ANY DEMOLITION, ROUGH-IN AND PRIOR TO SUBMITTAL SUBMISSION. IF THE CONTRACTOR DOES NOT SCHEDULE A PRE-INSTALL MEETING. THE CONTRACTOR SHALL MAKE ANY AND ALL CHANGES TO THE LIGHTING CONTROL SYSTEM AS DIRECTED BY THE OWNER AND LIGHTING CONTROL SYSTEM SUPPLIER AT NO ADDITIONAL COST TO THE OWNER.

ALL POWER PACKS, ROOM CONTROLLERS, ETC SHALL BE LOCATED IN A READILY ACCESSIBLE LOCATION.

KEYED NOTES: (#)


1. MODIFY WIRING AS DIRECTED BY THE LIGHTING CONTROL SYSTEM

SYSTEM SUPPLIER.

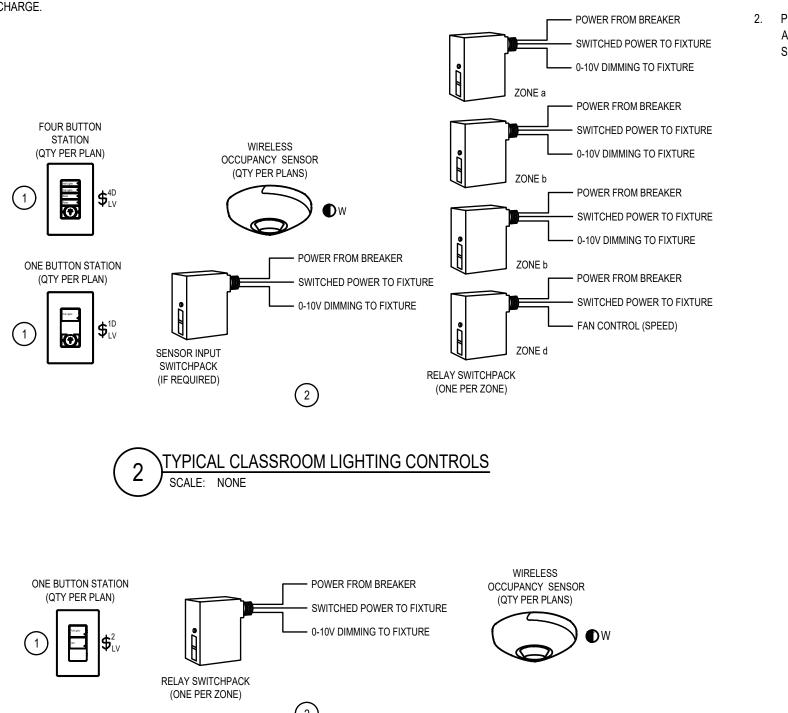

TYPICAL CORRIDOR LIGHTING CONTROLS

SCALE: NONE

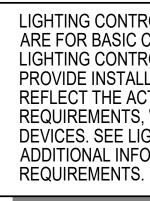

TATION CONTROLS.
S OTHERWISE DIRECTED BY THE OWNER.
50%

SUPPLIER. PROVIDE ADDITIONAL DIMMING CONDUCTORS AS DIRECTED BY THE LIGHTING CONTROL SYSTEM SUPPLIER.

PROVIDE ALL REQUIRED CONNECTIONS TO THE POWER PACKS AND WALL STATIONS AS DIRECTED BY THE LIGHTING CONTROL LIGHTING CONTROL SYSTEM REQUIREMENTS DIMMING LEADS: PROVIDE DIMMING LEADS TO ALL FIXTURES THAT HAVE THE FOLLOWING : NETWORK LOW-VOLTAGE LIGHTING CONTROL SYSTEMS. STAND ALONE LOW-VOLTAGE LIGHTING CONTROL SYSTEMS. ANYWHERE TASK TUNING IS REQUIRED. EMERGENCY OPERATION: PROVIDE A UL 924 LISTED METHOD FOR OPERATING EGRESS LIGHT FIXTURES. REFER TO DRAWINGS AND LIGHT FIXTURES SCHEDULE. ALL EGRESS LIGHT FIXTURES SHALL BE POWERED "FULL ON" DURING AN EMERGENCY OPERATION. LOW VOLTAGE CABLES:

PROVIDE CABLES IN TYPES AND SIZES IN ACCORDANCE WITH ALL MANUFACTURER'S WRITTEN INSTRUCTIONS AND RECOMMENDATIONS. ALL CABLES SHALL BE IN CONDUIT. INSTALLATION SHALL MEET ALL APPLICABLE REQUIREMENTS OF THE NEC 300.11.

SHOP DRAWINGS AND PRODUCT DATA:

PRODUCT DATA: PROVIDE PRODUCT DATA FOR ALL SYSTEM COMPONENTS CLEARLY DELINEATING THE DEVICES WHICH ARE TO BE PROVIDED. SHOP DRAWINGS: PROVIDE 1/8" SCALED DRAWINGS SHOWING THE LIGHTING CONTROL SYSTEM DEVICES PLACED ON THE CEILING AND FLOOR PLANS. OBTAIN CAD DRAWINGS FROM THE ARCHITECT. DRAWINGS SHALL INCLUDE COMPLETE LINE AND LOW VOLTAGE INTERCONNECTION REQUIREMENTS. PROVIDE SEPARATE LINE AND LOW VOLTAGE DRAWINGS AS MAY BE REQUIRED FOR CLARITY. LOW VOLTAGE DRAWING SHALL INCLUDE LENGTHS OF ALL CABLES. INCLUDE COMPLETE WIRING DIAGRAMS, ONE-LINE DIAGRAMS, DETAILS, ETC.

PROGRAMMING SCHEDULES: PROVIDE COMPLETE SEQUENCING AND PROGRAMMING SCHEDULES FOR ALL DEVICES, ZONES, AND SCENES.

RECORD DRAWINGS: AT THE COMPLETION OF THE PROJECT, PROVIDE UPDATED SHOP DRAWINGS INCLUDING ALL CHANGES MADE DURING CONSTRUCTION. INDICATE EXACT LOCATION BY DIMENSION OF ALL POWER PACKS AND OTHER DEVICES. PROVIDE IN ELECTRONIC FORMAT.

WARRANTY:

WARRANTY ALL WORK INCLUDING PARTS AND LABOR FOR A PERIOD OF ONE YEAR.

COMMISSIONING:

COMMISSION EACH PORTION OF THE LIGHTING CONTROL SYSTEMS AT THE COMPLETION OF THE PROJECT TO VERIFY THAT THE SYSTEM PERFORMS AS INTENDED AND AS DIRECTED BY THE OWNER.

RETRO-COMMISSIONING:

DURING THE ONE YEAR WARRANTY PERIOD, PROVIDE RETRO-COMMISSIONING SERVICES AT THREE MONTH, SIX MONTH, NINE MONTH, AND ONE YEAR MARKS. PROVIDE AT LEAST 8 HOURS OF COMMISSIONING SERVICE FOR EACH OF THE FOUR RETRO-COMMISSIONING PERIODS. THIS WILL INCLUDE MEETING WITH THE OWNER TO RECEIVE FEEDBACK ON THE SYSTEM AND MAKING CHANGES TO THE SYSTEM INCLUDING PROGRAMMING, TASK TUNING, ETC.

TRAINING:

PROVIDE TWO HOURS OF TRAINING FROM A FACTORY TRAINED AND CERTIFIED TECHNICIAN AT THE COMPLETION OF THE PROJECT. SCHEDULE TRAINING WITH THE OWNER.

BIDDING REQUIREMENTS:

BIDDERS SHALL BREAK OUT THE LIGHT FIXTURE PACKAGE SEPARATE FROM THE LIGHTING CONTROL SYSTEM. ALL SPECIAL FEATURES PERTAINING TO LIGHTING CONTROLS ASSOCIATED WITH THE LIGHT FIXTURES SHALL BE CONSIDERED LIGHTING CONTROLS. BIDDERS WHO DO NOT CONFORM TO THIS REQUIREMENT MAY BE DISQUALIFIED.

GENERAL NOTES:

- THE LIGHTING CONTROLS AS SHOW ARE WAVELINX LIGHTING CONTROLS NO OTHERS WILL BE ALLOWED.
- COORDINATE ALL REQUIREMENTS, CONNECTIONS AND CABLE TYPE WITH THE SUPPLIER PRIOR TO ANY INSTALLATION.
- THE LIGHTING CONTROLS SYSTEM SUPPLIER SHALL PROVIDE COMPUTER DRAFTED 3. SHOP DRAWINGS OF THE ENTIRE LIGHTING CONTROL SYSTEM USING FLOOR PLANS PROVIDED BY THE ENGINEER. SHOP DRAWINGS TO INCLUDE PLANS, SECTIONS, ELEVATIONS, FINAL DEVICE LOCATIONS, CONDUIT SIZE AND ROUTING AND ALL CONDUCTOR SIZES. TYPICAL RISERS AND COPYING AND SUBMITTING THE CONTRACT DOCUMENTS WILL NOT BE ACCEPTED.
- INSTALLATION SHALL MEET ALL APPLICABLE REQUIREMENTS OF THE NEC 300.11 ALL CABLES SHALL BE ROUTED IN A NEAT WORKMANLIKE MANNER PARALLEL AND PERPENDICULAR TO STRUCTURE.
- NOT ALL SPACES SHOWN. LIGHTING CONTROL SUPPLIER TO PROVIDE INSTALLATION DRAWINGS INDICATING ALL REQUIRED WIRING FOR ALL SPACES CONTROLLED.

LIGHTING CONTROLS DIAGRAMS AS SHOWN ARE FOR BASIC CONCEPT AND LAYOUT. LIGHTING CONTROLS SYSTEM SUPPLIER TO PROVIDE INSTALLATION DRAWINGS THAT REFLECT THE ACTUAL INSTALLATION REQUIREMENTS. WIRING AND ALL REQUIRED DEVICES. SEE LIGHTING PLANS FOR ADDITIONAL INFORMATION AND


NOTE:

CONTRACTOR SHALL SCHEDULE A PRE-INSTALL MEETING WITH THE OWNER AND LIGHTING CONTROL SYSTEM SUPPLIER TO REVIEW THE INSTALLATION OF THE LIGHTING CONTROL SYSTEM PRIOR TO ANY DEMOLITION, ROUGH-IN AND PRIOR TO SUBMITTAL SUBMISSION. IF THE CONTRACTOR DOES NOT SCHEDULE A PRE-INSTALL MEETING, THE CONTRACTOR SHALL MAKE ANY AND ALL CHANGES TO THE LIGHTING CONTROL SYSTEM AS DIRECTED BY THE OWNER AND LIGHTING CONTROL SYSTEM SUPPLIER AT NO ADDITIONAL COST TO THE OWNER.

			LIGHT FIXTURE SCHEDULE				
SYM	DESCRIPTION	MANUFACTURER		LOAD	LAMP	MOUNTING	REMARKS AND INSTRUCTIONS
F1	2x4 LED FLAT PANEL	NAME METALUX COLUMBIA DAY-BRIGHT LITHONIA	CATALOG NUMBER 24FP4740C-FPSURF24 SRP24-40LWG-EDU / SRPSMK-24 2FPZ43L840-4-DS-UNV-DIM FSF24 CPX 2X4 4000LM 80CRI 40K SWL MIN10 ZT MVOLT / 2X4SMKSH	(VA) 42	TYPE LED 4000 LUM 4000K	SURFACE	MOUNT WITH MANUFACTURER'S SURFACE MOUNT KIT INCLUDE EMERGENCY BATTERY PACK WHERE SHOWN ON PLAN HATCHED
F3	1x4 LED FLAT PANEL	METALUX COLUMBIA DAY-BRIGHT LITHONIA	14FP2640C-FPSURF14 SRP14-40MWG-EDU / SRPSMK-14 1FPZ32L840-4-DS-UNV-DIM FSF14 CPX 1X4 3200LM 80CRI 40K SWL MIN10 ZT MVOLT / 1X4SMKSH	39	LED 3200 LUM 4000K	SURFACE	MOUNT WITH MANUFACTURER'S SURFACE MOUNT KIT INCLUDE EMERGENCY BATTERY PACK WHERE SHOWN ON PLAN HATCHED
F4	LED STRIP LIGHT	METALUX SYLVANIA DAY-BRIGHT LITHONIA	4SLSTP2040DD-UNV STRIP2A/22UNVD840/48U/WH (E) / LNHBA2A/CHAINMT SDS42448L8CST-UNV-DIM CLX L48 3000LM SEF RDL MVOLT GZ10 40K 80CRI EPNKO WH	23	LED 2000 LUM 4000K	SURFACE OR CHAIN	INCLUDE EMERGENCY BATTERY PACK WHERE SHOWN ON PLAN HATCHED
F5	RESTROOM WALL LIGHT	METALUX VISIONEERING DAY-BRIGHT LITHONIA	4BCLED-LD4-32SL-F-UNV-L840-CD1-U LCAD-48-LED-8-40K-030LC-UNV FSW430L840-UNV-DIM BLWP4 30L SDSM GZ10 LP840	30	LED 3000 LUM 4000K	WALL	
F6	RESTROOM WALL LIGHT	METALUX VISIONEERING DAY-BRIGHT LITHONIA	2BCLED-LD4-20SL-F-UNV-L840-CD1-U LCAD-24-LED-8-40K-020L-UNV FSW220L840-UNV-DIM BLWP2 20L SDSM GZ10 LP840	20	LED 2000 LUM 4000K	WALL	
F8	30" DECORATIVE PENDANT	EVERGREEN LAMPISTE LIGHTWAY SPECTRUM	SHP-RBR-P30-136L-9-WF9-40K-DIM BWL-S-D-30/DC/30-LED/60-DBWL-LDS-CLA-SA MONH-30-LED-09C-4-STANDARD FINISH-WSA-DIM-1SLM45- DOUBLE BOWL-XX"OAH SPEC18-000E3 (MOD TO 40K) STEM LENGTH (XX")	136	LED 10000 LUM 4000K	PENDANT	MATCH EXISTING PENDANT LENGTH. FIELD VERIFY PRIOR TO ORDERING. LIGHTING CONTROL SYSTEM SUPPLIER TO TASK TUNE THIS FIXTURE TO LIGHTING LEVEL AS DIRECTED BY THE OWNER.
F11	CEILING FAN	HD SUPPLY	SEASONS #112168 (SEE LIGHT FIXTURE SCHEDULE GENERAL NOTE #5)	CONFIRM	N/A	PENDANT	52", THREE BLADE, THREE SPEED, WHITE. CONFIRM DOWN ROD LENGTH WITH THE ARCHITECT PRIOR TO ORDERING.
X1	LED EXIT SIGN	ALL PRO EM SYLVANIA CHLORIDE LITHONIA	APX7G 60878 VEGWEM EXG LED EL M6	5	LED	CEILING	THERMOPLASTIC EXIT SIGN WITH GREEN LETTERS.

LIGHT FIXTURE SCHEDULE GENERAL NOTES

- FIELD VERIFY ALL QUANTITIES AND LOCATIONS.
- PROVIDE DIMMERS COMPATIBLE WITH LIGHT SOURCE BEING DIMMED
- 4. LOCAL UTILITY COMPANY PRIOR TO SUBMISSION.
- PROVIDE AS SPECIFIED.

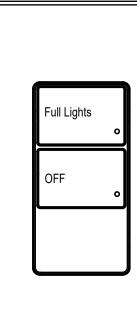


SYMBOL: $\mathbf{5}_{11}^2$

FIELD VERIFY FIXTURE THAT WILL REQUIRE EMERGENCY BATTERIES. SEE SPECIFICATIONS FOR BATTERY REQUIREMENTS AND APPROVED MANUFACTURES.

THE CONTRACTOR SHALL BE RESPONSIBLE FOR APPLYING FOR ANY AND ALL UTILITY INCENTIVES AVAILABLE. THIS INCLUDES PROVIDING ALL DOCUMENTATION, FIXTURE COUNTS, INVOICES, BILL OF MATERIALS, ETC NECESSARY FOR THE OWNER TO CAPTURE THOSE INCENTIVES. CONFIRM ALL REQUIREMENTS WITH THE

ALL MANUFACTURES LISTED IN THE LIGHT FIXTURE SCHEDULE ARE APPROVED TO BID THIS FIXTURE. CEILING FAN SHALL BE AN EQUIVALENT TO WHAT IS SPECIFY OR

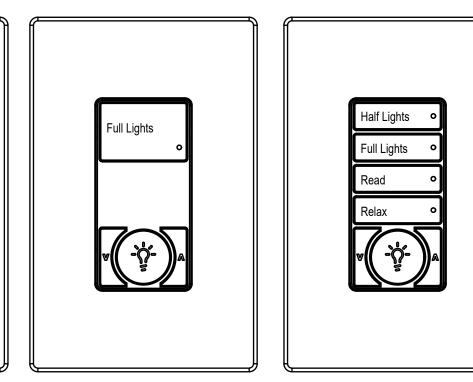

SYMBOL: \$10

SYMBOL: **\$**10






-5-日 92 دے No.26439 2022/04/13 Ш 55 **PRICE** INSTITU LS HRI HRI CHO DA ^い い に **H**DF ES PROJECT NUMBER 5404304-22010301 7 APR 2022 PROPERTY NUMBER: 5404304 RAWN BY CHECKED: SDK DPW SHEET TITLE LIGHT FIXTURE SCHEDULE AND LIGHTING CONTROLS


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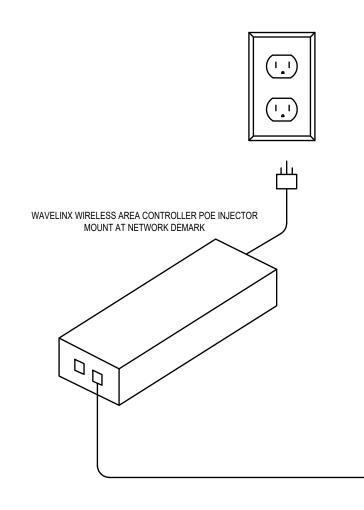
F (801) 534-1080

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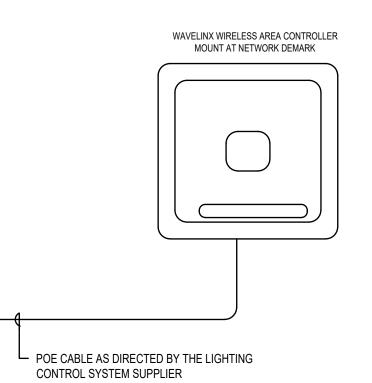







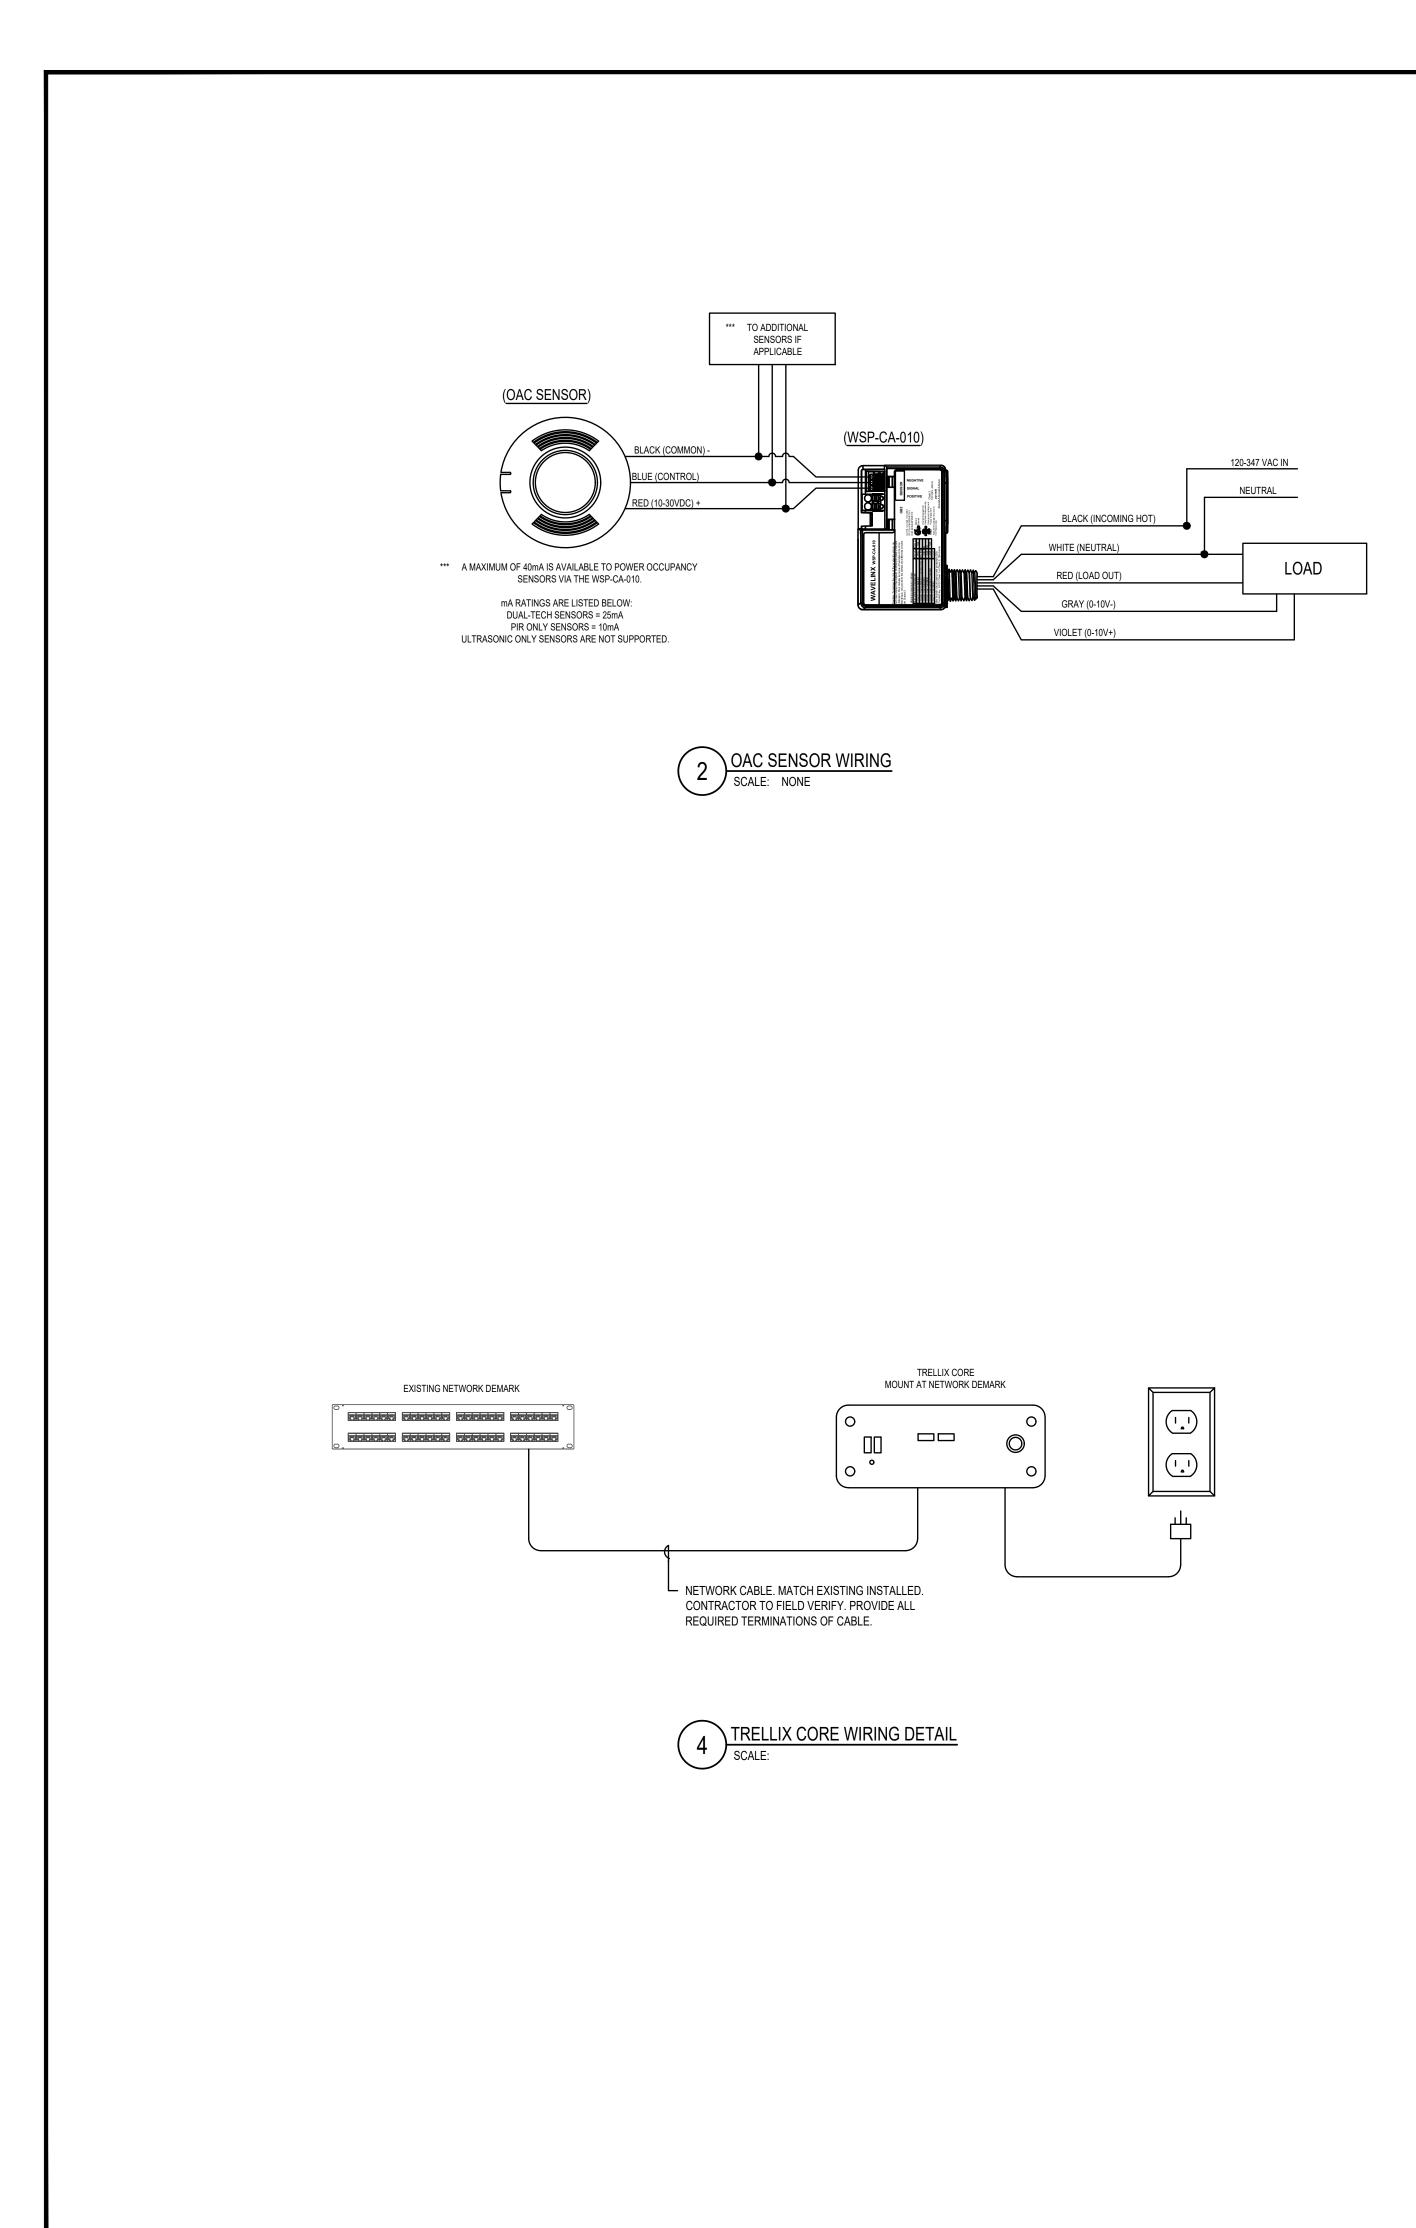

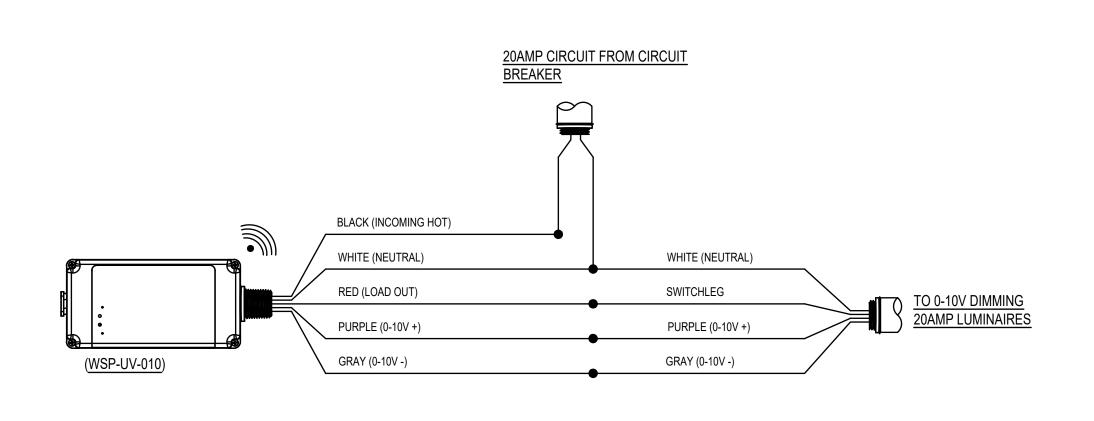



3 WIRELESS AREA CONTROLLER WIRING DETAIL SCALE: NONE

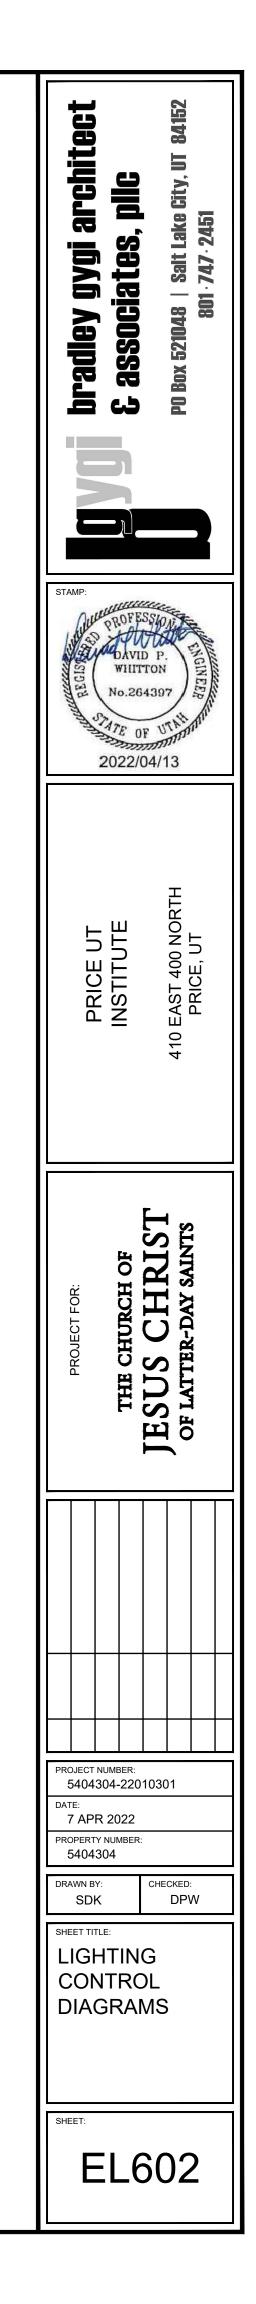

ENVISION

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