


## PARK 1, 4, 10 RESTROOM & ADA UPGRADES

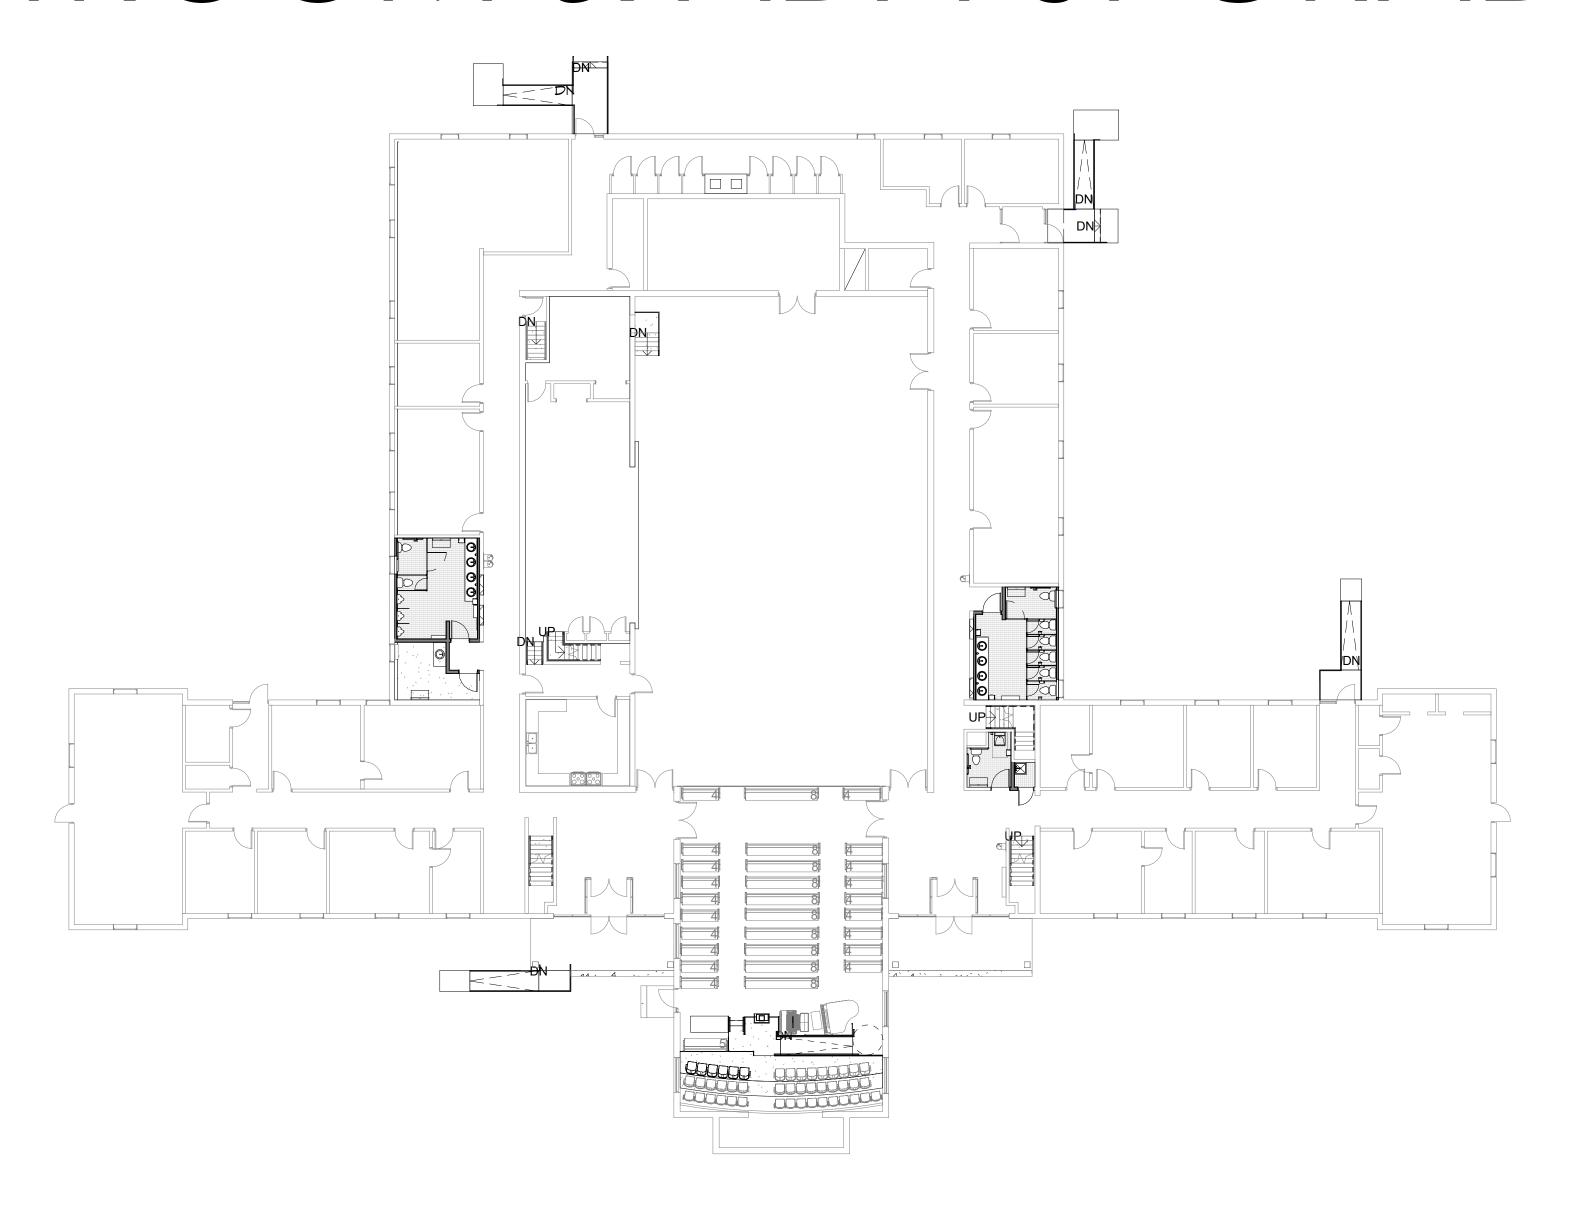

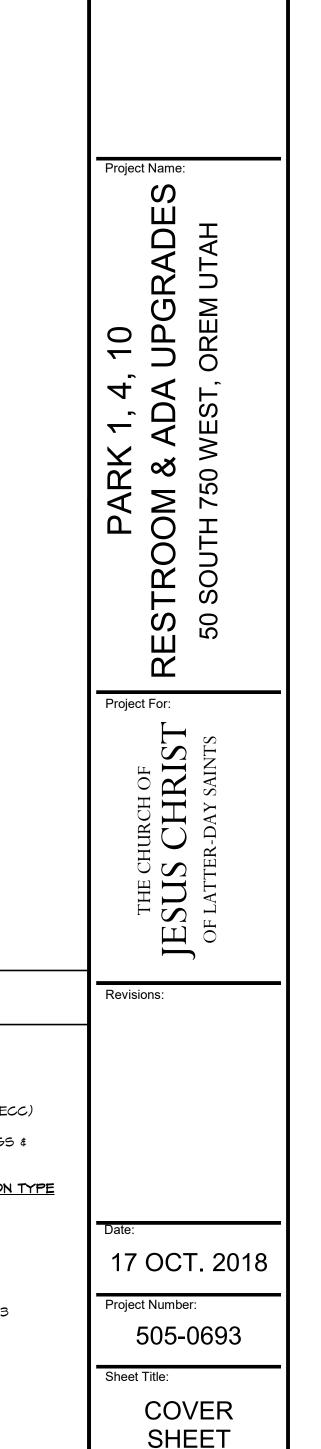

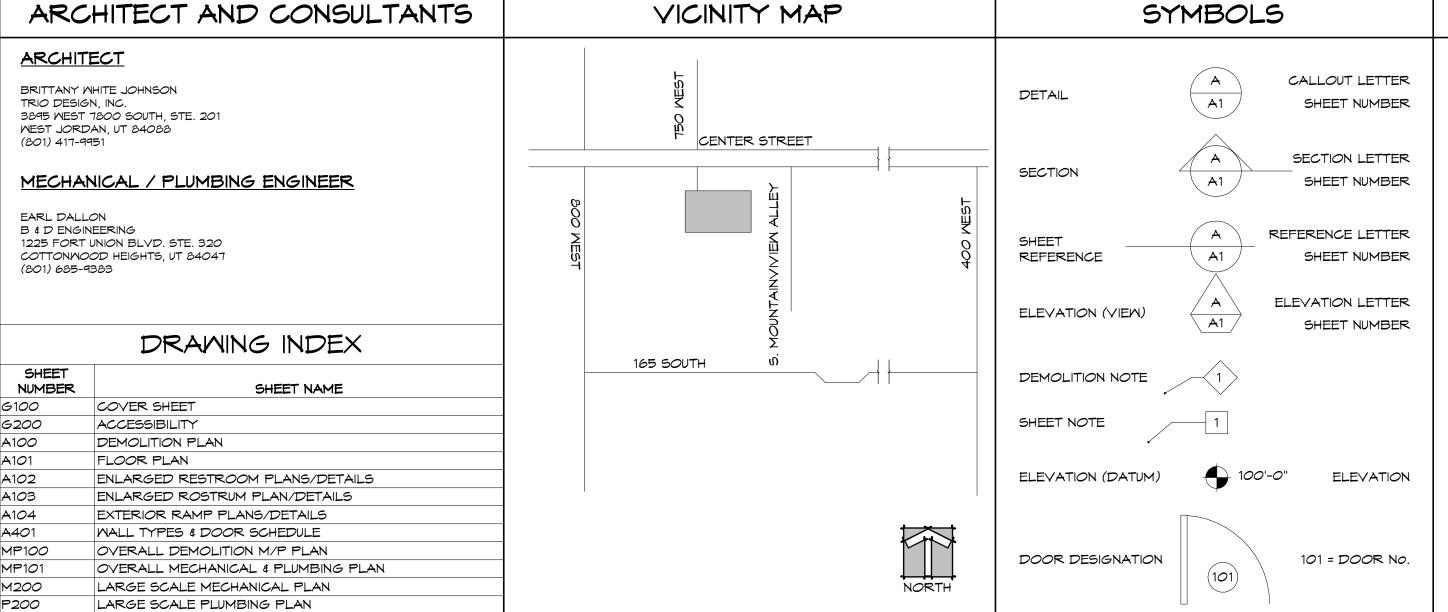

THE GENERAL CONTRACTOR SHALL BE RESPONSIBLE FOR OBTAINING ALL REQUIRED BUILDING PERMITS, SCHEDULING INSPECTIONS AND PROVIDING MATERIALS AND MORKMANSHIP IN ACCORDANCE WITH ALL APPLICABLE CODES MATERIALS AND WORKMANSHIP IN ACCORDANCE WITH ALL APPLICABLE CODES BY LOCAL AND STATE AGENCIES.

GENERAL NOTES

CONTRACTOR SHALL VERIFY ALL EXISTING CONDITIONS ON SITE AND REPORT ANY DISCREPANCIES AND/OR UNFORESEEN ADVERSE CONDITIONS REQUIRING DRAWINGS AND/OR CONSTRUCTION MODIFICATION IN WRITING TO THE ARCHITECT'S AND CONSTRUCTION MANAGER'S OFFICE.

- ALL NEW CONSTRUCTION AND MODIFICATIONS TO ANY EXISTING CONSTRUCTION OF SYSTEMS RELATED TO ANY CONSTRUCTION MUST CONFORM TO THE APPROPRIATE CONSTRUCTION, ENERGY, MECHANICAL, ELECTRICAL, STRUCTURAL, CIVIL OR ANY OTHER BUILDING RELATED STATE OR LOCAL CODES THAT ARE ADOPTED AND ENFORCEABLE.
- 4. ALL ITEMS THAT PENETRATE FIRE RATED CEILINGS (LIGHTS & ETC.) SHALL BE TENTED WITH 5/8" TYPE C GYPSUM BOARD.
- CONTRACTOR TO PROVIDE WOOD BACKING FOR ALL ITEMS ATTACHED TO WALLS.

MEET THAT OF THE WALL IN WHICH PENETRATION OCCURS.

- "PROVIDE" SHALL REPRESENT THE REQUIREMENT TO SUPPLY AND INSTALL THE ITEM INDICATED.
- ANY AND ALL QUESTIONS REGARDING THESE DRAWINGS SHALL BE DIRECTED TO THE ARCHITECT.
- THE ARCHITECT & OWNER ASSUME NO RESPONSIBILITY FOR ANY UNFORESEEN EXISTING CONDITIONS, ANY CONTRACTOR'S WORK, WORKMEN, SUBCONTRACTORS OR ANY PERSON CONNECTED WITH ANY
- CONSTRUCTION ON THIS WORK. DIMENSIONS ARE TO FACE OF EXISTING SURFACES AND FACE OF NEW FRAMING/ CONCRETE UNLESS
- OTHERWISE NOTED. PROVIDE FIRE SAFING AND SEALANTS PER MFR'S INSTRUCTIONS AT PENETRATION OF ALL WALLS REQUIRING FIRE RESISTANCE AS INDICATED. FIRE RESISTANCE OF FIRE SAFING AND SEALANTS SHALL
- 12.. THE PROJECT SITE IS A NON-SMOKING, TOBACCO FREE SITE, WHICH INCLUDES E-CIGARETTES (VAPING). REFER TO SPECIFICATION SECTION 01 1400 - WORK RESTRICTIONS FOR ADDITIONAL INFORMATION.

MATER CLOSET HEIGHT: 11" TO 19" A.F.F.

- 2. CENTERLINE OF WATER CLOSET: 18" FROM SIDE WALL.
- 3. GRAB BAR BEHIND WATER CLOSET: 36" LONG, 33"-36" AFF. GRAB BAR AT SIDE OF WATER CLOSET: 42" MIN. LONG, 33"-36" AFF. VERTICAL BAR

ADA REQS:

- GRAB BAR DIAMETER: 1-1/4" TO 1-1/2"
- 6. SPACE BETWEEN GRAB AND BAR: 1-1/2"
- TOILET PAPER DISPENSER: 36"FROM REAR WALL, (MAX), 19" MIN AFF.
- KNEE CLEARANCE @ LAVATORY: APRON 29" MIN. HGT, 8" MIN DEPTH.
- LAVATORY DEPTH:
- MIN 17" DEPTH. 10. LAY. HOT WATER & DRAIN PIPES
- INSULATED WHERE EXPOSED. 11. INTERNATIONAL SYMBOL OF ACCESSIBILITY SHALL BE MOUNTED ON EXTERIOR OF ALL TOILET ROOM DOORS AND ADJACENT MALL NEXT TO THE LATCH SIDE OF THE
- DOOR, 48" AFF. 12. LAV. RIM SURFACE:
- 34" MAX. AFF. MIRROR BOTTOM EDGE:
- 40" MAX. AFF. 14. PRIVACY LOCK SHALL HAVE LEVER-TYPE HANDLES.

2015 INTERNATIONAL BUILDING CODE (IBC) 2015 INTERNATIONAL MECHANICAL CODE (IMC) 2015 INTERNATIONAL PLUMBING CODE (IPC) 2015 INTERNATIONAL FUEL GAS CODE (IFGC) 214 NATIONAL ELECTRICAL CODE (NEC)

CODE REVIEW

2015 INTERNATIONAL ENERGY CONSERVATION CODE (IECC) (ASHRAE 90.1) 2009 ICC/ANSI 117.1 ACCESSIBLE AND USABLE BUILDINGS &

FACIITIES OCCUPANCY TYPE (SECTION 304.1) CONSTRUCTION TYPE

(SECTION 602.5) A-3 - ASSEMBLY TYPE V-B

FIRE SPRINKLERS NOT PROVIDED

OCCUPANT LOAD (SECTION 1004.1.2) OCCUPANT LOAD FOR AREA OF WORK = BASED ON A-3 OCCUPANCY TOTAL = 1520 OCCUPANTS

PLUMBING FIXTURES (TABLE 2902.1) ASSEMBLY: 1520 OCCUPANTS

WATER CLOSETS = 1/150 - MEN & 1/75 WOMEN LAVATORIES = 1/200 PER GENDER DRINKING FOUNTAINS = 1/1000 1 SERVICE SINK


FAMILY RESTROOM - 1 W/C & 1 LAV

MATER CLOSETS = 2 W/C & 3 URINALS - MEN; 6 W/C -


MOMEN LAVATORIES = 4 PROVIDED PER GENDER DRINKING FOUNTAINS: 4 FOUNTAINS (3 HIGH, 1 LOW) OTHER = 1 SERVICE SINK EXISTING

Sheet No.:

G100

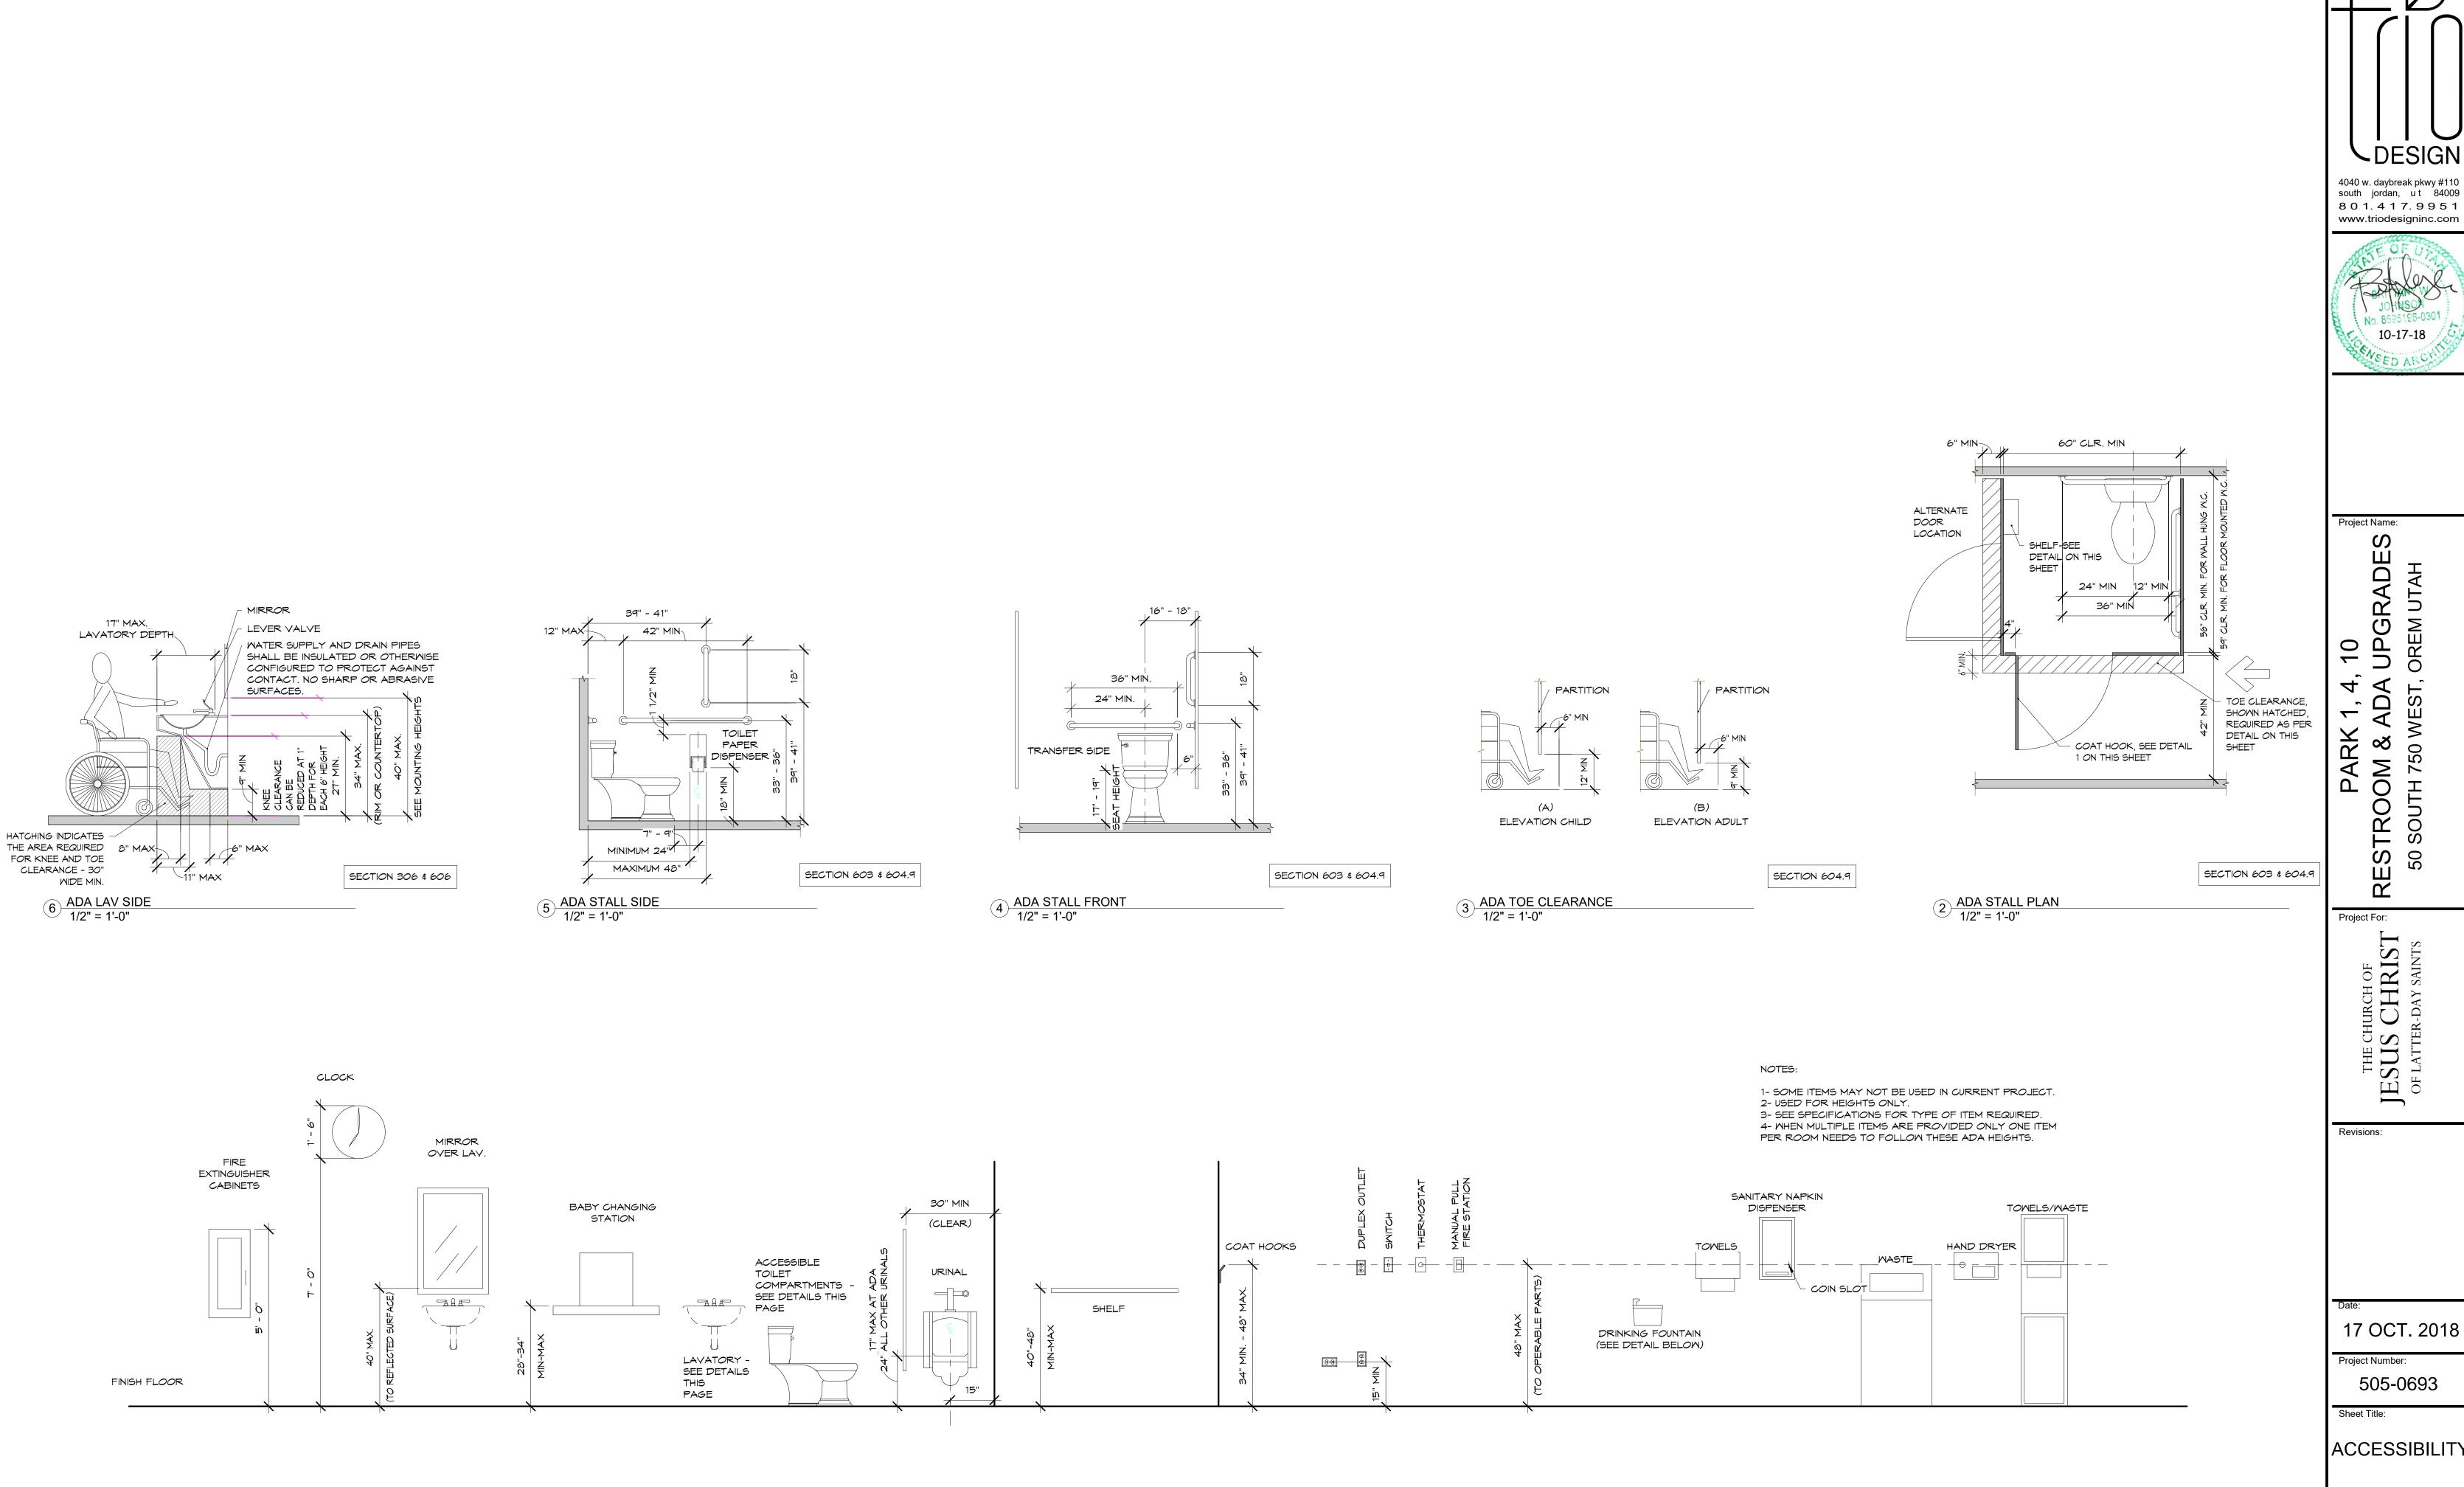

1 TYPICAL MOUNTING HEIGHTS
1/2" = 1'-0"

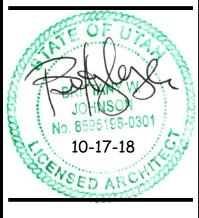

 4, 10
 ADA UPGRADES **OREM UTAH** H 750 WEST, MORESTROC 50 SOUTH

THE CHURCH OF JESUS CHRIST OF LATTER-DAY SAINTS

Revisions:

17 OCT. 2018


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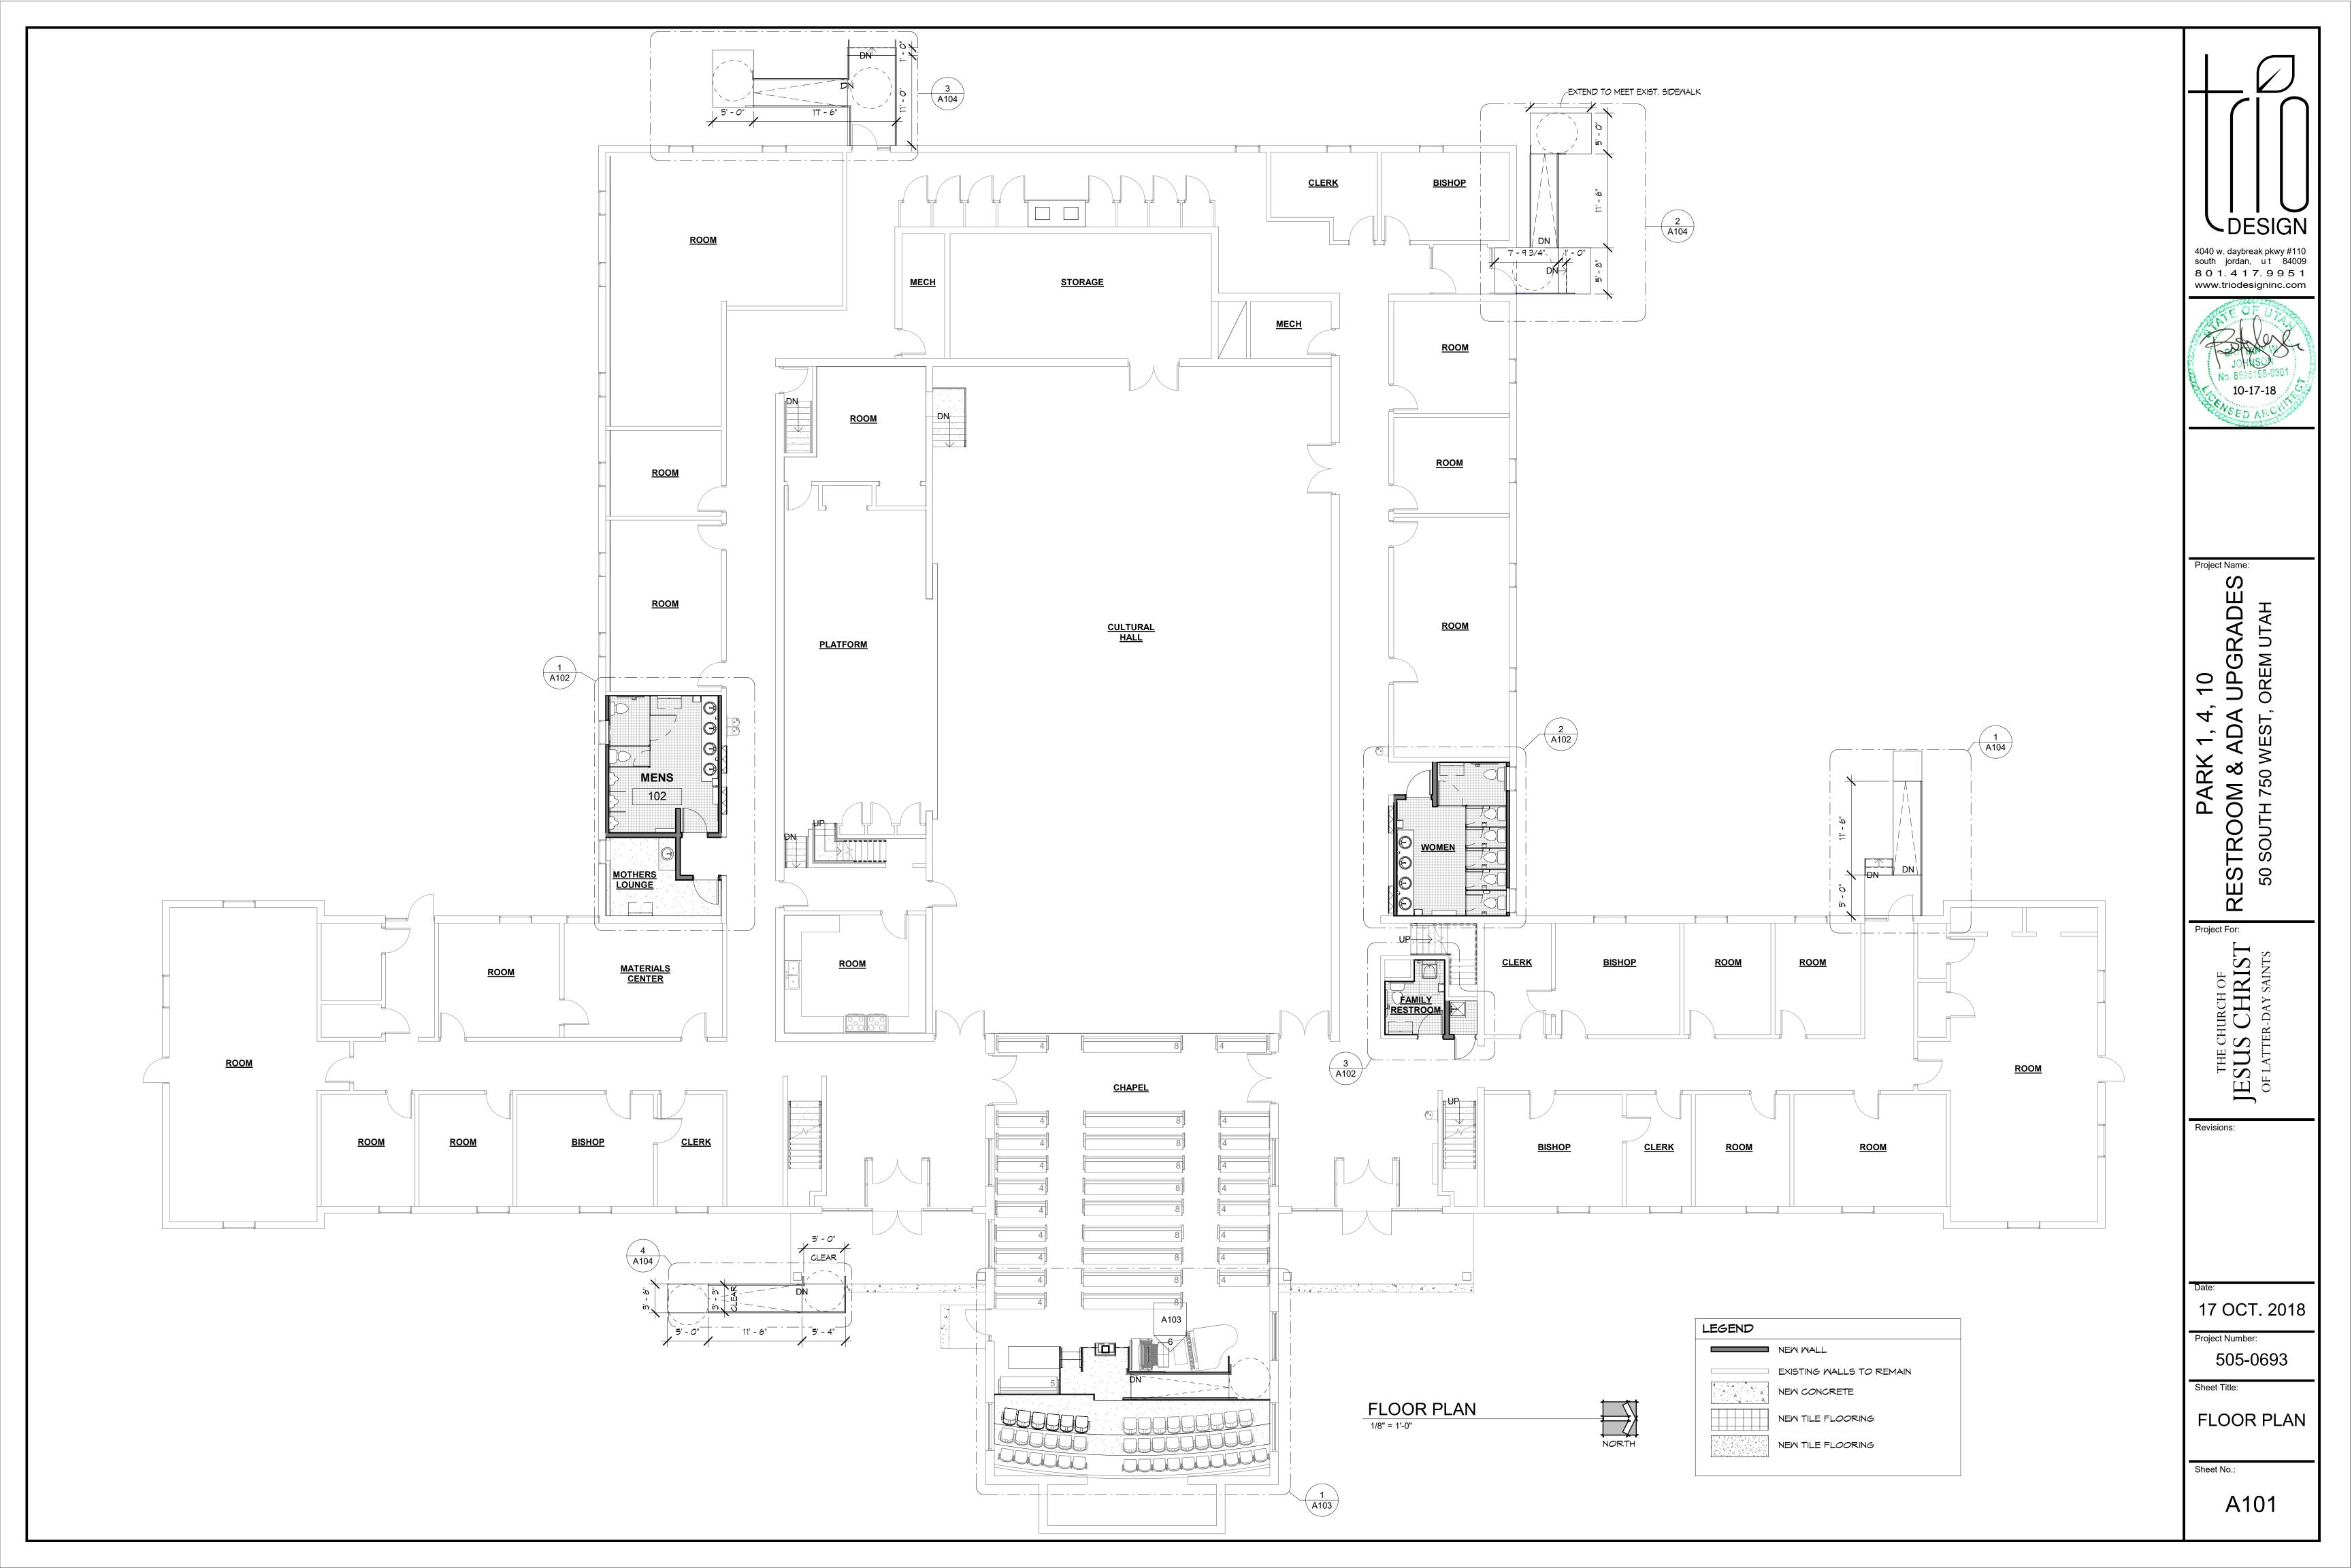
505-0693


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Sheet No.:

G200





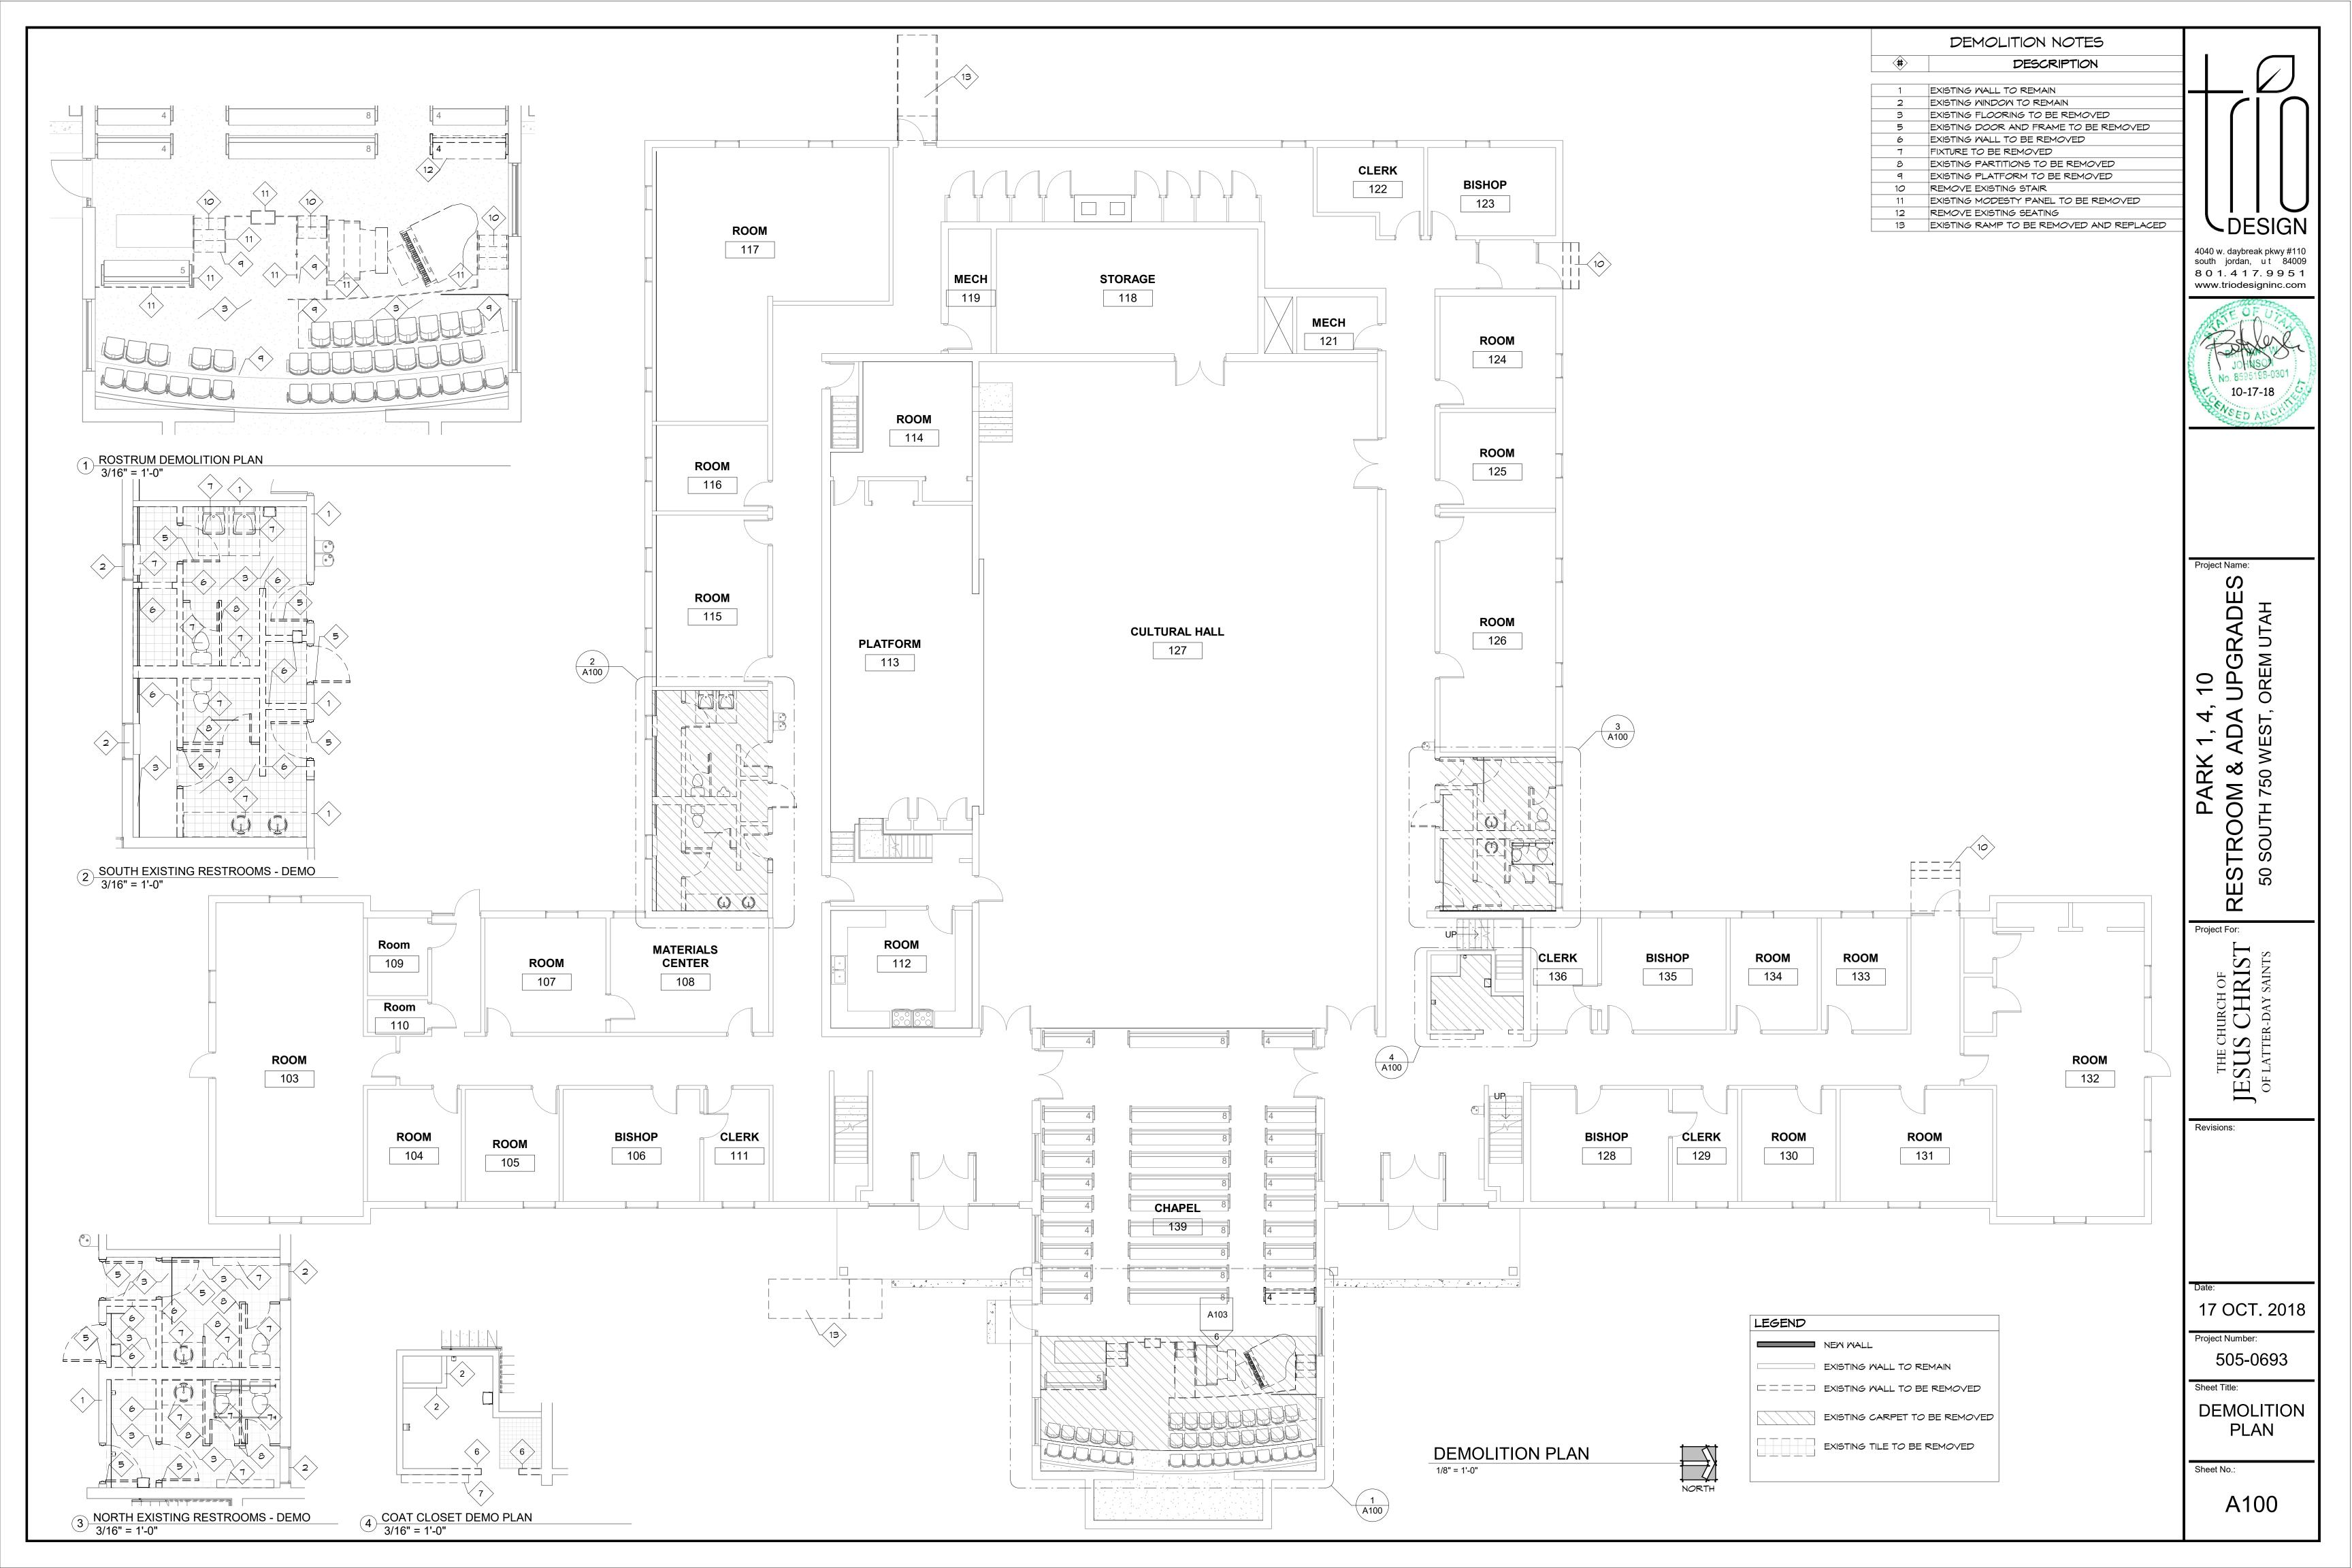

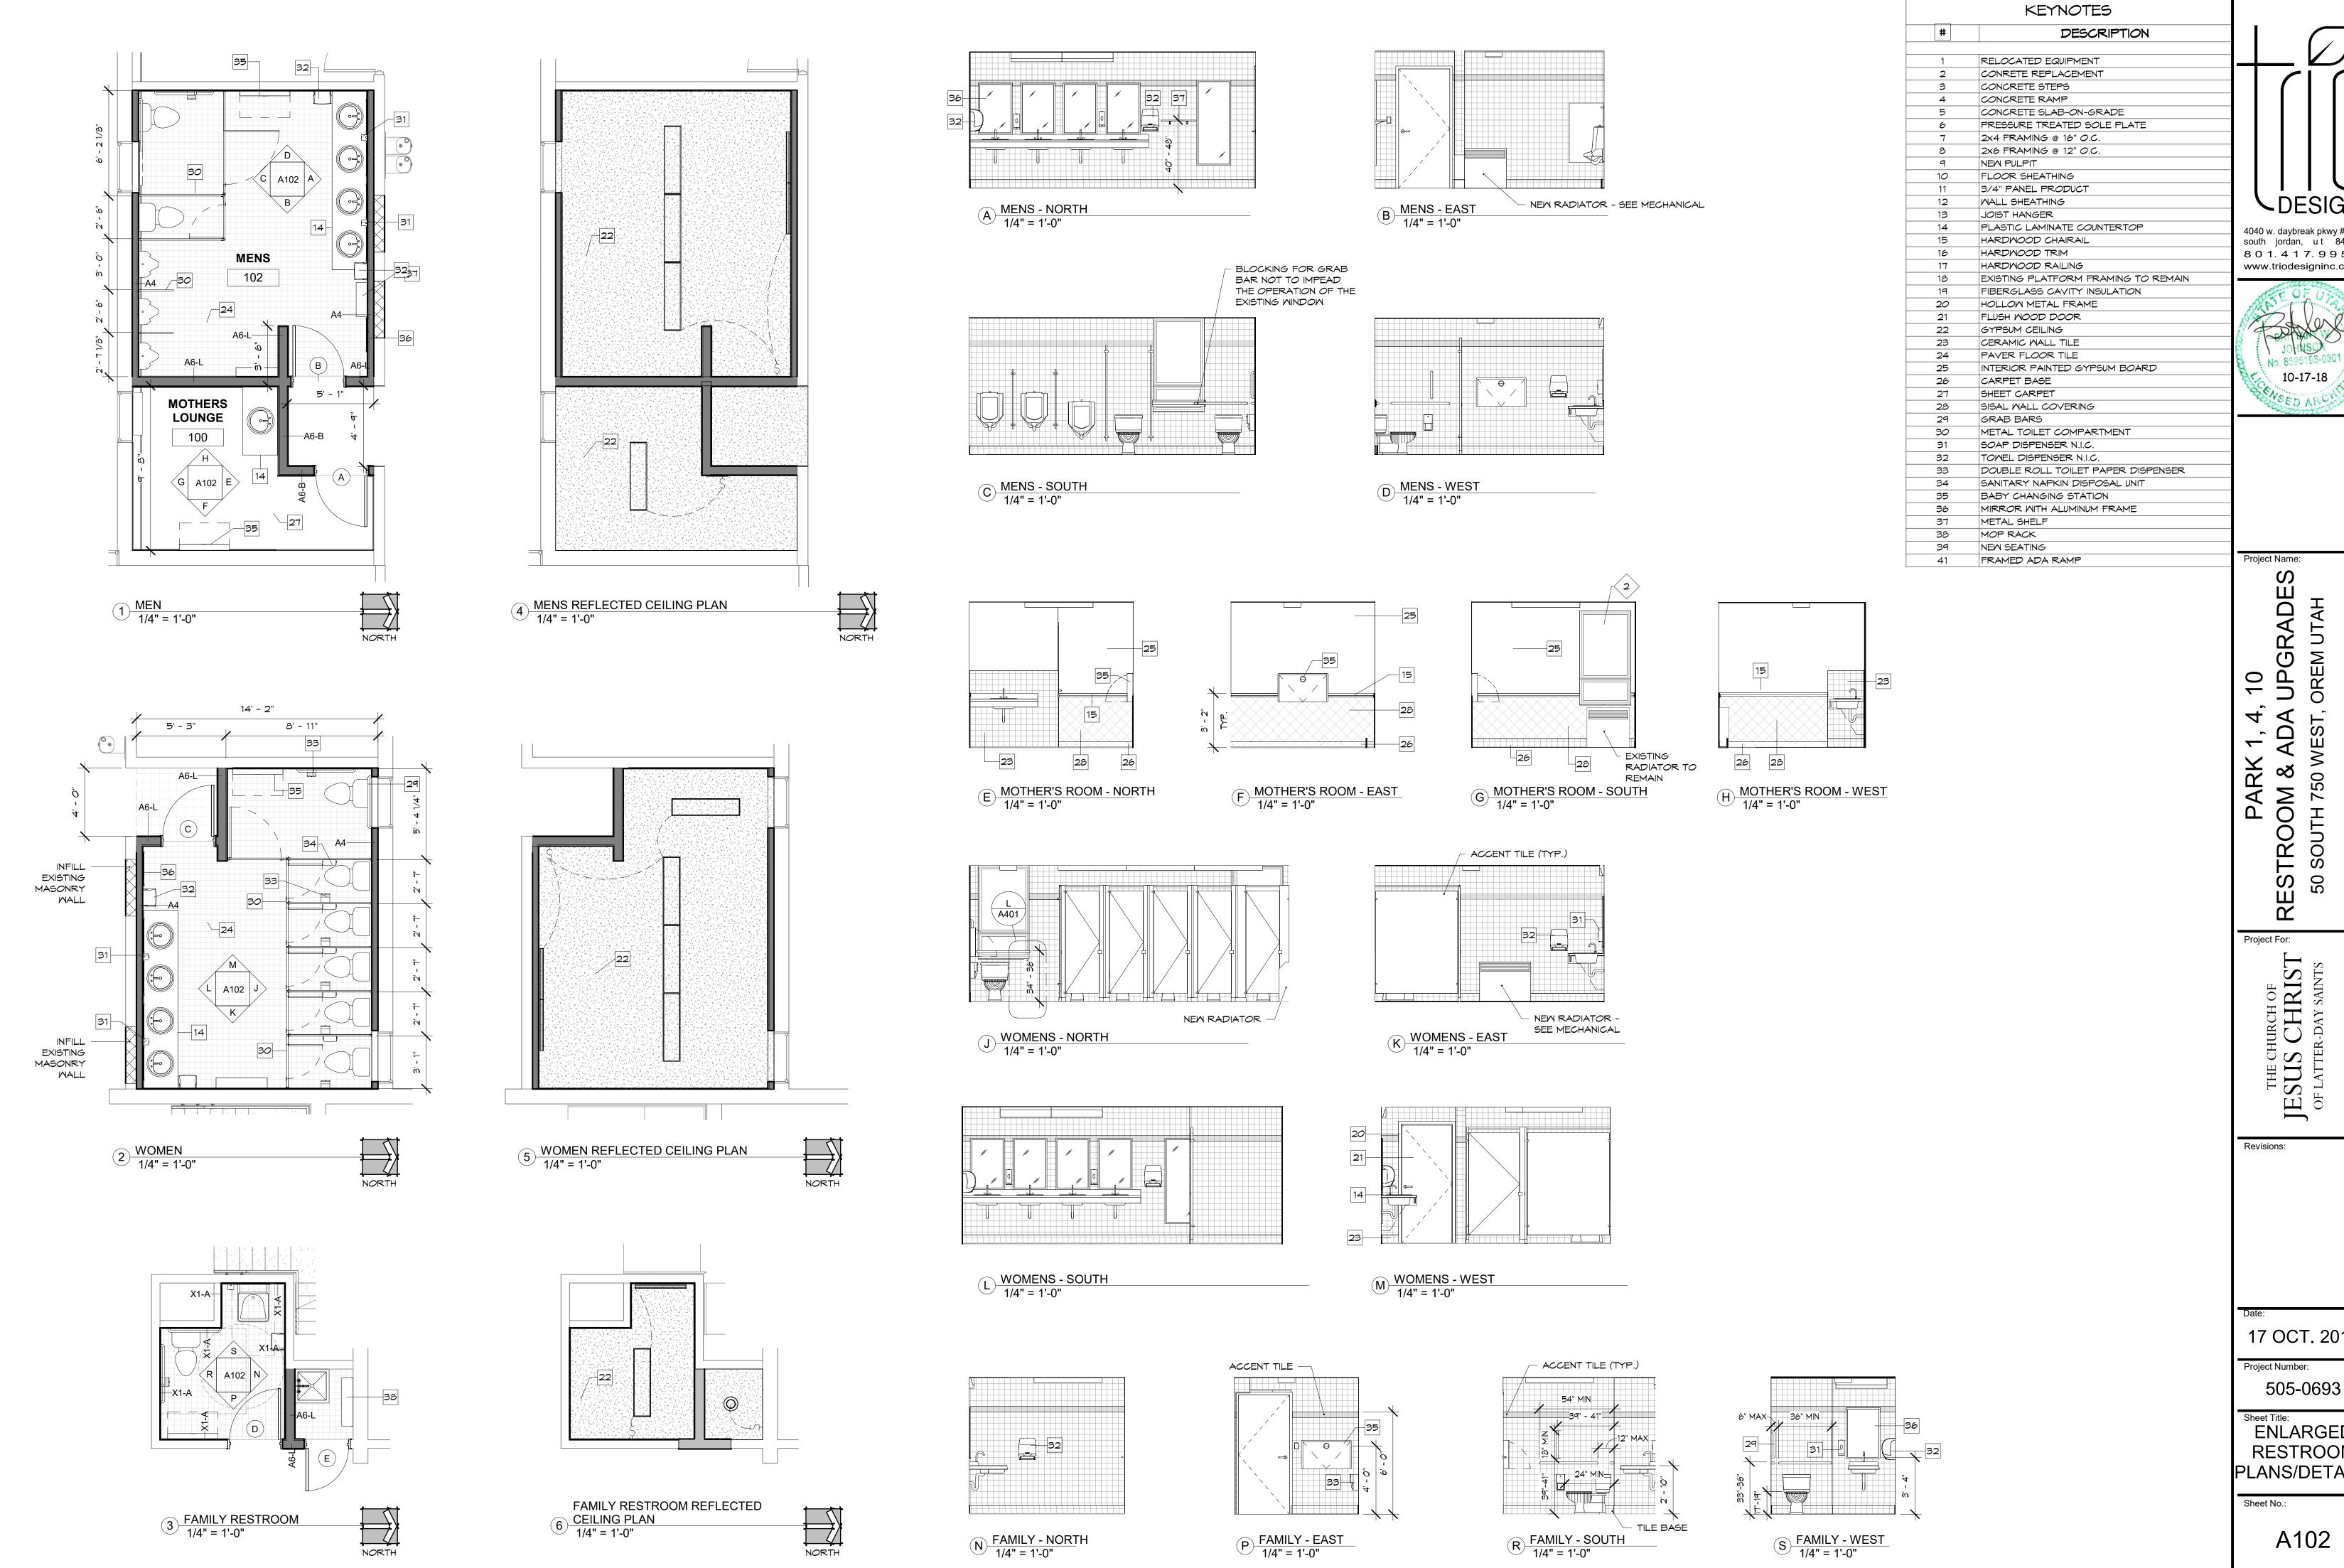
~DESIGN 4040 w. daybreak pkwy #110 south jordan, u t 84009 801.417.9951 www.triodesigninc.com 10-17-18

OREM UTAH

17 OCT. 2018

**ENLARGED** RESTROOM PLANS/DETAILS

A102

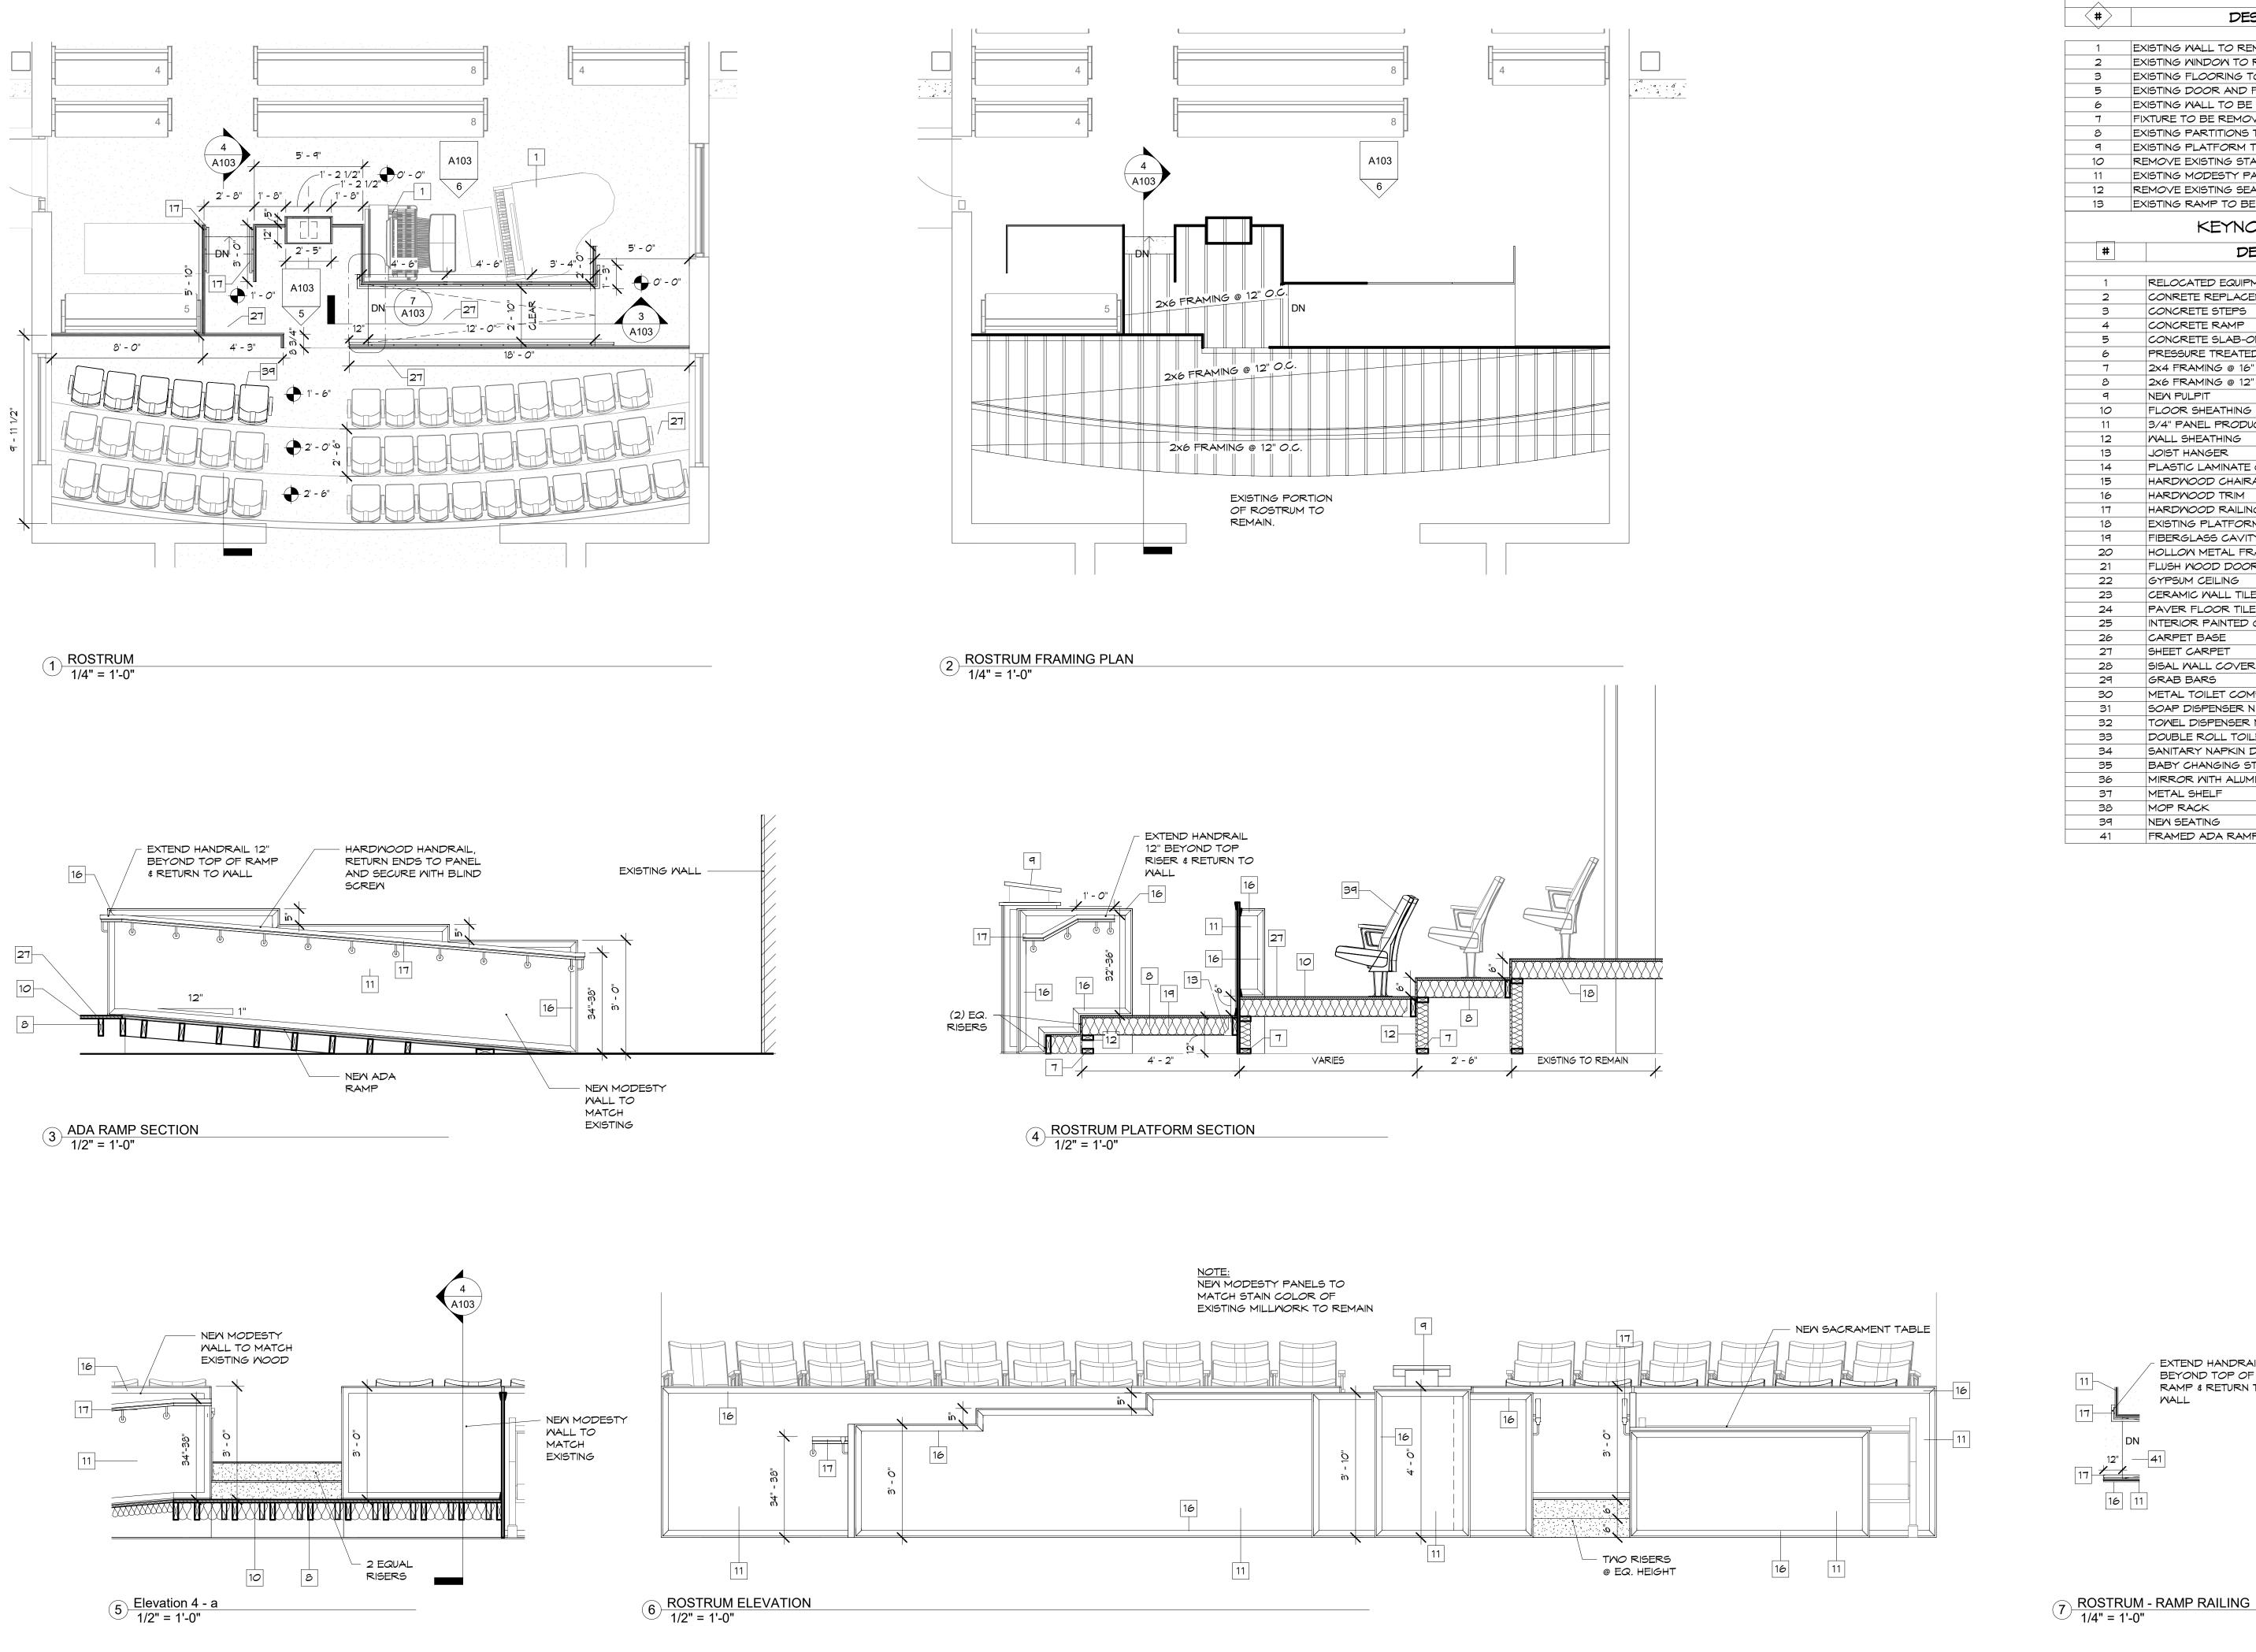

DEMOLITION NOTES DESCRIPTION **(#)** EXISTING WALL TO REMAIN EXISTING WINDOW TO REMAIN EXISTING FLOORING TO BE REMOVED EXISTING DOOR AND FRAME TO BE REMOVED EXISTING WALL TO BE REMOVED FIXTURE TO BE REMOVED EXISTING PARTITIONS TO BE REMOVED EXISTING PLATFORM TO BE REMOVED REMOVE EXISTING STAIR EXISTING MODESTY PANEL TO BE REMOVED REMOVE EXISTING SEATING 13 EXISTING RAMP TO BE REMOVED AND REPLACED KEYNOTES south jordan, ut 84009 DESCRIPTION 801.417.9951 www.triodesigninc.com RELOCATED EQUIPMENT CONRETE REPLACEMENT CONCRETE STEPS CONCRETE RAMP CONCRETE SLAB-ON-GRADE PRESSURE TREATED SOLE PLATE 2x4 FRAMING @ 16" O.C. 2x6 FRAMING @ 12" O.C. NEW PULPIT FLOOR SHEATHING 3/4" PANEL PRODUCT MALL SHEATHING JOIST HANGER PLASTIC LAMINATE COUNTERTOP HARDMOOD CHAIRAIL HARDWOOD TRIM HARDWOOD RAILING EXISTING PLATFORM FRAMING TO REMAIN FIBERGLASS CAVITY INSULATION 20 HOLLOW METAL FRAME FLUSH WOOD DOOR 22 GYPSUM CEILING 23 CERAMIC MALL TILE PAVER FLOOR TILE INTERIOR PAINTED GYPSUM BOARD CARPET BASE SHEET CARPET SISAL WALL COVERING GRAB BARS METAL TOILET COMPARTMENT 30 SOAP DISPENSER N.I.C. TOMEL DISPENSER N.I.C. DOUBLE ROLL TOILET PAPER DISPENSER SANITARY NAPKIN DISPOSAL UNIT BABY CHANGING STATION MIRROR WITH ALUMINUM FRAME METAL SHELF 38 MOP RACK NEW SEATING FRAMED ADA RAMP

FEXTEND HANDRAIL 12"
BEYOND TOP OF
RAMP & RETURN TO

RADE OREM 10 UP 4 1, AD PARK  $\sum_{i=1}^{N}$ RESTROC 50 SOUTH Project For:

4040 w. daybreak pkwy #110

10-17-18

THE CHURCH OF

JESUS CHRIST

OF LATTER-DAY SAINTS

Revisions:

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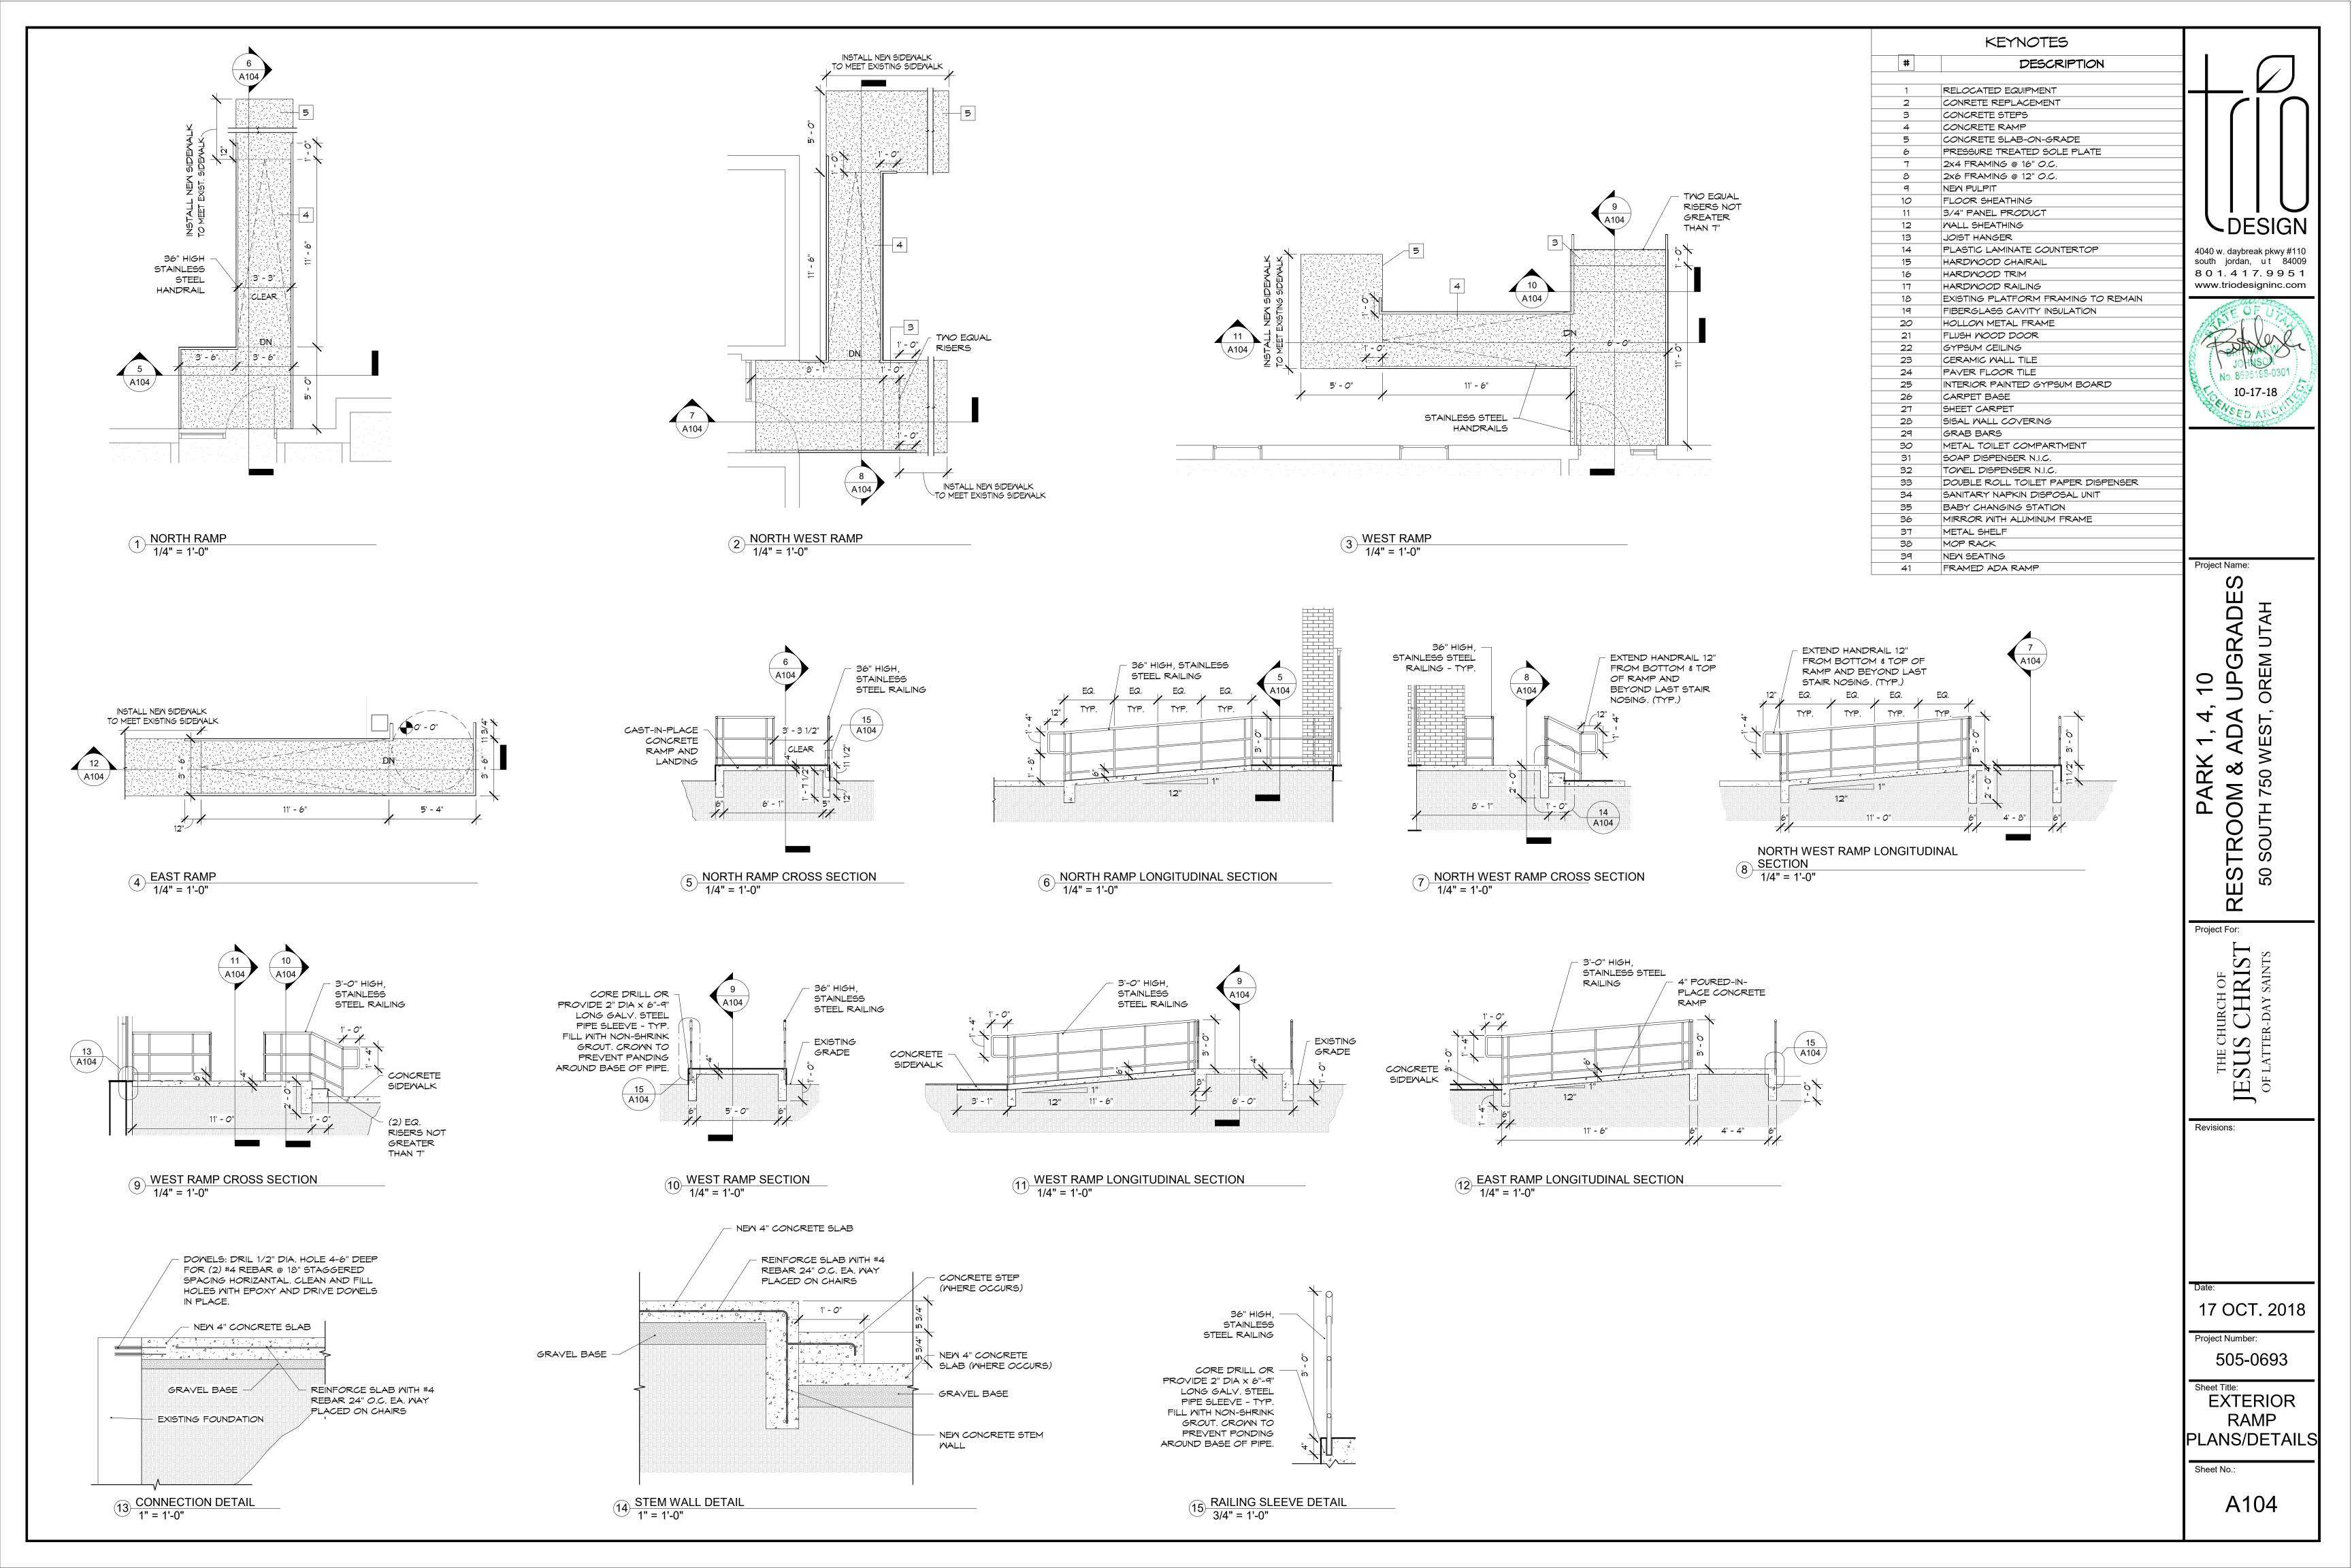
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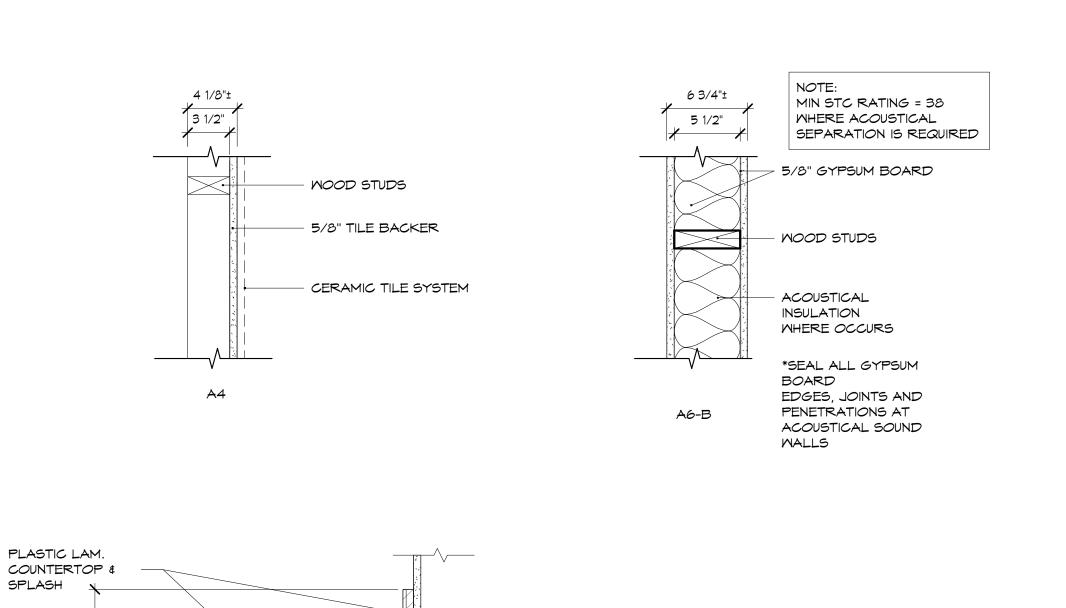
505-0693

**ENLARGED** ROSTRUM PLAN/DETAILS

Sheet No.:

A103





5/8" GYP. BD.

2X6 FRAMING

TILE - WHERE

FILL FRAME WITH

OCCURS

1' - 10"

COUNTER TOP SECTION

1x4 WOOD FRAMING

2X8 BLOCKING BETWEEN

5/16" x 2" METAL BRACKETS

ANCHOR SECURELY WITH 3/8"


BRACKETS AT 30" MIN. CLEAR)


STUDS FOR BRACKET


LAG BOLTS (SPACE

MOOD SCREMS

LAG BOLTS

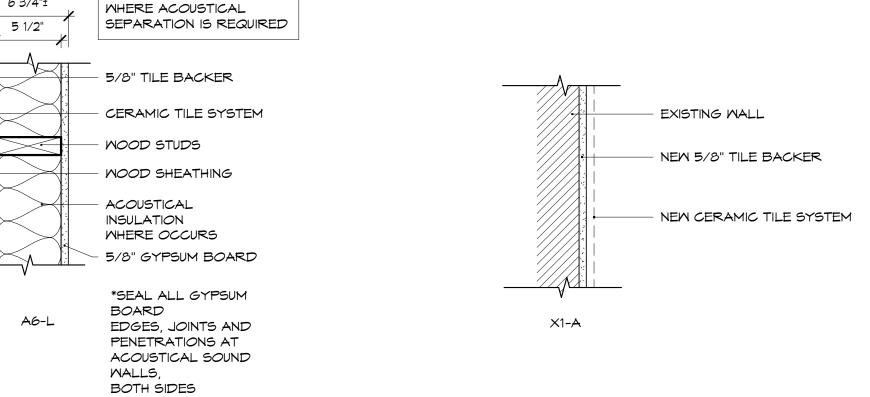

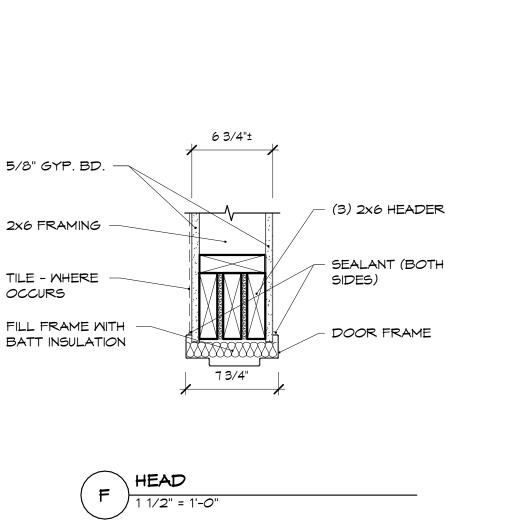


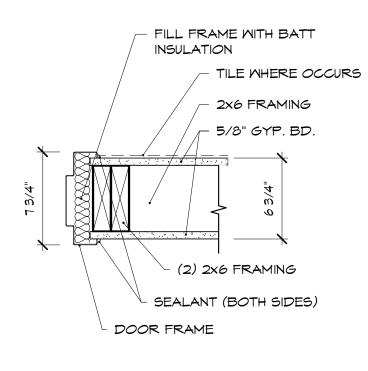



NOTE:

6 3/4"±

MIN STC RATING = 40

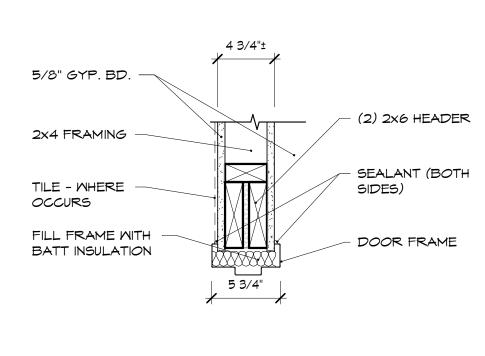


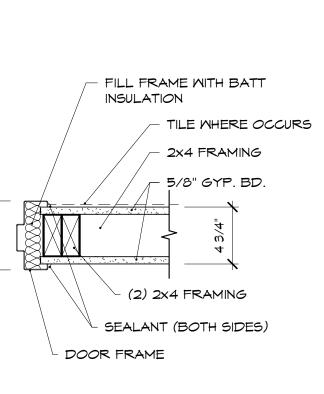

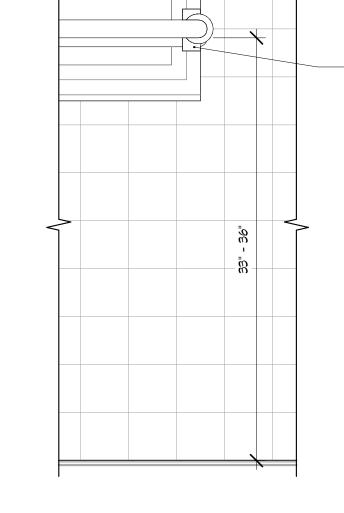

	HEAD		
(F)	1 1/2" = 1'-0"		

JAMB	
G 1 1/2" = 1'-0"	

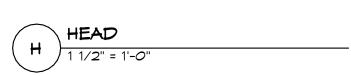





2X BLOCKING SECURED TO


SIDE WALL TO

BE FINISHED MITH TILE TO MATCH WALL

THE JAMB

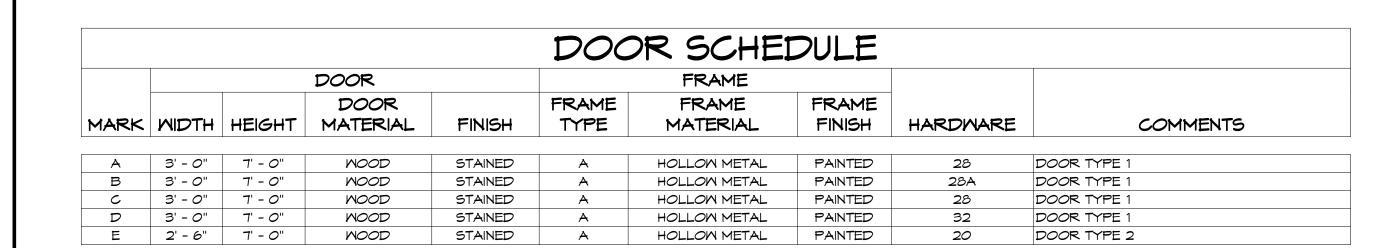

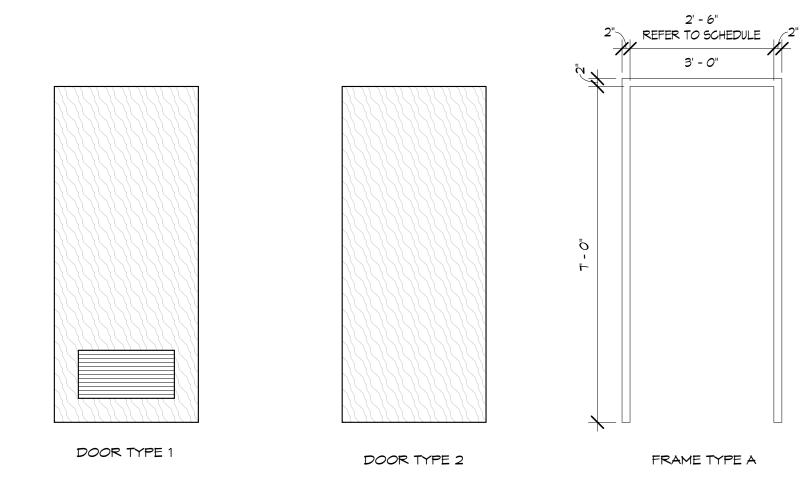

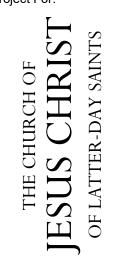

Project For:

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10-17-18

GRADE

7, AD,

 $\overline{\mathbb{Q}}$ 

OREM UTAH

750

I

RESTROC 50 SOUTH


Revisions:

17 OCT. 2018

505-0693

WALL TYPES & DOOR SCHEDULE

A401

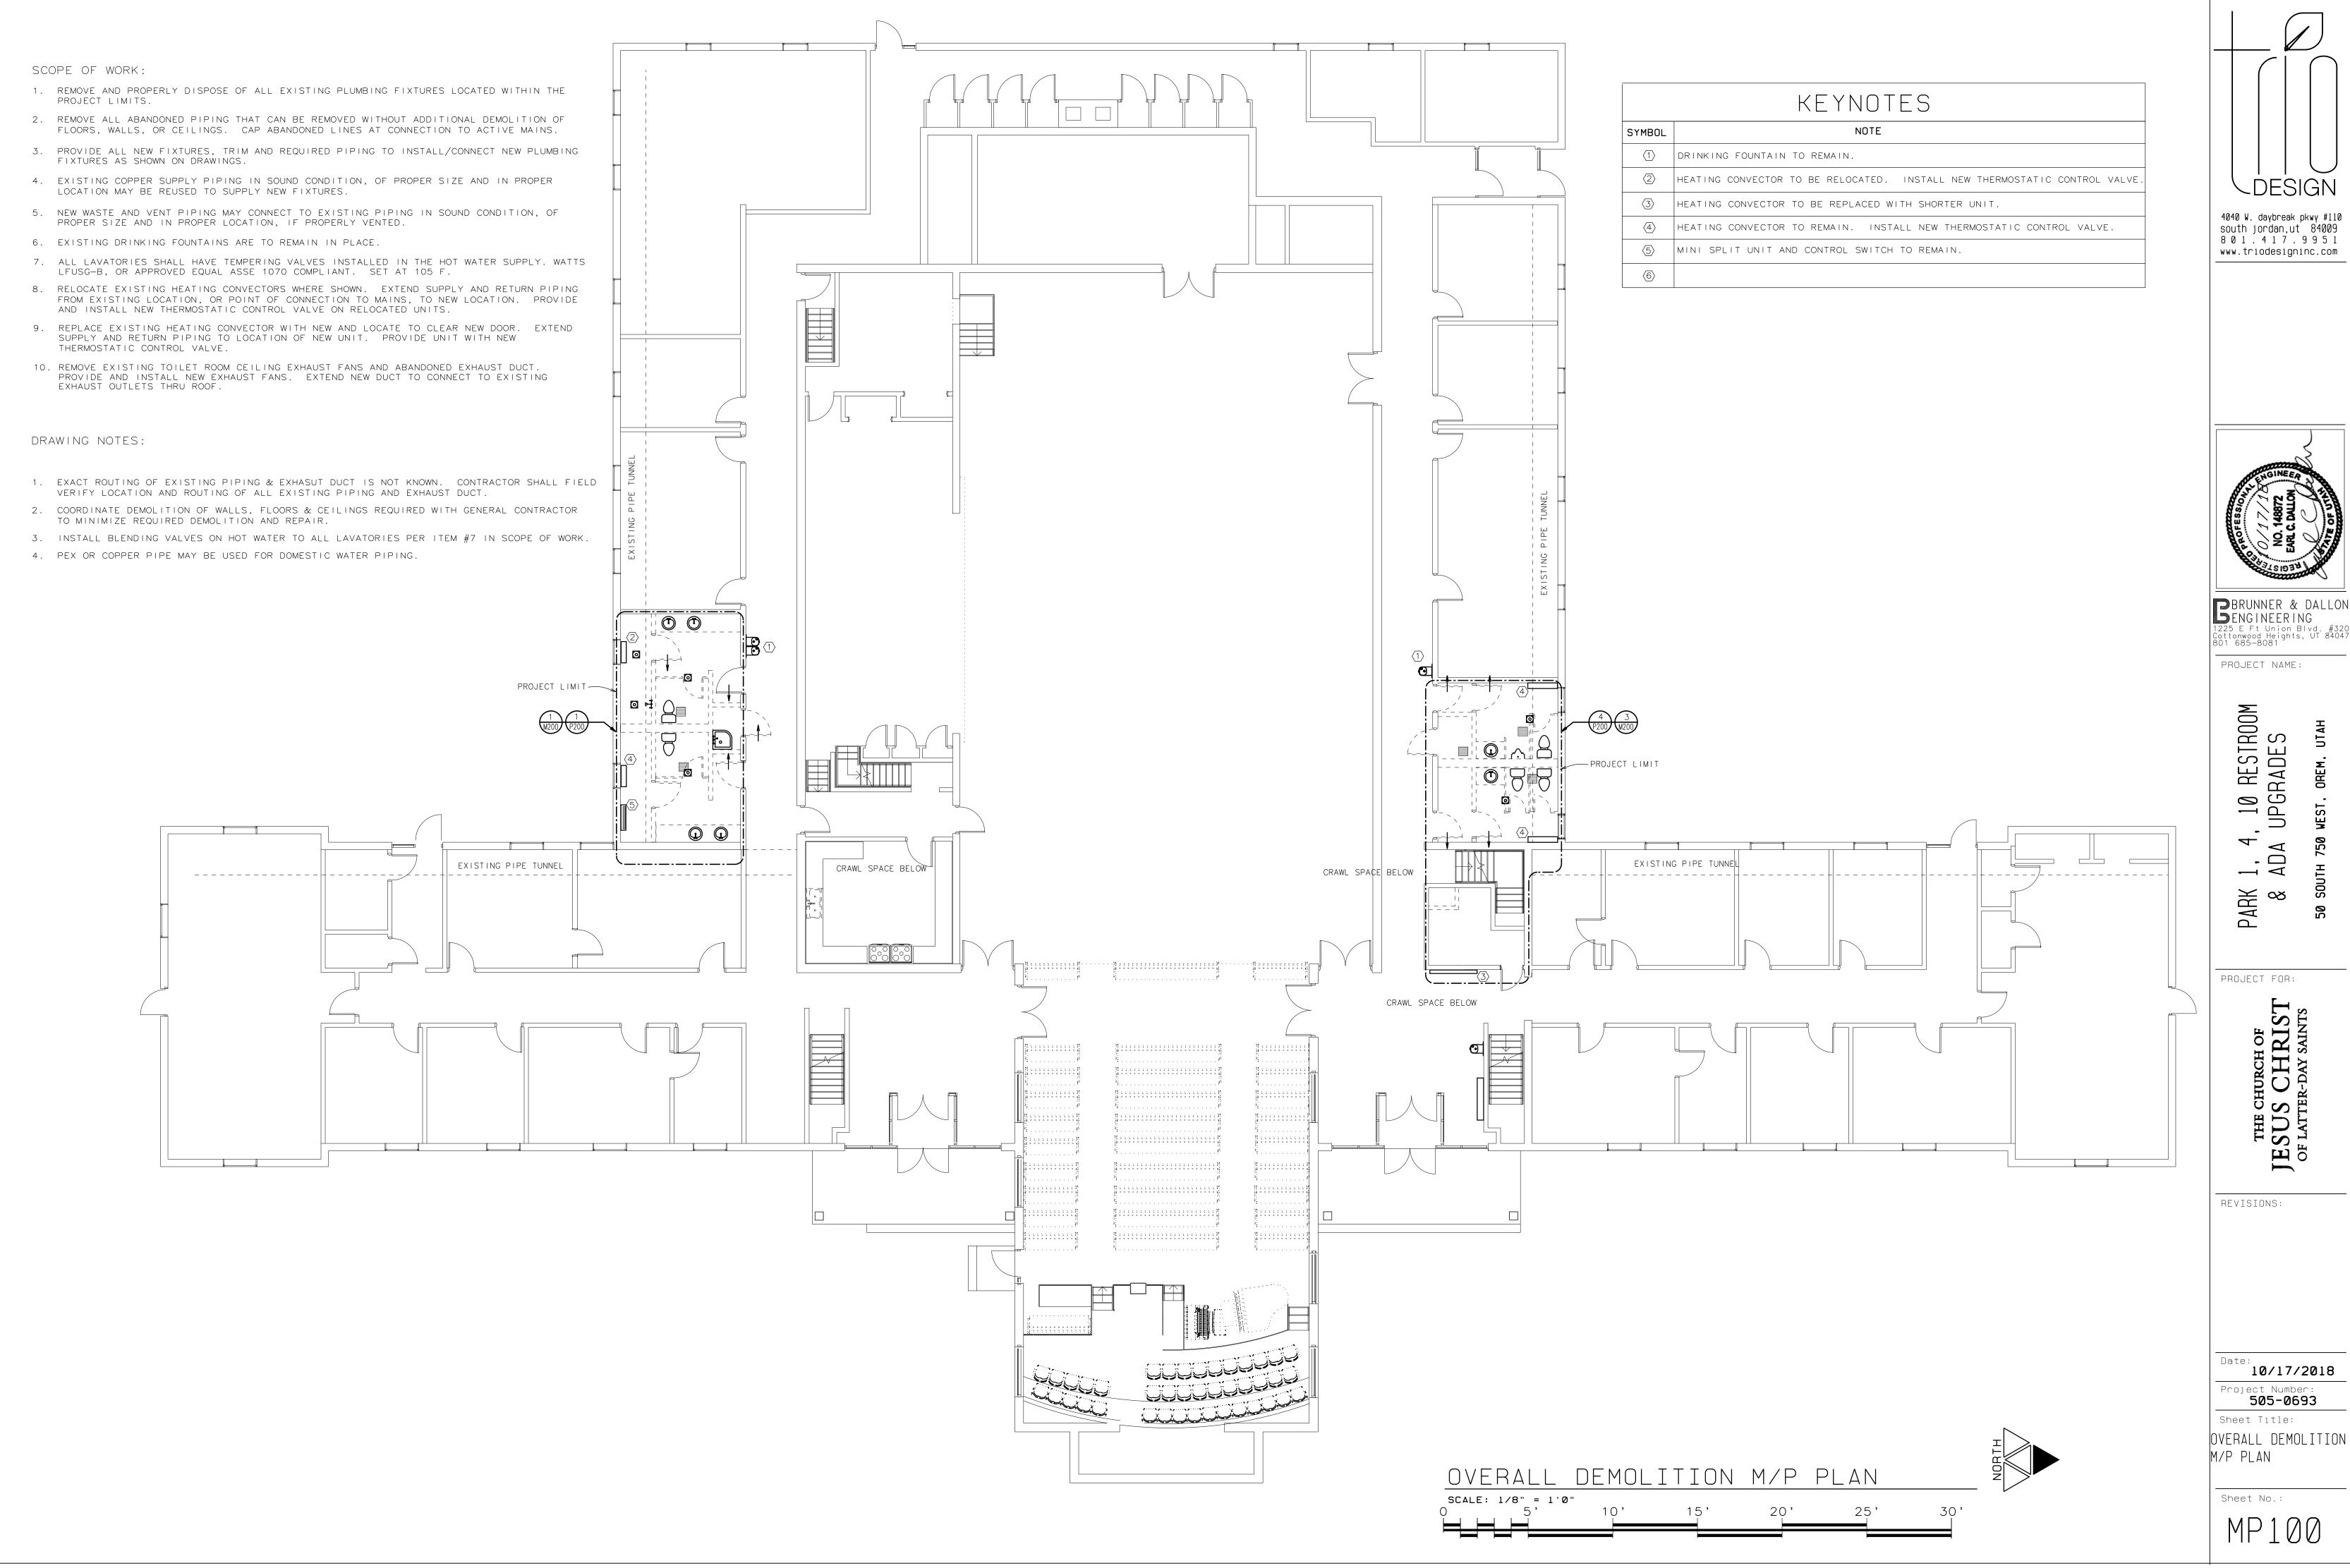

ENGINEERING 225 E Ft Union Blvd. #320 ottonwood Heights, UT 84047 801 685—8081

PROJECT NAME:

RESTROOM SRADES 0 GF 1, 4 ADA PARK 8


PROJECT FOR:

10/17/2018

Project Number: **505-0693** 

Sheet Title: OVERALL DEMOLITION M/P PLAN

MP100

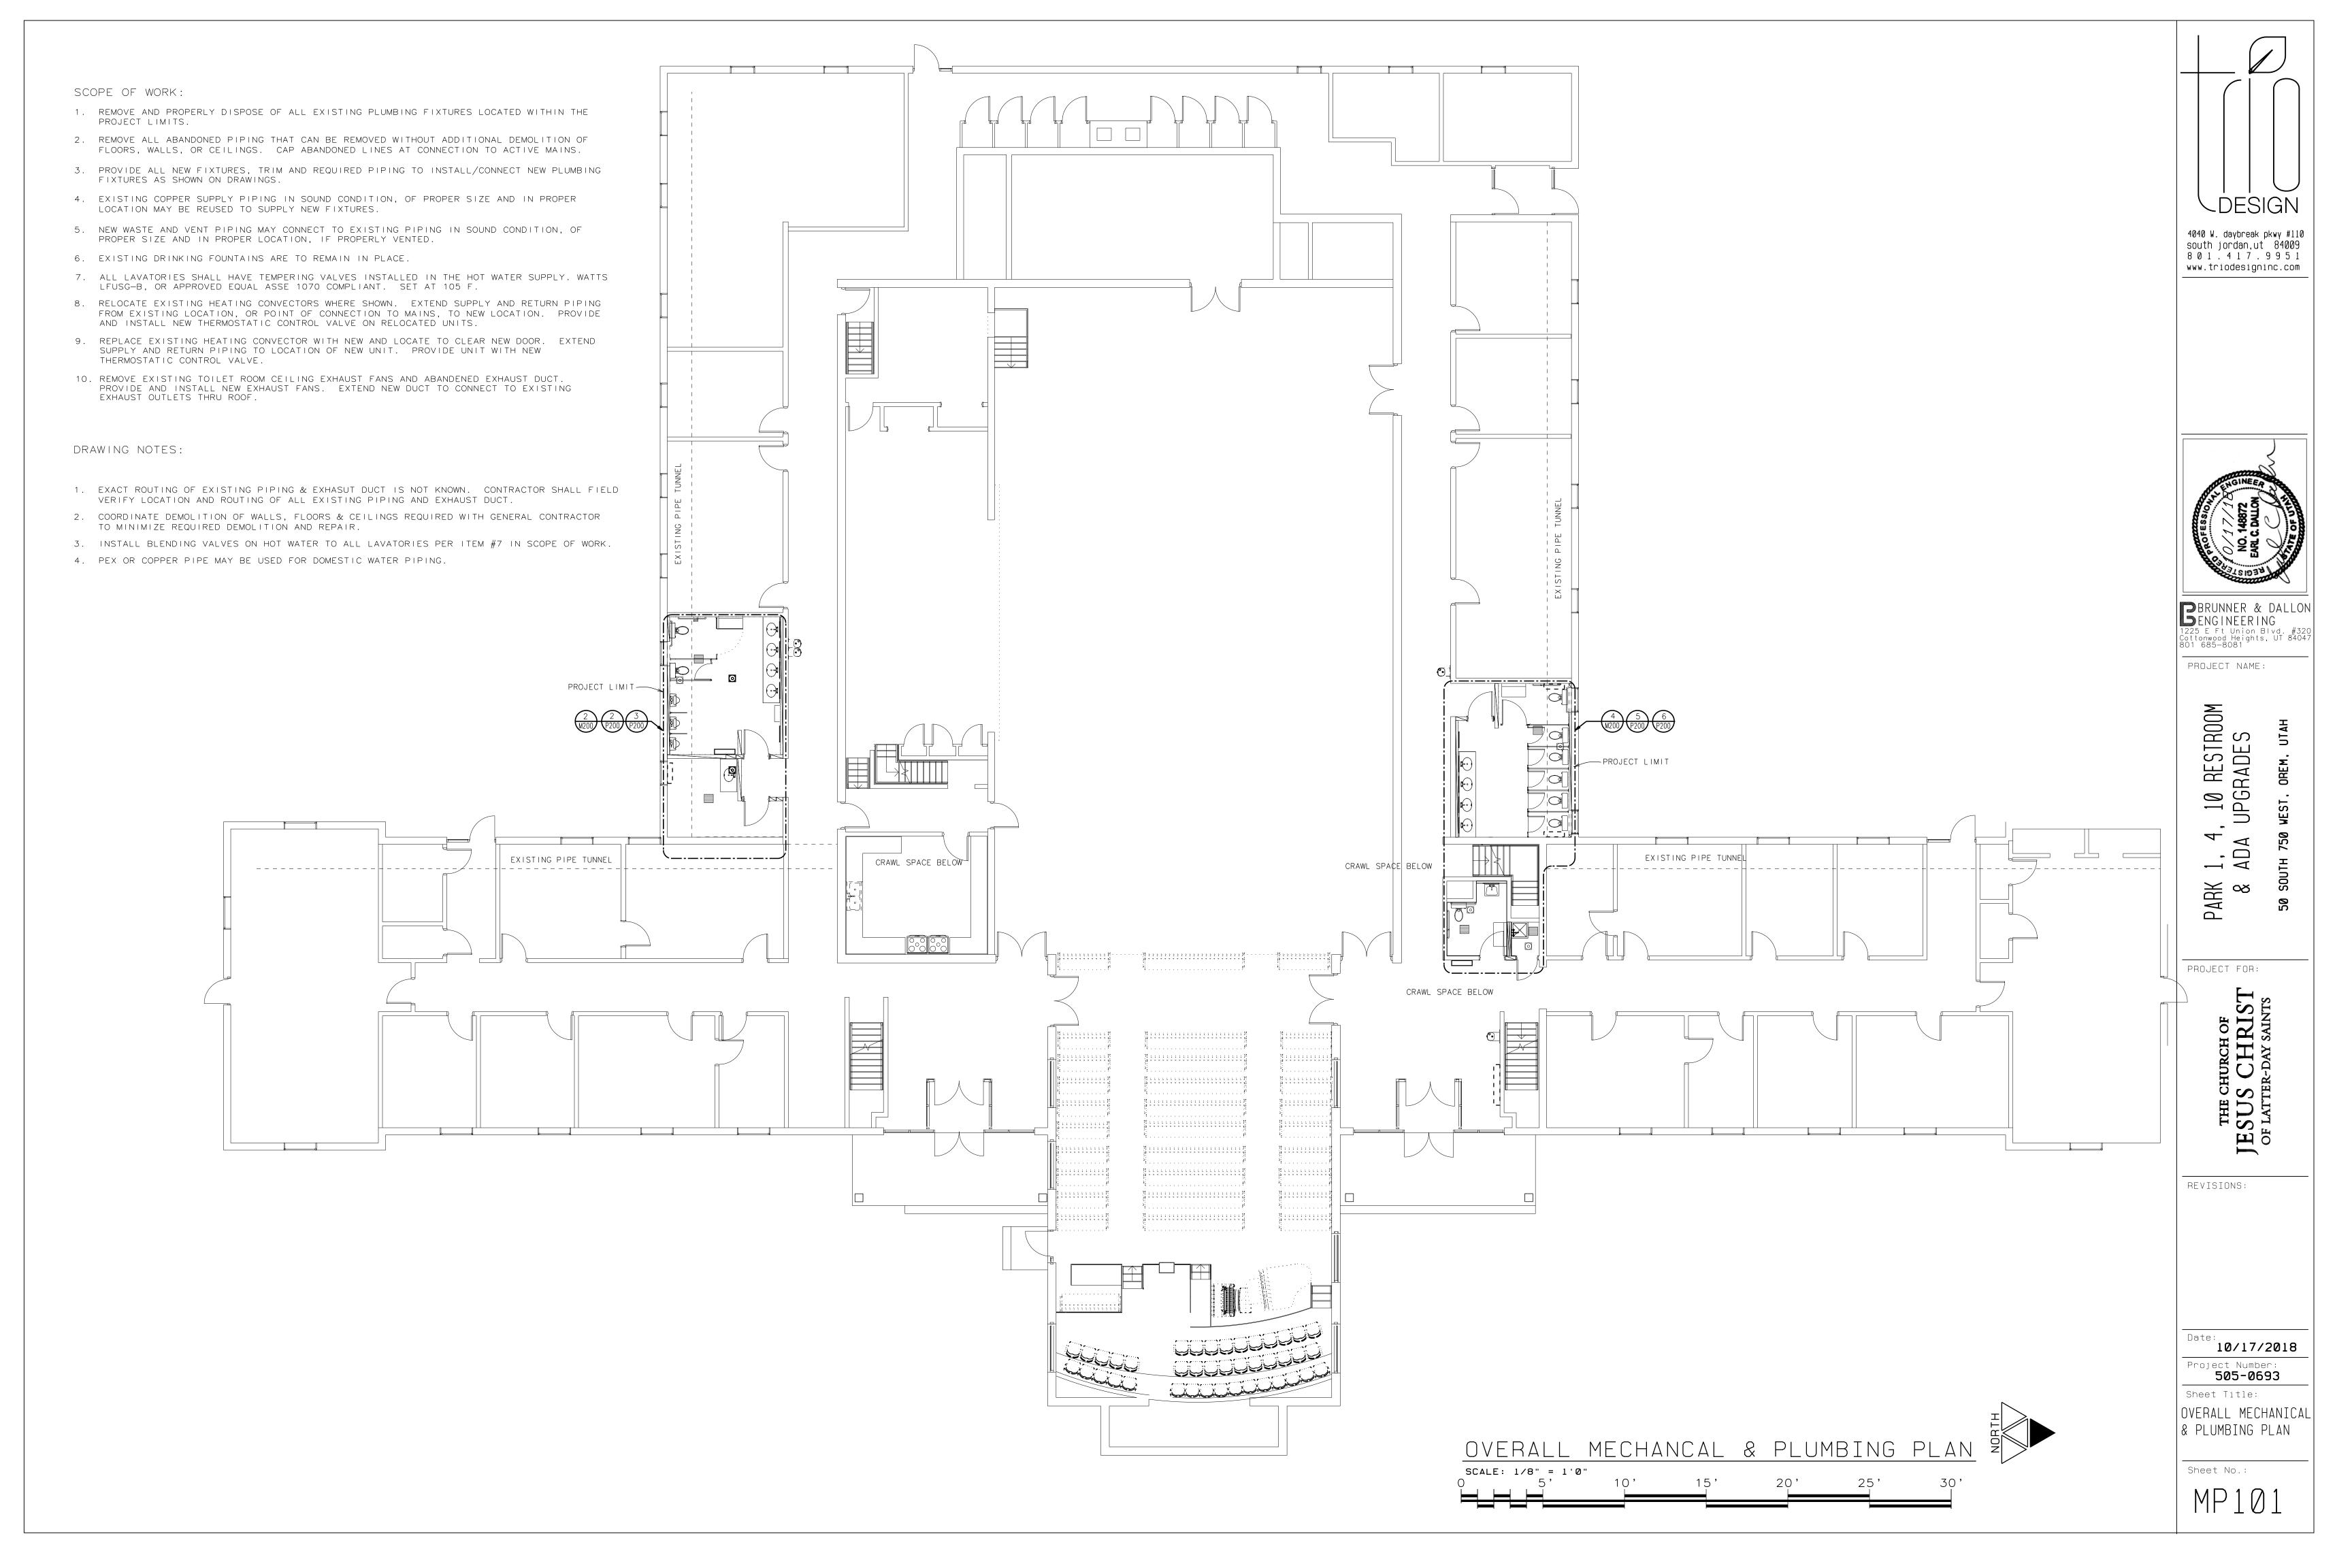

	KEYNOTES					
SYMBOL	NOTE					
1	DRINKING FOUNTAIN AND EXISTING WASTE, VENT & WATER PIPING TO REMAIN.					
2	REMOVE EXISTING HEATING CONVECTOR. UNIT TO BE RELOCATED TO NEW WALL. CAP SUPPLY AND RETURN PIPING AT MAIN OR SHUTOFF VALVES PENDING NEW INSTALLATION					
3	REMOVE EXISTING HEATING CONVECTOR. CAP SUPPLY AND RETURN PIPING AT MAIN OR SHUTOFF VALVES PENDING NEW INSTALLATION.					
4	HEATING CONVECTOR TO REMAIN. INSTALL NEW THERMOSTATIC CONTROL VALVE.					
(5)	MINI SPLIT UNIT AND CONTROL SWITCH TO REMAIN.					
<b>6</b>	NEW HEATING CONVECTOR LOCATION. INSTALL NEW THERMOSTATIC CONTROL VALVE. EXTEND PIPING FROM MAIN OR ORIGINAL LOCATION IN TUNNEL, RISE IN NEW WALL AND RUN IN WALL TO NEW UNIT LOCATION.					
7	NEW HEATING CONVECTOR IS SHORTER THAN ORIGINAL. OFFSET SUPPLY AND RETURN PIPING IN CRAWL SPACE TO MAKE CONNECTIONS TO NEW UNIT.					
8	REMOVE EXISTING CEILING EXHAUST FAN AND CONNECTED DUCT THAT IS NOT REUSEABLE. EXISTING POWER MAY BE UTILIZED FOR NEW FAN.					
9	INSTALL NEW CEILING EXHAUST FAN AS SCHEDULED. EXTEND EXHAUST DUCT IN ATTIC TO NEAREST EXISTING EXHAUST VENT UP THRU ROOF. FAN TO SWITCH ON WITH ROOM LIGHTS AND REMAIN ON FOR 5 MINUTES AFTER LIGHT IS OFF. FIELD VERIFY EXISTING ROOF EXHAUST LOCATION.					

MECHANICAL PLAN

SCALE 1/4" = 1'0"

<u>2</u> M200

MECHANICAL DEMOLITION PLAN (1)

SCALE 1/4" = 1'0"


KEYNOTES
NOTE
RINKING FOUNTAIN AND EXISTING WASTE, VENT & WATER PIPING TO REMAIN.
MOVE EXISTING HEATING CONVECTOR. UNIT TO BE RELOCATED TO NEW WALL. CAP
PPLY AND RETURN PIPING AT MAIN OR SHUTOFF VALVES PENDING NEW INSTALLATION MOVE EXISTING HEATING CONVECTOR. CAP SUPPLY AND RETURN PIPING AT
IN OR SHUTOFF VALVES PENDING NEW INSTALLATION.
ATING CONVECTOR TO REMAIN. INSTALL NEW THERMOSTATIC CONTROL VALVE.
NI SPLIT UNIT AND CONTROL SWITCH TO REMAIN.
W HEATING CONVECTOR LOCATION. INSTALL NEW THERMOSTATIC CONTROL VALVE. TEND PIPING FROM MAIN OR ORIGINAL LOCATION IN TUNNEL, RISE IN NEW WALL D RUN IN WALL TO NEW UNIT LOCATION.
W HEATING CONVECTOR IS SHORTER THAN ORIGINAL. OFFSET SUPPLY AND RETURN PING IN CRAWL SPACE TO MAKE CONNECTIONS TO NEW UNIT.
MOVE EXISTING CEILING EXHAUST FAN AND CONNECTED DUCT THAT IS NOT JSEABLE. EXISTING POWER MAY BE UTILIZED FOR NEW FAN.

SYMBOL ITEM CAPACITY (1) ELECTRICAL OPTIONS  EF-1 CEILING EXHAUST FAN 80 CFM © 0.25" ESP 120 1 WITH ROOM AFTER LIGHTS  EF-2 CEILING EXHAUST FAN 125 CFM © 0.25" ESP 120 1 WITH ROOM AFTER LIGHTS  AFTER LIGHTS	
EXHAUST FAN 80 CFM @ 0.25" ESP 120 1 LIGHTS AFTER LIGHTS  EXHAUST FAN 125 CFM @ 0.25" ESP 120 1 WITH ROOM 5 MINUTE ON	
	DELAY S OFF
EF-3 CEILING 450 CFM @ 0.25" ESP 120 1 WITH ROOM 5 MINUTE ON AFTER LIGHTS	
UC-1 HEATING 40" LENGTH, 6" DEEP CASE ADJ DAMPER ATTHERMOSATIC N	


	5RILL			E		
SYMBOL	LOCATION	SERVICE	CORE	FRAME	FINISH	
DG-1	DOOR	TRANSFER	DOOR	FLANGE	PAINT TO MATCH DOOR	

## DRAWING NOTES:

- 1. EXACT ROUTING OF EXISTING PIPING & DUCT IS NOT KNOWN. CONTRACTOR SHALL FIELD VERIFY LOCATION AND ROUTING OF ALL EXISTING PIPING & EXHAUST DUCT.
- 2. COORDINATE DEMOLITION OF WALLS, FLOORS & CEILINGS REQUIRED WITH GENERAL CONTRACTOR TO MINIMIZE REQUIRED DEMOLITION AND REPAIR.
- 3. EXTEND HEATING WATER SUPPLY & RETURN PIPING FROM LOCATION OF EXISTING CONVECTOR OR BRANCH CONNECTION TO MAIN TO NEW CONVECTOR LOCATION. RUN LINES IN TUNNEL, CRAWL SPACE, OR IN NEW WALLS WHERE POSSIBLE.

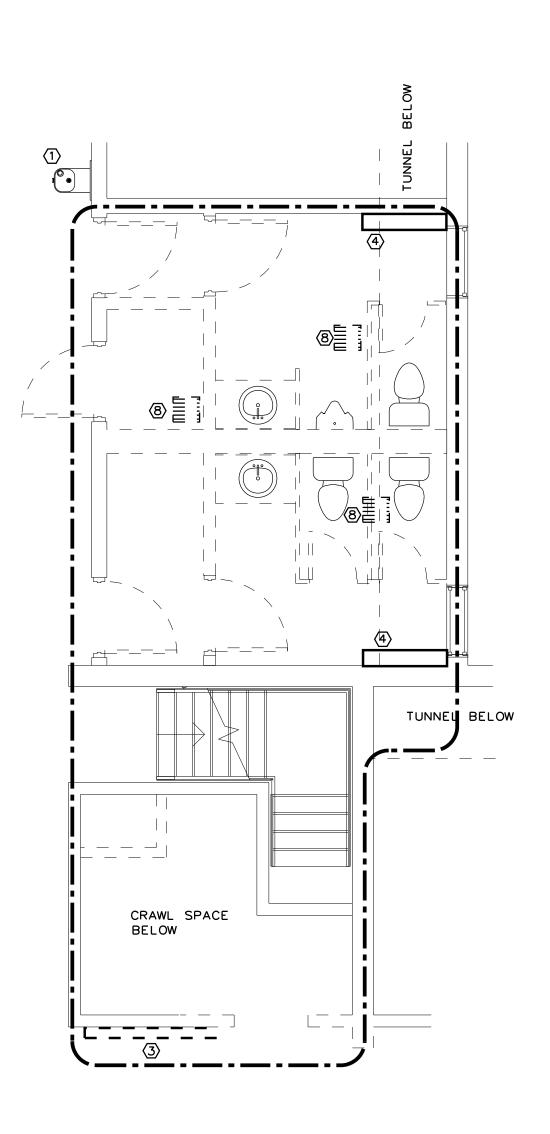





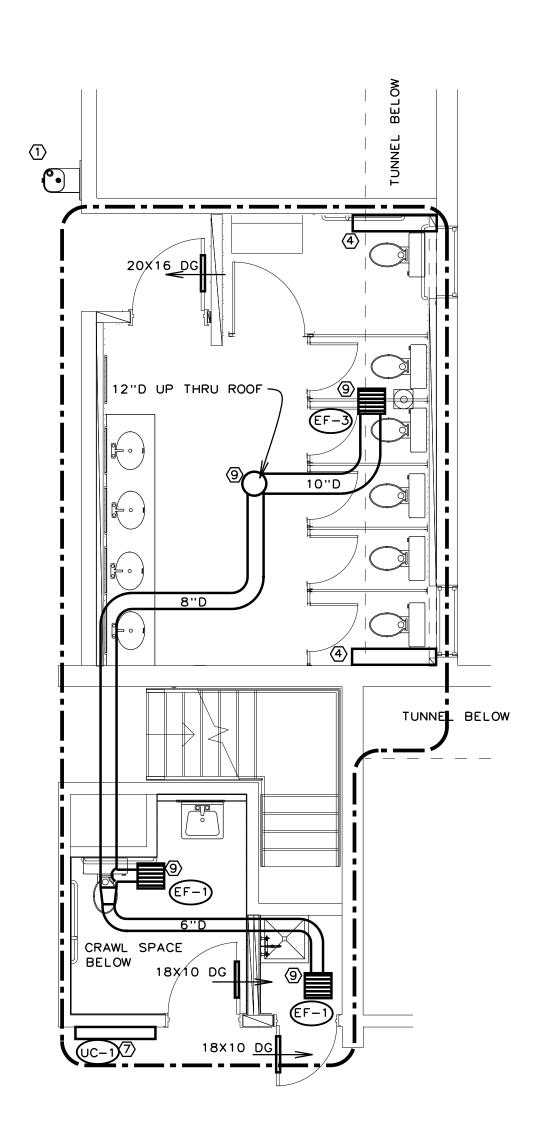


MECHANICAL PLAN SCALE 1/4" = 1'0"



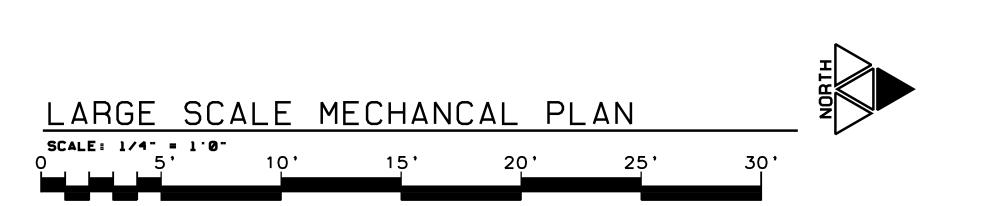

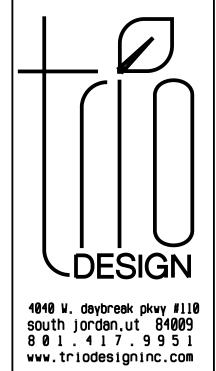

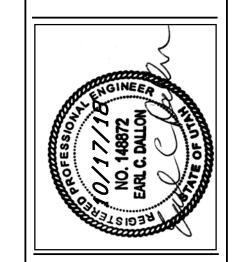

ENGINEERING

1225 E Ft Union Blvd. #320
Cottonwood Heights, UT 84047
801 685-8081

PROJECT NAME:

O RESTROOM 1, 4 ADA PARK &

PROJECT FOR:

REVISIONS:

Date: 10/17/2018 Project Number: **505-0693** 

Sheet Title: LARGE SCALE MECHANICAL PLAN

Sheet No.:

M200

	KEYNOTES						
SYMBOL	NOTE						
1	DRINKING FOUNTAIN AND EXISTING WASTE, VENT & WATER PIPING TO REMAIN.						
2	REMOVE ALL EXISTING PLUMBING FIXTURES AND PIPING IN REMOVED WALLS. CAP BELOW FLOOR, BEHIND WALL SURFACE, OR AT ACTIVE MAIN.						
3	HEATING CONVECTOR TO BE REPLACED WITH SHORTER UNIT.						
4	HEATING CONVECTOR TO REMAIN. INSTALL NEW THERMOSTATIC CONTROL VALVE.						
(5)	MINI SPLIT UNIT AND CONTROL SWITCH TO REMAIN.						
6	HEATING CONVECTOR TO BE MOVED. INSTALL NEW THERMOSTATIC CONTROL VALVE.						
7	1/2"CW TO RISE IN NEW FURRED WALL TO TOILET ABOVE.						
8	1"CW TO CONNECT TO EXISTING 1 1/4" CW IN TUNNEL BELOW. DRILL THRU FOUNDATION WALL.						
9	3/4" CW & HW TO CONNECT TO EXISTING 1 1/4"CW AND 1" HW IN CRAWL SPACE. DRILL THRU FOUNDATION WALL AND RISE IN NEW FURRED WALL.						
10	1/2" CW & HW TO RUN IN NEW FURRED WALL AND RISE TO SINKS.						
11)	3/4" CW & HW TO CONNECT TO EXISTING 1 1/4"CW AND 1" HW IN CRAWL SPACE.						
(12)	CONNECT 1" CW & 3/4"HW TO EXISTING 1 1/4"CW AND 1"HW IN TUNNEL BELOW.						
(13)	3/4"CW TO RISE IN NEW FURRED WALL TO URINAL ABOVE.						
(14)	CONNECT 1" CW & 3/4"HW TO EXISTING 1 1/4"CW AND 1"HW IN TUNNEL BELOW.						
(15)	CONNECT NEW 2"W TO EXISTING 4"W HERE. FIELD VERIFY LOCATION. DRILL THRU FOUNDATION WALL.						
<b>16</b>	CONNECT NEW 3"W TO EXISTING 4"W HERE. FIELD VERIFY LOCATION.						
⟨1⟩⟩	CONNECT NEW 4"W TO EXISTING 4"W HERE. FIELD VERIFY LOCATION. DRILL THRU FOUNDATION WALL.						
(18)	CONNECT EXISTING 2"W TO NEW 3"W HERE. FIELD VERIFY LOCATION.						

SCALE 1/4" = 1'0"


SCALE 1/4" = 1'0"

SCALE 1/4" = 1'0"


	PLUMBING FIXTURE SCHEDULE									
SYMBOL	FIXTURE	SUPPLY PIPE SIZE				•		TRIM		NOTE
		TRAP	WASTE	VENT	COLD	нот	REMARKS	VALVE	STOP	1
P-1	WATER CLOSET	INT	3	2	1/2	-	FLUSH TANK FLOOR MOUNT 1.6 GPF	INTEGRAL	YES	
(P-2)	WATER CLOSET, HANDICAP	INT	3	2	1/2	-	FLUSH TANK FLOOR MOUNT 1.6 GPF, TRIP LEVER ON ACCESS SIDE	INTEGRAL	YES	
P-3	URINAL	2	2	2	3/4	-	WALL MOUNT, Ø.5 GPF	0.5 GPF FLUSH VALVE	INCL	
P-4	LAVATORY	1 1/4	1 1/2	1 1/2	1/2	1/2	SELF RIM, 110 F TEMPERING VALVE, GRID DRAIN	1.5 GPM	YES	1 & 2
P-5	LAVATORY	1 1/4	1 1/2	1 1/2	1/2	1/2	WALL HUNG, 110 F TEMPERING VALVE, GRID DRAIN	1.5 GPM	YES	1 & 2
P-6	FLOOR DRAIN	2	2	2	-	-	SLOPE FLOOR TO DRAIN, TRAP GUARD		-	
P-7	MOP SINK	3	3	2	1/2	1/2	FLOOR MOUNT		INCL	
NOTES	TES 1. PROVIDE PRO WRAP DRAIN AND STOP INSULATION SYSTEM ON ALL SINKS WITH EXPOSED DRAIN PIPING. 2. TEMPERING VALVE TO BE INSTALLED UNDER SINK AND SET TO 110 F.									

## DRAWING NOTES:


- 1. EXACT ROUTING OF EXISTING PIPING IS NOT KNOWN. CONTRACTOR SHALL FIELD VERIFY LOCATION AND ROUTING OF ALL EXISTING PIPING.
- 2. COORDINATE DEMOLITION OF WALLS, FLOORS & CEILINGS REQUIRED WITH GENERAL CONTRACTOR TO MINIMIZE REQUIRED DEMOLITION AND REPAIR.
- 3. INSTALL BLENDING VALVES ON HOT WATER TO ALL LAVATORIES PER ITEM #7 IN SCOPE OF WORK.
- 4. PEX OR COPPER PIPE MAY BE USED FOR DOMESTIC WATER PIPING.
- 5. HEATING WATER PIPING FOR CONVECTORS SHOWN ON SHEET M200.
- 6. BELOW SLAB WATER PIPING TO BE RUN INSIDE 1/2" RUBATEX INSULATION.

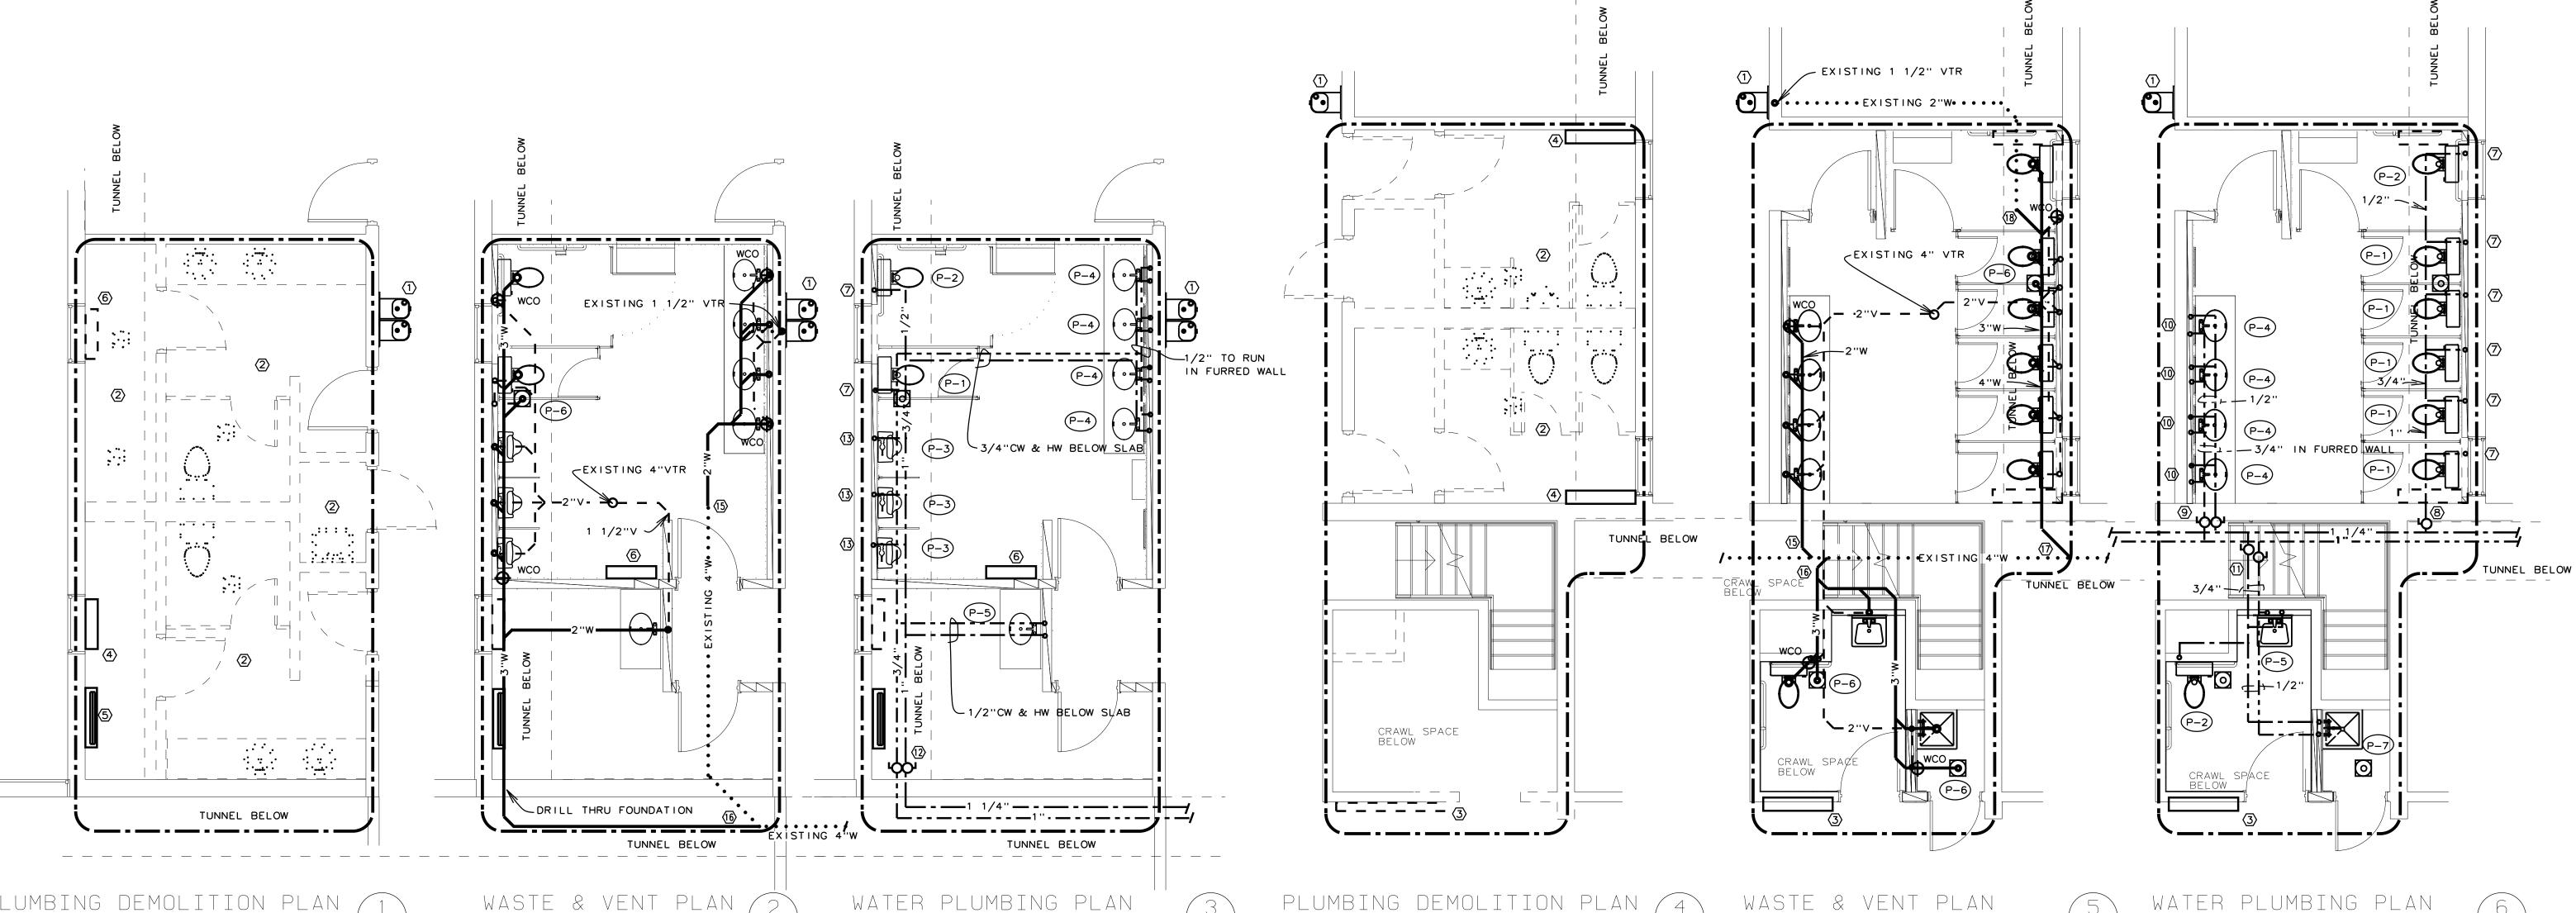

LARGE SCALE PLUMBING PLANS

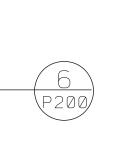

SCALE 1/4" = 1'0"

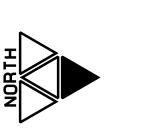

SCALE 1/4" = 1'0"

Date: 10/17/2018 Project Number: **505-0693** 

REVISIONS:

4040 W. daybreak pkwy #110 south jordan.ut 84009 8 0 1 . 4 1 7 . 9 9 5 1

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ENGINEERING

PROJECT NAME:

O RESTROOM

1, 4 ADA

PROJECT FOR:

225 E Ft Union Blvd. #320 ttonwood Heights, UT 8404: 01 685-8081

LARGE SCALE PLUMBING PLANS

Sheet Title:

Sheet No.:

P200