


							P	LOTTED	: 6	6/20/201	18 8:2	4 AM
n mounted per Archi sibility requirements			A									
MBING FI	XTUR	E SCI	HEDL	JLE		()						
FIXTURE			PIPE SIZE			REMARKS	JLE					
	TRAP	WASTE	VENT	C.W.	H.W.		CHED(
Water Closet	INT.	4"	2"	1/2"	-	Flush tank, HET (high efficiency toilet)	ISSUE S	iON				
Water Closet	INT.	4"	2"	1/2"	-	Flush tank, 18" rim height (ADA approved), HET	RAWING	DESCRIPTION Bid Documents				
_avatory	1-1/4"	1-1/4"	1-1/2"	1/2"	1/2"	Counter top 20"x17", See Architectural Elevations	Ľ	2018 Bid			+	
_avatory	1-1/4"	1-1/4"	1-1/2"	1/2"	1/2"	Self supporting 20"x18", see Architectural Elevations		DATE: 20 Jun 20				
Floor Drain	2"	2"	2"	-	-	With deep seal p-trap and trap seal. See detail C/P502		+ -				
ERAL PL	UMBI	NG NG	OTES	;	PL	UMBING DEMOLITION NOTES						
all immediately stop work in this area and notify owner. sting pipe locations and pipe sizes show have been taken m existing drawings. Contractor is to field determine exact e, elevation and location of existing piping inside the building specified connection points prior to starting any work. w cut or core drill all new penetrations through existing sonry construction. ch and repair all existing surfaces damaged by new instruction to match existing. molition - General: Remove all related piping and appurtenances. Remove branch piping completely and cap in main Patch and repair all existing surfaces (wall, roof, floor, ceiling, etc.)				exact building g	2. 3. 4. 5.	 plumbing plans for new piping connections. Field verify all existing locations. Existing 4" vent through roof to remain. Remove existing 2" waste piping as shown for replacement and re-sizing. Existing 1" CW and 3/4" HW up in plumbing chase. Existing 3/4" CW and HW to existing water heater (routed below grade). 						
model - General: Conceal all piping	equipment,	and appurt	enances u	nless	PL	UMBING KEYED NOTES						
otherwise noted. Remove existing s required and repla fer to Mechanical Dr plumbing shall com les, ordinances, or t fixtures shall be pro individual line sizes to the close proxin well as ductwork, ec mbing contractor sh chanical and sheet tect all plumbing pip istruction activities.	ace to match rawings for a ply with the r the Specifica operly vented s to fixtures, s nity of the wa quipment, an nall coordinate metal contra- ping which is	any addition most stringe ations. d to the atmo see Fixture ater, drain, a nd HVAC pip te the install actors. s to remain o	nal work. ent of appli osphere. e Schedule. and vent pi ping, the llation with during all	icable iping	1. 2. 3. 4. 5. 6. 7. 8.	Install new fixture. Reconnect to existing waste, vent, and supplies. Install new floor drain. Reconnect to existing waste. Install new fixture. Connect new waste, vent, and supplies to existing mains at plumbing wall. Connect new 2" vent to existing 4" VTR. Connect new waste to existing waste at this location. Connect new 3/4" CW to existing 1" main and route as shown below grade. Connect new 3/4" HW to existing 3/4" HW below grade. 3/4" CW and HW up in new plumbing wall.	STAMP:				.571.0010 .571.0303	3.571.0010
											801	ree: 888.5

	PLUMBING LEGEND							
	SYMBOL OR ABBREVIATION	MEANING	SYMBOL OR ABBREVIATION	MEANING				
OR	HOT WATER LINE		WALL CLEANOUT	WCO				
	COLD WATER LINE		CLEANOUT	СО				
	VENT LINE		FLOOR CLEANOUT	FCO				
	WASTE LINE		BALL VALVE	$\overline{\Phi}$				
	VENT THRU ROOF	VTR	UNION	 				
UG	EXISTING PIPE TO BE REMOVED	* * * * *	EXISTING FIXTURE TO BE REMOVED	[]0				

	ARCHITECTS 65 E Wadsworth Park Dr. Ste 205 Phone: 801.57	Draper, Utah 84020 Fax: 801.57 bhdarchitects.com Toll Free: 888.57			
THE CHURCH OF	OF LATTER-DAY SAINTS				
PROJECT NAME: Orchard 3, 7, Geneva Heights 8 Orem Utah Orchard Stake	810 East 600 North Orem, Utah	DATE: BHDA PROJECT #: PLAN SERIES: PROPERTY #: 20 Jun 2018 1815 506-3558			
SHEET TITLE: PLUMBING DEMOLITION PLANS AND NEW PLANS					
SHEET: P1	01				

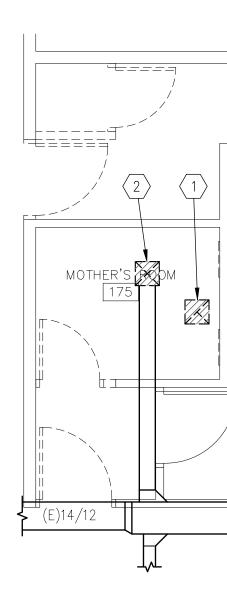





RE	REGISTER, LOUVER, & GRILLE SCHEDULE								
MARK	TYPE	TYPE SERV		CFM (1) RANGE	NOMINAL SIZE			REMARKS	3
DG-1	DOOR GRILLE 5	DOOR GRILLE 5 TRANS		150 - 300	2	24x12			
EXHAUST FAN SCHEDULE									
MARK	SERVES ROOM		MIN. S.C.F.M.	STATIC PRESSURI IN. W.G.	E	MINIMU WATT		REMARKS	
$\left\langle \begin{array}{c} EF \\ 1 \end{array} \right\rangle$	WOMEN 174		150	0.25		155W	1	0 2	
$\left\langle \begin{array}{c} EF\\ 2\end{array} \right\rangle$	WOMEN 175		75	0.25		81W		00	


CONTROL BY DIVISION 26.
VOLTAGE IS 115V / 1 PHASE / 60 HZ

DII	DIFFUSER SCHEDULE							
MARK	C.F.M. RANGE	DIFFUSER	NECK CONN.	BLOW		AIR DIST./SIDE		
MARK	C.F.M. RANGE	SIZE			PATTERN	A (%)	B (%)	
D-1	40 - 100	6X6	_{6X6} 4	3 WAY	&A ∢⊳B	38	31	
	REGISTER, GRILLE AND DIFFUSER SCHEDULE NOTES:							
①	MAXIMUM NC=25 ± MAXIMUM CFM NOTED.							
2	SHALL BE TITUS TDC TYPE 6 OR EQUAL BY OTHER APPROVED MANUFACTURERS. (SEE SPECIFICATIONS)							
3	SEE SPECIFICATIONS FOR APPROVED MANUFACTURERS.							
4	FINISH: OFF-WHITE BAKED ENAMEL.							
5	FINISH: AS SELECTED BY ARCHITECT TO MATCH DOOR.							

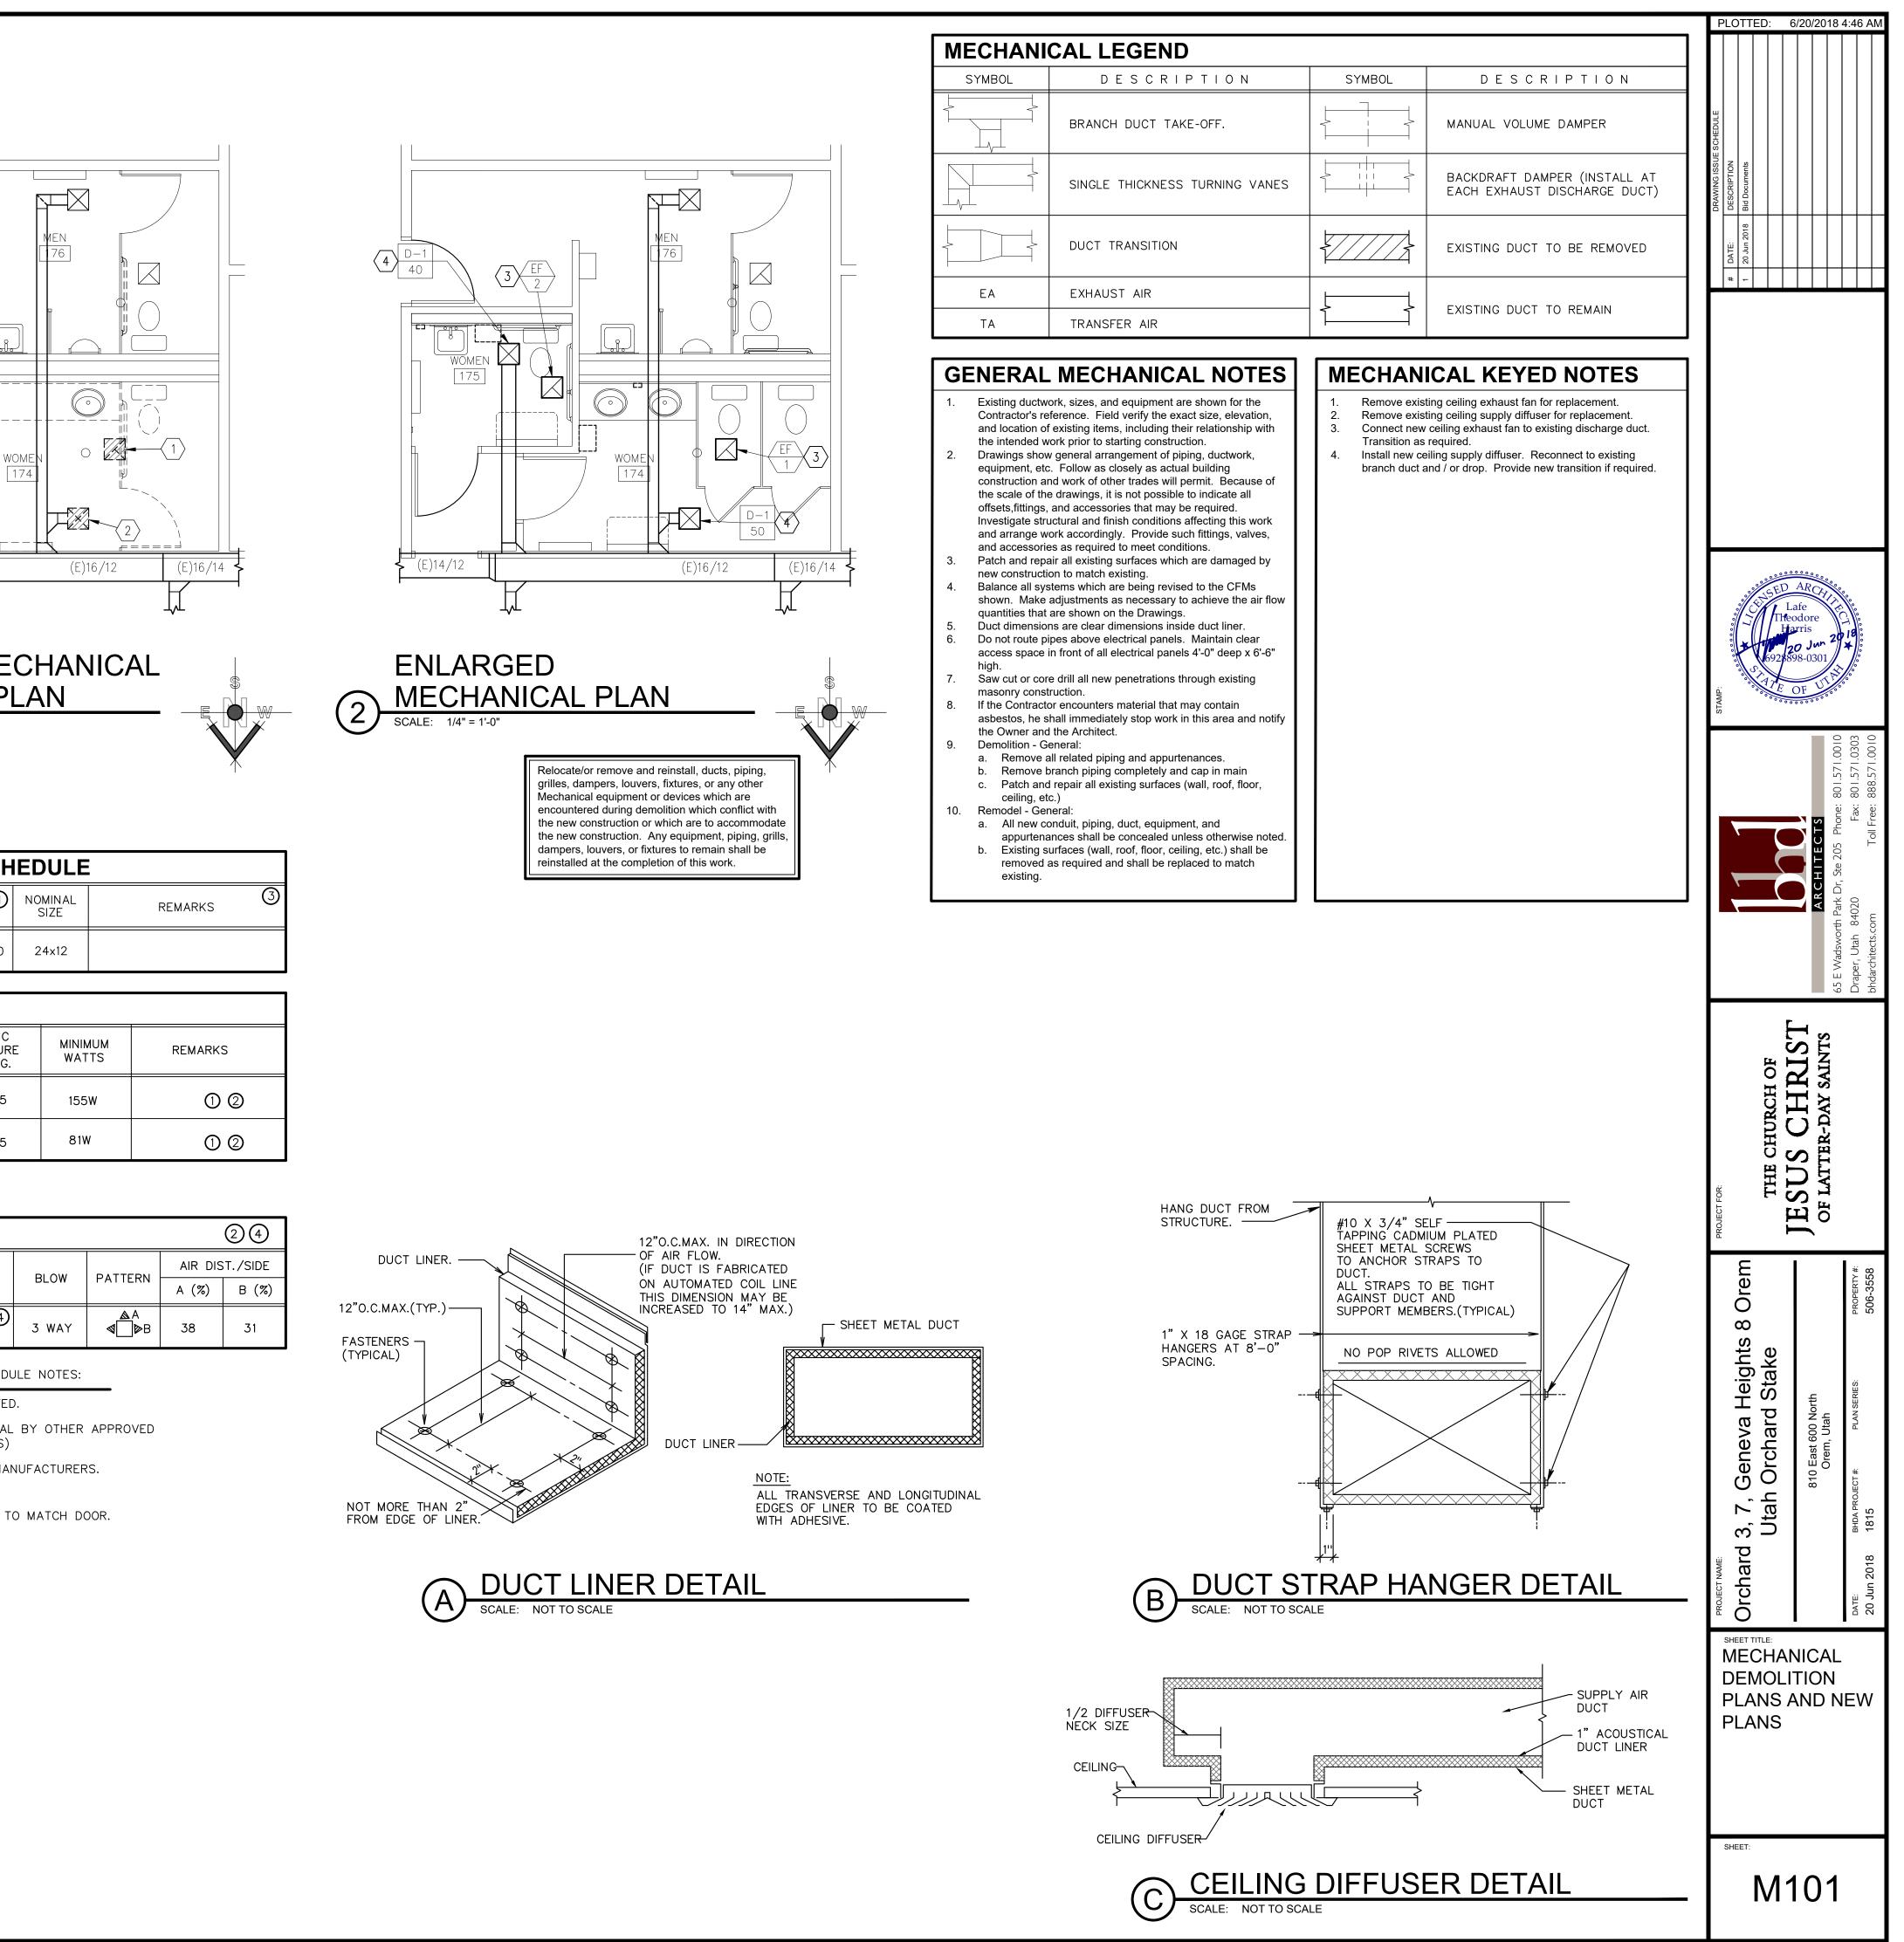


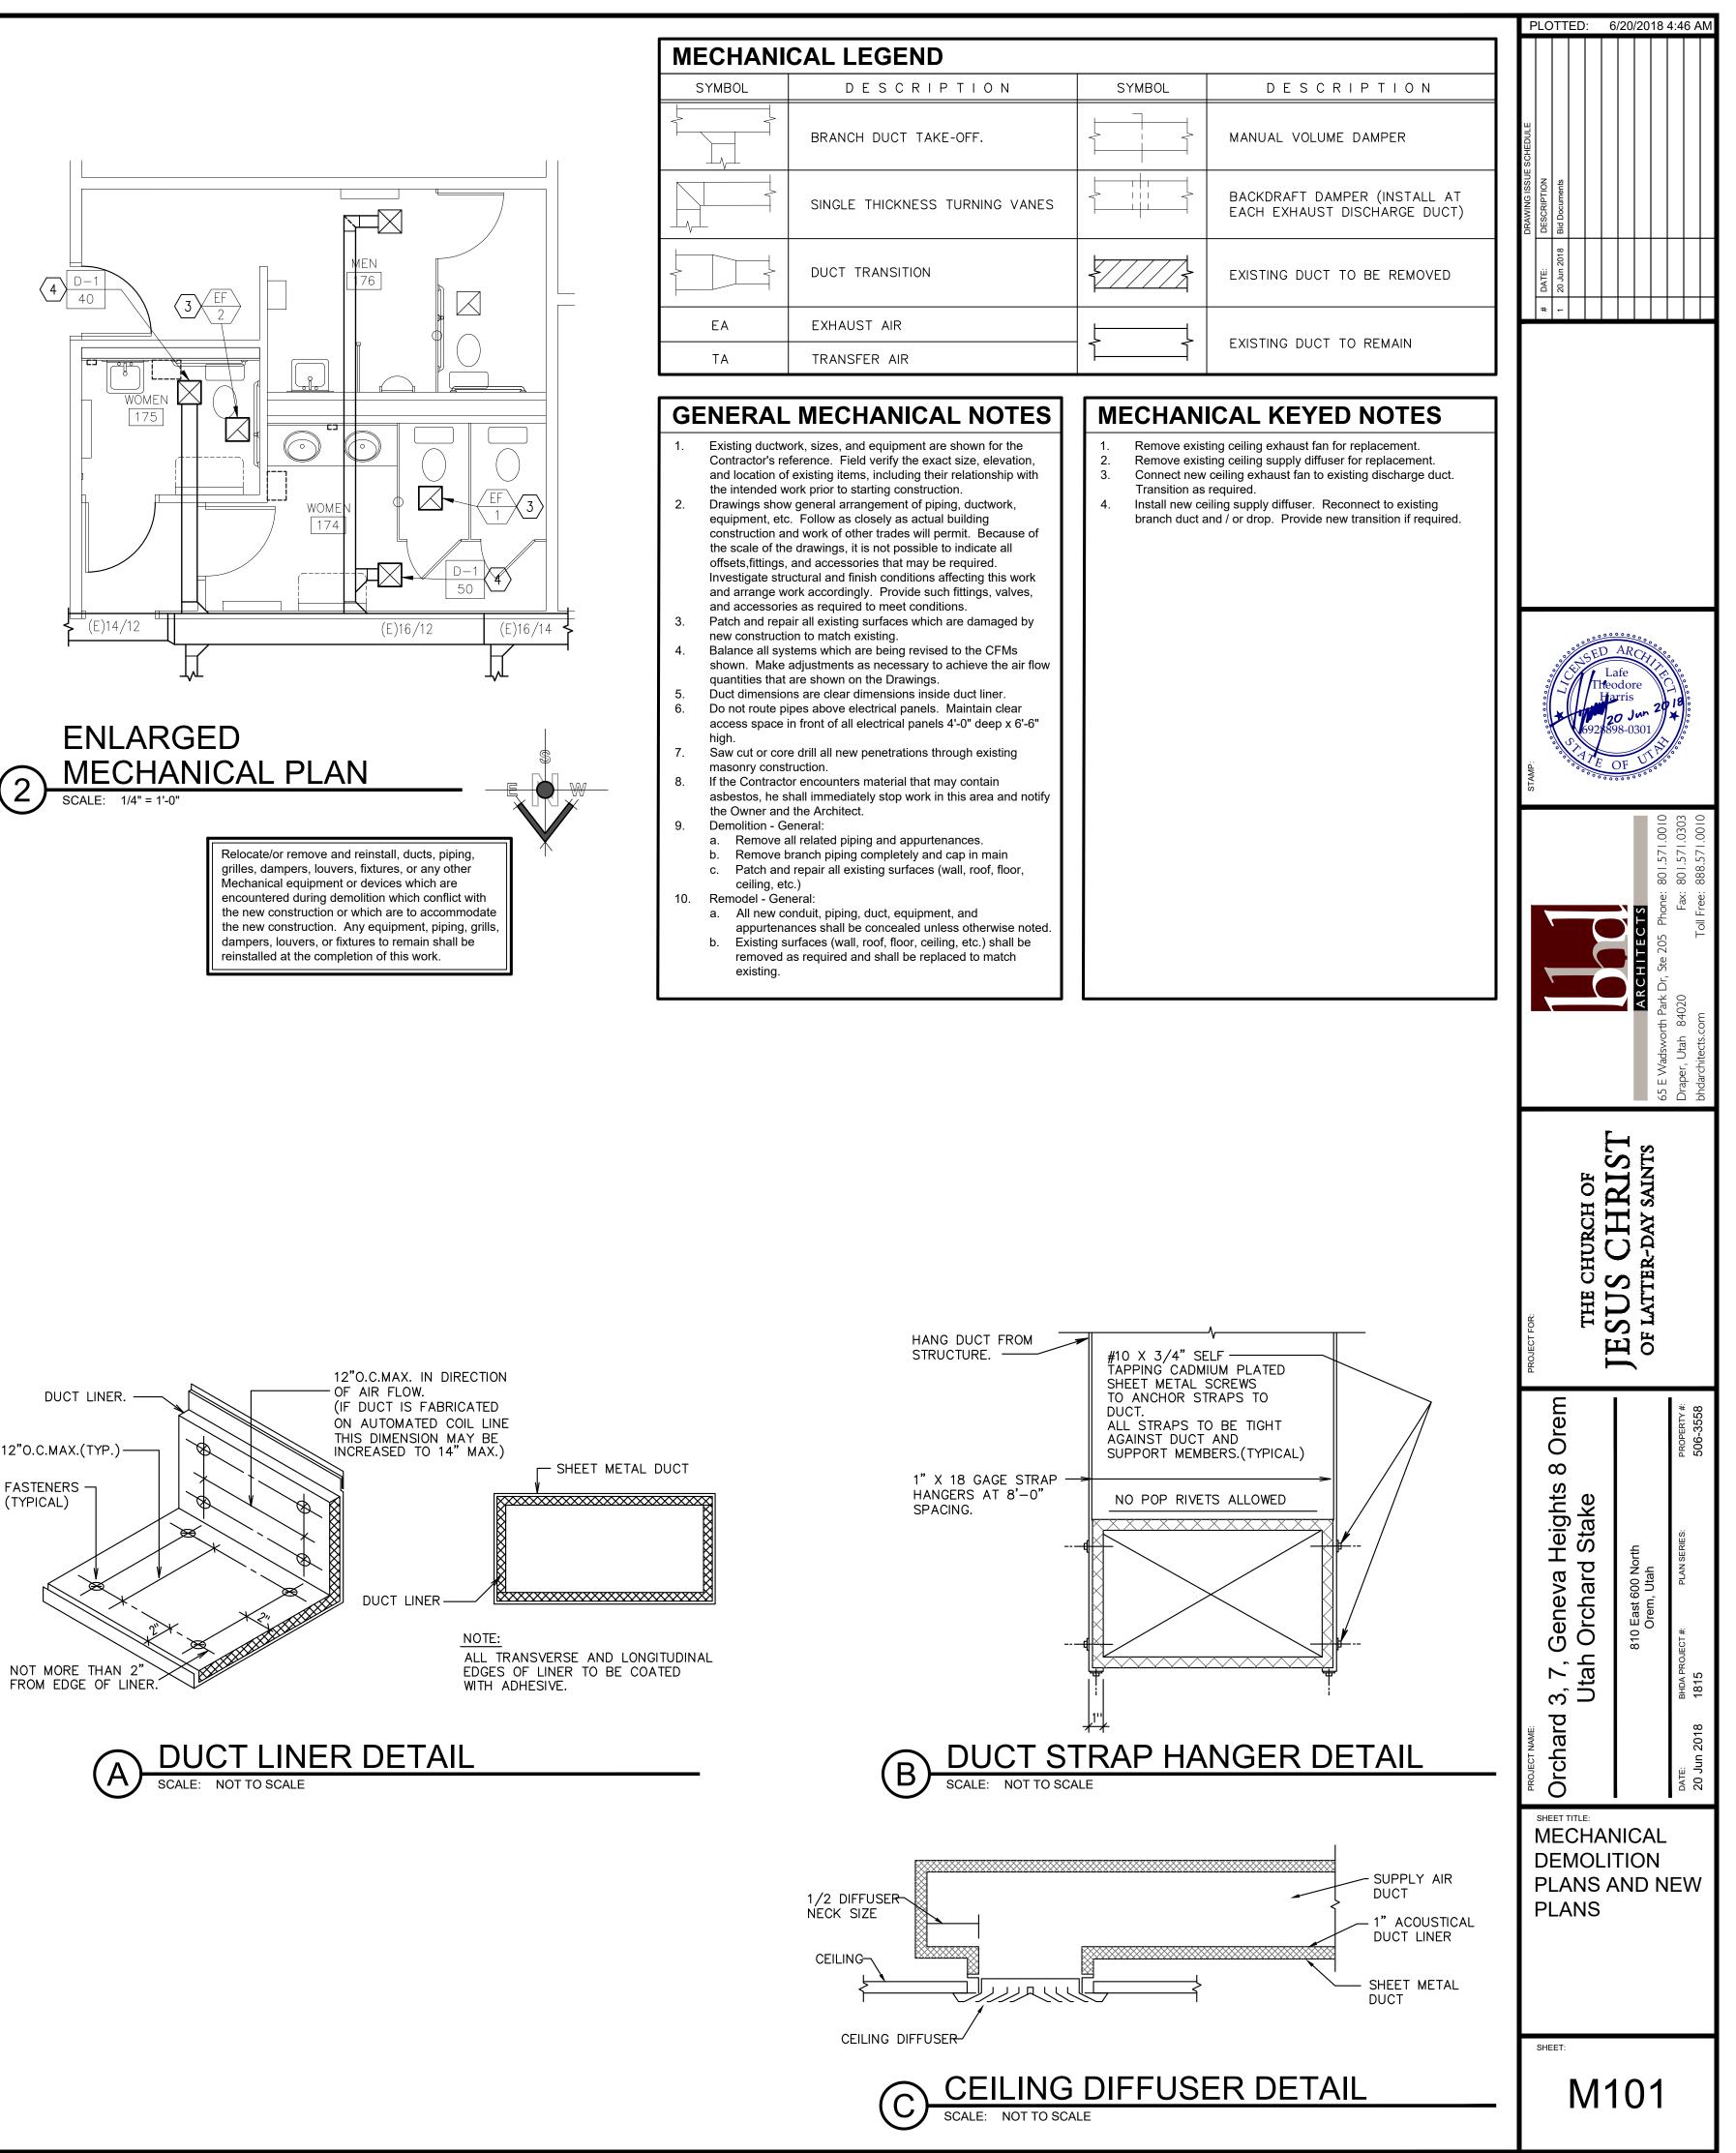



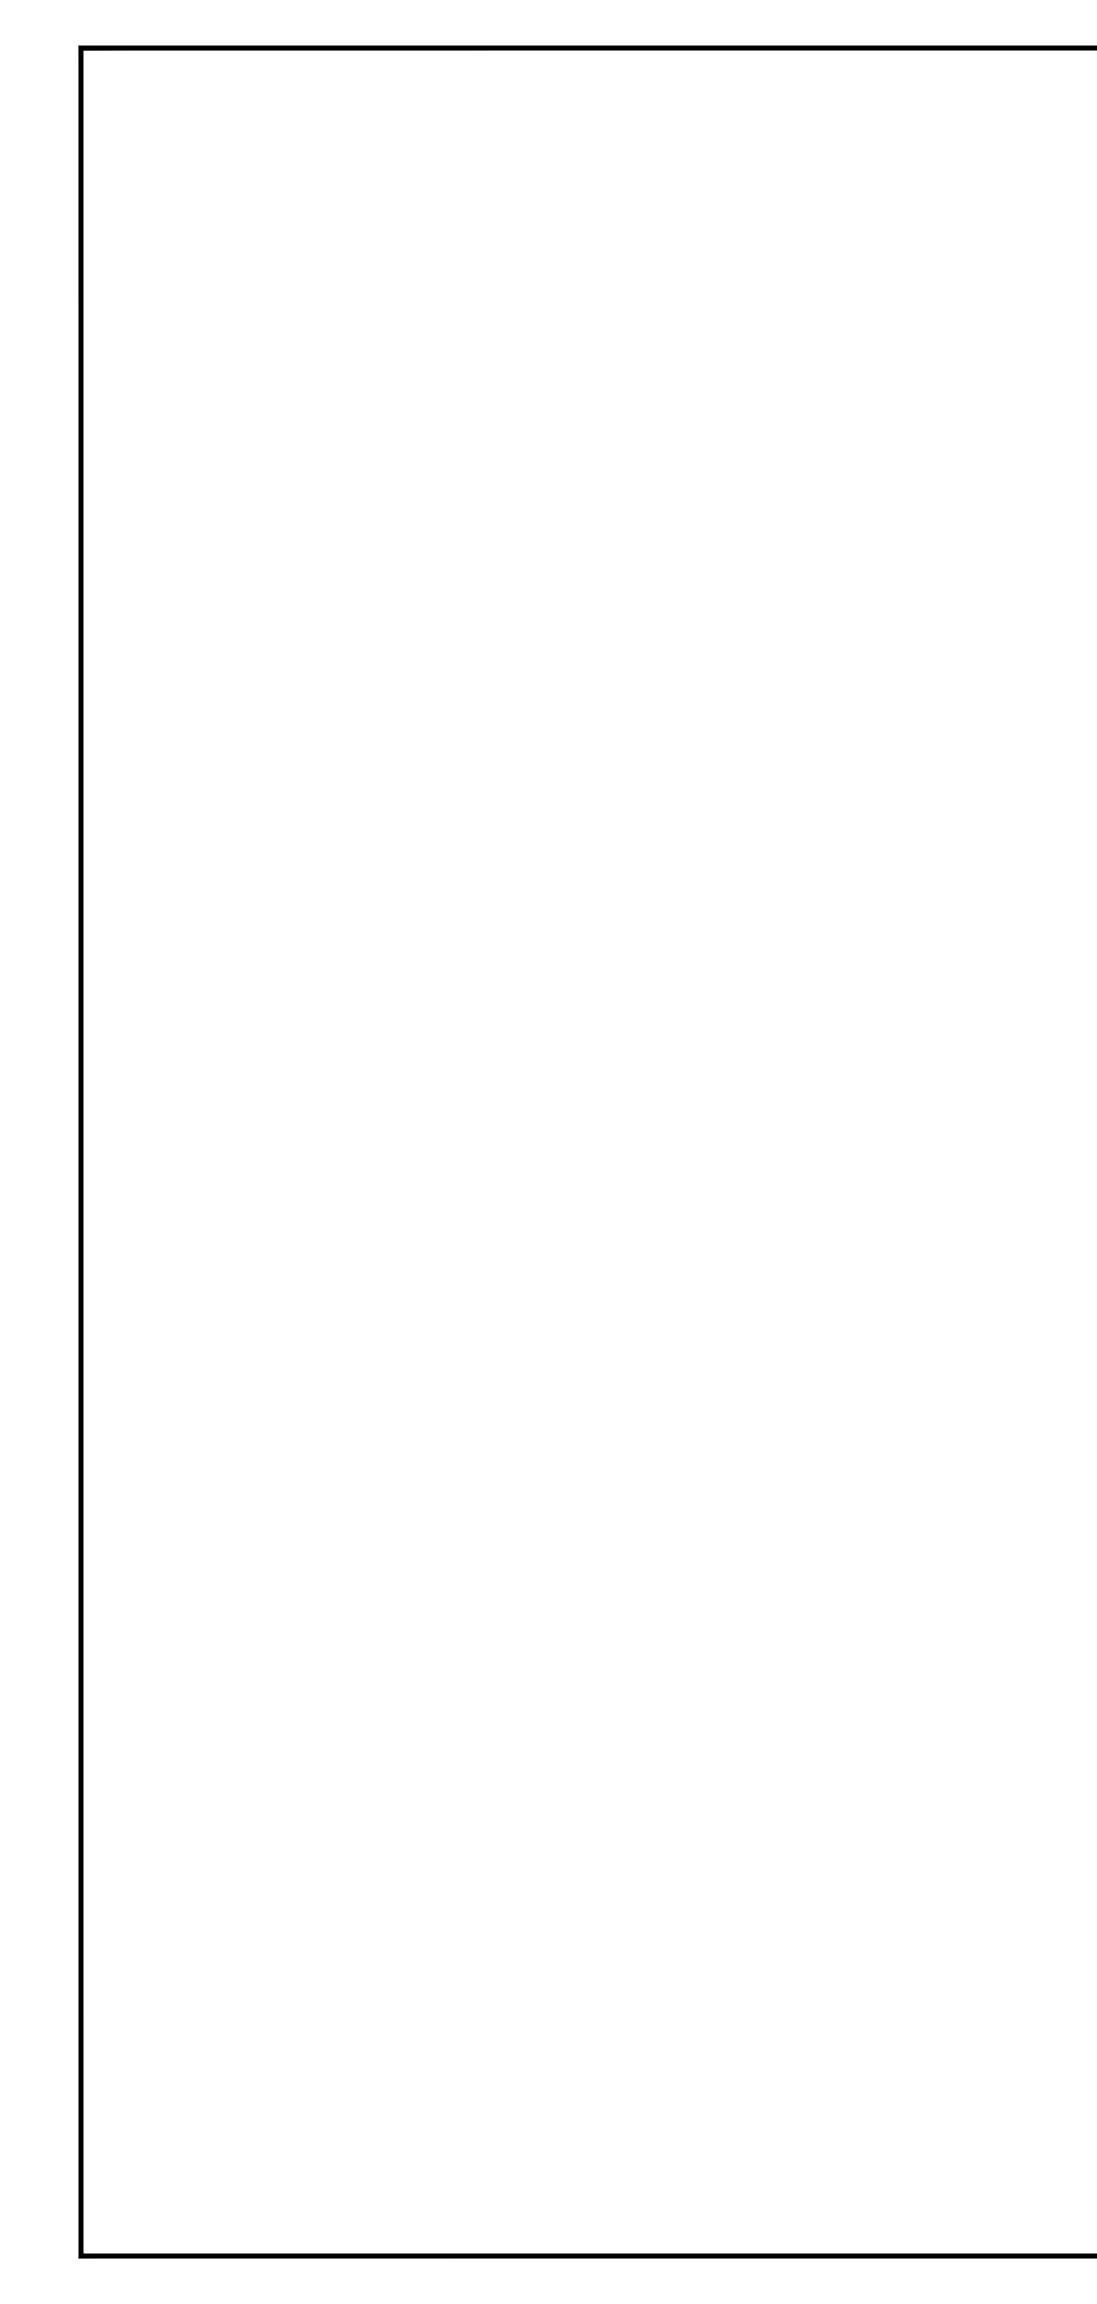

FIXTURE SCHEDULE	KEYED NOTES	PLOTTED: 6/20/2018 8:34 AM
TYPEMANUFACTURERLOADLAMPSMOUNTINGREMARKSSYMBOLNAMECATALOG NUMBER(VA)TYPE	 Blank off existing occupancy sensor and salvage to Owner. Re-circuit light to be fed from the Hallway lighting instead of the Restroom lighting. Replace existing receptacle with new GFCI receptacle. Remove existing speaker and blank off wall volume control. Emergency fixture with battery 	снерисе
TEMPERATURE)	C. Energency lixere with battery	DRAWING ISSUE S DESCRIPTION 18 Bid Documents Bid Documents
		# DATE: 1 20 Jun 20
MEN 176	MEN 176	
MOTHER'S ROOM		
₩OMEN	WOMEN 174 5	
		STAMP: 3
G ELECTRICAL PLAN	ILARGED ECTRICAL	S Jone: 801.571.0010 Fax: 801.571.0303 Free: 888.571.0010
SCALE: 1/4" = 1'-0"	E: 1/4" = 1'-0"	ARCHITECT ark Dr, Ste 205 Ph 120 Toll
		 ▲ 65 E Wadsworth Par Draper, Utah 8402 bhdarchitects.com
		HURCH OF CHRUST R-DAY SAINTS
		THE CHURCH OF JESUS CHRIST OF LATTER-DAY SAINTS
		J PRC
		Geneva Heights 8 Orem Orchard Stake 810 East 600 North 0rem, Utah LECT #: PLAN SERIES: 506-3558
		/a Heights ard Stake ^{D0 North} Jah Jah
		3, 7, Geneva Height Utah Orchard Stake 810 East 600 North Orem, Utah 1815 1815
		PROJECT NAME: Orchard 3, 7 Ut: DATE: BHDA 20 Jun 2018 1815
		SHEET TITLE: ELECTRICAL DEMOLITION
		PLAN AND ELECTRICAL PLAN
		SUFET
		E101

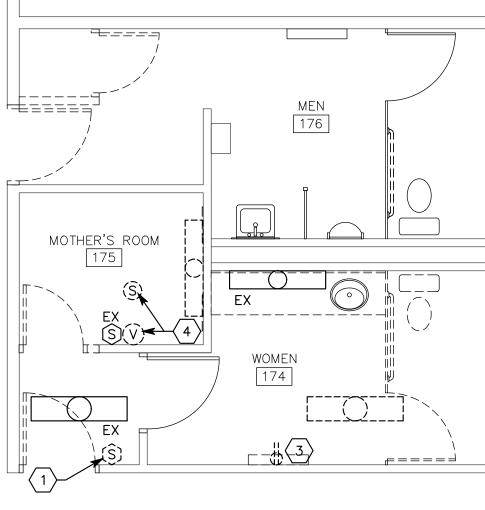

	ENLARGED DEMOLITION
	SCALE: 1/4" = 1'-0"
リノ	SCALE: 1/4" = 1'-0"