


PARLEYS YSA, MP YSA (BLDG. 11) BONNEVILLE & MP STAKES

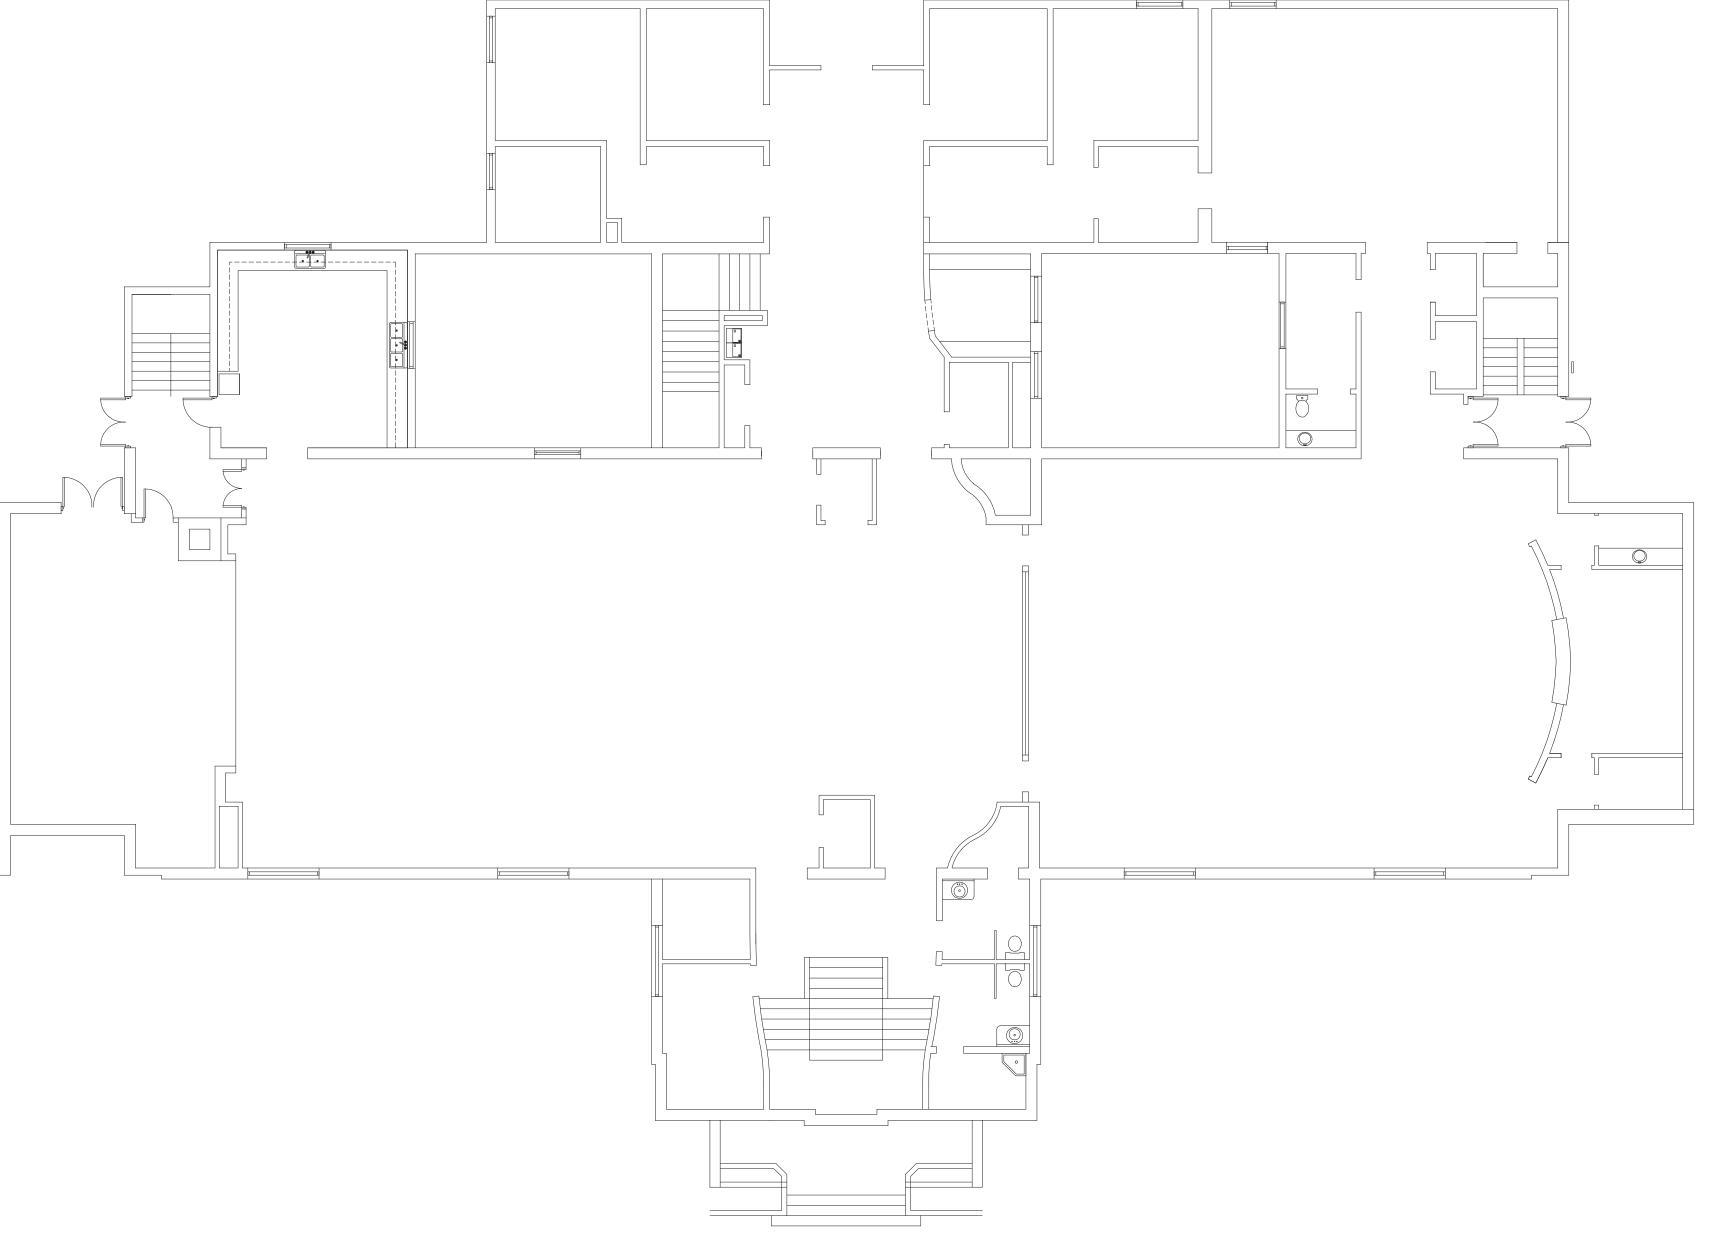

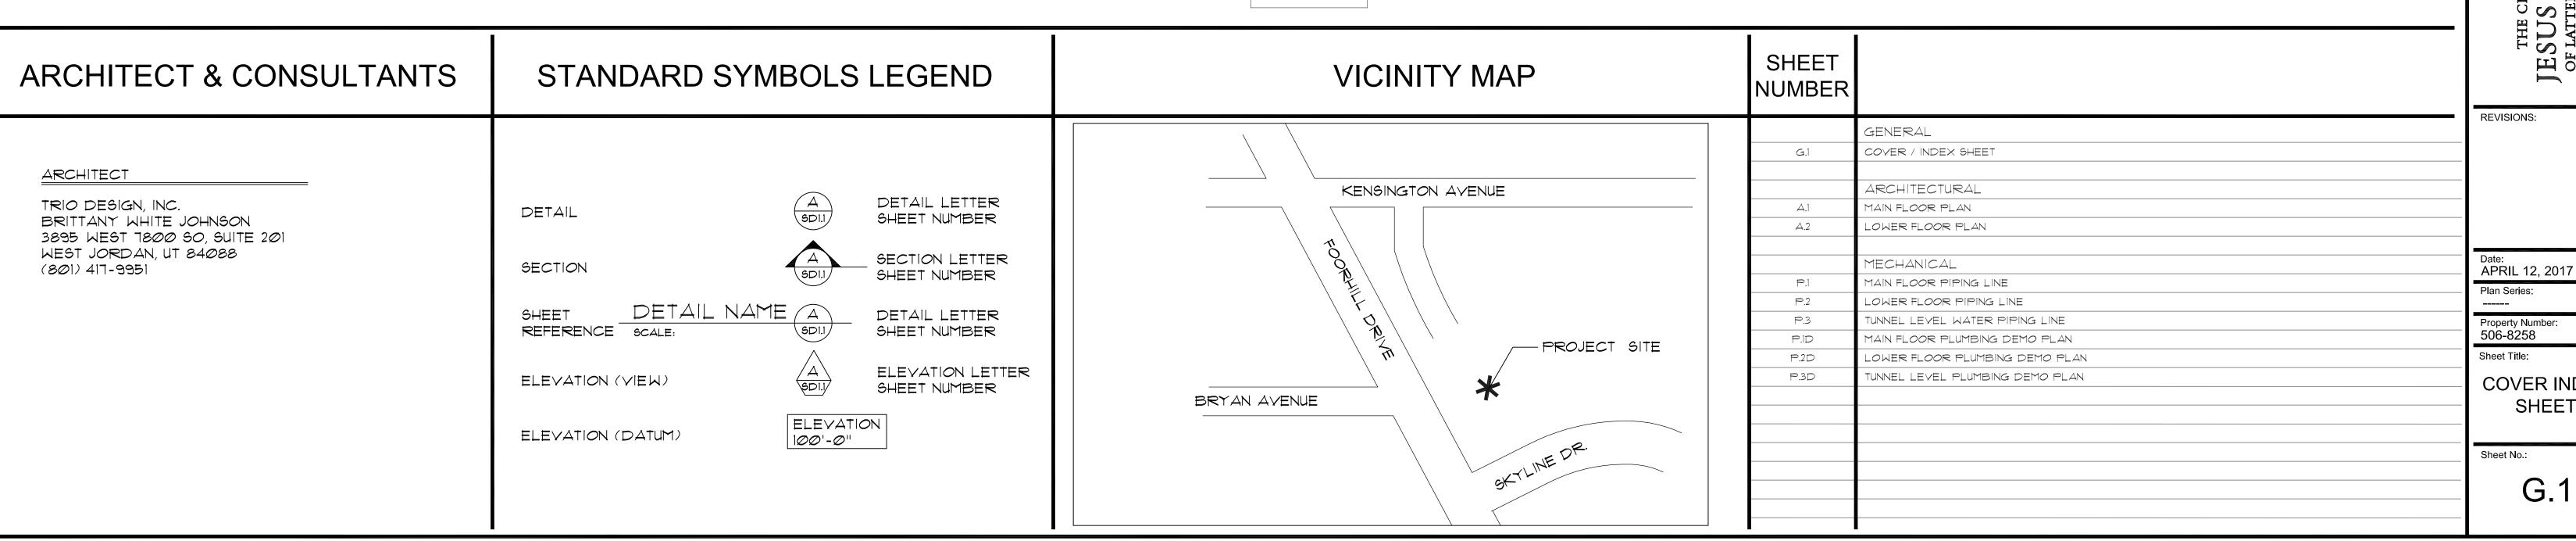

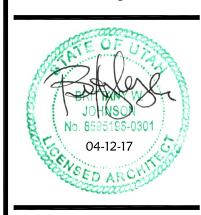



PROJECT FOR:

THE CHURCH OF

JESUS CHRIST


OF LATTER-DAY SAINTS

REVISIONS:

Date: APRIL 12, 2017

Sheet Title: **COVER INDEX**


G.1

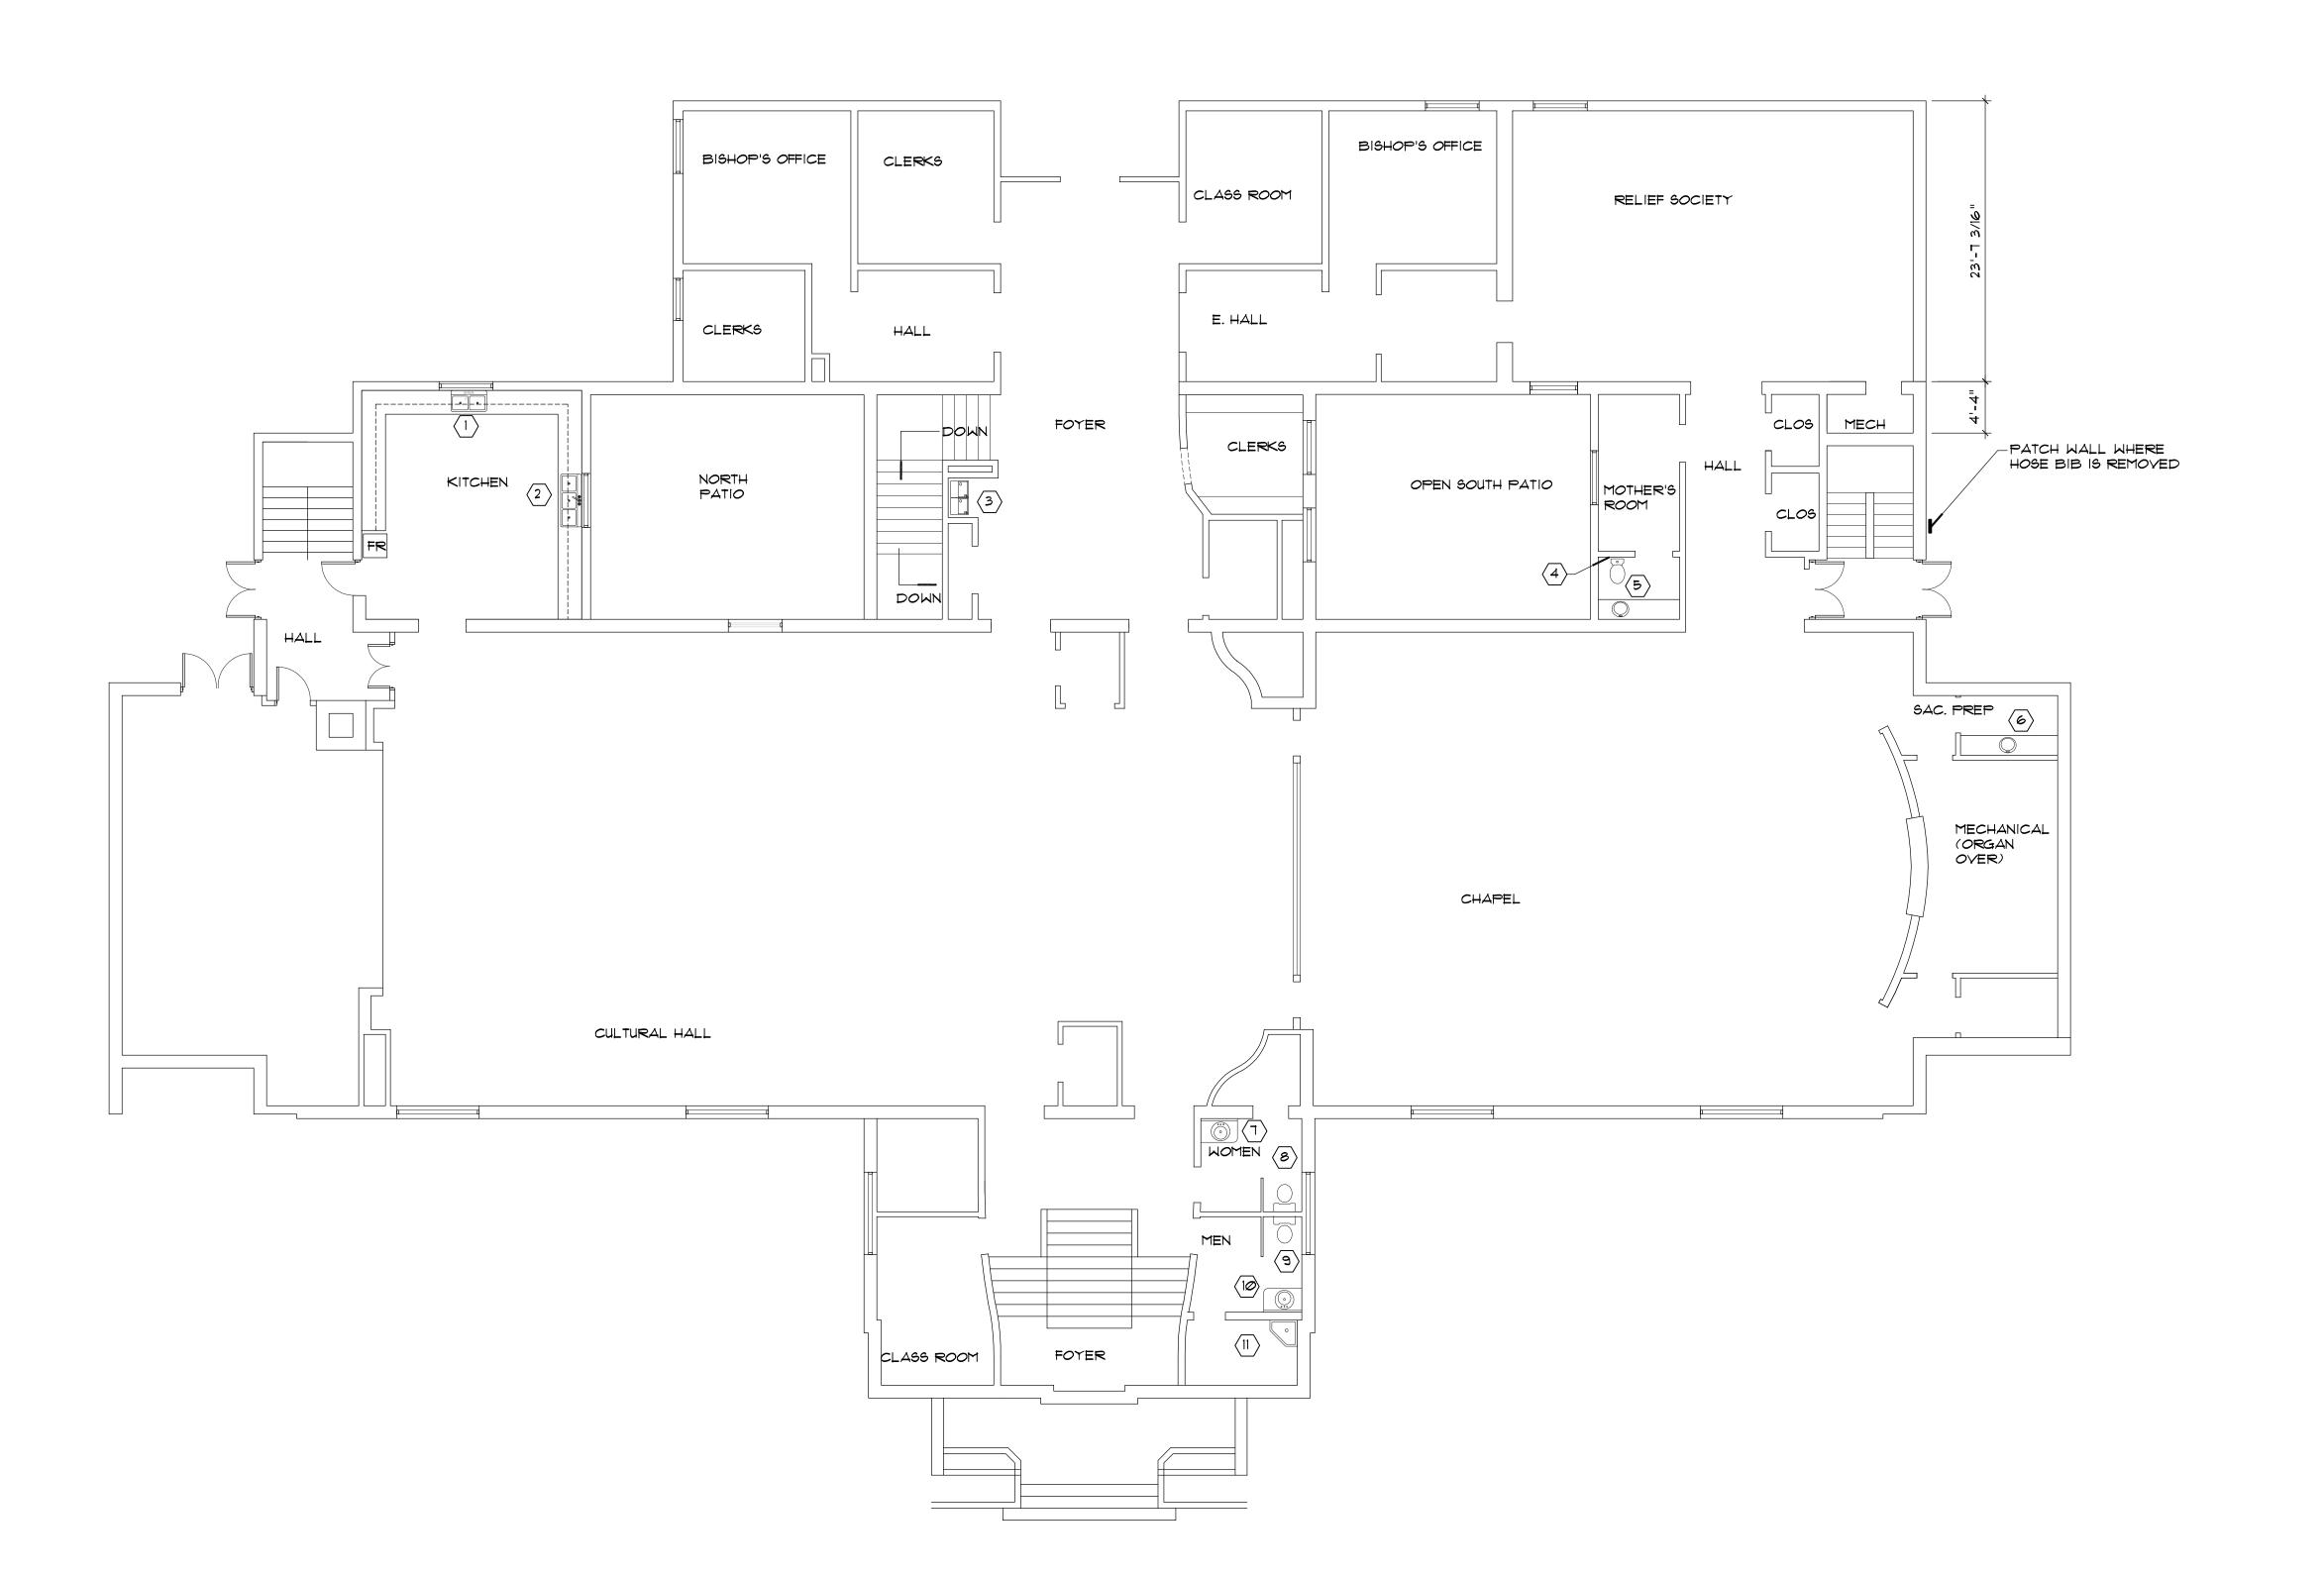




KEYED NOTES

- REMOVE BOTTOM SHELF OF CABINET TO GIVE ACCESS FOR PLUMBING DEMOLITION. SEAL FLOOR AT NEW PLUMBING PENETRATION. PATCH EXISTING PLASTER WALL. INSTALL NEW
- REMOVE 12" X 18" SECTION OF STAINLESS STEEL BOTTOM SHELF (BELOW SINK) AND SECTION OF WALL NEEDED FOR PLUMBING DEMOLITION. PATCH AND SEAL WALL AND FLOOR
- REMOVE 12" WIDE SECTION OF CERAMIC TILE AND GWB (GYPSUM WALL BOARD) TO PROVIDE ACCESS FOR NEW PLUMBING SUPPLY LINE TO WATER CLOSET. INSTALL NEW G.W.B. AND CERAMIC TILE. SEAL AROUND PLUMBING. MATCH EXISTING CERAMIC TILE.
- REMOVE 12" WIDE, DOWN TO FLOOR, SECTION OF CERAMIC TILE AND G.W.B. TO PROVIDE ACCESS FOR INSTALLATION OF NEW PLUMBING LINES TO VANITY SINK.
- REMOVE 12" WIDE SECTION OF CERAMIC AND G.W.B. ON NORTH SEAL AROUND PLUMBING LINES, MATCH EXISTING CERAMIC TILE.
- REMOVE 12" WIDE SECTION OF CERAMIC TILE AND GWB (GYPSUM WALL BOARD) TO PROVIDE ACCESS FOR NEW PLUMBING SUPPLY SEAL AROUND PLUMBING, MATCH EXISTING CERAMIC TILE.
- REMOVE 12" WIDE SECTION OF CERAMIC TILE AND GWB (GYPSUM WALL BOARD) TO PROVIDE ACCESS FOR NEW PLUMBING SUPPLY LINE TO WATER CLOSET. INSTALL NEW G.W.B. AND CERAMIC TILE. SEAL AROUND PLUMBING. MATCH EXISTING CERAMIC TILE.
- REMOVE 12" WIDE SECTION OF CERAMIC AND G.W.B. ON WEST WALL FROM BELOW VANITY DOWN TO FLOOR TO PROVIDE ACCESS FOR NEW PLUMBING LINES. INSTALL NEW G.W.B. AND CERAMIC TILE± SEAL AROUND PLUMBING LINES, MATCH EXISTING CERAMIC TILE.
- REMOVE 18" WIDE SECTION OF GWB AND CERAMIC TILE FROM INSTALLATION OF NEW PLUMBING SUPPLY LINES . INSTALL NEW EAST WALL- MATCH EXISTING.

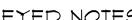

BOTTOM SHELF, SEAL AROUND PLUMBING.

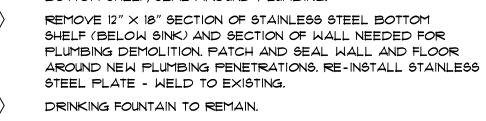

REMOVE BOTTOM SHELF OF BASE CABINET AND 12" imes 12" PORTION OF BACK OF CABINET AND WALL PLASTER TO PROVIDE ACCESS FOR NEW PLUMBING SUPPLY LINE TO SINK. PATCH WALL SEAL AROUND PLUMBING LINE, INSTALL NEW BACK PANEL AND BOTTOM SHELF TO BASE CABINET.

WALL FROM BELOW VANITY DOWN TO FLOOR TO PROVIDE ACCESS FOR NEW PLUMBING LINES. INSTALL NEW G.W.B. AND CERAMIC TILE:

LINE TO WATER CLOSET, INSTALL NEW G.W.B. AND CERAMIC TILE.

PLUMBING FIXTURE DOWN TO MOP SINK TO PROVIDE ACCESS FOR GWB AND CERAMIC TILE. MATCH EXISTING CERAMIC TILE: REPAINT

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PROJECT NAME:

ARLEYS YS
BONNEV
1565 SOUTH FOO

PROJECT FOR: THE CHURCH OF

JESUS CHRIST

OF LATTER-DAY SAINTS

REVISIONS:

Date: APRIL 12, 2017


Property Number: 506-8258

Sheet Title:

MAIN FLOOR PLAN

Sheet No.:

A.1

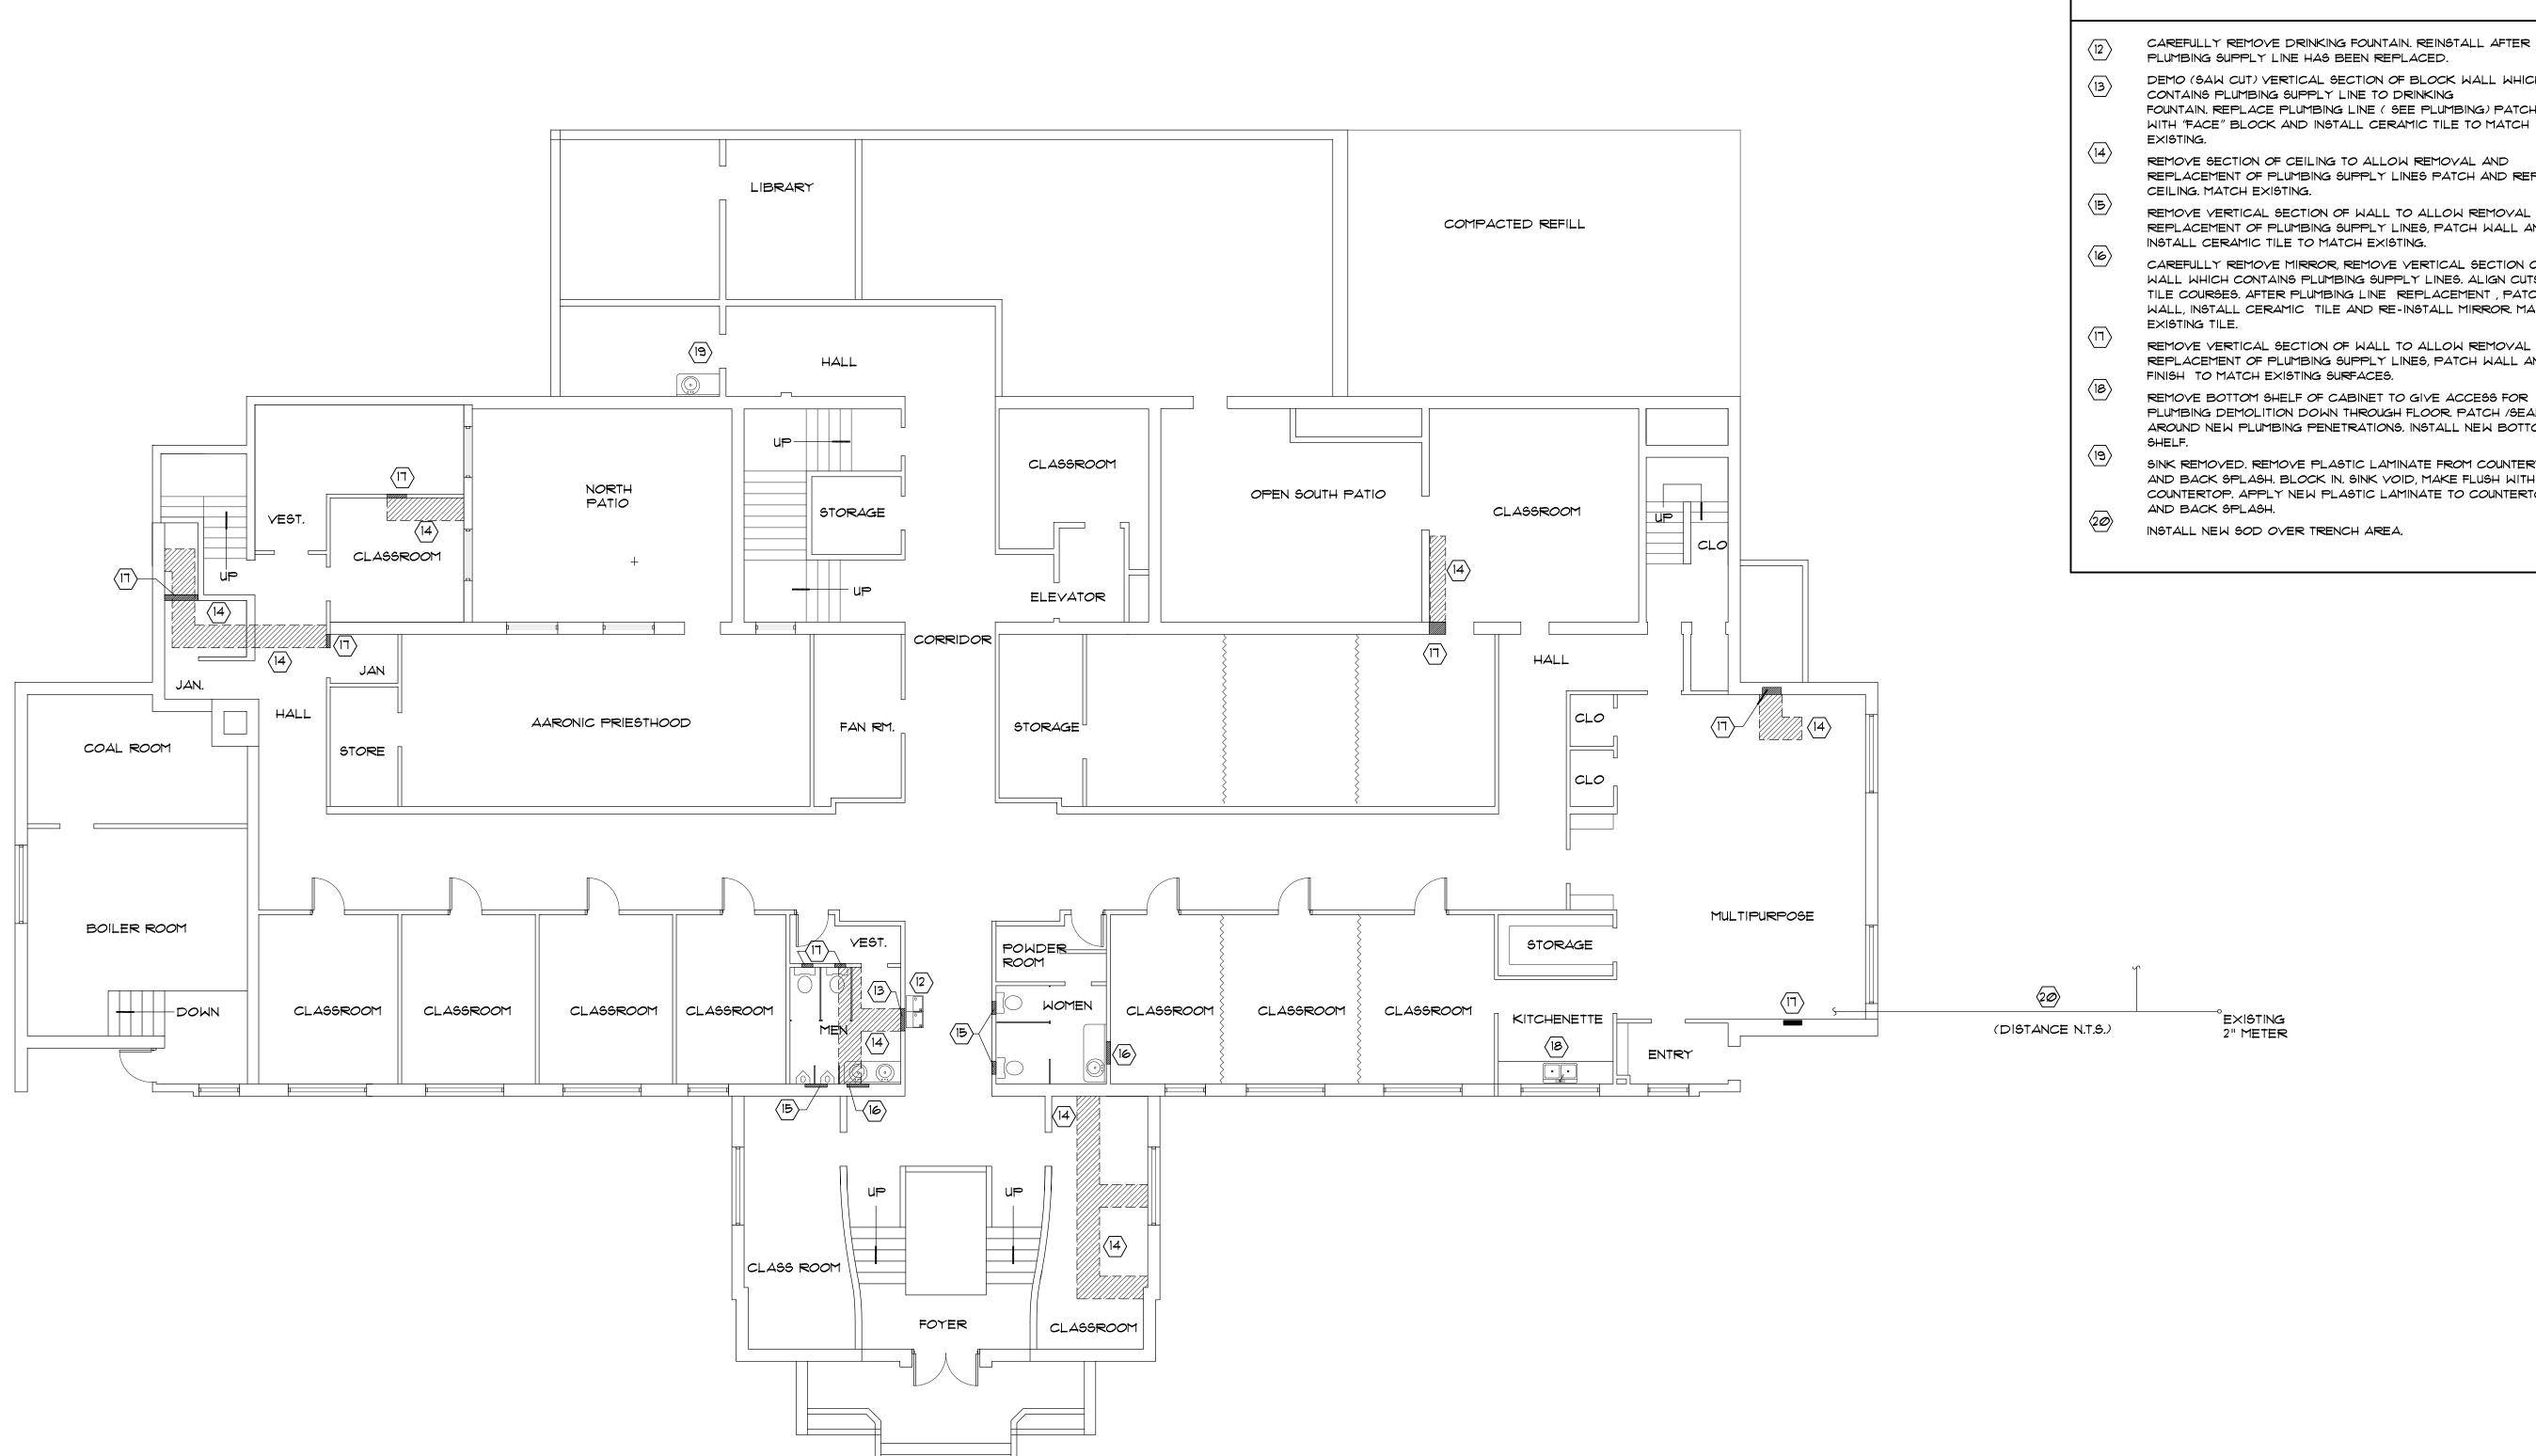

DEMO (SAW CUT) VERTICAL SECTION OF BLOCK WALL WHICH

KEYED NOTES

FOUNTAIN. REPLACE PLUMBING LINE (SEE PLUMBING) PATCH WALL WITH "FACE" BLOCK AND INSTALL CERAMIC TILE TO MATCH

REMOVE SECTION OF CEILING TO ALLOW REMOVAL AND REPLACEMENT OF PLUMBING SUPPLY LINES PATCH AND REPLACE

REMOVE VERTICAL SECTION OF WALL TO ALLOW REMOVAL AND REPLACEMENT OF PLUMBING SUPPLY LINES, PATCH WALL AND

CAREFULLY REMOVE MIRROR, REMOVE VERTICAL SECTION OF WALL WHICH CONTAINS PLUMBING SUPPLY LINES. ALIGN CUTS WITH TILE COURSES. AFTER PLUMBING LINE REPLACEMENT, PATCH WALL, INSTALL CERAMIC TILE AND RE-INSTALL MIRROR, MATCH

REMOVE VERTICAL SECTION OF WALL TO ALLOW REMOVAL AND REPLACEMENT OF PLUMBING SUPPLY LINES, PATCH WALL AND

REMOVE BOTTOM SHELF OF CABINET TO GIVE ACCESS FOR PLUMBING DEMOLITION DOWN THROUGH FLOOR. PATCH /SEAL AROUND NEW PLUMBING PENETRATIONS. INSTALL NEW BOTTOM

SINK REMOVED. REMOVE PLASTIC LAMINATE FROM COUNTERTOP AND BACK SPLASH. BLOCK IN. SINK VOID, MAKE FLUSH WITH COUNTERTOP. APPLY NEW PLASTIC LAMINATE TO COUNTERTOP

PROJECT FOR:

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PROJECT NAME:

REVISIONS:

Date: APRIL 12, 2017

Property Number: 506-8258

LOWER FLOOR PLAN

Sheet No.:

A.2

LOWER FLOOR PLAN
SCALE: 1/8"=1'-0"

KEYNOTES

SYMBOL

- (1) 1/2" CW TO RISE IN WALL FROM BELOW AND CONNECT TO FIXTURE. CONT ON P.2.
- 2 1/2" CW TO RISE IN WALL FROM BELOW STAIRS & CONNECT TO FIXTURE. CONTINUED ON P.2.
- 1/2" CW & HW TO RISE UNDER CABINET FROM BELOW AND CONNECT TO FIXTURE.
- 1/2" CW & HW TO RISE IN WALL FROM BELOW AND CONNECT TO FIXTURE.


 CONTINUED ON P.2.

DRAWING NOTES:

- 1. ALL FIXTURES SHOWN, EXCEPT HB-1 ARE EXISTING AND ARE TO BE REUSED.
- 2. EXACT ROUTING OF EXISTING PIPING IS NOT KNOWN. CONTRACTOR WILL NEED TO VERIFY LOCATION AND ROUTING OF ALL EXISTING PIPING TO PLUMBING FIXTURES AND INSTALL NEW PIPING TO SERVE ALL EXISTING FIXTURES THAT ARE RETAINED.
- 3. COORDINATE DEMOLITION OF WALLS, FLOORS & CEILINGS REQUIRED WITH GENERAL CONTRACTOR TO MINIMIZE REQUIRED DEMOLITION AND REPAIR.
- 4. INSTALL BLENDING VALVES ON HOT WATER TO ALL LAVATORIES PER ITEM #8 IN SCOPE OF WORK.
- 5. PEX OR COPPER PIPE MAY BE USED ON THIS LEVEL.

SCOPE OF WORK:


- 1. REPLACE ALL GALVANIZED CULINARY WATER PIPING SERVING THE BUILDING, FROM EXISTING 2" METER TO BUILDING AND WITHIN THE BUILDING, UNLESS NOTED TO REMAIN.
- 2. REMOVE ALL ABANDONED PIPING THAT CAN BE REMOVED WITHOUT ADDITIONAL DEMOLITION OF FLOORS, WALLS, OR CEILINGS.
- 3. REPLACE STOPS AND SUPPLIES FOR ALL FIXTURES. REMOVE EXISTING FIXTURES AS REQUIRED TO ALLOW SUPPLY PIPING TO BE REPLACED AND REPLACE FIXTURES AFTER WALLS ARE REPAIRED BY GENERAL CONTRACTOR.
- 4. REPLACE ALL EXTERIOR HOSE BIBS THAT CAN BE ACCESSED WITHOUT DEMOLITION OF FINISHES IN FINISHED AREAS. THOSE THAT CANNOT BE REPLACED ARE TO BE REMOVED, PIPING ABANDONED IN PLACE AND EXTERIOR WALL FINISH REPAIRED BY GENERAL CONTRACTOR.
- 5. REPLACE HOT WATER RECIRCULATION LINE AND PUMP & PROVIDE NEW CONTROL TIMER. EXISTING HOT WATER HEATER AND BOILER FEED WATER SYSTEM TO BE RETAINED AND NEW SUPPLY PIPING CONNECTED.
- 6. INSTALL NEW PRV AND COLD WATER HEADER IN BOILER ROOM.
- 7. IRRIGATION SYSTEM IS NOT IN CONTRACT, EXCEPT FOR RECONNECTION OF IRRIGATION MAIN TO NEW SERVICE LINE FROM METER TO BUILDING, AND REPAIR OF ANY IRRIGATION SYSTEM DAMAGED OR DISTURBED BY MAIN LINE EXCAVATION AND REPLACEMENT.
- 8. INSTALL 1/2" WATTS USG—B—M1 BLENDING VALVE UNDER EACH LAVATORY. ADJUST TO DELIVER 110F HOT WATER TO EACH LAVATORY FAUCET. EQUAL ASSE 1016 & 1070 LISTED BY PRIOR APPROVAL.

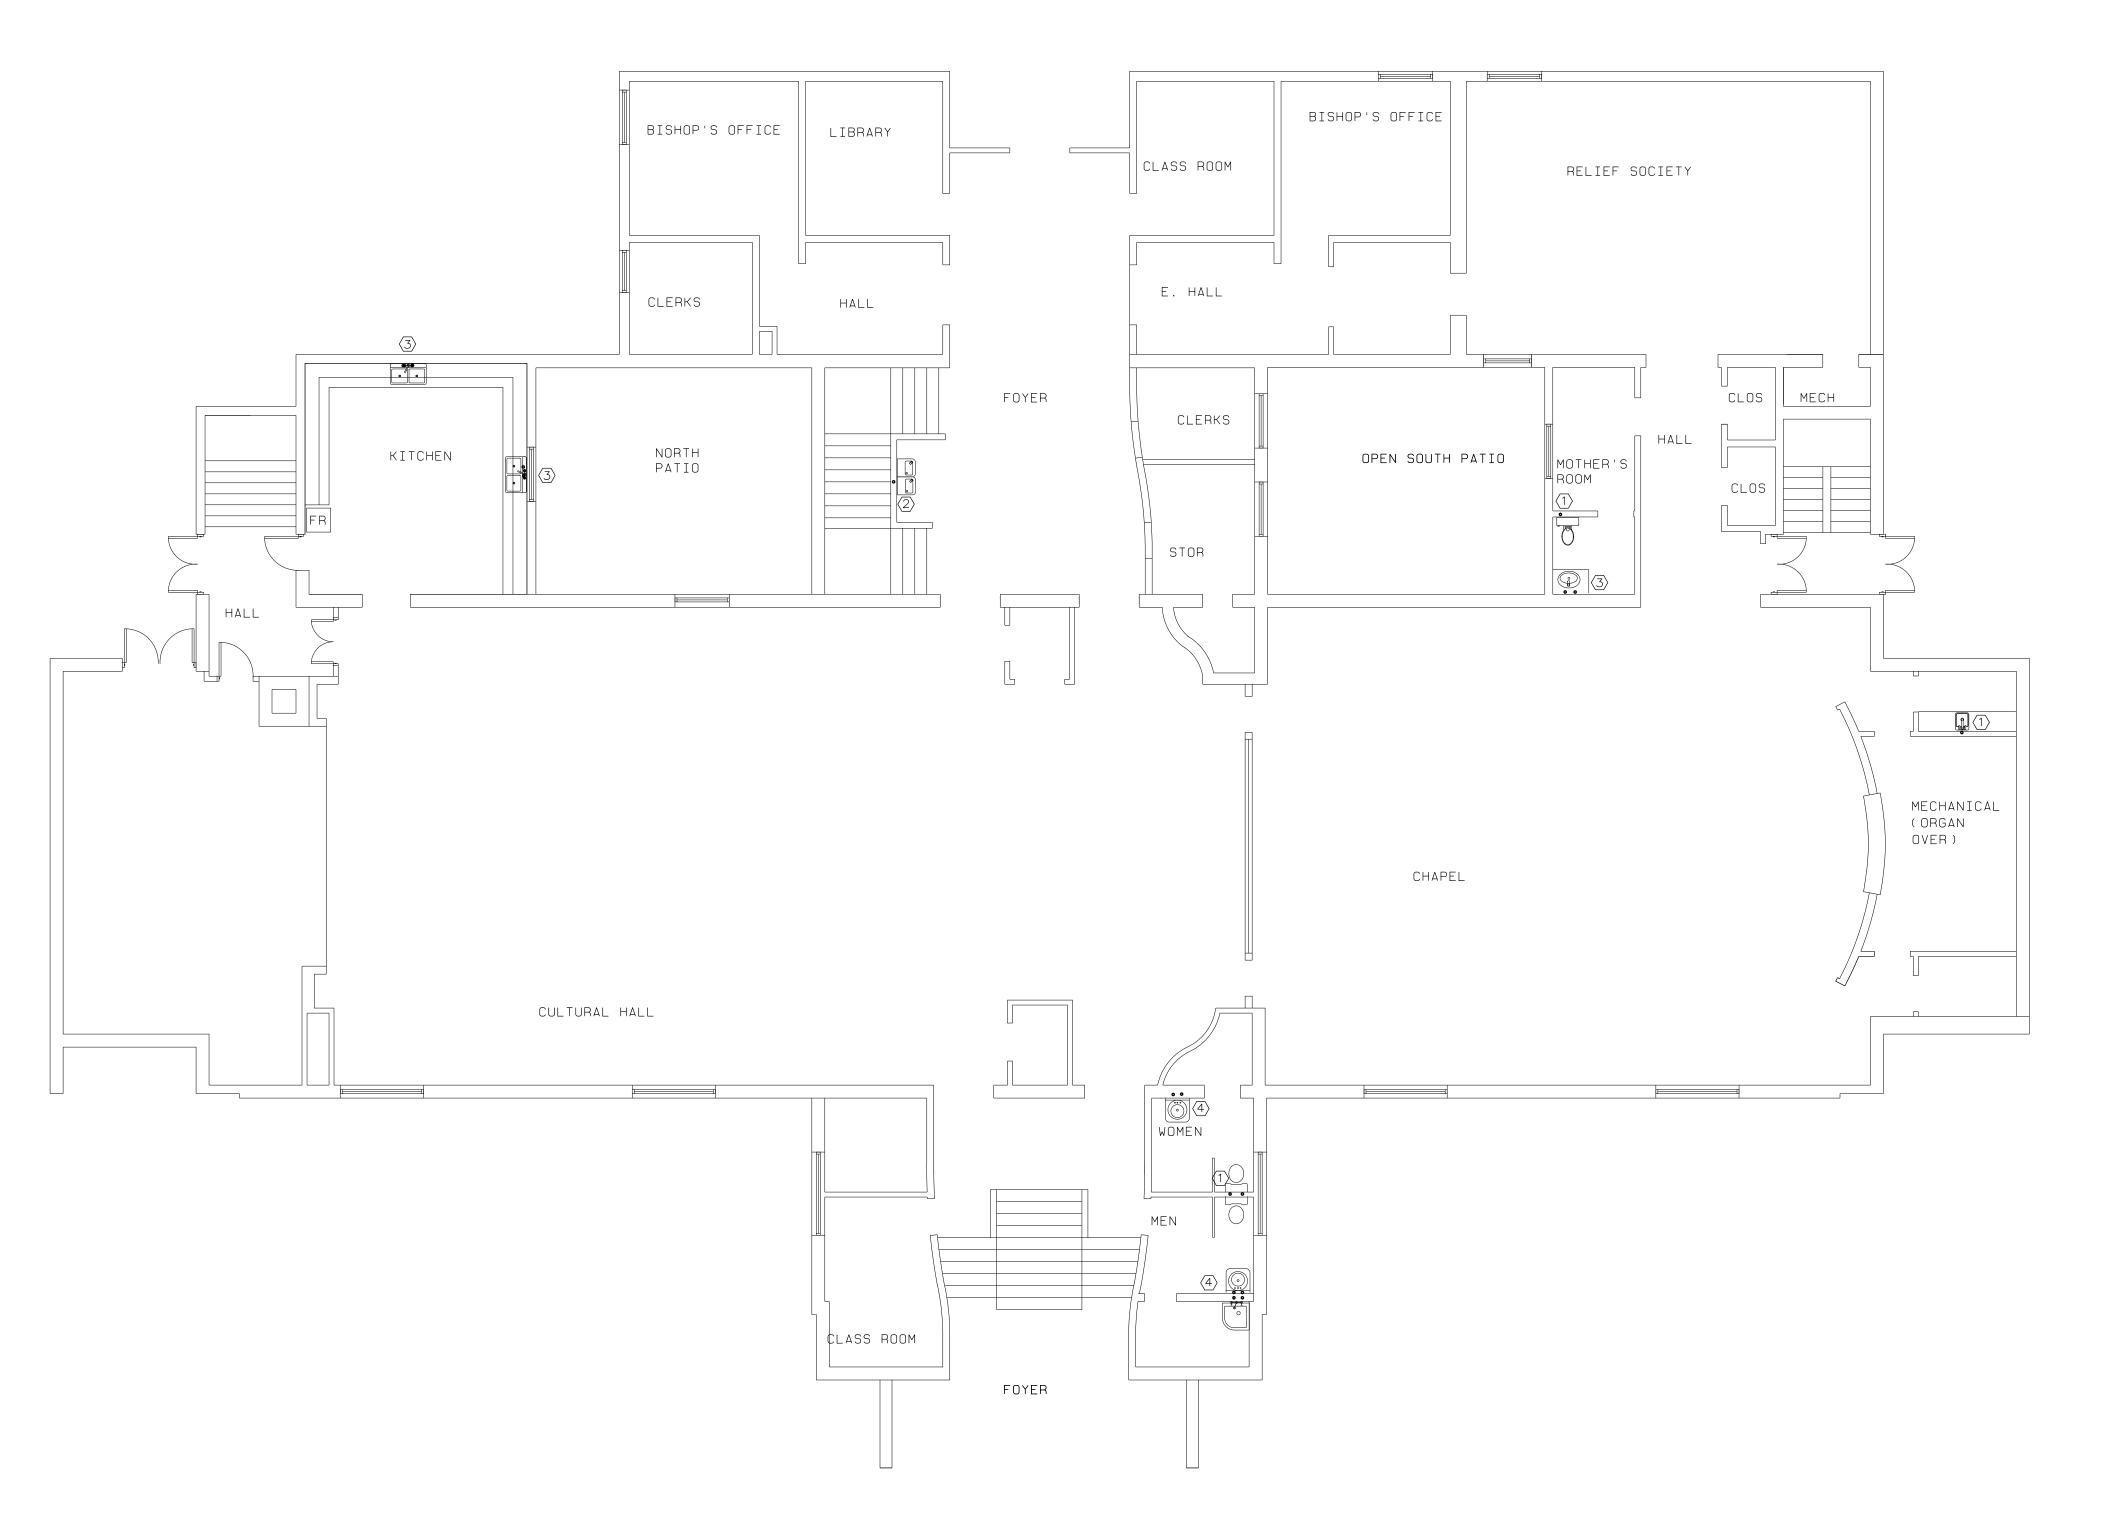

MAIN FLOOR PIPING PLAN
SCALE:
1/8"=1'-0"

DESIGN

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BRUNNER & DALLON ENGINEERING 5330 S 900 E, #240 SALT LAKE CITY, UT 84117 801 685-8081

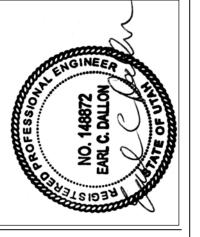PROJECT NAME:

leys YSA, MP YSA (Bldg. Bonneville & MP Stakes south foothills DRIVE, SALT LAKE CITY,

Parleys Bonn

PROJECT FOR:

THE CHURCH OF

JESUS CHRIST

OF LATTER-DAY SAINTS

REVISIONS:

Date: APRIL 12, 2017 Plan Series:

-----Property Number: 506-8258

Sheet Title:

MAIN FLOOR

PIPING PLAN

Sheet No.:

P.1

KFYNOTES


KEYNUTES		
SYMBOL	NOTE	
1	ESTIMATED LOCATION OF 1/2" CW RISER FROM TUNNEL BELOW. RISE IN WALL ABOVELLING OR UNDER STAIRS AND OFFSET AS SHOWN. PIPING DOWN CONT ON P.3.	
(2)	1/2" CW TO OFFSET ABOVE CEILING AND RISE UP TO FIXTURE ABOVE. CONTINUED ON P.1.	
(3)	ESTIMATED LOCATION OF 3/4" HW & CW RISERS FROM TUNNEL BELOW. RISE IN WALL ABOVE CEILING AND OFFSET AS SHOWN. CONTINUED DOWN ON P.3.	
4	ESTIMATED LOCATION OF 1/2" HW & CW RISERS FROM TUNNEL BELOW. RISE IN WALL ABOVE CEILING AND OFFSET AS SHOWN. CONTINUED DOWN ON P.3.	
(5)	ESTIMATED LOCATION OF 1/2" CW RISER FROM TUNNEL BELOW. CONTINUED ON P.3	
6	ESTIMATED LOCATION OF 3/4" CW RISER FROM TUNNEL BELOW. CONTINUED ON P.3	
7	ESTIMATED LOCATION OF 3/4" CW RISER FROM TUNNEL BELOW. RISE TO ABOVE CEILING AND OFFSET AS SHOWN. CONTINUED DOWN ON P.3.	
8	INSTALL NEW NON-FREEZE HOSE BIB WITH ISOLATION BALL VALVE.	
9	1/2" CW & HW TO OFFSET ABOVE CEILING AND RISE UP TO FIXTURE ABOVE. CONTINUED ON P.1.	
10>	1/2" CW TO OFFSET ABOVE CEILING AND DROP IN WALL TO FIXTURE.	


DRAWING NOTES:

- 1. ALL FIXTURES SHOWN, EXCEPT HB-1 ARE EXISTING AND ARE TO BE REUSED.
- 2. EXACT ROUTING OF EXISTING PIPING IS NOT KNOWN. CONTRACTOR WILL NEED TO VERIFY LOCATION AND ROUTING OF ALL EXISTING PIPING TO PLUMBING FIXTURES AND INSTALL NEW PIPING TO SERVE ALL EXISTING FIXTURES THAT ARE RETAINED.
- 3. COORDINATE DEMOLITION OF WALLS, FLOORS & CEILINGS REQUIRED WITH GENERAL CONTRACTOR TO MINIMIZE REQUIRED DEMOLITION AND REPAIR.
- 4. INSTALL BLENDING VALVES ON HOT WATER TO ALL LAVATORIES PER ITEM #8 IN SCOPE OF WORK.
- 5. PEX OR COPPER PIPE MAY BE USED ON THIS LEVEL.


SCOPE OF WORK:

- 1. REPLACE ALL GALVANIZED CULINARY WATER PIPING SERVING THE BUILDING, FROM EXISTING 2" METER TO BUILDING AND WITHIN THE BUILDING, UNLESS NOTED TO REMAIN.
- 2. REMOVE ALL ABANDONED PIPING THAT CAN BE REMOVED WITHOUT ADDITIONAL DEMOLITION OF FLOORS, WALLS, OR CEILINGS.
- 3. REPLACE STOPS AND SUPPLIES FOR ALL FIXTURES. REMOVE EXISTING FIXTURES AS REQUIRED TO ALLOW SUPPLY PIPING TO BE REPLACED AND REPLACE FIXTURES AFTER WALLS ARE REPAIRED BY GENERAL CONTRACTOR.
- 4. REPLACE ALL EXTERIOR HOSE BIBS THAT CAN BE ACCESSED WITHOUT DEMOLITION OF FINISHES IN FINISHED AREAS. THOSE THAT CANNOT BE REPLACED ARE TO BE REMOVED, PIPING ABANDONED IN PLACE AND EXTERIOR WALL FINISH REPAIRED BY GENERAL CONTRACTOR.
- 5. REPLACE HOT WATER RECIRCULATION LINE AND PUMP & PROVIDE NEW CONTROL TIMER. EXISTING HOT WATER HEATER AND BOILER FEED WATER SYSTEM TO BE RETAINED AND NEW SUPPLY PIPING CONNECTED.
- 6. INSTALL NEW PRV AND COLD WATER HEADER IN BOILER ROOM.
- 7. IRRIGATION SYSTEM IS NOT IN CONTRACT, EXCEPT FOR RECONNECTION OF IRRIGATION MAIN TO NEW SERVICE LINE FROM METER TO BUILDING, AND REPAIR OF ANY IRRIGATION SYSTEM DAMAGED OR DISTURBED BY MAIN LINE EXCAVATION AND REPLACEMENT.
- 8. INSTALL 1/2" WATTS USG—B—M1 BLENDING VALVE UNDER EACH LAVATORY. ADJUST TO DELIVER 110F HOT WATER TO EACH LAVATORY FAUCET. EQUAL ASSE 1016 & 1070 LISTED BY PRIOR APPROVAL.

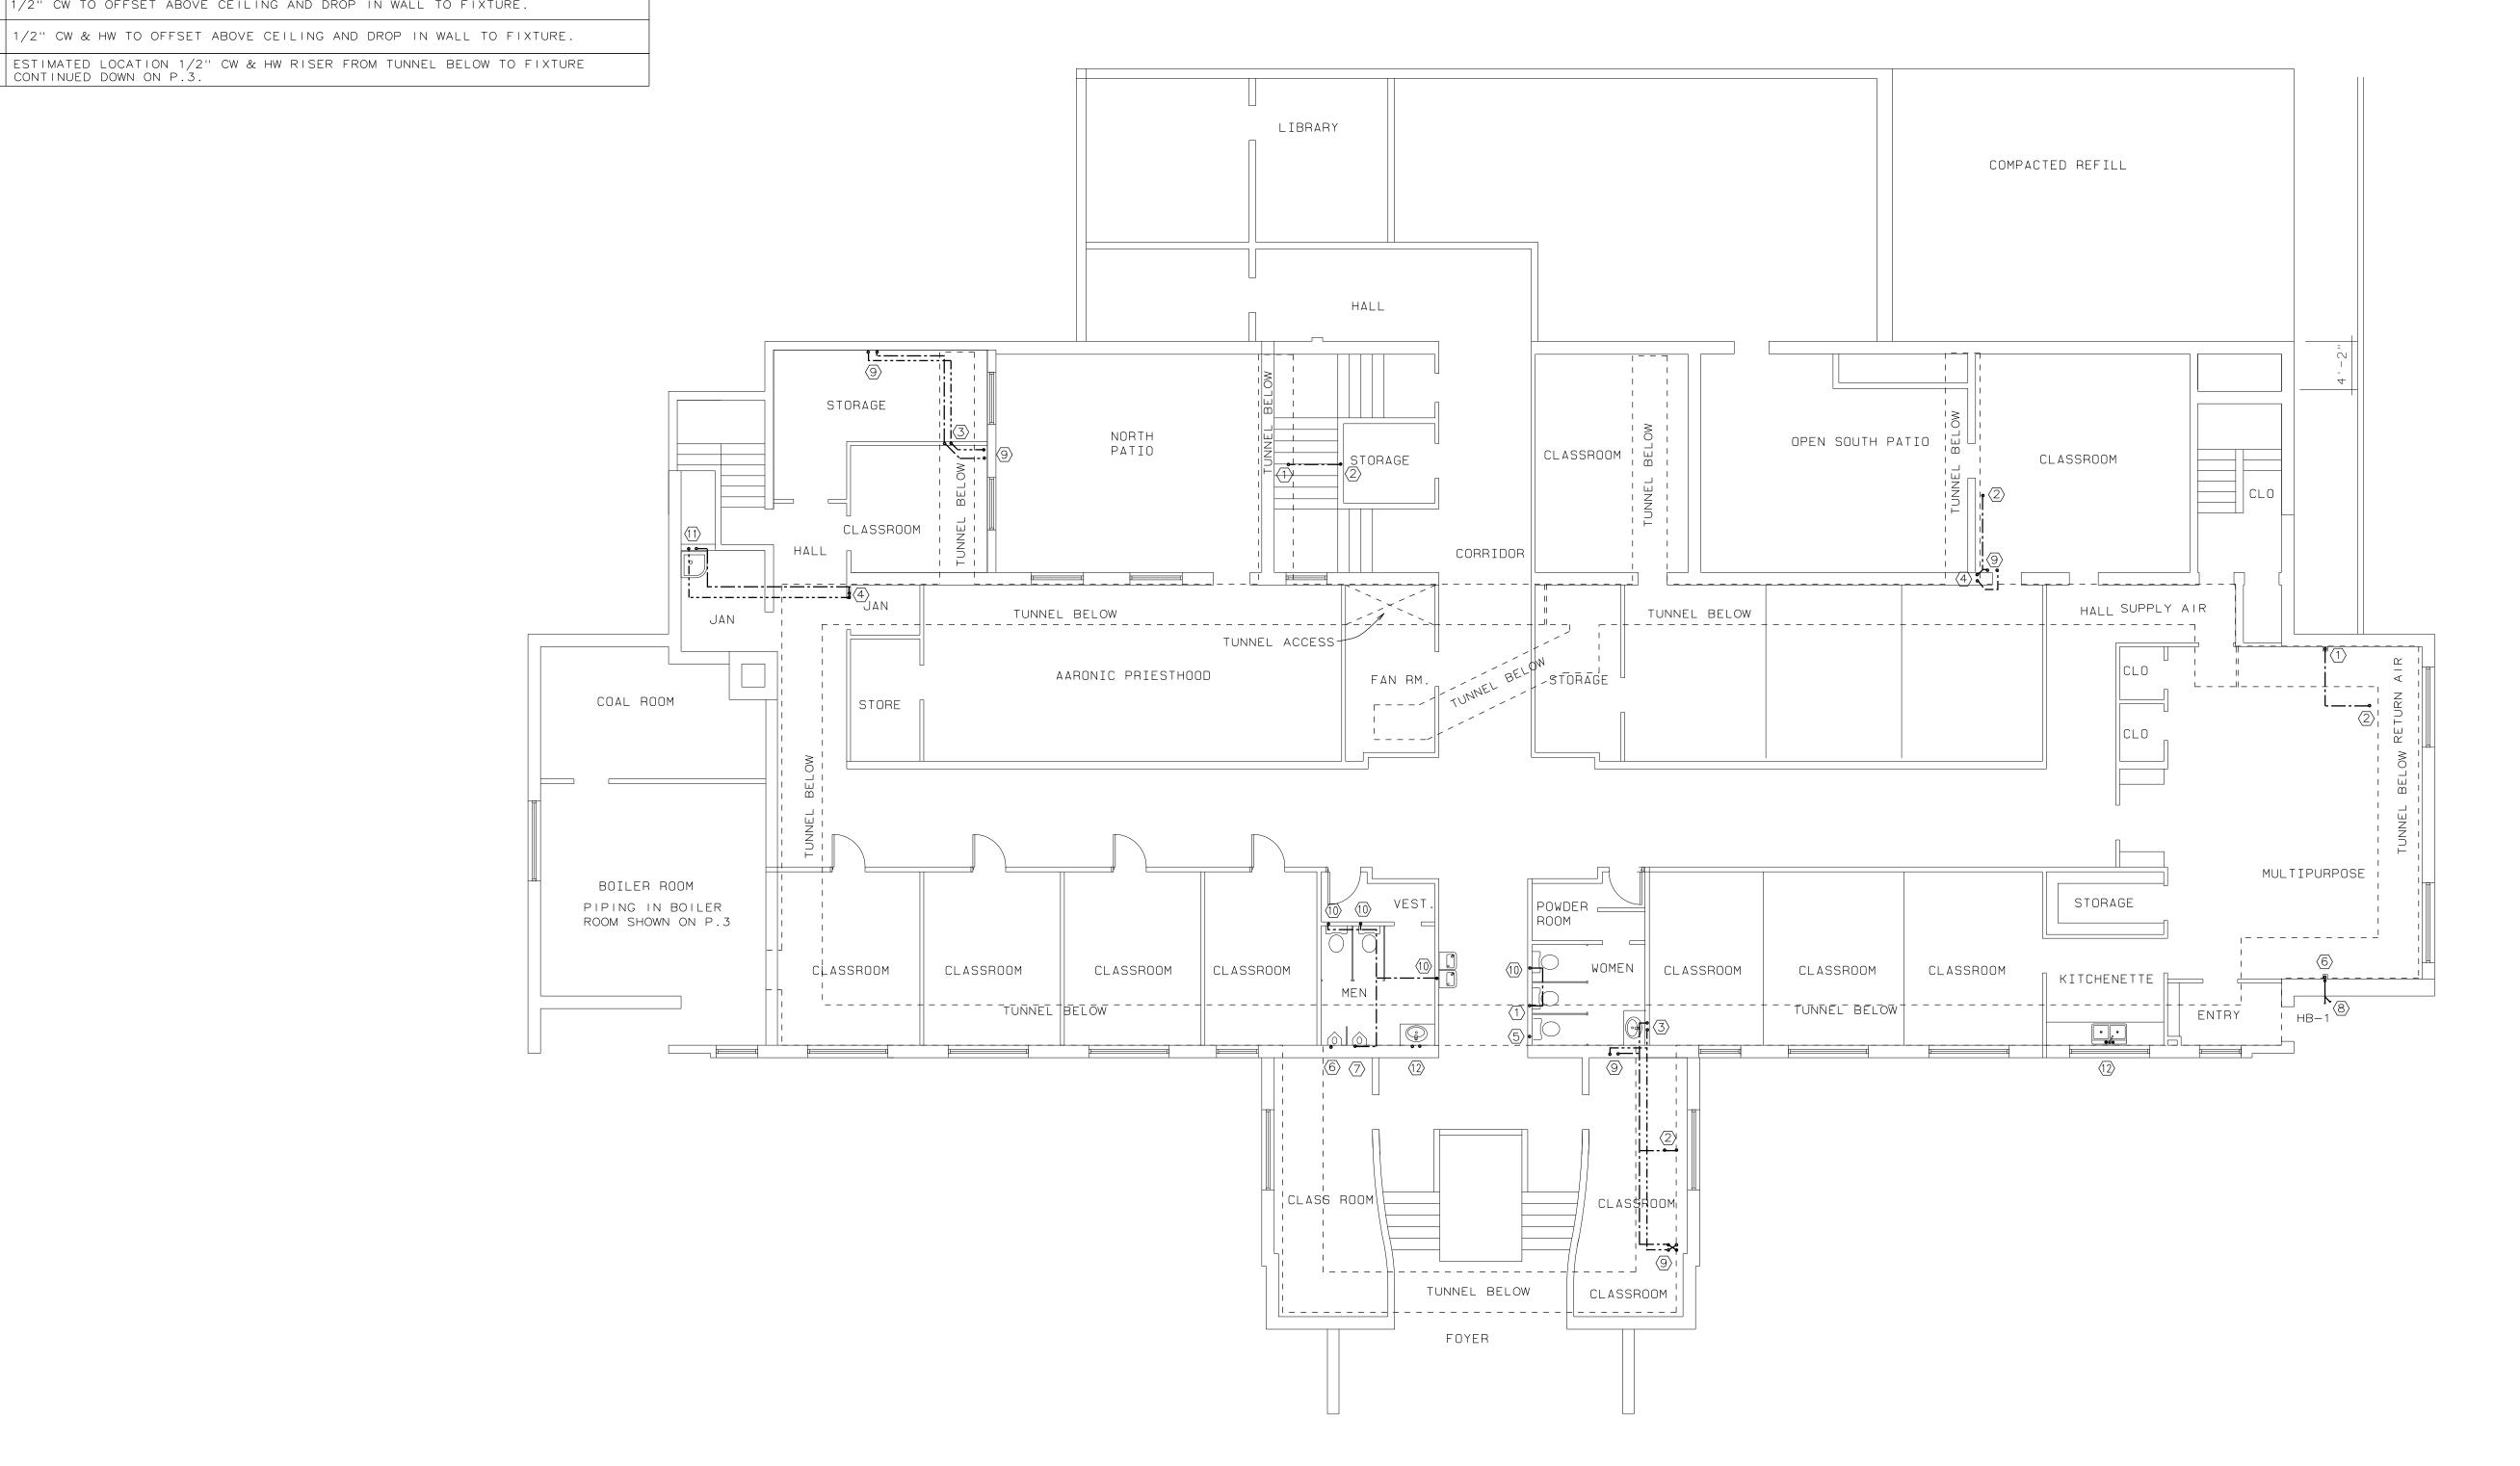

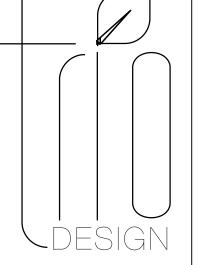

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PROJECT NAME:

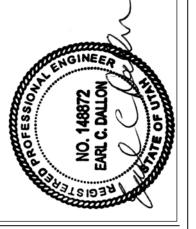Parleys YSA, MP YSA (Bldg.111 Bonneville & MP Stakes 1565 SOUTH FOOTHILLS DRIVE, SALT LAKE CITY, UTAN

PROJECT FOR:

JESUS CHRIST OF LATTER-DAY SAINTS

REVISIONS:

Date: APRIL 12, 2017 Plan Series:

_____ Property Number: 506-8258

Sheet Title:

LOWER FLOOR
PIPING PLAN

Sheet No.:

P.2

LOWER FLOOR PIPING PLAN

SCALE:
1/8"=1'-0"

KEYNOTES SYMBOL PROVIDE AND INSTALL NEW 2" WATER SERVICE LINE FROM METER TO IRRIGATION TEE. CONNECT TO EXISTING IRRIGATION LINE. PROVIDE AND INSTALL NEW 1-1/4" WATER SERVICE LINE FROM IRRIGATION TEE TO NEW COLD WATER HEADER IN BOILER ROOM. ALL PIPING IN TUNNEL TO BE RIGID ESTIMATED LOCATION OF 3/4" HW & CW RISERS FROM TUNNEL INTO WALL OR CABINET TO FIXTURES ABOVE. CONT ON P.2. ESTIMATED LOCATION OF 1/2" HW & CW RISERS FROM TUNNEL INTO WALL OR CABINET TO FIXTURES ABOVE. CONT ON P.2. ESTIMATED LOCATION OF 1/2" CW RISER FROM TUNNEL INTO WALL OR CABINET TO FIXTURES ABOVE. CONT ON P.2. ESTIMATED LOCATION OF 3/4" CW RISER FROM TUNNEL INTO WALL OR CABINET TO FIXTURES ABOVE. CONT ON P.2. EXISTING SHEET METTAL BAFFLE BETWEEN SUPPLY AND RETURN AIR SECTIONS OF TUNNEL MUST BE REPAIRED AND SEALED AIR TIGHT. INSTALL NEW NON-FREEZE HOSE BIB WITH ISOLATION BALL VALVE. FIELD VERIFY EXACT LOCATION OF EXISTING IRRIGATION TEE. IRRIGATION LINE TO BE RECONNECTED TO NEW SERVICE LINE. CONNECT NEW CW, HW & HWR TO EXISTING WATER HEATER. REPLACE EXISTING HWR CIRCULATOR AND INSTALL NEW TIMER. REUSE EXISTING POWER TO CIRCULATOR. CONNECT NEW 3/4"CW TO EXISTING BOILER WATER FEED SYSTEM. SEE DETAIL 1/P.3. SET HOT WATER HEATER TO 140 F. PROVIDE AND INSTALLL NEW COLD WATER HEADER WITH PRV. SECURE TO WALL ON UNISTRUCT. SEE DETAIL 2/P.3.

PERIODS. COORDINATE WITH FM

SET TO RUN 5 MINUTES PER

GROUP

-GRUNDFOS UP 15-42 BRONZE CIRCULATOR

O GPM

2 GPM @ 9' HEAD

1-1/4" PRV-1

COLD WATER HEADER DETAIL

SET AT 65 PSI

EQUAL BY B&G, TACO, LANG


1/2" WATTS LFCSM-61-S

HW RECIRC PUMP ISOMETRIC

EQUAL BY B&G, TACO

NO SCALE

NO SCALE

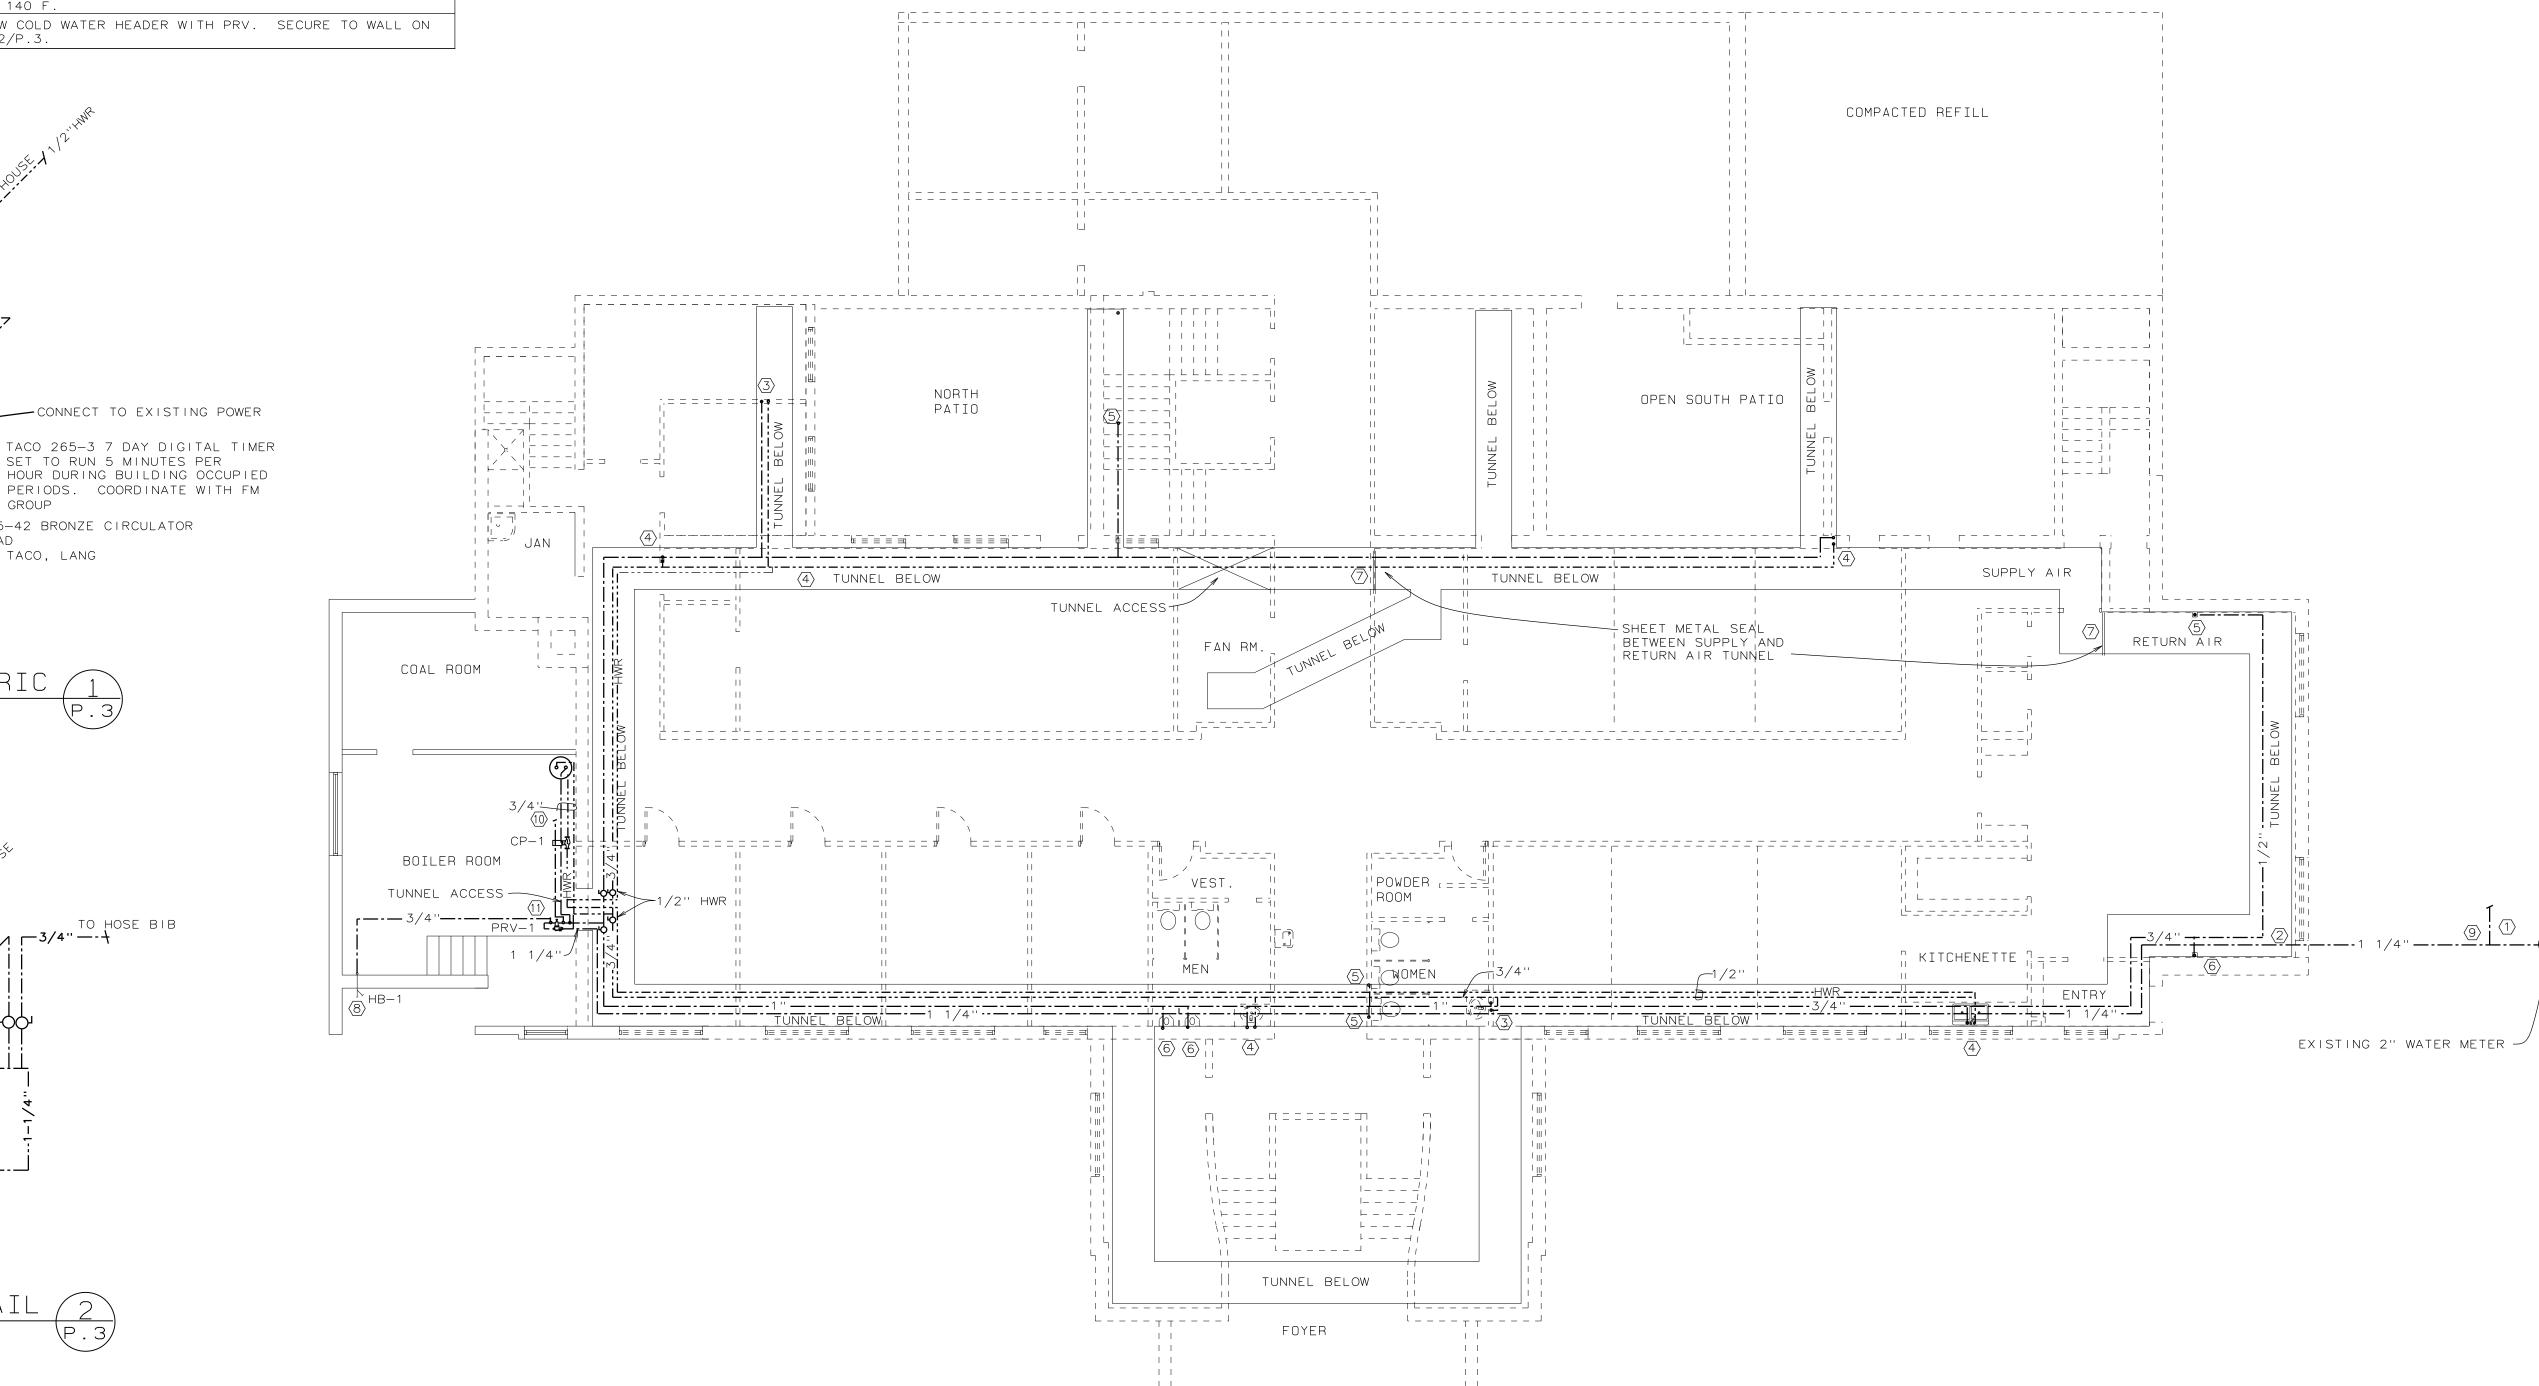

DRAWING NOTES:

1. UNDER FLOOR TUNNEL CONTAINS HEATING AND OTHER PIPING THAT IS NOT TO BE DISTURBED.

LOCATION AND ROUTING OF ALL EXISTING PIPING TO PLUMBING FIXTURES AND INSTALL NEW

3. COORDINATE DEMOLITION OF WALLS, FLOORS & CEILINGS REQUIRED WITH GENERAL CONTRACTOR

2. EXACT ROUTING OF EXISTING PIPING IS NOT KNOWN. CONTRACTOR WILL NEED TO VERIFY

4. REUSE OF EXISTING PIPE HANGERS IN UTILITY TUNNEL IS PERMITED. INSULATE COPPER

PIPING TO SERVE ALL EXISTING FIXTURES THAT ARE RETAINED.

TO MINIMIZE REQUIRED DEMOLITION AND REPAIR.


PIPE FROM FERROUS PIPE HANGERS.

5. COPPER PIPE MUST BE USED ON THIS LEVEL.

SCOPE OF WORK:

- 1. REPLACE ALL GALVANIZED CULINARY WATER PIPING SERVING THE BUILDING, FROM EXISTING 2" METER TO BUILDING AND WITHIN THE BUILDING, UNLESS NOTED TO REMAIN.
- 2. REMOVE ALL ABANDONED PIPING THAT CAN BE REMOVED WITHOUT ADDITIONAL DEMOLITION OF FLOORS, WALLS, OR CEILINGS.
- 3. REPLACE STOPS AND SUPPLIES FOR ALL FIXTURES. REMOVE EXISTING FIXTURES AS REQUIRED TO ALLOW SUPPLY PIPING TO BE REPLACED AND REPLACE FIXTURES AFTER WALLS ARE REPAIRED BY GENERAL CONTRACTOR.
- 4. REPLACE ALL EXTERIOR HOSE BIBS THAT CAN BE ACCESSED WITHOUT DEMOLITION OF FINISHES IN FINISHED AREAS. THOSE THAT CANNOT BE REPLACED ARE TO BE REMOVED, PIPING ABANDONED IN PLACE AND EXTERIOR WALL FINISH REPAIRED BY GENERAL CONTRACTOR.
- 5. REPLACE HOT WATER RECIRCULATION LINE AND PUMP & PROVIDE NEW CONTROL TIMER. EXISTING HOT WATER HEATER AND BOILER FEED WATER SYSTEM TO BE RETAINED AND NEW SUPPLY PIPING CONNECTED.
- 6. INSTALL NEW PRV AND COLD WATER HEADER IN BOILER ROOM.
- 7. IRRIGATION SYSTEM IS NOT IN CONTRACT, EXCEPT FOR RECONNECTION OF IRRIGATION MAIN TO NEW SERVICE LINE FROM METER TO BUILDING, AND REPAIR OF ANY IRRIGATION SYSTEM DAMAGED OR DISTURBED BY MAIN LINE EXCAVATION AND REPLACEMENT.
- 8. INSTALL 1/2" WATTS USG-B-M1 BLENDING VALVE UNDER EACH LAVATORY. ADJUST TO DELIVER 110F HOT WATER TO EACH LAVATORY FAUCET. EQUAL ASSE 1016 & 1070 LISTED BY PRIOR APPROVAL.

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BRUNNER & DALLON ENGINEERING

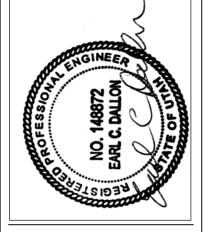PROJECT NAME: $\overline{}$

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 \Box PROJECT FOR:

REVISIONS:

APRIL 12, 2017 Plan Series:

_____ Property Number:

506-8258 Sheet Title:

TUNNEL LEVEL WATER PIPING PLAN

Sheet No.:

TUNNEL LEVEL WATER PIPING PLAN SCALE: 1/8"=1'-0"


KEYNOTES		
SYMBOL	NOTE	
1	REMOVE EXISITNG SUPPLY PIPING UP FROM BELOW TO FIXTURE.	
2	REMOVE EXISTING EXTERIOR HOSE BIB AND PIPING. HOSE BIB WILL NOT BE REPLACED. REPAIR EXTERIOR WALL SURFACE.	

DEMOLITION NOTES:


- 1. UNDER FLOOR TUNNEL CONTAINS HEATING AND OTHER PIPING THAT IS NOT TO BE DISTURBED.
- 2. EXACT ROUTING OF EXISTING PIPING IS NOT KNOWN. CONTRACTOR WILL NEED TO VERIFY EXACT LOCATION AND ROUTING OF EXISTING PIPING.
- 3. COORDINATE DEMOLITION OF WALLS, FLOORS & CEILINGS REQUIRED WITH GENERAL CONTRACTOR TO MINIMIZE REQUIRED DEMOLITION AND REPAIR.
- 4. REUSE OF EXISTING PIPE HANGERS IN UTILITY TUNNEL IS PERMITED. INSULATE COPPER PIPE FROM FERROUS PIPE HANGERS.

SCOPE OF WORK:


- 1. REPLACE ALL GALVANIZED CULINARY WATER PIPING SERVING THE BUILDING, FROM EXISTING 2" METER TO BUILDING AND WITHIN THE BUILDING, UNLESS NOTED TO REMAIN.
- 2. REMOVE ALL ABANDONED PIPING THAT CAN BE REMOVED WITHOUT ADDITIONAL DEMOLITION OF FLOORS, WALLS, OR CEILINGS.
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- 5. REPLACE HOT WATER RECIRCULATION LINE AND PUMP & PROVIDE NEW CONTROL TIMER. EXISTING HOT WATER HEATER AND BOILER FEED WATER SYSTEM TO BE RETAINED AND NEW SUPPLY PIPING CONNECTED.
- 6. INSTALL NEW PRV AND COLD WATER HEADER IN BOILER ROOM.
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- 8. INSTALL 1/2" WATTS USG—B—M1 BLENDING VALVE UNDER EACH LAVATORY. ADJUST TO DELIVER 110F HOT WATER TO EACH LAVATORY FAUCET. EQUAL ASSE 1016 & 1070 LISTED BY PRIOR APPROVAL.

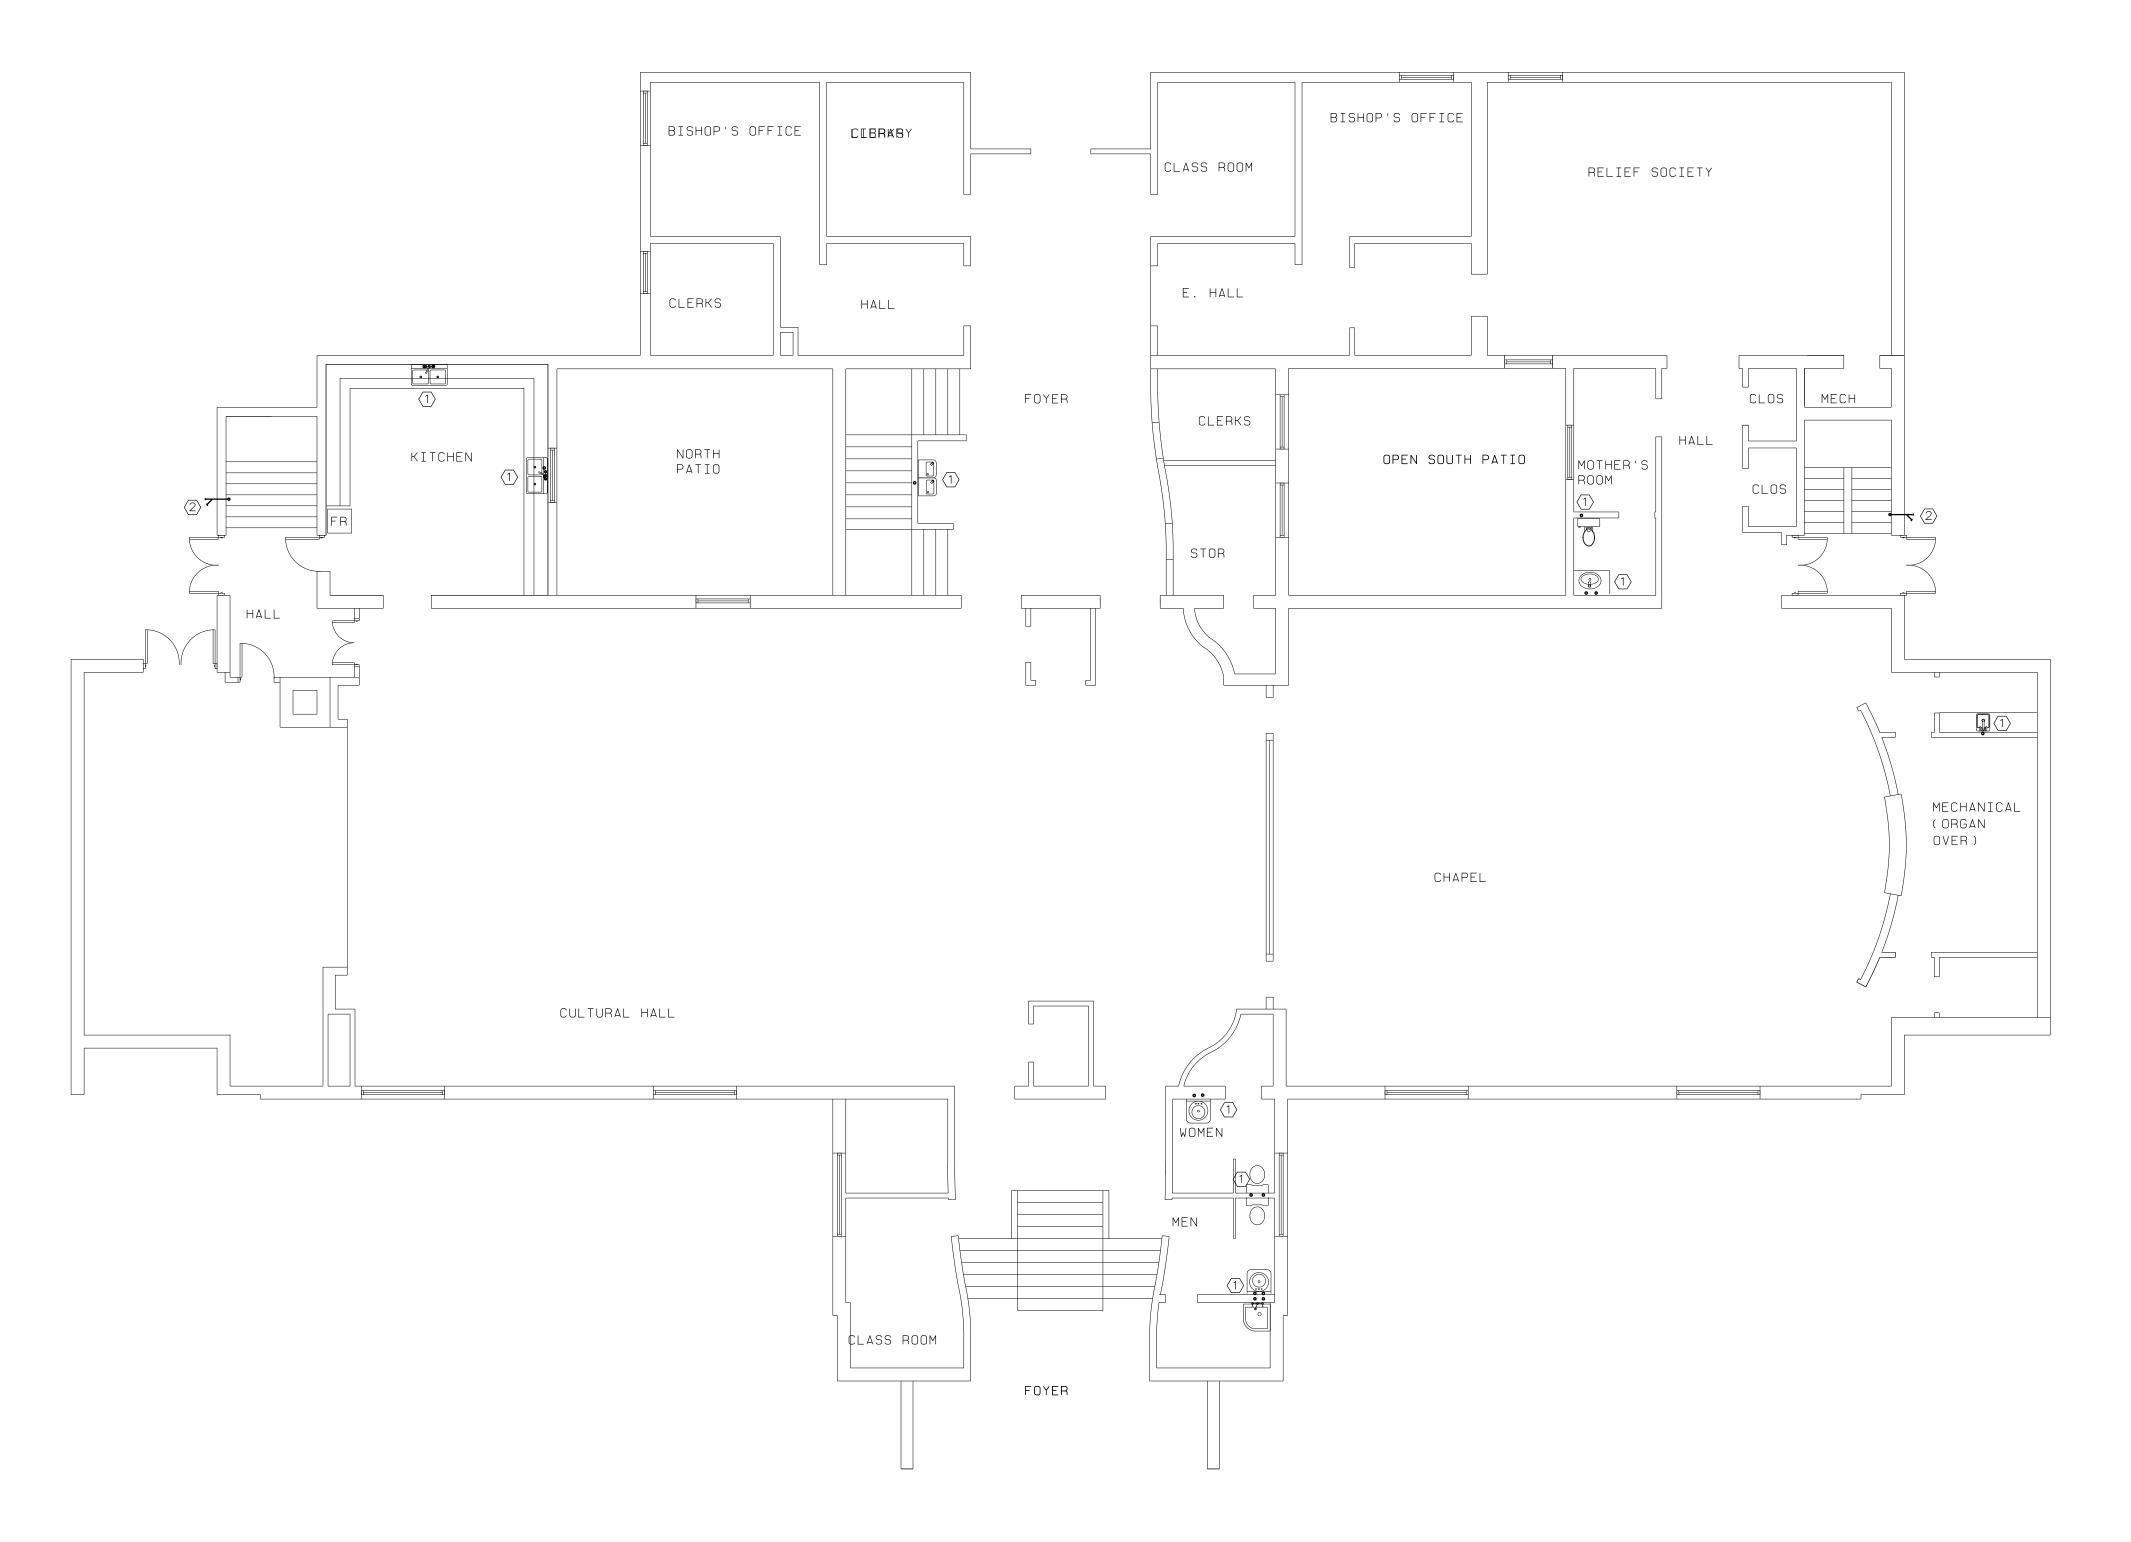

MAIN FLOOR PLUMBING DEMOLITION PLAN
scale:
1/8"=1'-0"

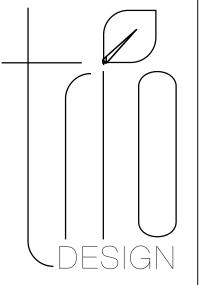

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PROJECT NAME:
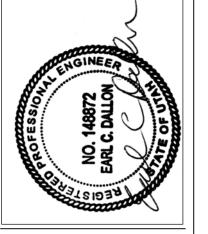
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PROJECT FOR:

JESUS CHRIST OF LATTER-DAY SAINTS

REVISIONS:

Date: APRIL 12, 2017 Plan Series:

Property Number: 506-8258

Sheet Title: MAIN FLOOR PLUMBING

DEMO PLAN

Sheet No.:

KEYNOTES		
YMBOL	NOTE	
1	REMOVE EXISTING EXTERIOR HOSE BIB AND PIPING. HOSE BIB TO BE REPLACED.	
2	REMOVE EXISTING EXTERIOR HOSE BIB AND PIPING. HOSE BIB WILL NOT BE REPLACED. REPAIR EXTERIOR WALL SURFACE.	
3	ESTIMATED LOCATION OF RISER FROM TUNNEL INTO WALL OR UNDER STAIRS ABOVE. REMOVE PIPING.	
4	ESTIMATED LOCATION OF OVERHEAD PIPING AND RISER TO UPPER LEVEL. REMOVE PIPING.	
(5)	ESTIMATED LOCATION OF RISER IN WALL. PIPING TO RUN ABOVE CEILING AND DROP IN WALL TO FIXTURE.	
6	THIS SINK TO BE REMOVED AND NOT REPLACED. REMOVE PIPING AND CAP EXISTING WASTE & VENT INSIDE WALL.	
7	COLD WATER RISE BELOW STAIR TO EXTERIOR HOSE BIB TO BE REMOVED.	


DEMOLITION NOTES:

- 1. UNDER FLOOR TUNNEL CONTAINS HEATING AND OTHER PIPING THAT IS NOT TO BE DISTURBED.
- 2. EXACT ROUTING OF EXISTING PIPING IS NOT KNOWN. CONTRACTOR WILL NEED TO VERIFY EXACT LOCATION AND ROUTING OF EXISTING PIPING.
- 3. COORDINATE DEMOLITION OF WALLS, FLOORS & CEILINGS REQUIRED WITH GENERAL CONTRACTOR TO MINIMIZE REQUIRED DEMOLITION AND REPAIR.
- 4. REUSE OF EXISTING PIPE HANGERS IN UTILITY TUNNEL IS PERMITED. INSULATE COPPER PIPE FROM FERROUS PIPE HANGERS.


SCOPE OF WORK:

- 1. REPLACE ALL GALVANIZED CULINARY WATER PIPING SERVING THE BUILDING, FROM EXISTING 2" METER TO BUILDING AND WITHIN THE BUILDING, UNLESS NOTED TO REMAIN.
- 2. REMOVE ALL ABANDONED PIPING THAT CAN BE REMOVED WITHOUT ADDITIONAL DEMOLITION OF FLOORS, WALLS, OR CEILINGS.
- 3. REPLACE STOPS AND SUPPLIES FOR ALL FIXTURES. REMOVE EXISTING FIXTURES AS REQUIRED TO ALLOW SUPPLY PIPING TO BE REPLACED AND REPLACE FIXTURES AFTER WALLS ARE REPAIRED BY GENERAL CONTRACTOR.
- 4. REPLACE ALL EXTERIOR HOSE BIBS THAT CAN BE ACCESSED WITHOUT DEMOLITION OF FINISHES IN FINISHED AREAS. THOSE THAT CANNOT BE REPLACED ARE TO BE REMOVED, PIPING ABANDONED IN PLACE AND EXTERIOR WALL FINISH REPAIRED BY GENERAL CONTRACTOR.
- 5. REPLACE HOT WATER RECIRCULATION LINE AND PUMP & PROVIDE NEW CONTROL TIMER. EXISTING HOT WATER HEATER AND BOILER FEED WATER SYSTEM TO BE RETAINED AND NEW SUPPLY PIPING CONNECTED.
- 6. INSTALL NEW PRV AND COLD WATER HEADER IN BOILER ROOM.
- 7. IRRIGATION SYSTEM IS NOT IN CONTRACT, EXCEPT FOR RECONNECTION OF IRRIGATION MAIN TO NEW SERVICE LINE FROM METER TO BUILDING, AND REPAIR OF ANY IRRIGATION SYSTEM DAMAGED OR DISTURBED BY MAIN LINE EXCAVATION AND REPLACEMENT.
- 8. INSTALL 1/2" WATTS USG—B—M1 BLENDING VALVE UNDER EACH LAVATORY. ADJUST TO DELIVER 110F HOT WATER TO EACH LAVATORY FAUCET. EQUAL ASSE 1016 & 1070 LISTED BY PRIOR APPROVAL.



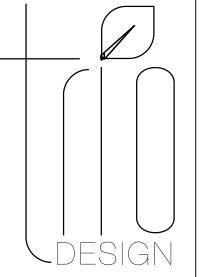

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Stakes
LILAKE CITY, UTAH

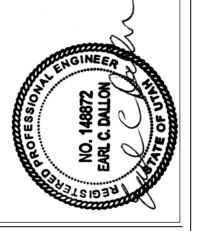PROJECT NAME:

Parleys YSA, MP YSA I Bonneville & MP S 1565 SOUTH FOOTHILLS DRIVE, SALT L

PROJECT FOR:

JESUS CHRIST OF LATTER-DAY SAINTS

REVISIONS:

Date: APRIL 12, 2017 Plan Series:

Property Number: 506-8258

Sheet Title:
LOWER FLOOR
PLUMBING
DEMO PLAN

Sheet No.:

P.2D

LOWER FLOOR PLUMBING DEMOLITION PLAN
SCALE:
1/8"=1'-0"

KEYNOTES


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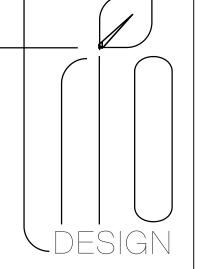
- REMOVE EXISTING GALVANIZED LINE FROM 2" METER TO BUILDING. REPAIR ANY DAMAGE TO IRRIGATION PIPING CAUSED BY REMOVAL.
- REMOVE EXISTING 1-1/2" GALVANIZED SUPPLY MAIN FROM BUILDING ENTRANCE TO PRV AND COLD WATER HEADER LOCATED IN BOILER ROOM. DO NOT DAMAGE NON CULINARY WATER PIPING IN THE TUNNEL.
- (3) ESTIMATED LOCATION OF RISER FROM TUNNEL INTO WALL OR CABINET ABOVE.
- REMOVE ALL EXISTING COLD WATER, HOT WATER AND HOT WATER RECIRC PIPING LOCATED IN TUNNEL. TAKE CARE NOT TO DAMAGE OTHER EXISTING PIPING LOCATED IN TUNNEL. REMOVE ADDITIONAL GALVANIZED WATER PIPE IN TUNNEL NOT SHOWN ON DRAWING. SEAL ANY HOLES IN TUNNEL NOT REUSED AIR TIGHT.
- REMOVE ALL EXISTING GALVANIZED CULINARY WATER PIPING, VALVES & PRV LOCATED IN BOILER ROOM. DO NOT CHANGE BOILER FEED WATER PIPING.
- SINK ABOVE IS NOT RETAINED THIS PIPING WILL NOT BE REPLACED.
- (7) EXISTING SHEET METTAL BAFFLE BETWEEN SUPPLY AND RETURN AIR SECTIONS OF TUNNEL MUST BE REPAIRED AND SEALED AIR TIGHT.
- EXISTING HOSE BIB TO BE REPLACED.
- FIELD VERIFY EXACT LOCATION OF EXISTING IRRIGATION TEE. IRRIGATION LINE TO BE RECONNECTED TO NEW SERVICE LINE.

- DEMOLITION NOTES:
- 1. UNDER FLOOR TUNNEL CONTAINS HEATING AND OTHER PIPING THAT IS NOT TO BE DISTURBED.
- 2. EXACT ROUTING OF EXISTING PIPING IS NOT KNOWN. CONTRACTOR WILL NEED TO VERIFY LOCATION AND ROUTING OF ALL EXISTING GALVANIZED WATER PIPE AND REMOVE ALL EXISTING ACTIVE AND ABANDONED GALVANIZED PIPING LOCATED IN THE TUNNEL.
- 3. COORDINATE DEMOLITION OF WALLS, FLOORS & CEILINGS REQUIRED WITH GENERAL CONTRACTOR TO MINIMIZE REQUIRED DEMOLITION AND REPAIR.
- 4. REUSE OF EXISTING PIPE HANGERS IN UTILITY TUNNEL IS PERMITED. INSULATE COPPER PIPE FROM FERROUS PIPE HANGERS.


SCOPE OF WORK:

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PROJECT NAME:

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PROJECT FOR:

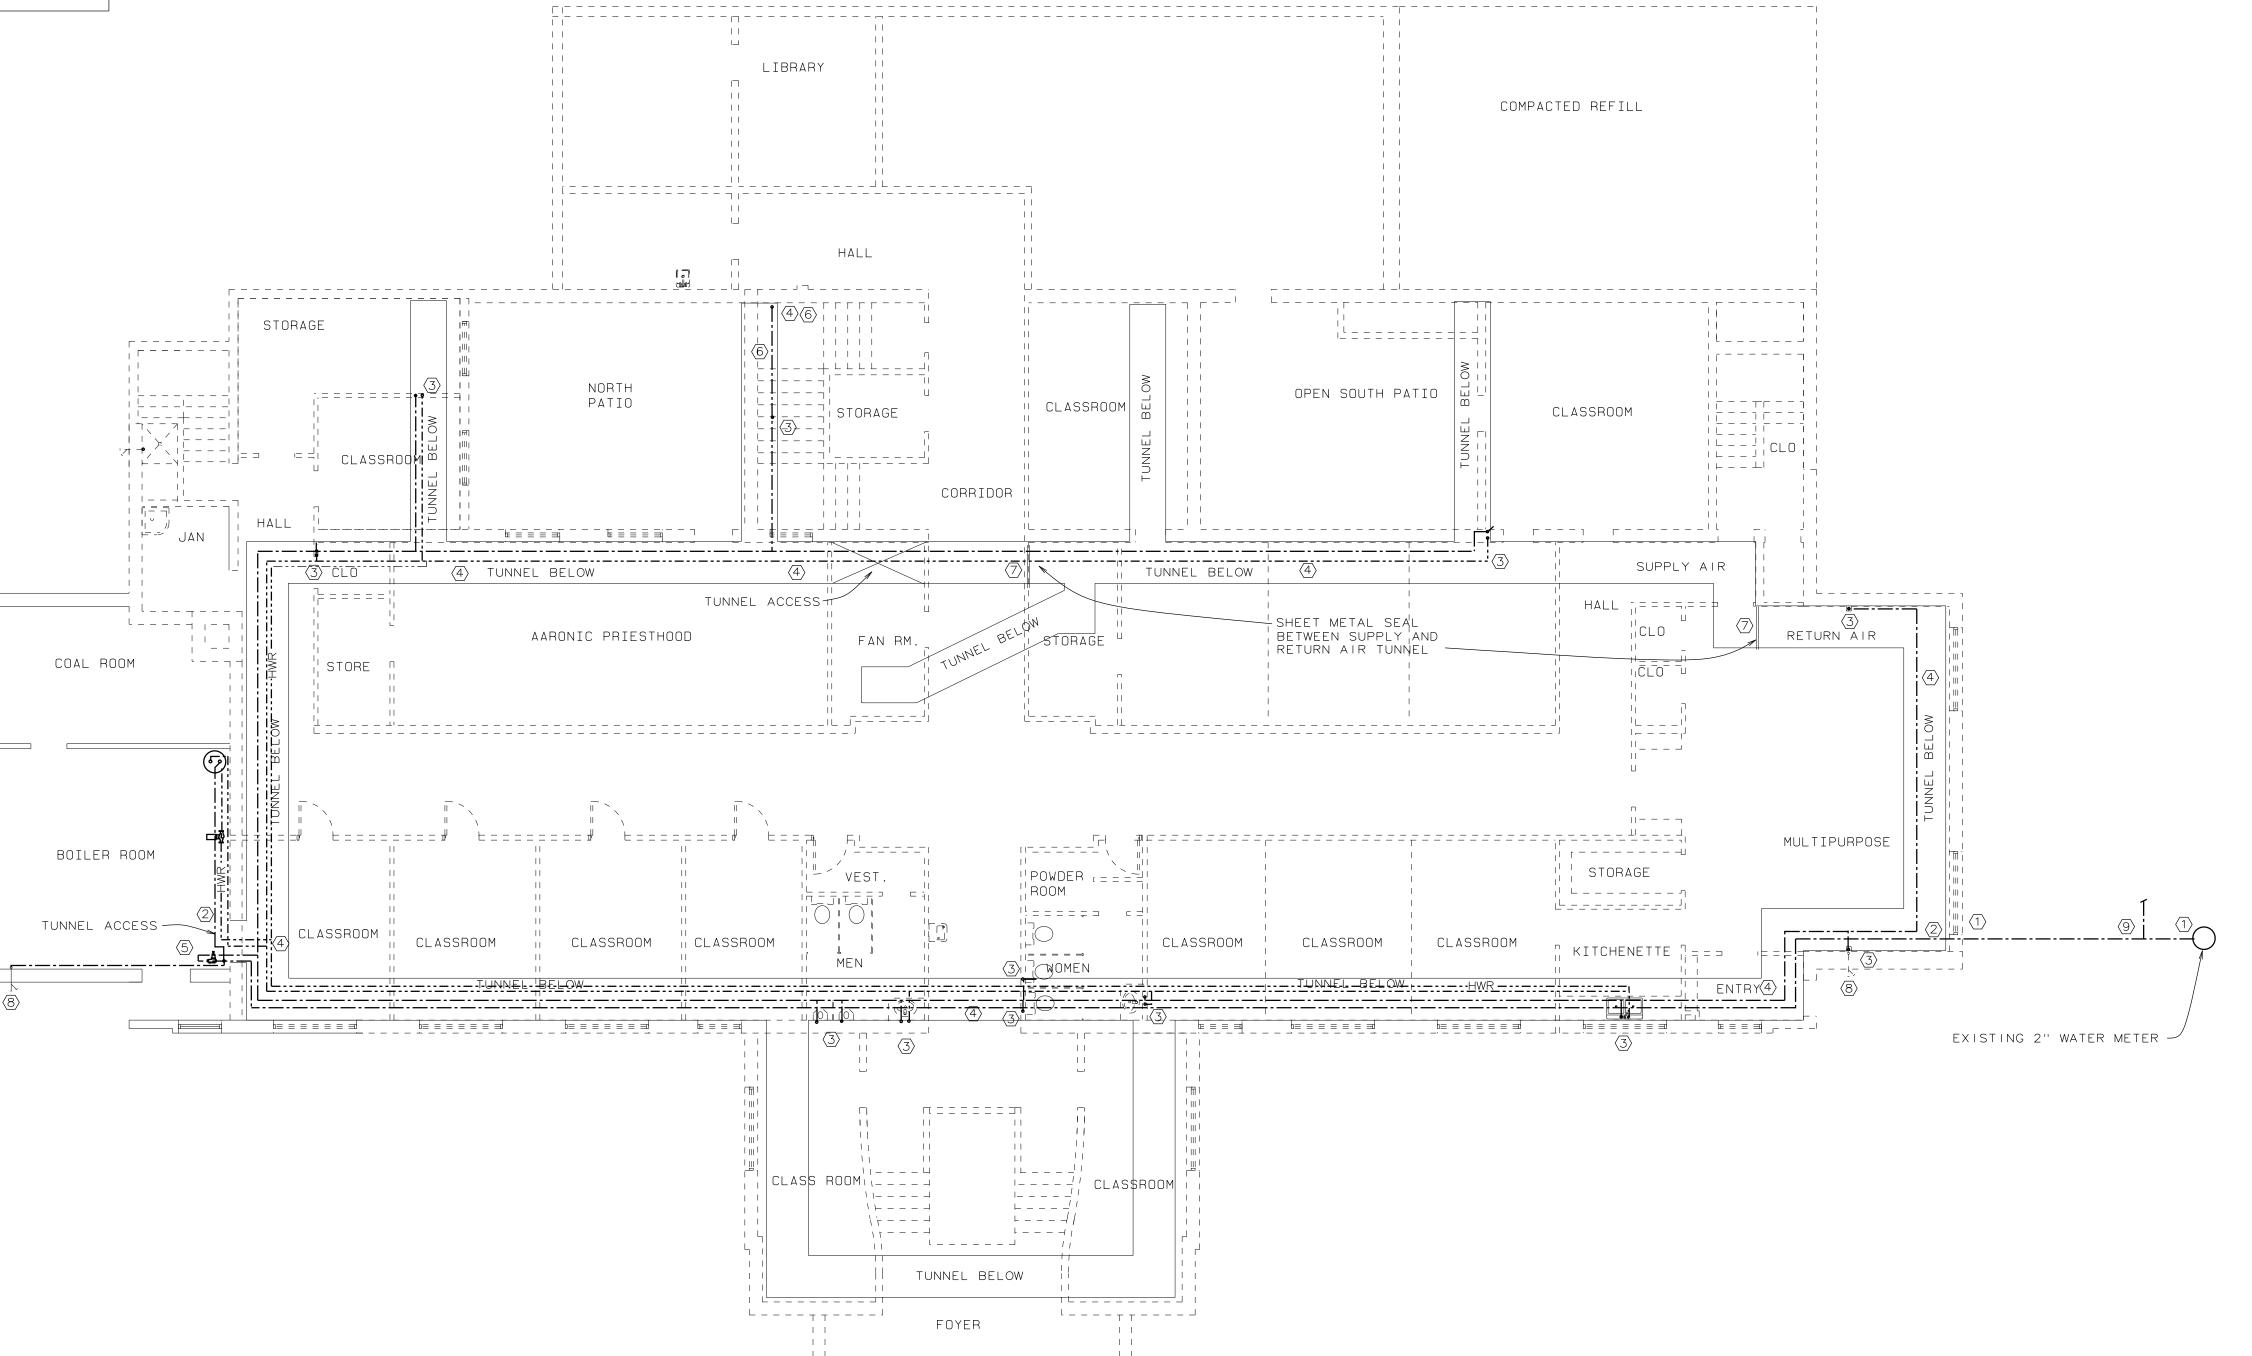THE CHURCH OF

JESUS CHRIST

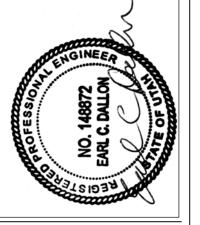OF LATTER-DAY SAINTS

REVISIONS:

Date: APRIL 12, 2017

Plan Series:
----Property Number:

506-8258

Sheet Title:

TUNNEL LEVEL PLUMBING DEMO PLAN

Sheet No.:

P.3D

TUNNEL LEVEL PLUMBING DEMOLITION PLAN
SCALE:
1/8"=1'-0"