


MIDVALLEY 2,4,6 SANDY UT MIDVALLEY STAKE SITE: 1160 EAST 8050 SOUTH, SANDY, UTAH

THE CHURCH OF JESUS CHRIST OF LATTER-DAY SAINTS PROJECT NUMBER: 5338409-19030101

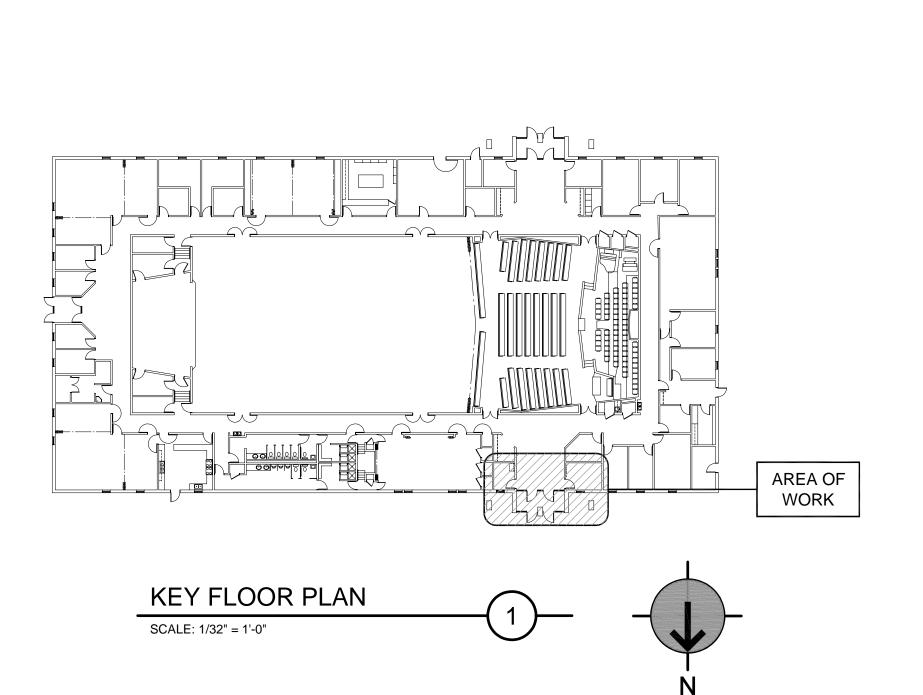


·						
DRAPERY SCHEDULE						
LOCATION	TYPE	NO. RE	QUIRED	NOTES	REMARKS	
LOCATION		PAIR	SINGLE	INOTES	REMARKS	
MOTHERS' 103	Р	1		1		
MOTHERS' 103		1		2		

NOTES:

NEW DRAPE AND RODS. INSET IN WINDOW OPENING. (1)


(2) CEILING-MOUNTED PRIVACY DRAPE. SEE SPECIFICATIONS

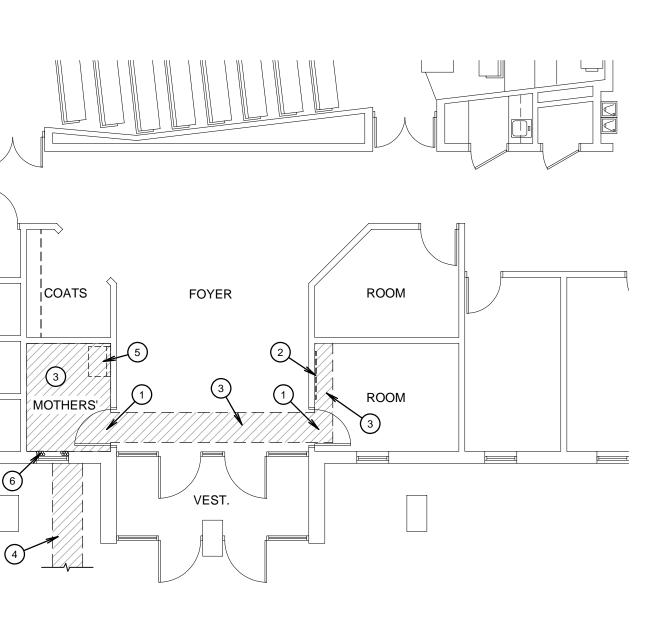

DEMOLITION FLOOR PLAN

SCALE: 1/8" = 1'-0"


	KEYED DEMOLITION NOTES
1	REMOVE SELECTED DOOR HARDWARE. EXISTING DOOR, FRAME AND HARDWARE TO REMAIN. SEE SHEET A601.
2	REMOVE EXISTING VISUAL DISPLAY BOARD AND SALVAGE TO OWNER.
3	REMOVE EXISTING CARPET, CONCRETE SLAB, BASE, SOILS AND OTHER WORK AS REQUIRED TO ACCOMMODATE NEW WORK. SEE MECHANICAL DRAWINGS FOR EXISTING UNDERGROUND DUCT WORK.
4	REMOVE EXISTING SOILS, LANDSCAPING, IRRIGATION AND SITE CONCRETE TO ACCOMMODATE SEWER LINE. SEE PLUMBING DRAWINGS.
5	REMOVE AND SALVAGE EXISTING BABY CHANGING STATION.
6	REMOVE EXISTING DRAPERY AND RODS
5	REMOVE EXISTING SOILS, LANDSCAPING, IRRIGATION AND SITE CONCRETE TO ACCOMMODATE SEWER LINE. SEE PLUMBING DRAWINGS. REMOVE AND SALVAGE EXISTING BABY CHANGING STATION.

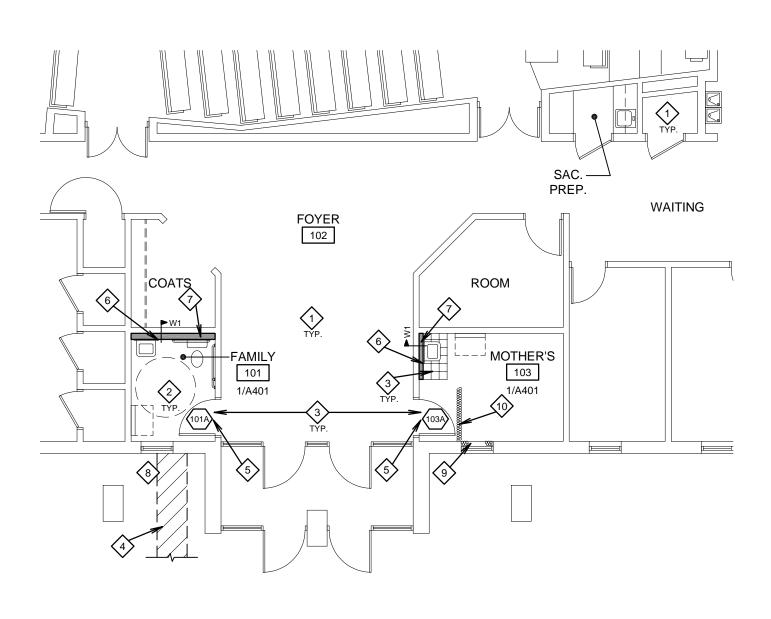

SOUTH CLASSROOMS **NEW FLOOR PLAN**

SCALE: 1/8" = 1'-0"

	KEYED NOTES
	PATCH EXISTING WALLS, FLOORS AND CEILINGS TO DISTURBED BY NEW WORK.
2	REINSTALL ALL EXISTING WORK REMOVED TO ACC SEWER INSTALLATION. INSTALL SOIL BACK FILL, 4 AND 4" CONCRETE SLAB. RECESS 2" FOR TILE SET
\$	REINSTALL ALL EXISTING WORK REMOVED TO ACC SEWER INSTALLATION. INSTALL SOIL BACK FILL, 4 AND 4" LEVEL CONCRETE SLAB INFILL. PREPARE F INSTALLATION. NEW CARPET FURNISHED AND INS OWNER. MATCH EXISTING BASE.
4	COMPACT BACK FILL WHERE NEW SEWER IS INSTAL LANDSCAPING, SPRINKLING, MOW STRIPS, CONCR OTHER DISTURBED WORK TO MATCH EXISTING. SI PHOTOGRAPHS THIS SHEET AND PLAN 1/P101.
5	NEW HARDWARE IN EXISTING DOOR AND FRAME.
	NEW WALL-MOUNTED WATER HEATER. SEE PLUM AND ELECTRICAL NOTES.
\Diamond	PATCH EXISTING SHINGLE ROOFING ABOVE TO MA FLASHING FOR NEW VENT. SEE ROOFING DETAIL A PLUMBING DRAWINGS FOR LOCATION.
8	PATCH EXISTING SOFFIT FOR NEW EXHAUST FAN MECHANICAL DRAWINGS FOR LOCATION.
9	NEW DRAPERY. SEE SCHEDULE THIS SHEET.
	NEW CEILING MOUNTED DRAPERY. SEE SCHEDULE

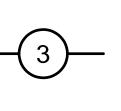

TO MATCH WHERE

COMMODATE NEW 4" GRAVEL BASE TING BED.

COMMODATE NEW 4" GRAVEL BASE FOR CARPET ISTALLED BY

TALLED. PATCH RETE WALKS AND SEE


. SEE SHEET A601. MBING DRAWINGS

ATCH. NEW A/A151 AND

VENT. SEE


LE THIS SHEET.

A 4 0 4	RAWING INDEX	-
A 4 0 4	ARCHITECTURAL	S
A101	FLOOR PLANS	
A151	REFLECTED CEILING PLANS AND ROOFING DETAILS	59
A401	ENLARGED RESTROOM AND MOTHERS' ROOM	
A601	FINISH & DOOR SCHEDULES AND DETAILS	Dradley gygi architeC & associates, pllc 150 South 1300 East, Suite 500 alt Lake City, Utah 84106 alt Lake City, Utah 84106
	PLUMBING	V GVG Ciate D East, Suit
P101	PLUMBING PLUMBING PLANS	JIG
	MECHANICAL	SS SS International Internatio
M101	MECHANICAL PLANS	bradl & ass salt Lake C 801.747.245
		br 2150 & 1 2150 Sal t1
	ELECTRICAL	-
E101	ELECTRICAL PLANS	
	GENERAL DEMOLITION NOTES	
	LITION DRAWINGS ARE SHOWN TO ASSIST CONTRACTOR	
EXTEN	AND ARE NOT INTENDED TO BE ALL-INCLUSIVE OR TO LIMIT IT OF DEMOLITION WORK REQUIRED. CONTRACTOR SHALL	STAMP:
TRADE	THE SITE PRIOR TO BIDDING AND COORDINATE WITH ALL ES AND DRAWINGS TO DEFINE EXTENT OF DEMOLITION	SED ARCHIN
-	REQUIRED TO PERFORM NEW WORK AND TO CARRY OUT ITENT OF THESE CONTRACT DRAWINGS.	No. 6112728
2. OWNE	R HAS FIRST RIGHTS TO SALVAGE. LL OTHER DOCUMENTS FOR ADDITIONAL DEMOLITION	-813 Sr. 80
REQU	REMENTS: COORDINATE. RACTOR TO MAINTAIN STRUCTURAL INTEGRITY OF EXISTING	BRADLEY G
STRU	CTURE. PROVIDE HEADERS, FRAMING OR STRUCTURAL DRT / SHORING TO ACCOMMODATE NEW OPENINGS,	5.20.19
REMO	VED STRUCTURE, ETC.	OF OF
EXIST	E SHOWN ZZZZZZZ POCHED ON PLAN, REMOVE NG WALL OR PORTION OF WALL - COMPLETE. REMOVE ALL	
WALL.	6, WIRING, EQUIPMENT, AND OTHER ITEMS CONCEALED IN COORDINATE ITEMS TO BE MAINTAINED AND ABANDONED	
WITH	ALL DISCIPLINES.	
		STAKE
	GENERAL NOTES	DVALLEY 2,4,6 T MIDVALLEY S EAST 8050 SOUTH SANDY, UTAH
	GENERAL NUTES	2,4,6 _LEY { south
	LLS ARE SHOWN "POCHED" TYPICAL.	VALLEY MIDVAL
ELECTRI	XISTING WORK IS TO REMAIN - MECHANICAL, PLUMBING, CAL, SOUND OR OTHER WORK WHICH IS ENCOUNTERED	− 1 1 1 1 1 1 1 1 1 1 1 1 1 1
WITH RE	MOVAL OF FLOORS, WALLS OR CEILINGS, SHALL BE TED INTO NEW OR EXISTING WORK TO MAINTAIN	
CONTINU		MIDVALLEY SANDY UT MIDVAL 1106 EAST 8050 SANDY, UT
PARTITIC	DNS, VANITY BRACKETS, CASEWORK, RAILINGS/GRAB BARS, DARDS, PARTITIONS, AND OTHER EQUIPMENT AND	7 7
ACCESS	ORIES.	INA
VISQUEE	G CARPET TO REMAIN. COVER WITH HEAVY REINFORCED EN TAPED AT ALL JOINTS AND ALONG EDGES TO PROTECT	ر ک
5. PATCH A	CONSTRUCTION. LL WALLS, FLOORS AND CEILINGS TO MATCH WHERE	
	OR - PATCHING/FINISHES:	
WORK. WA	REPAIR ALL EXISTING WORK DISTURBED BY THIS NEW LLS, CEILINGS, FLOORS, TRIM AND OTHER WORK SHALL BE	STY
WORK IS TO	O MATCH EXISTING FINISHES FOR SPACE WHERE EXISTING D BE REPLACED AND FURRED OUT. REMOVE AND	NAL OF
REINSTALL	EXTEND EXISTING FIXTURES, DEVICES, CONVECTORS, DUVERS, EQUIPMENT AND OTHER EXISTING WORK TO NEW	ROJECT FOR: CHURCH OF S CHRUS' TER-DAY SAINTS
	TO ACCOMMODATE NEW WORK.	
INSULA	TION:	PROJECT FOR CHURCH S CH TER-DAY
CEILINGS:	INSTALL EQUIVALENT TO R-38 INSULATION AT ALL NEW	THE SUS
	ATTIC OR DISTURBED ATTIC AREAS. PROVIDE COMPLETE ENVELOPE.	
WALLS:	REPLACE REMOVED INSULATION WITH EQUIVALENT TO	H N H
WALLS:	MATCH EXISTING AT EXISTING WALLS.	JES OF 1
CAULK	MATCH EXISTING AT EXISTING WALLS.	JES
CAULK	MATCH EXISTING AT EXISTING WALLS.	
CAULK ALL OF NEW WO	MATCH EXISTING AT EXISTING WALLS.	
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CAULK ALL OF NEW WO PRIOR TO F FIRESTOP / WITH CURF STRUC MAINTAIN S HEADERS, I NEW OPEN	MATCH EXISTING AT EXISTING WALLS. ING: NEW AND EXISTING DOOR AND WINDOW FRAMES AT AREAS DRK. ENTIRE PERIMETER - EXTERIOR AND INTERIOR. CAULK ANNTING AND FINISH WORK. OPPING: ALL WALL, FLOOR AND CEILING PENETRATIONS TO COMPLY SENT CODES. TURAL: TRUCTURAL INTEGRITY OF EXISTING STRUCTURE. PROVIDE FRAMING OR STRUCTURAL SUPPORT TO ACCOMMODATE NGS, REMOVED STRUCTURE, ETC. WALL TYPES SCHEDULE DESCRIPTION EX4 STUDS AT 16" O.C. WITH 5/8" GYPSUM BOARD AT EXPOSED	PROJECT NUMBER: 5338409-19030101 DATE: 20 MAY 2019 PROPERTY NUMBER: 5338409 DRAWN BY: BGG DRAWN BY: BGG CHECKED: BGG SHEET TITLE: FLOOR PLANS AND NOTES

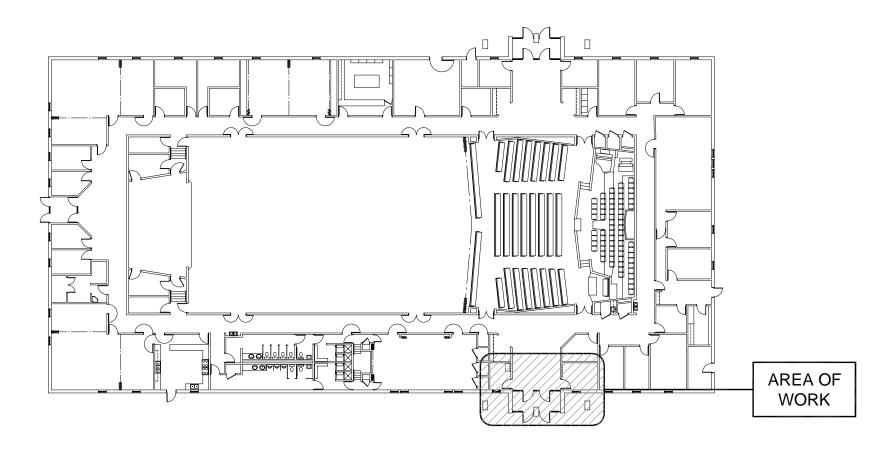


KEY PLAN


LIGHT FIXTURES
SMOKE DETECTORS
MECHANICAL AIR GF
AUDIO SPEAKERS
FOLDING PANEL PARTITIONS
CEILING ACCESS

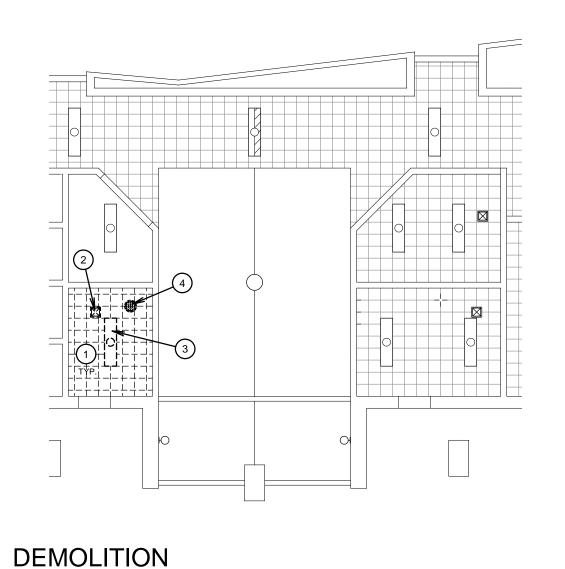



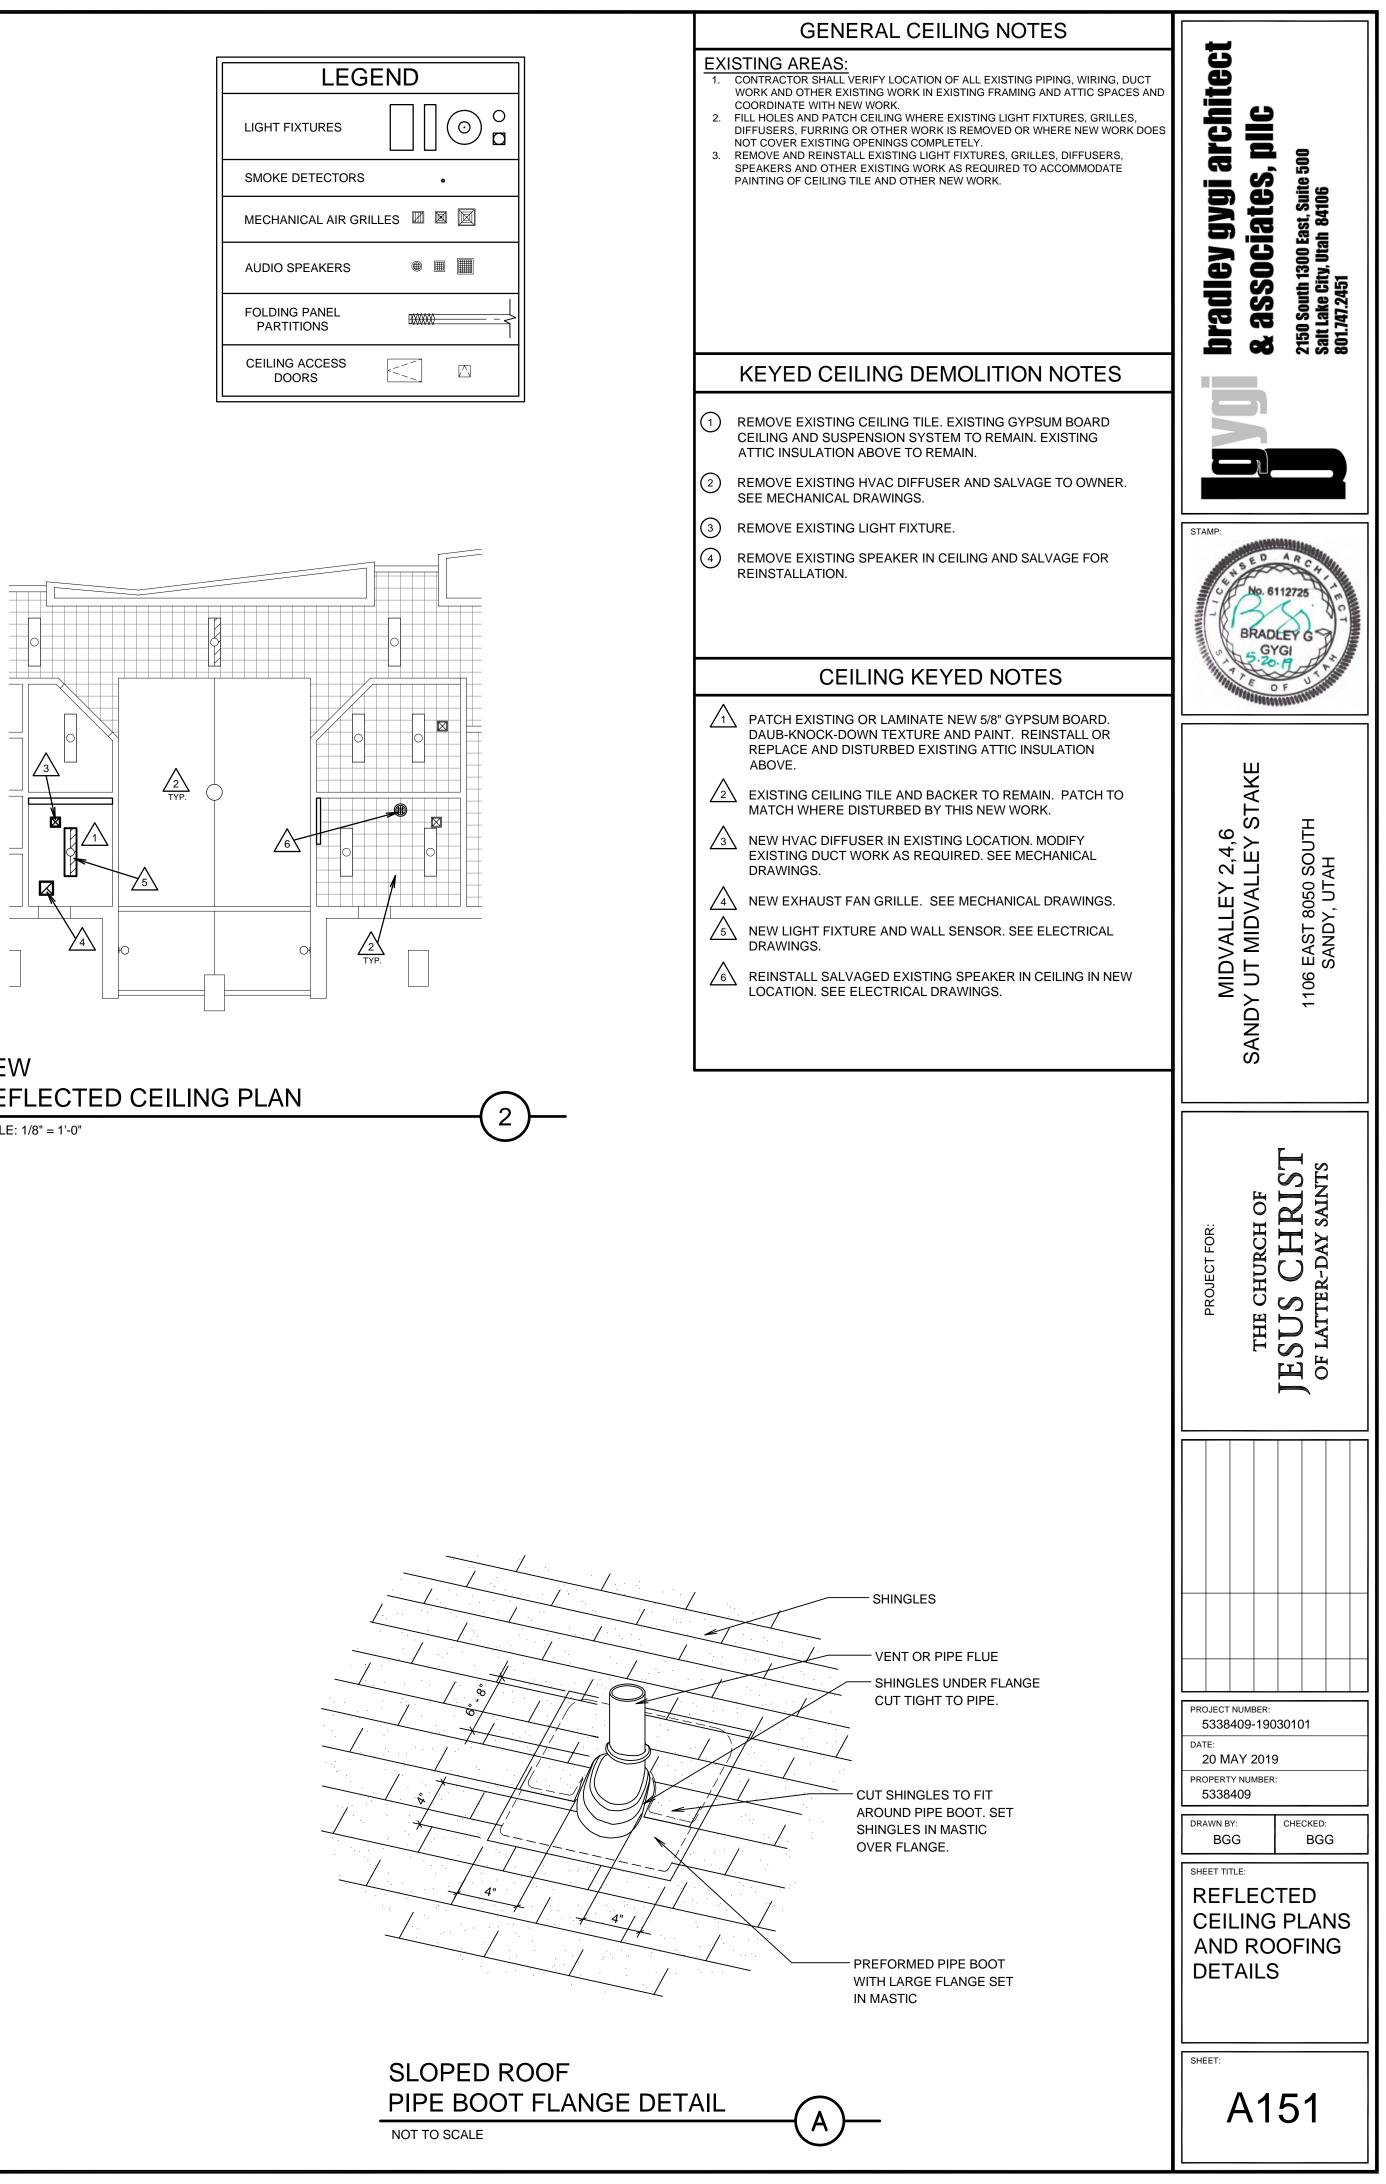




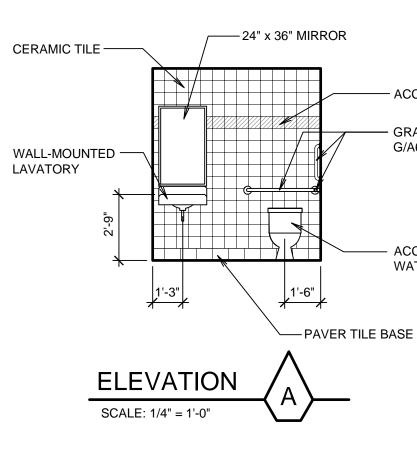


ELEVATION

SCALE: 1/4" = 1'-0"


- ACCENT TILE (TYP).-

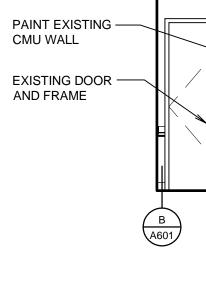

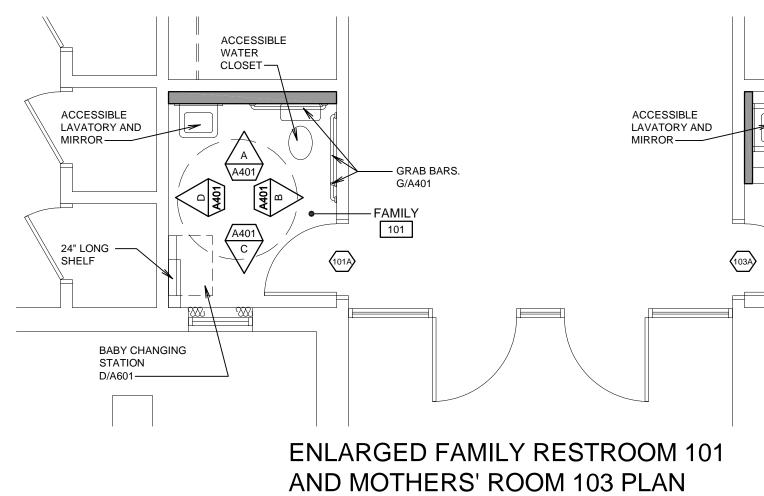

SCALE: 1/4" = 1'-0"

XTX

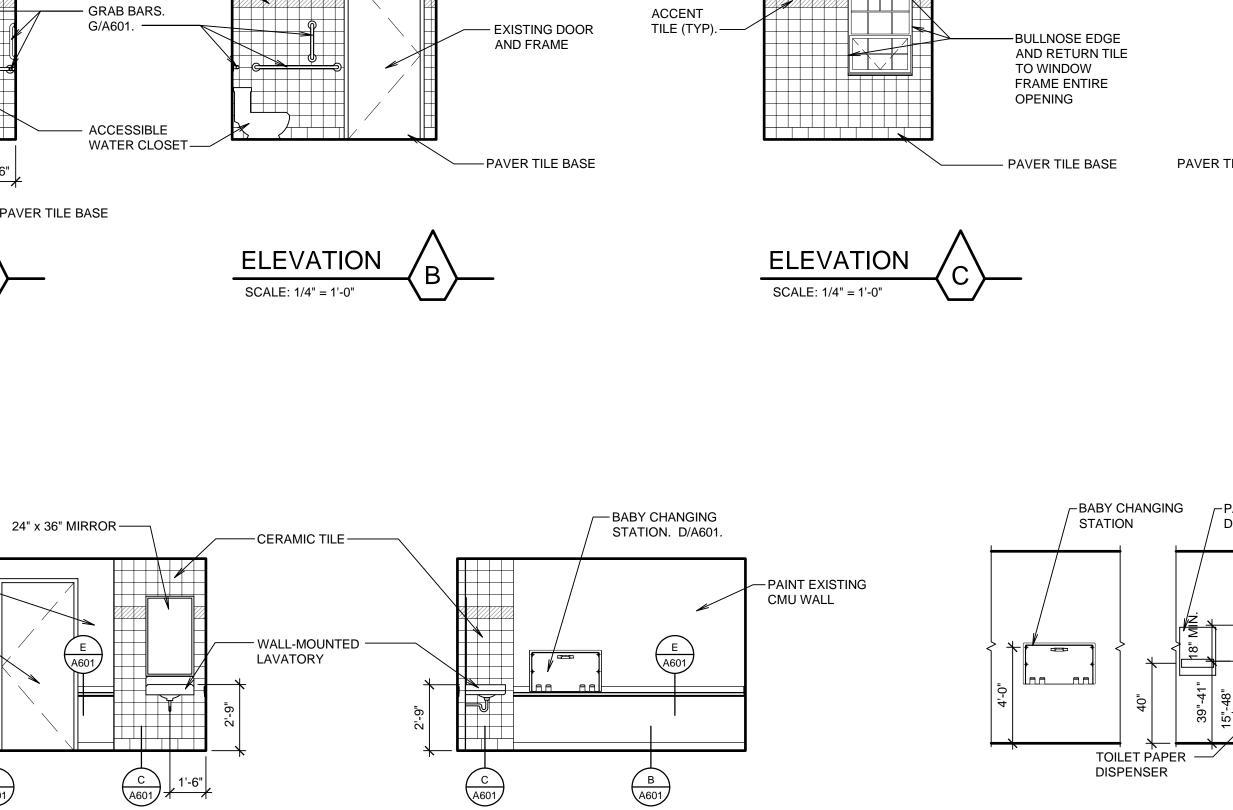

ELEVATION


SCALE: 1/4" = 1'-0"


CERAMIC TILE -

- CERAMIC TILE


TYPICAL ACCESSORY MOUNTING LOCATIONS SCALE: 1/4" = 1'-0"


— EXISTING WINDOW AND STOOL TO REMAIN.

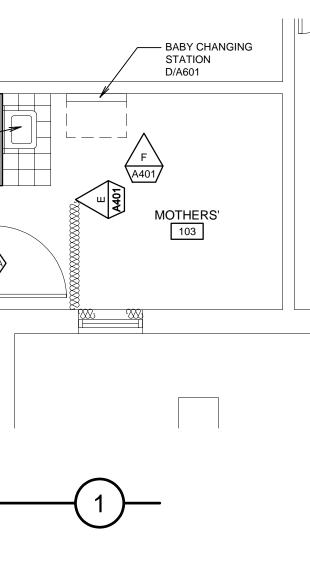

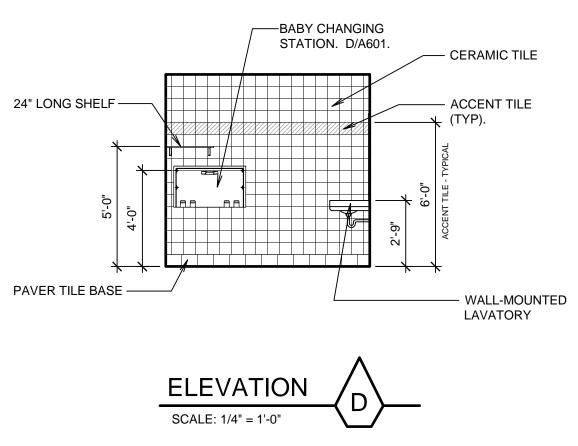




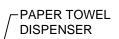


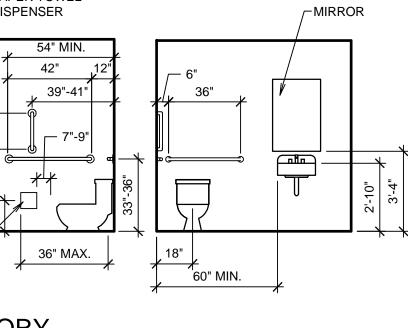



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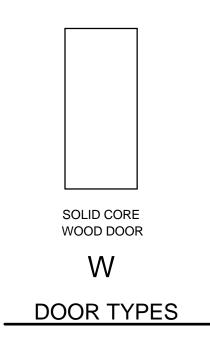


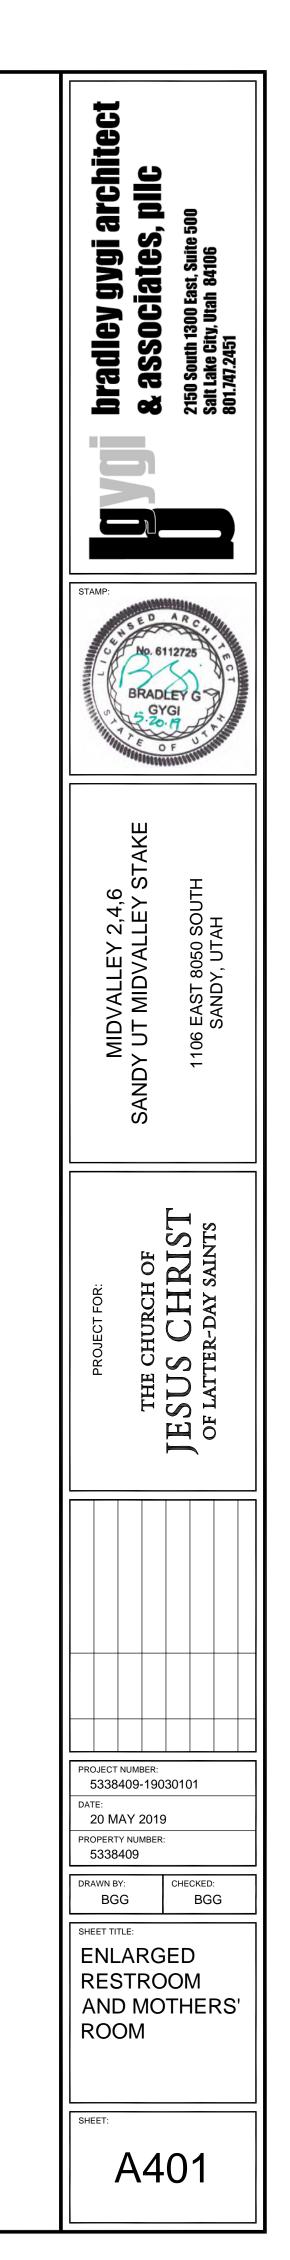


CHAIR RAIL

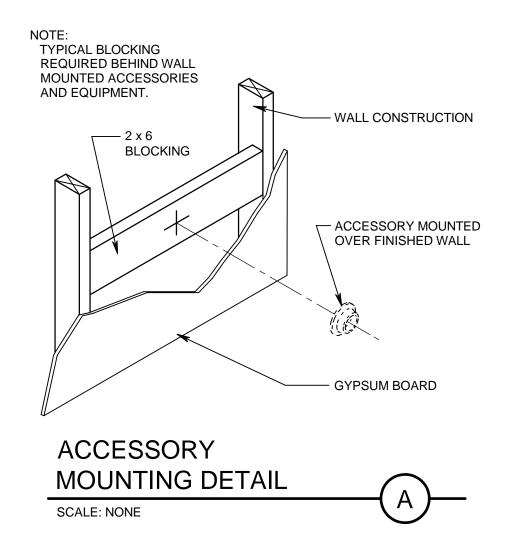
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SCALE: FULL

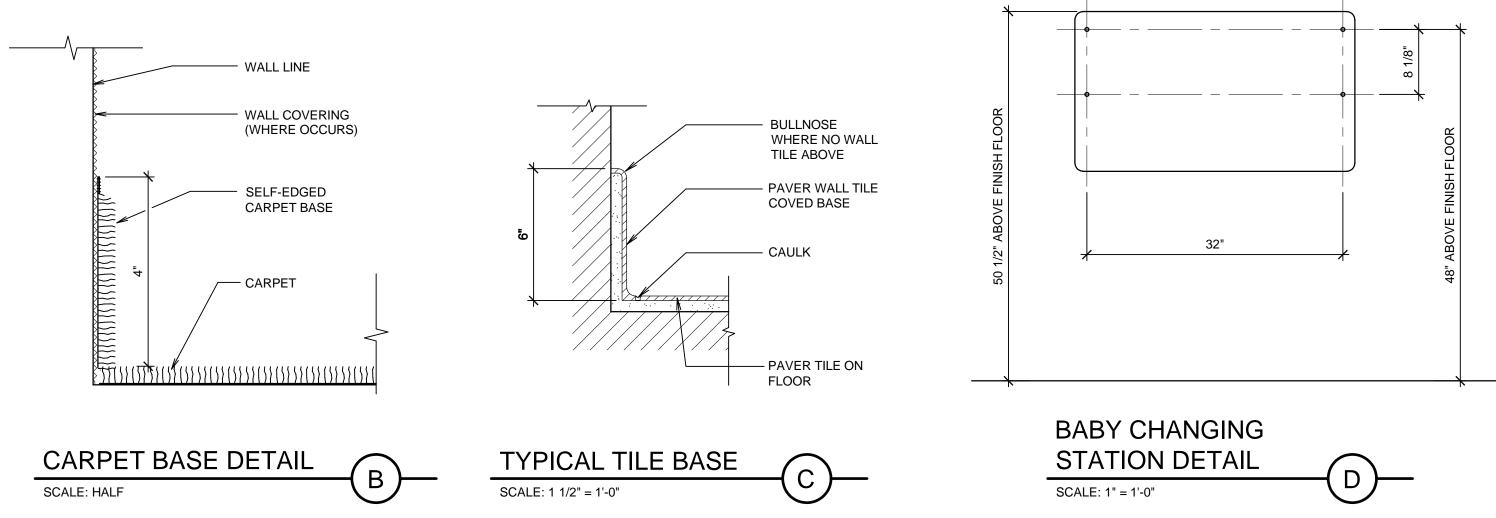

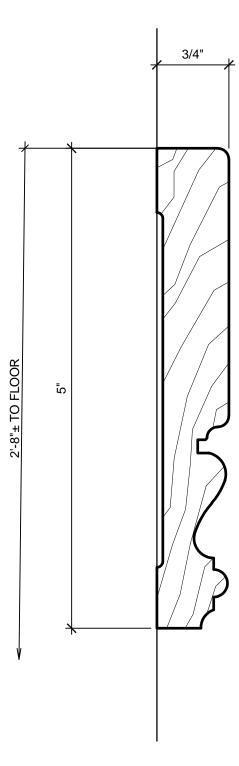

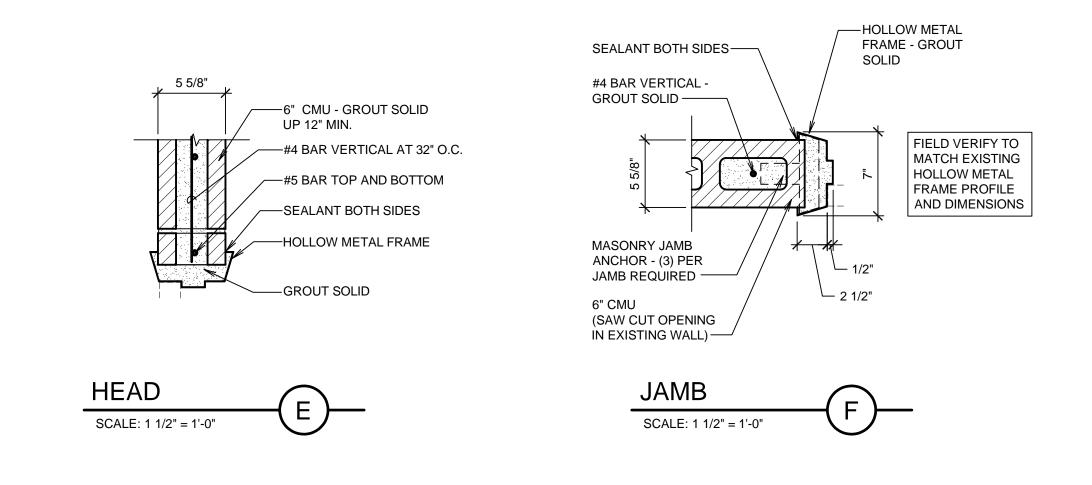
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	ROOM		ROOM	NAME			FLOOR	BASE	WALLS	CEILING	CEILING HEIGHT			TRIM OR	hiter	0	
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			s' Room								_		S1,S	3,S4,S5,S6		ites	t, Suite 14106
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		W3	DOOR . EXISTIN	JAMBS G TO F	REMA						R					WINISHING WW	FU
		<u>C</u>				i CEILI	ING TILE. EXI	ISTING G	YPSUM BOA	RD						AKE	
RESTROUM UND DEWOLTROD EXABLES S NEW CELLING-MOUNTED DRAPERY NEW WINDOW DRAPERY VAN ROOS S NEW CELLING-MOUNTED DRAPERY DOOR CELLING-MOUNTED DRAPERY DOOR DETALS DOOR DET		C2	OR LAM TEXTUR EXISTIN	IINATE RE ANI G TO F	E NEV D PAI REMA	N 5/8" INT. AIN. P	GYPSUM BO	ARD. DA	UB-KNOCK-	DOWN	3					, 1, ∐ 2, ≻	SOUTH
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			NEW CH	IAIR R/	AIL T	Ο ΜΑΤ	CH EXISTIN			M NEW							1106
DOOR DETAILS View USANDER View View View <td></td> <td></td> <td>NEW WI</td> <td>NDOW</td> <td>/ DRA</td> <td>PERY</td> <td>AND RODS</td> <td>Ι.</td> <td></td> <td></td> <td></td> <td></td> <td></td> <td></td> <td></td> <td>SAN</td> <td></td>			NEW WI	NDOW	/ DRA	PERY	AND RODS	Ι.								SAN	
DOOR DETAILS Y Image: Signed and Signed												PROJECT FOR:	CHURCH	S CH			
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S SIZE FR FIRE RATING GENERAL NOTES S1 3'-0" x 7'-0" x 1 34" [MATCH EXISTING HEIGHT] FR20 20 MINUTE 1. NEW HARDWARE WITH EXISTING DOOR, FRAME and DHARDWARE PREPARE AND PAINT EXISTING FRAME. 5338409-19030101 T THRESHOLD T 2' STONE THRESHOLD (BY TILE INSTALLER) 0 0 T1 2' STONE THRESHOLD (BY TILE INSTALLER) 0 0 0	101A	101									T1				1		
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S SIZE FR FIRE RATING GENERAL NOTES S1 3'-0" x 7'-0" x 1 34" (MATCH EXISTING HEIGHT) FR20 20 MINUTE T THRESHOLD 1. New HARDWARE PREPARE AND PAINT EXISTING FRAME. 5338409-19030101 T THRESHOLD (BY TILE INSTALLER) 0. OHECKED: 5338409 BGG BGG BGG SHEET TITLE: FINISH & DOOR SCHEDULES AND DETAILS																	
Imatch existing height] Image: Doministic Image: Note of the constraints of the cons	_		7'-0" x 1 3/4"			-			ING						5338		30101
T1 2' STONE THRESHOLD (BY TILE INSTALLER) DRAWN BY: BGG SHEET TITLE: FINISH & DOOR SCHEDULES AND DETAILS	_	[MATO	CH EXISTING	6 HEIGHT	Ŋ	F	172U 20 M	VIIINU I E		1.	FRAME AN	D HAR	RDWAR	E. PREPARE AND	20 N PROPER	TY NUMBER:	
SHEET TITLE: FINISH & DOOR SCHEDULES AND DETAILS SHEET:		1 2" ST	ONE THRES	HOLD (B`	Y										DRAWN	BY:	
SCHEDULES AND DETAILS			,														BGG
SHEET:															SCI	HEDU	LES
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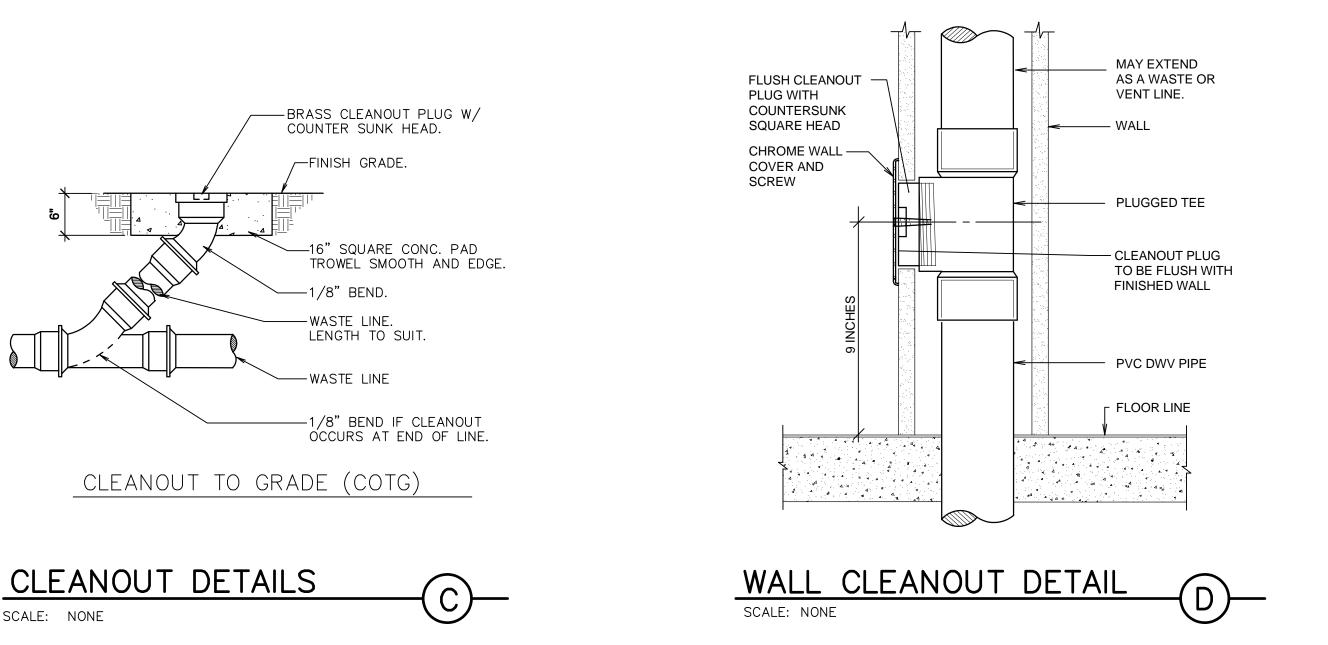


KEY PLAN

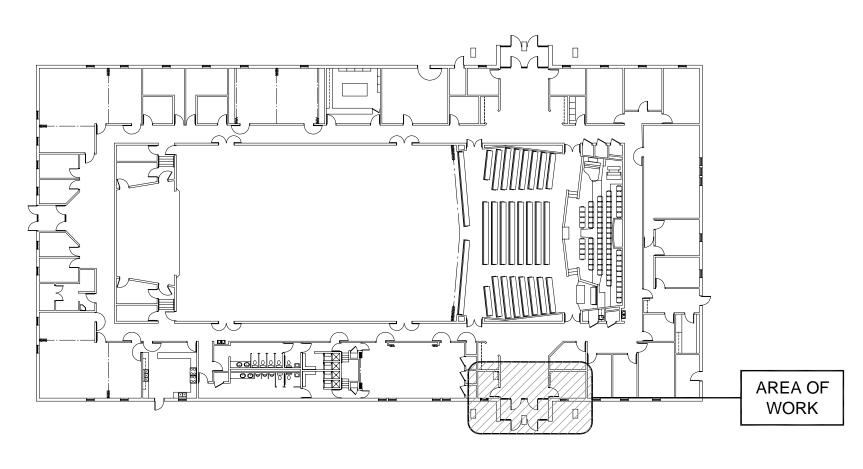
	PLUMBING FIXTURE SCHEDULE							
MARK FIXTURE		PIPE SIZE					REMARKS	
		TRAP	WASTE	VENT	C.W.	H.W.	REWARKS	
WC-1	WATER CLOSET	INT.	4"	2"	1/2"	-	FLUSH TANK, 18" RIM HEIGHT (ADA APPROVED)	
(L-1)	LAVATORY	1-1/4"	1-1/4"	1-1/2"	1/2"	1/2"	SELF SUPPORTING 20"X18"	
(FD-1)	FLOOR DRAIN	2"	2"	2"	-	-	W/DEEP SEAL P-TRAP & TRAP SEAL. SEE A/P101.	
WH-1	WATER HEATER	-	-	-	1/2"	1/2"	ELECTRIC, 3.2-3.5 KW, 25-29 AMPS, 120 V, 1 PHASE TANKLESS	

(1) WHEN MOUNTED PER ARCHITECTURAL ELEVATIONS, ADA ACCESSIBILITY REQUIREMENTS ARE SATISFIED.




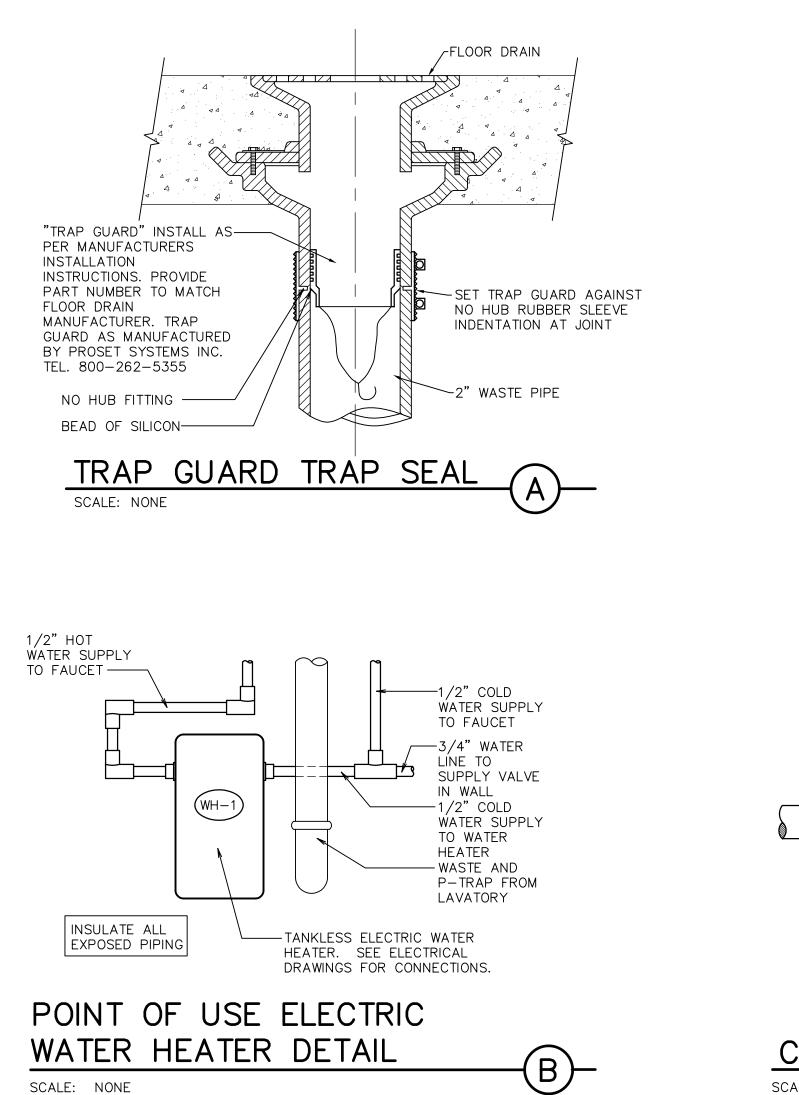


SCALE: NONE

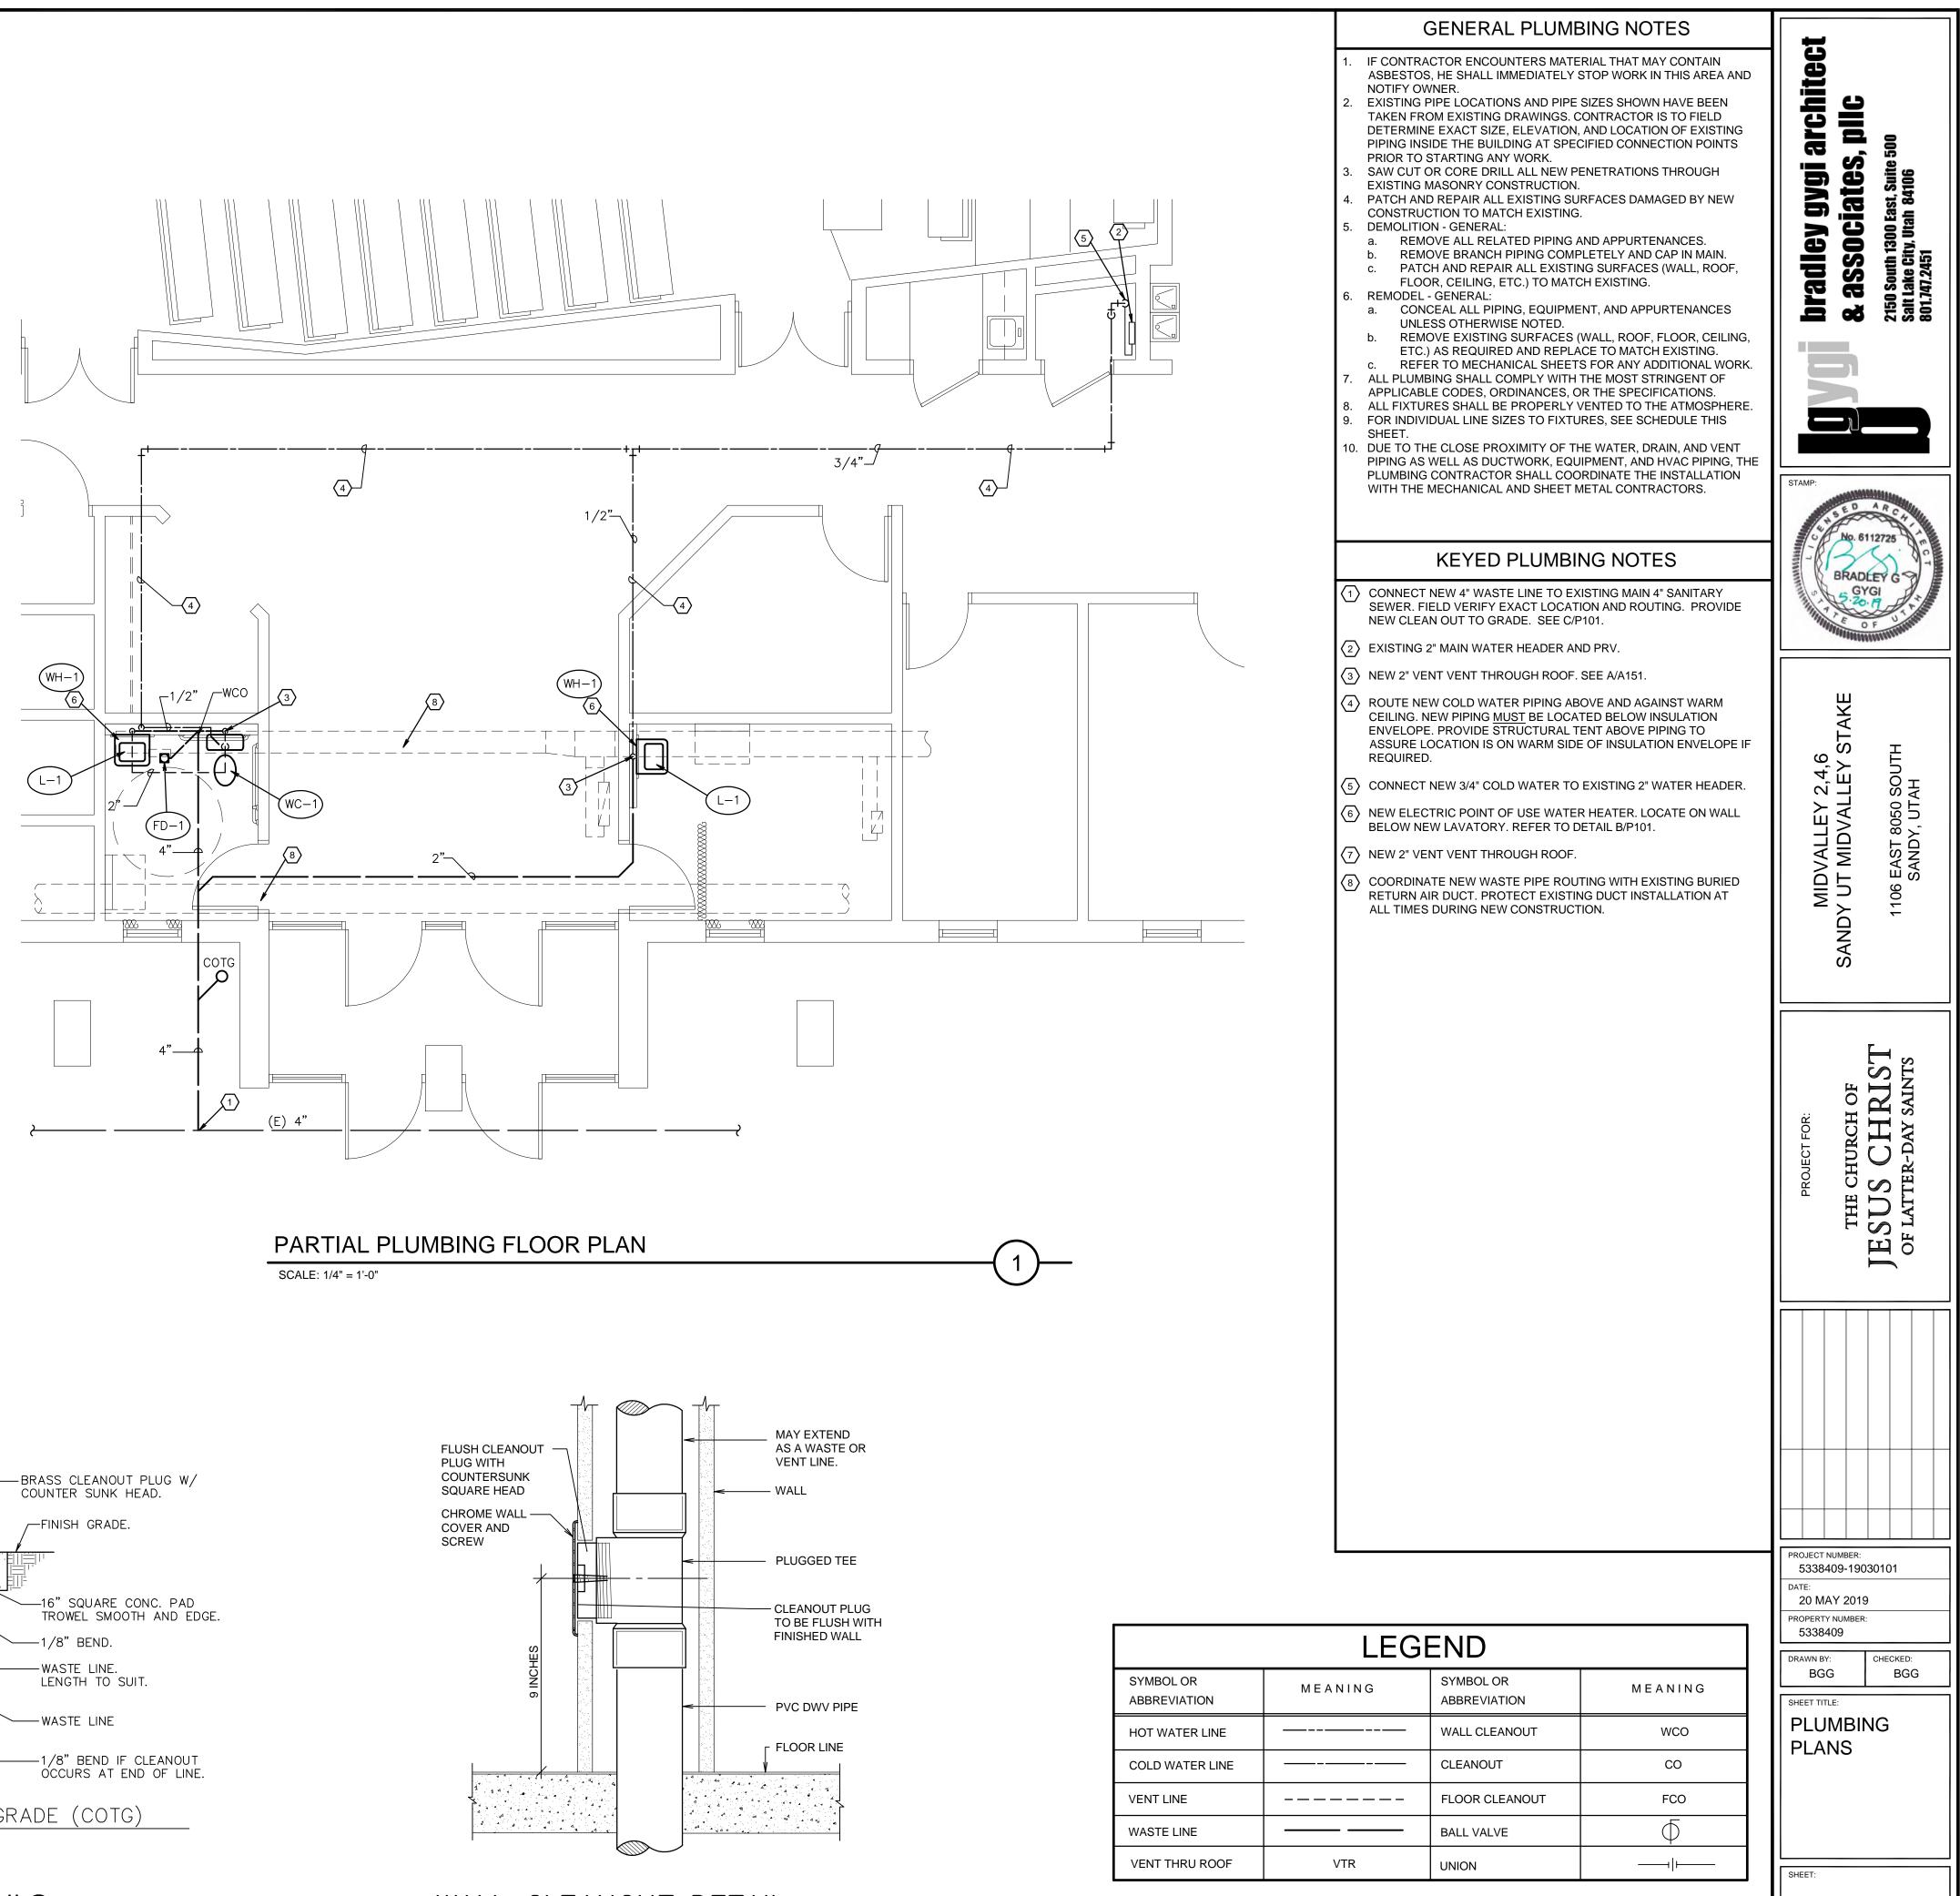



P101

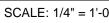

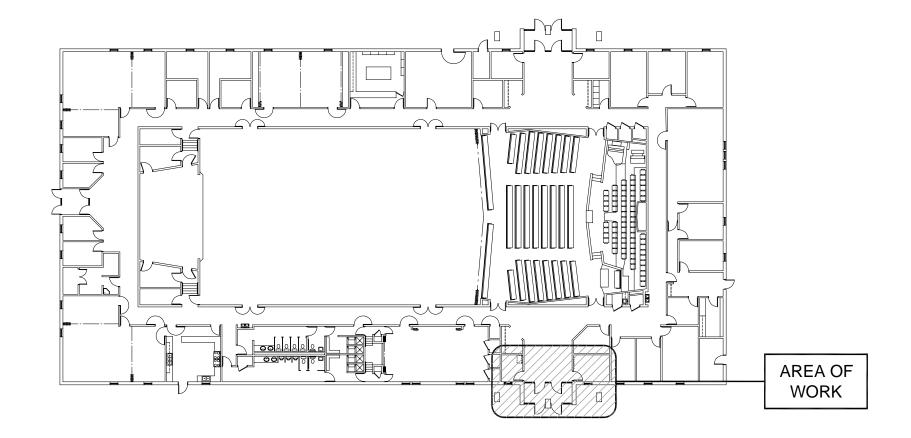

KEY PLAN

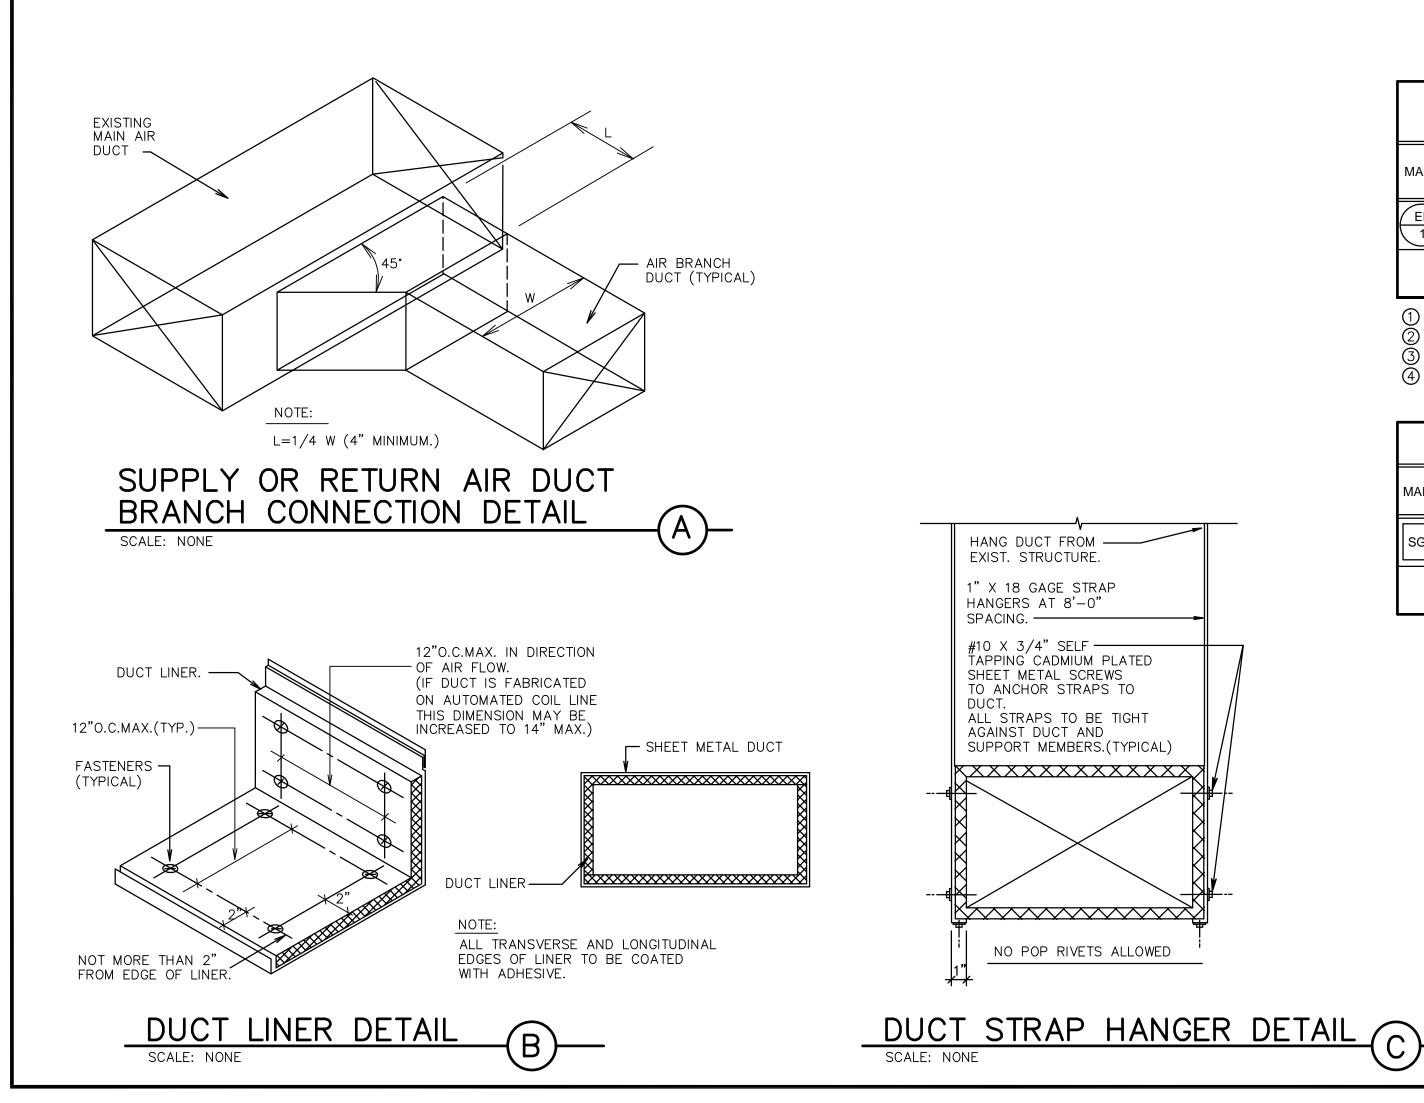

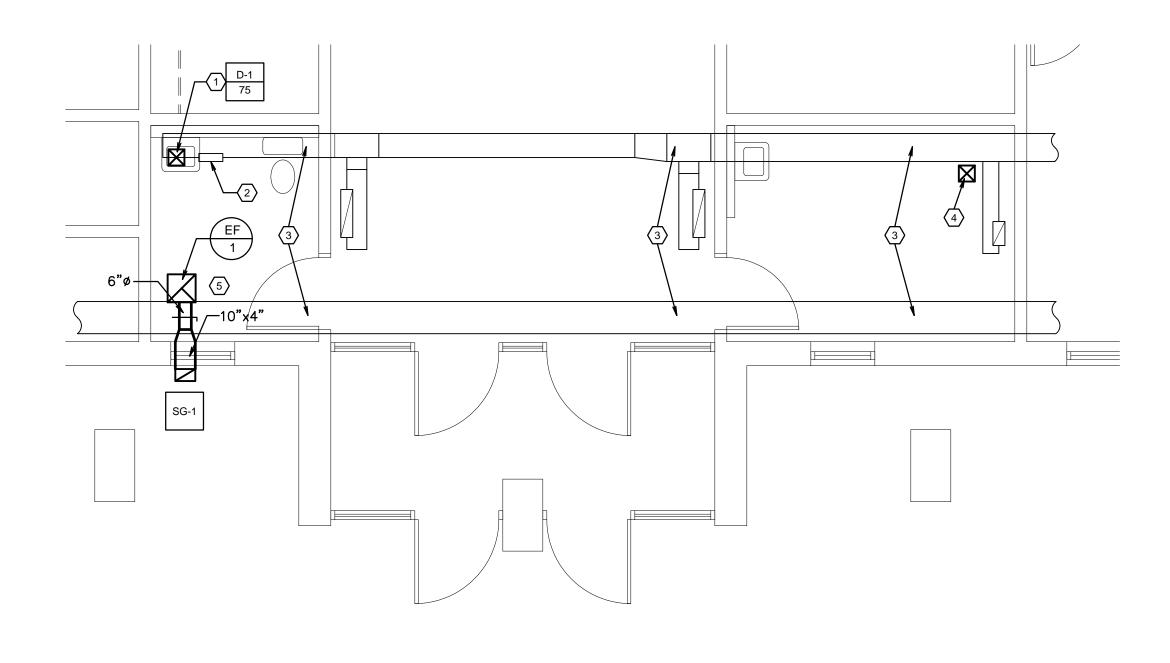

PARTIAL MECHANICAL FLOOR PLAN



	EXHAUST FAN SCHEDULE							
MARK	SERVES ROOM	MIN. ① S.C.F.M.	STATIC PRESSURE IN. W.G.	MINIMUM WATTS	REMARKS			
EF 1	RESTROOM 101	95	0.25	81W	234			

() SET BALANCE DAMPERS TO CFM LISTED

(2) CONTROL BY DIVISION 26. 3 VOLTAGE IS 115V / 1 PHASE / 60 HZ


(4) PROVIDE BACKDRAFT DAMPER AND BALANCING DAMPER.

REGISTER, LOUVER & GRILLE SCHEDULE							
MARK	ТҮРЕ	SERVICE	CFM (1) RANGE	NOMINAL SIZE	REMARKS 3		
SG-1	SOFFIT GRILLE 5	EXHAUST AIR	95	10X6			


DIFFUSER SCHEDULE 24							
MARK	C.F.M. RANGE	DIFFUSER	NECK	BLOW	PATTERN	AIR DIST./SIDE	
W/ UUV	O.I. IM. TO INCE	SIZE	CONN.	BLOW		A (%)	B (%)
D-1	95	6X6	6X6	3 WAY	& A ∢b B	38	31

REGISTER, LOUVER AND DIFFUSER SCHEDULE NOTES:


- \bigcirc MAXIMUM NC=25 @ MAXIMUM CFM NOTED.
- 2 SHALL BE TITUS TDC TYPE 6 OR EQUAL BY OTHER APPROVED MANUFACTURERS. (SEE SPECIFICATIONS)
- 3 SEE SPECIFICATIONS FOR APPROVED MANUFACTURERS.
- FINISH SHALL BE OFF-WHITE BAKED ENAMEL. 4
- FINISH COLOR TO MATCH SOFFIT AS DIRECTED BY ARCH. 5

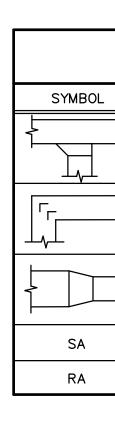


	GENERAL MECHANICAL NOTES	
	 EXISTING DUCTWORK, SIZES, AND EQUIPMENT SHOWN FOR CONTRACTOR'S REFERENCE. FIELD DETERMINE EXACT SIZE, ELEVATION, AND LOCATION OF EXISTING ITEMS, INCLUDING THEIR RELATIONSHIP WITH INTENDED WORK PRIOR TO STARTING ANY WORK. DRAWINGS SHOW GENERAL ARRANGEMENT OF PIPING, DUCTWORK, EQUIPMENT, ETC. FOLLOW AS CLOSELY AS ACTUAL BUILDING CONSTRUCTION AND WORK OF OTHER TRADES WILL PERMIT. BECAUSE OF THE SMALL SCALE OF THE DRAWINGS, IT IS NOT POSSIBLE TO INDICATE ALL OFFSETS, FITTINGS, AND ACCESSORIES THAT MAY BE REQUIRED. INVESTIGATE STRUCTURAL AND FINISH CONDITIONS AFFECTING THIS WORK AND ARRANGE WORK ACCORDINGLY. PROVIDE SUCH FITTINGS, VALVES, AND ACCESSORIES REQUIRED TO MEET CONDITIONS. PATCH AND REPAIR ALL EXISTING SURFACES DAMAGED BY NEW CONSTRUCTION TO MATCH EXISTING. BALANCE SYSTEMS BEING REVISED COMPLETELY TO CFM'S SHOWN. MAKE ADJUSTMENTS NECESSARY TO ACHIEVE AIR FLOW QUANTITIE SHOWN ON DRAWINGS. DUCT DIMENSIONS ARE CLEAR DIMENSIONS INSIDE DUCT LINER. DO NOT ROUTE PIPES ABOVE ELECTRICAL PANELS. MAINTAIN CLEAF ACCESS SPACE IN FRONT OF ALL ELECTRICAL PANELS 4'-0" DEEP AN 6'-6" HIGH. SAW CUT OR CORE DRILL ALL NEW PENETRATIONS THROUGH EXISTING MASONRY CONSTRUCTION. IF CONTRACTOR ENCOUNTERS MATERIAL THAT MAY CONTAIN ASBESTOS, HE SHALL IMMEDIATELY STOP WORK IN THIS AREA AND NOTIFY THE OWNER. DEMOLITION - GENERAL: REMOVAL OF EQUIPMENT, PIPING, OR DUCTWORK TO INCLUDE REMOVAL OF ALL RELATED APPURTENANCES SUCH AS WIRING 	BACIER OF CALLEY OF CALLE
	 CONDUIT, SUPPORTS, ETC. AND MODIFICATIONS REQUIRED FO A COMPLETE OPERATING SYSTEM. b. REMOVE BRANCH CONDUIT AND WIRE COMPLETELY. TERMINATE AT JUNCTION BOX. c. PATCH AND REPAIR ALL EXISTING SURFACES (WALL, ROOF, FLOOR, CEILING, ETC.) TO MATCH EXISTING. 10. REMODEL - GENERAL: a. ALL NEW CONDUIT, PIPING, DUCT, EQUIPMENT, AND APPURTENANCES TO BE CONCEALED UNLESS OTHERWISE NOTED. b. EXISTING SURFACES (WALL, ROOF, FLOOR, CEILING, ETC.) TO BE REMOVED AS REQUIRED AND REPLACED TO MATCH EXISTING. 	
	KEYED MECHANICAL NOTES 1 REMOVE EXISTING CEILING SUPPLY DIFFUSER. PROTECT EXISTING BRANCH DUCT DURING CONSTRUCTION. INSTALL NEW CEILING SUPPLY DIFFUSER AT EXISTING BRANCH DUCT LOCATION. BALANCE SUPPLY AIR TO VOLUME SPECIFIED. 2 REMOVE EXISTING FLOOR RETURN GRILLE AND RELATED BURIED BRANCH RETURN AIR DUCT. CAP AT EXISTING MAIN DUCT.	MIDVALLEY 2,4,6 SANDY UT MIDVALLEY STAKE 1106 EAST 8050 SOUTH SANDY, UTAH
	 PROTECT ALL EXISTING BURIED RETURN AIR DUCT TO REMAIN DURING CONSTRUCTION. EXISTING SUPPLY AIR IN CEILING TO REMAIN (DUCTWORK NOT SHOWN FOR CLARITY). NEW EXHAUST FAN. NEW DUCTWORK PIPING THROUGH ATTIC TO SOFFIT VENT PER MANUFACTURER'S RECOMMENDATIONS. 	PROJECT FOR: THE CHURCH OF JESUS CHRUST OF LATTER-DAY SAINTS
		PROJECT NUMBER: 5338409-19030101
LEGE	ΝΟ	DATE: 20 MAY 2019 PROPERTY NUMBER:
DESCRIPTION	SYMBOL DESCRIPTION	DRAWN BY: CHECKED: BGG BGG
BRANCH DUCT TAKE-OFF. SEE DETAIL E/M3.1 SINGLE THICKNESS TURNING VANES	MANUAL VOLUME DAMPER MANUAL VOLUME DAMPER BACKDRAFT DAMPER (INSTALL AT EACH EXHAUST DISCHARGE DUCT)	SHEET TITLE: MECHANICAL PLANS
DUCT TRANSITION	EXISTING DUCT TO BE REMOVED	
SUPPLY AIR RETURN AIR	EXISTING DUCT TO REMAIN	SHEET: M101

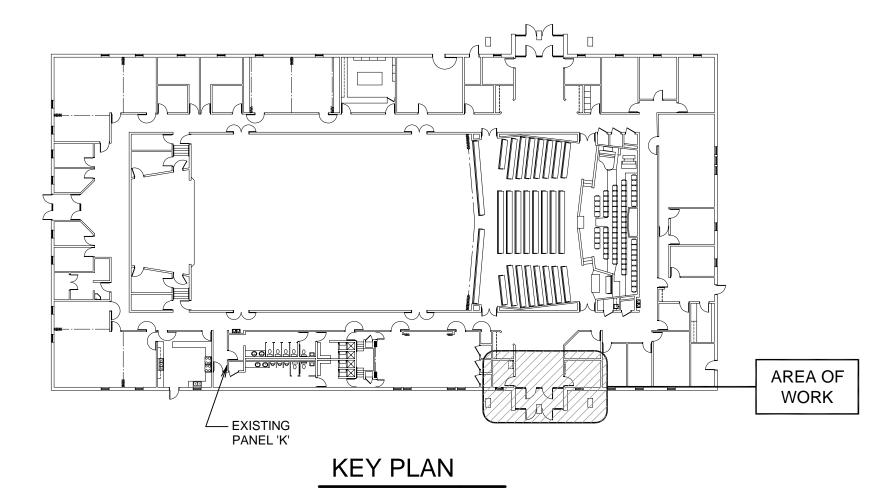

SYM	DESCRIPTION
EF-1	EXHAUST FAN

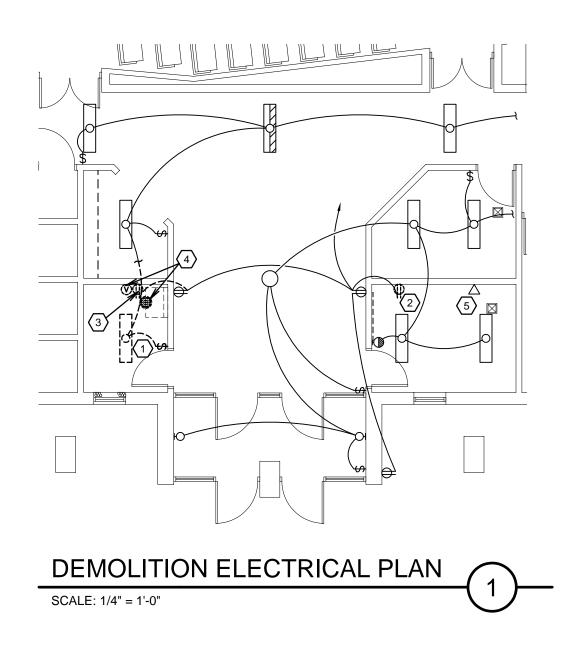

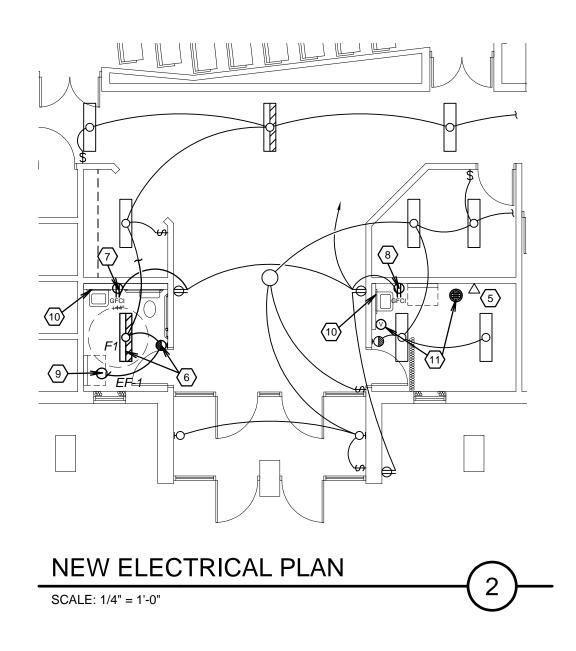

EXHAUST FAN SCHEDULE								
1	CIRCUIT	FEEDER	VOLTS / PHASE	DISCONNECT	HP/WATTS			
	EXIST.	2 #12, #12 GR	120 / 1 (VERIFY EXISTING)	INCLUDED	100W			

FIXTURE SCHEDULE								
SYM	MANUFACTURER		LOAD	LAMPS	MOUNTING			
	NAME	CATALOG NUMBER	(VA)	TYPE				
F1	DAY-BRITE	OWN232-UNV-1/2EB*	50	2-F32	SURFACE			
	METALUX	WN232A-UNV-EB81*		Т8				
	H.E. WILLIAMS	17-4-232-A-LDS-EBLH2*-AD-BD-UNV		3000K				
	LSI	WNA10-232-SSOL-UE						
	LITHONIA	SB232 MVOLT OS10IXSL*						
	COLUMBIA	AWN-232-ELW*U						

GENERAL ELECTRICAL NOTES	ct
 WHERE AFFECTED BY DEMOLITION OR NEW CONSTRUCTION, RELOCATE, EXTEND OR REPAIR RACEWAYS, CONDUCTORS, OUTLETS AND APPARATUS TO ALLOW CONTINUED USE OF ELECTRICAL SYSTEM. USE METHODS AND MATERIALS AS SPECIFIED FOR NEW CONSTRUCTION. 	architect , pllc 500
2. REROUTE ANY EXISTING CONDUIT OR ELECTRICAL FIXTURES OR DEVICES WHICH ARE ENCOUNTERED DURING THE DEMOLITION OR WHICH ARE CONFLICTING WITH NEW CONSTRUCTION FOR THIS PROJECT. REROUTE THE CONDUIT AND MAINTAIN THE SERVICE OR MOVE FIXTURES AND APPLIANCES AS REQUIRED TO ACCOMMODATE THE WORK OF OTHER TRADES DURING THIS CONSTRUCTION. MOVE OR REMOVE FIXTURES AND DEVICES TO ACCOMMODATE OTHER TRADES DURING THIS CONSTRUCTION AND REINSTALL THE SAME AT THE CONCLUSION OF THE	dley gygj SSOCjateS uth 1300 East, Suite e City, Utah 84106 2451
PROJECT. 3. CIRCUIT NEW LIGHT FIXTURES, DEVICES, MOTORS AND FIXTURES TO EXISTING PANEL. PROVIDE NEW BREAKERS, CONDUIT AND WIRE AS REQUIRED FOR INSTALLATION.	bra 8, 35 2150 So Salt Lak 801.747.
 PROVIDE RACEWAYS AND BOXES CALLED OUT IN MECHANICAL DRAWINGS. SEE MECHANICAL DRAWINGS AND COORDINATE WITH MECHANICAL CONTRACTOR. 	
 NO SURFACE-MOUNTED CONDUIT WILL BE ALLOWED ON PROJECT. PATCH AND REPAIR WALLS AND CEILINGS THAT ARE DAMAGED BY ELECTRICAL DEMOLITION AND INSTALLATION. SAW-CUT THROUGH WALLS AS REQUIRED TO CONCEAL ALL CONDUIT. FIELD VERIFY EXISTING CONDITIONS. 	STAMP:
6. AT REMODELED ROOMS, REPLACE ALL EXISTING OUTLETS, SWITCHES, COVER PLATES AND OTHER DEVICES WHICH ARE NOT REMOVED FOR THIS WORK WITH NEW. ALL NEW DEVICES AND COVER PLATES TO BE WHITE COLOR.	No. 6112725
7. MAINTAIN POWER AND SWITCHES FOR EXISTING LIGHTING AND OUTLETS AT ALL ADJACENT AREAS.	BRADLEY G GYGI 5-40-F U THURSON
ELECTRICAL KEYED NOTES ① REMOVE EXISTING LIGHT FIXTURE, SWITCH AND RELATED WORK. ② REMOVE EXISTING POWER OUTLET. MAINTAIN LOCATION FOR NEW OUTLET DEVICE. ③ REMOVE EXISTING POWER OUTLET AND ABANDON LOCATION. ④ REMOVE EXISTING POWER OUTLET AND ABANDON LOCATION. ④ REMOVE AND SALVAGE EXISTING SPEAKER IN CEILING, VOLUME CONTROL DEVICE AND RELATED WIRING. ⑤ EXISTING PHONE / DATA OUTLET.	MIDVALLEY 2,4,6 V UT MIDVALLEY STAKE 106 EAST 8050 SOUTH SANDY, UTAH
 (5) EXISTING PHONE / DATA OUTLET. (6) NEW LIGHT FIXTURE. WIRE WITH NEW WALL SENSOR IN LOCATION OF EXISTING SWITCH AND CIRCUIT TO EXISTING LIGHT FIXTURE CIRCUIT. (7) NEW GROUND FAULT OUTLET. CIRCUIT TO EXISTING POWER OUTLET CIRCUIT. 	MIE SANDY U ⁻ 1106
8 NEW GROUND FAULT OUTLET IN LOCATION OF EXISTING REMOVED OUTLET.	
 NEW EXHAUST FAN. SWITCH WITH LIGHT FIXTURE SENSOR. CONNECT TO NEW 20A CIRCUIT BREAKER FOR EXHAUST FAN IN ELECTRICAL PANEL 'K' NEAR RESTROOMS (SEE KEY PLAN). ELECTRIC TANKLESS WATER HEATER ON WALL UNDER RESTROOM LAWATODY - 2.2.2 SIN 95 22 AMES 422 Y 4 DUASE NEW 224 	R: H OF IRUST ' SAINTS
 LAVATORY. 3.2-3.5W, 25-29 AMPS, 120 V, 1 PHASE. NEW 30A CIRCUIT BREAKER FOR WATER HEATER IN NEAREST PANEL 'K' NEAR RESTROOMS (SEE KEY PLAN). (1) REINSTALL EXISTING SALVAGED SPEAKER IN NEW LOCATION IN CEILING. CONNECT TO EXISTING SALVAGED VOLUME CONTROL IN NEW LOCATION. CONNECT TO EXISTING AV WIRING OR RUN NEW AS REQUIRED TO PROVIDE CHAPEL OVERFLOW SOUND IN MOTHERS' ROOM. 	PROJECT FOR: THE CHURCH OI JESUS CHR OF LATTER-DAY SAL
	PROJECT NUMBER: 5338409-19030101
ELECTRICAL SYMBOLS LEGEND	DATE: 20 MAY 2019 PROPERTY NUMBER: 5338409
 FLUORESCENT LIGHT FIXTURE	DRAWN BY: CHECKED: BGG BGG
FLUORESCENT LIGHT FIXTURE WITH EMERGENCY BATTERY PACK EXHAUST FAN (MOTOR OUTLET) Subscript OCCUPANCY SENSOR CEILING MOUNT, ULTRASONIC Subscript OCCUPANCY SENSOR WALL SWITCH, PASSIVE INFRARED \$ SINGLE POLE SWITCH	SHEET TITLE: ELECTRICAL PLANS
SINGLE POLE SWITCH DUPLEX RECEPTACLE OUTLET GFCI DUPLEX RECEPTACLE OUTLET	
GFCI	E101

)	REMARKS
	*ELECTRONIC BALLAST SEE SPEC. 265100

*EMERGENCY BATTERY PACK WHERE SHOWN HATCHED ON PLAN