
# MAPLETON 3, 5, 13, 21, SC

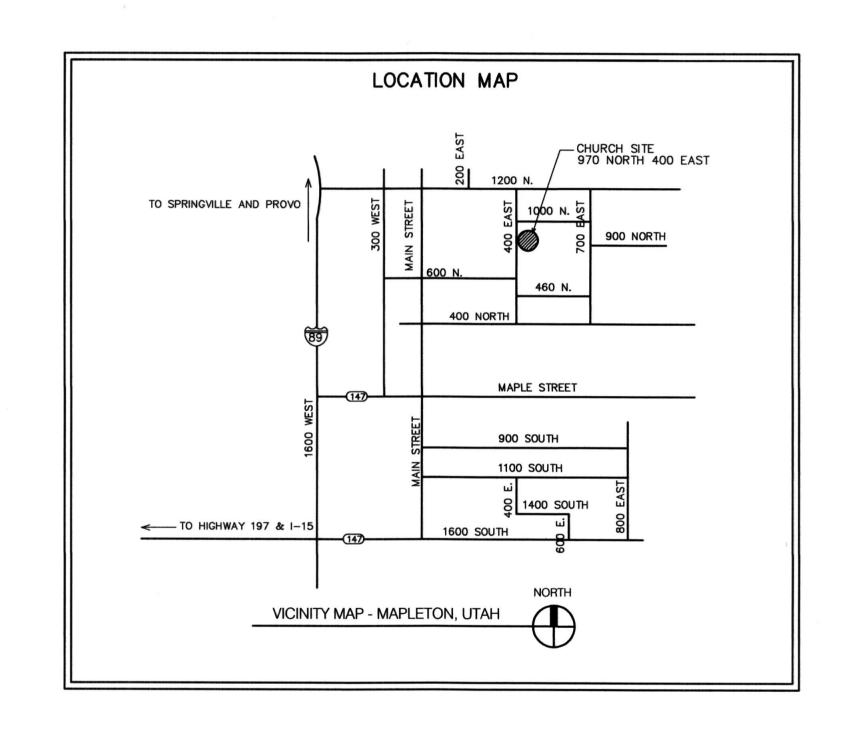

# STANDARD SYMBOLS LEGEND

DETAIL SECTION SHEET REFERENCE ROOM NUMBER ELEVATION LETTER ELEVATION ELEVATION 100'-0" ELEVATION (DATUM)

D	RAWING INDEX						
SHEET NUMBER	SHEET TITLE						
	GENERAL						
	COVER SHEET						
G1.0	INDEX SHEET						
	ARCHITECTURAL						
A1.1	FLOOR PLAN						
A1.2	ENLARGED DEMOLITION AND FLOOR PLAN AND WALL TYPES						
A1.3	DOOR AND FINISH SCHEDULES						
A2.1	INTERIOR ELEVATIONS RESTROOMS						
F1.1	FURNISHING PLAN, ROOM SIGNAGE AND DETAILS						
	ELECTRICAL						
E1.1	ENLARGED ELECTRICAL PLAN						
	MECHANICAL						
M101	MECHANICAL FLOOR PLAN						
M501	MECHANICAL DETAILS AND SCHEDULES						
P101	PLUMBING DEMOLITION AND FLOOR PLANS						
P501	PLUMBING SCHEDULES AND DETAILS						

# ARCHITECT & CONSULTANTS

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PROVO, UTAH 84606


MECHANICAL ENGINEER

VAN BOERUM & FRANK ASSOC. INC.

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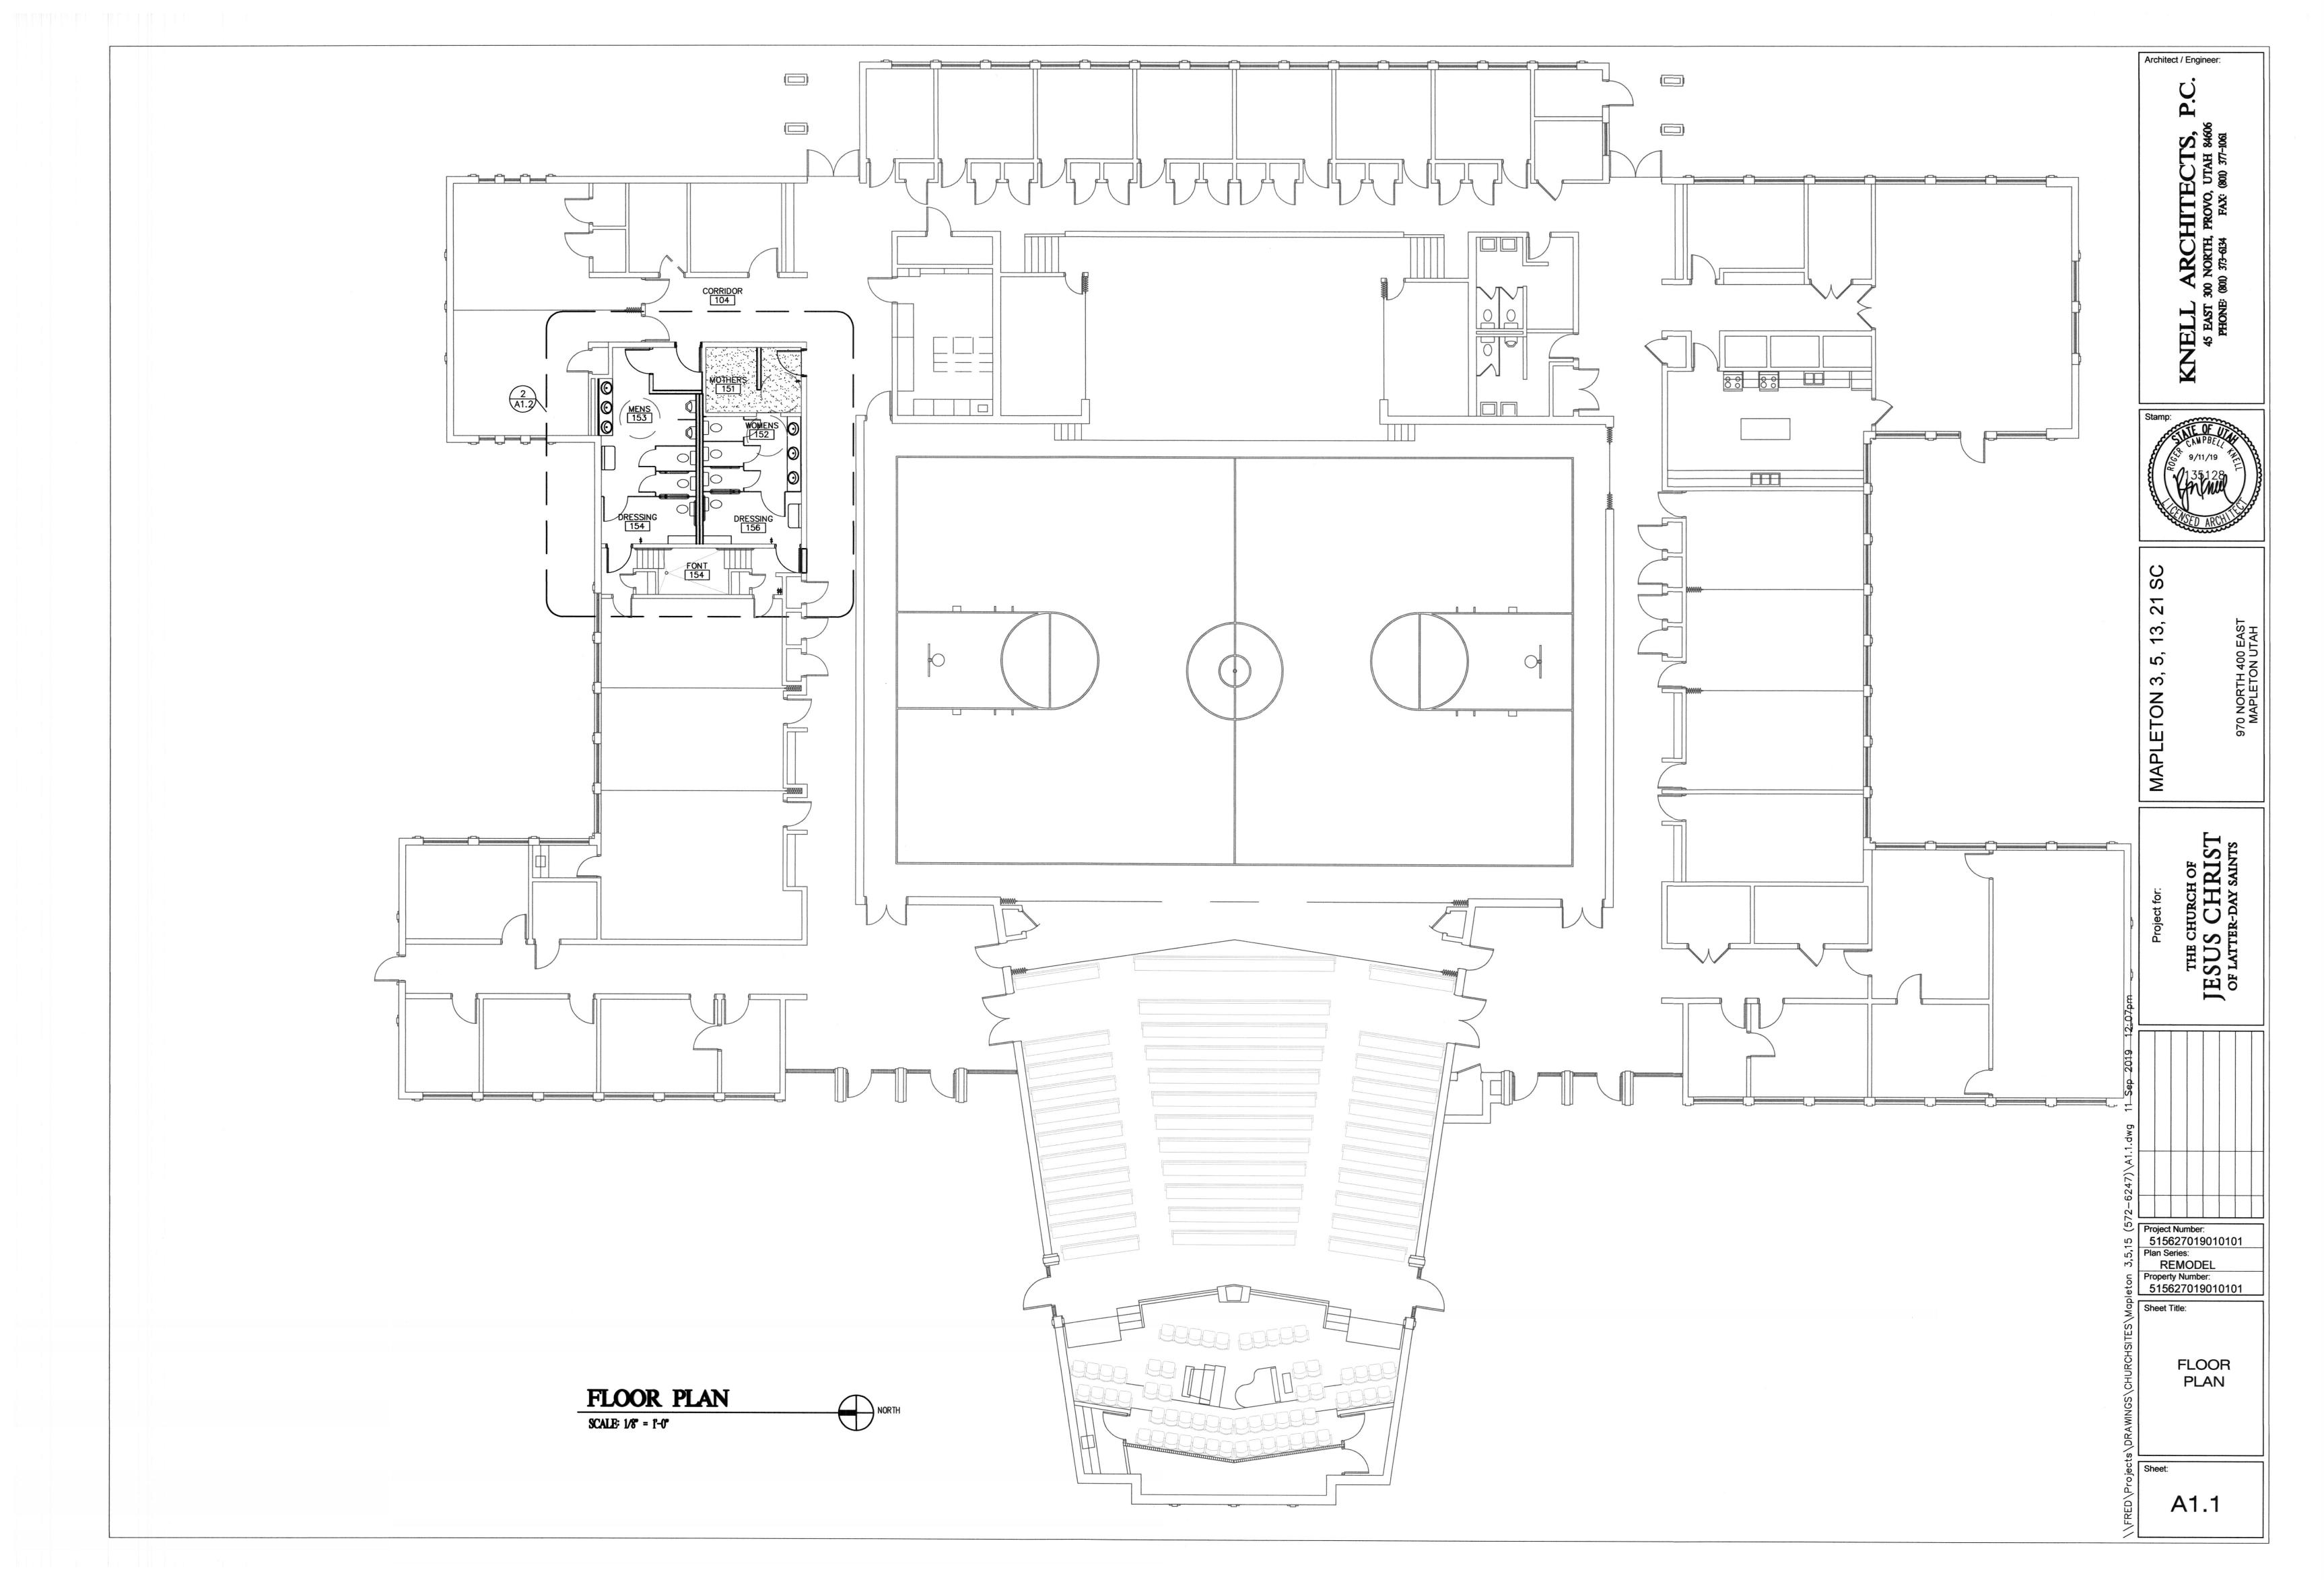
JESUS CHRIST OF LATTER-DAY SAINTS


REMODEL
Property Number:

515627019010101

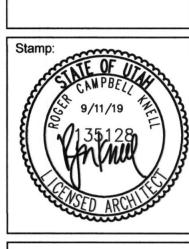**INDEX SHEET** 

G1.0



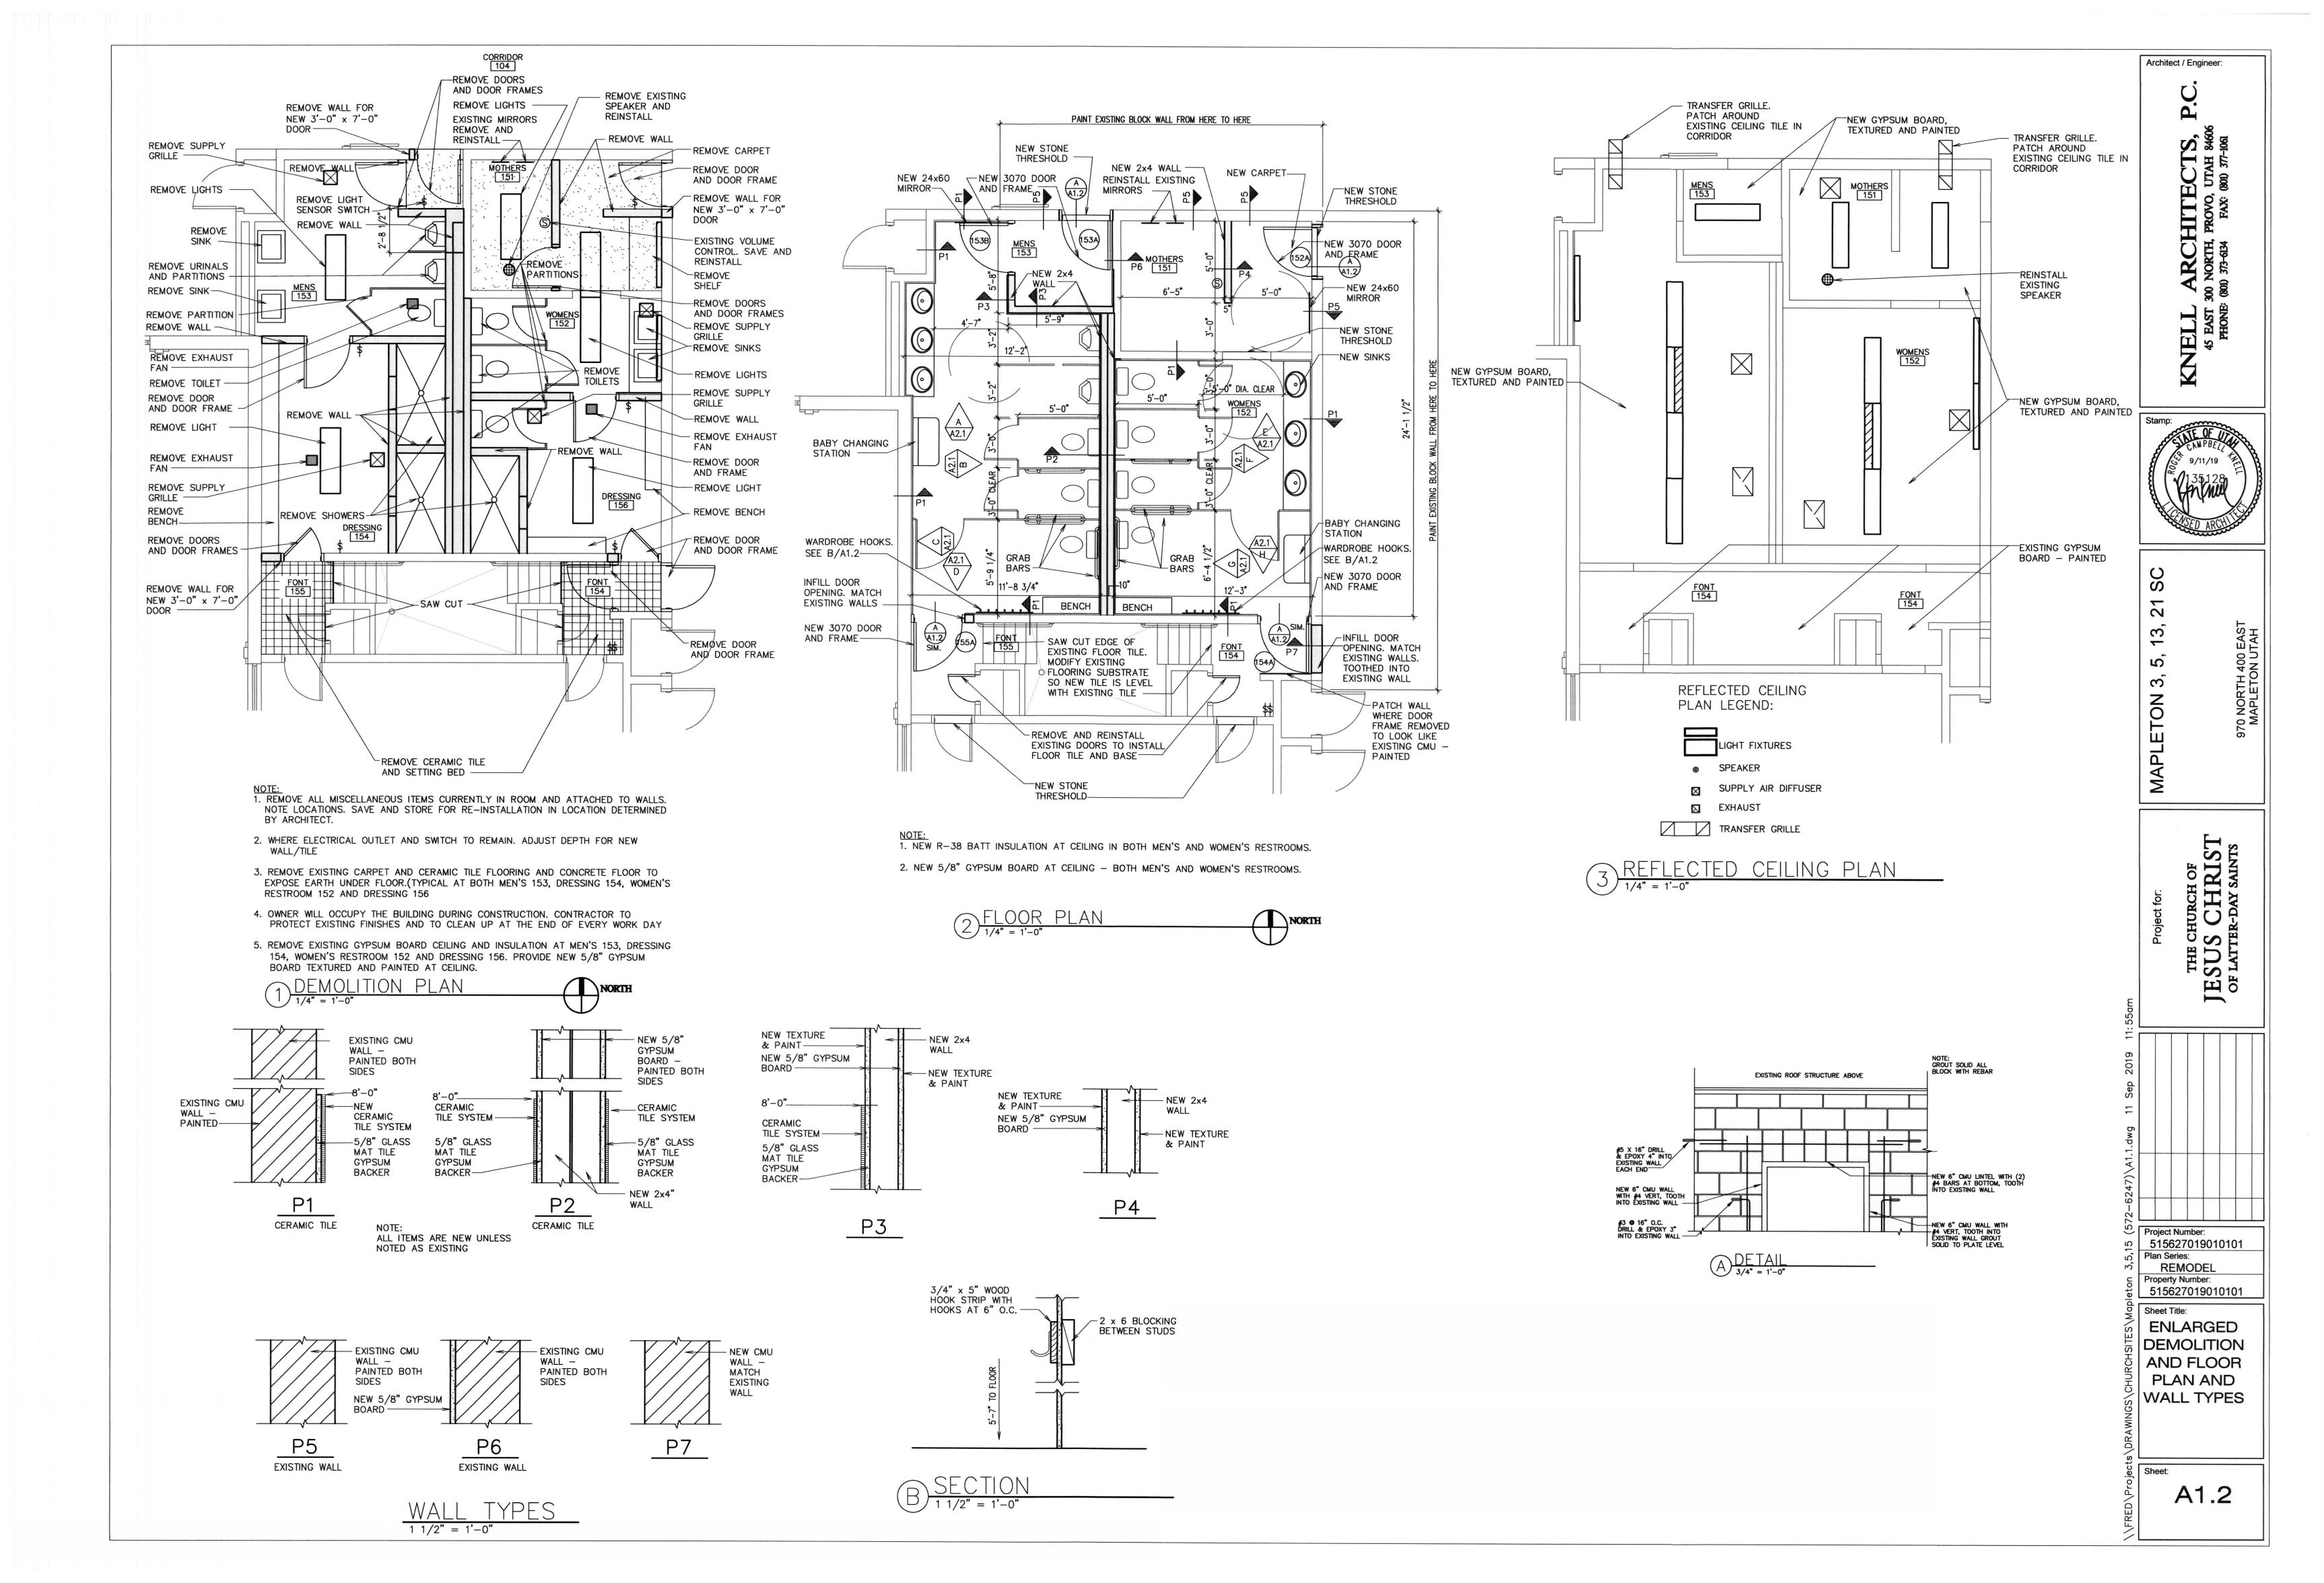

FINISH SCHEDULE										
ROOM NO.	ROOM NAME	FLOOR	BASE	WALLS	CEILING	CEILING HT	SPECIAL TRIM OR EQUIPMENT			
MAIN	FLOOR									
151	MOTHERS	F2	B2	W2/W3	C1	CH1				
152	WOMENS	F1/F2	B1/B2	W1/2/3	C1	CH1	S1 S2 S3 S4			
153	MENS	F1/F2	B1/B2	W1/2/3	C1	CH1	S1 S2 S3 S4			
154	FONT (MEN'S)	F1	B1	W1, W2	C1	CH1				
155	FONT (WOMEN'S)	F1	B1	W1, W2	C1	CH1				

#### DESCRIPTION

F_	FLOOR	
F1	CERAMIC TILE	
F2	CARPET	
W	WALLS	

W1 CERAMIC TILE
W2 PAINTED CMU
W3 GYPSUM BOARD — PAINTED CEILING

C1 5/8" GYPSUM BOARD-PAINTED

NOTE:

1. ALL ITEMS ARE NEW UNLESS NOTED AS EXISTING

В	BASE
=	
B1	CERAMIC TILE
B2	CARPET
1000000	O7 II II 2 I
CH	CEILING HEIGHT

SPECIAL TRIM OR EQUIPMENT

S1 GRAB BARS S2 BABY CHANGING STATION

CH1 8'-11<u>+</u>"

S3 MIRRORS S4 SHELF (STAINLESS STEEL) S1 3'-0" x 7'-THRESHOLD T1 STONE THRESHOLD


	DOOR SCHEDULE													
DOOR FRAME								<u> </u>						
								ш	DE	TAILS		GROUP		
								TYP			NG	-2 (80)	Q	
X	$\nabla$	1.1		,LE	10	SS	FILE	ΛE			RATING	HARDWARE	THRESHOLD	REMARKS
MARK	ROOM	TYPE	PAIR	SING	SIZE	GLASS	PROFI	FRAME	HEAD	JAMB		\RD\	RES	
				0,	<u> </u>						FIRE	ΗН	王	
MAIN	-	OOR										70		
152A		W		•	S1		_	1				32	T1	DS 1
153A		W		•	S1		_	1		_		32	T1	DS 1
153B		W		•	S1 S1	=	-	1				32 35	T1 T1	DS 1 DS 1
154A 155A		W	_	•	S1	+=	Ε	1				35	T1	DS 1
1334	134	- VV	_	-	31	<del>                                     </del>	-	-				- 55	'-	
							$\vdash$							

#### DESCRIPTION

C	SI7F	D.C.		GENERAL NOTES:
5	SIZE	DS	DOOR STOP	THE GENERAL INTENT
S1	3'-0" x 7'-0" x 1 3/4"	DS-1	WALL MOUNTED	OF DETAILS SHALL IN ALL

THE GENERAL INTENT
OF DETAILS SHALL IN ALL
CASES BE FOLLOWED AND THE
ARCHITECT CONSULTED SHOULD
QUESTIONS ARISE. CUT EXISTING DOOR TO BE 1" ABOVE THRESHOLD


Architect / Engineer:

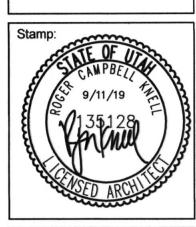


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515627019010101
Plan Series:
REMODEL
Property Number:
515627019010101


Sheet Title: DOOR AND FINISH
SCHEDULES


A1.3

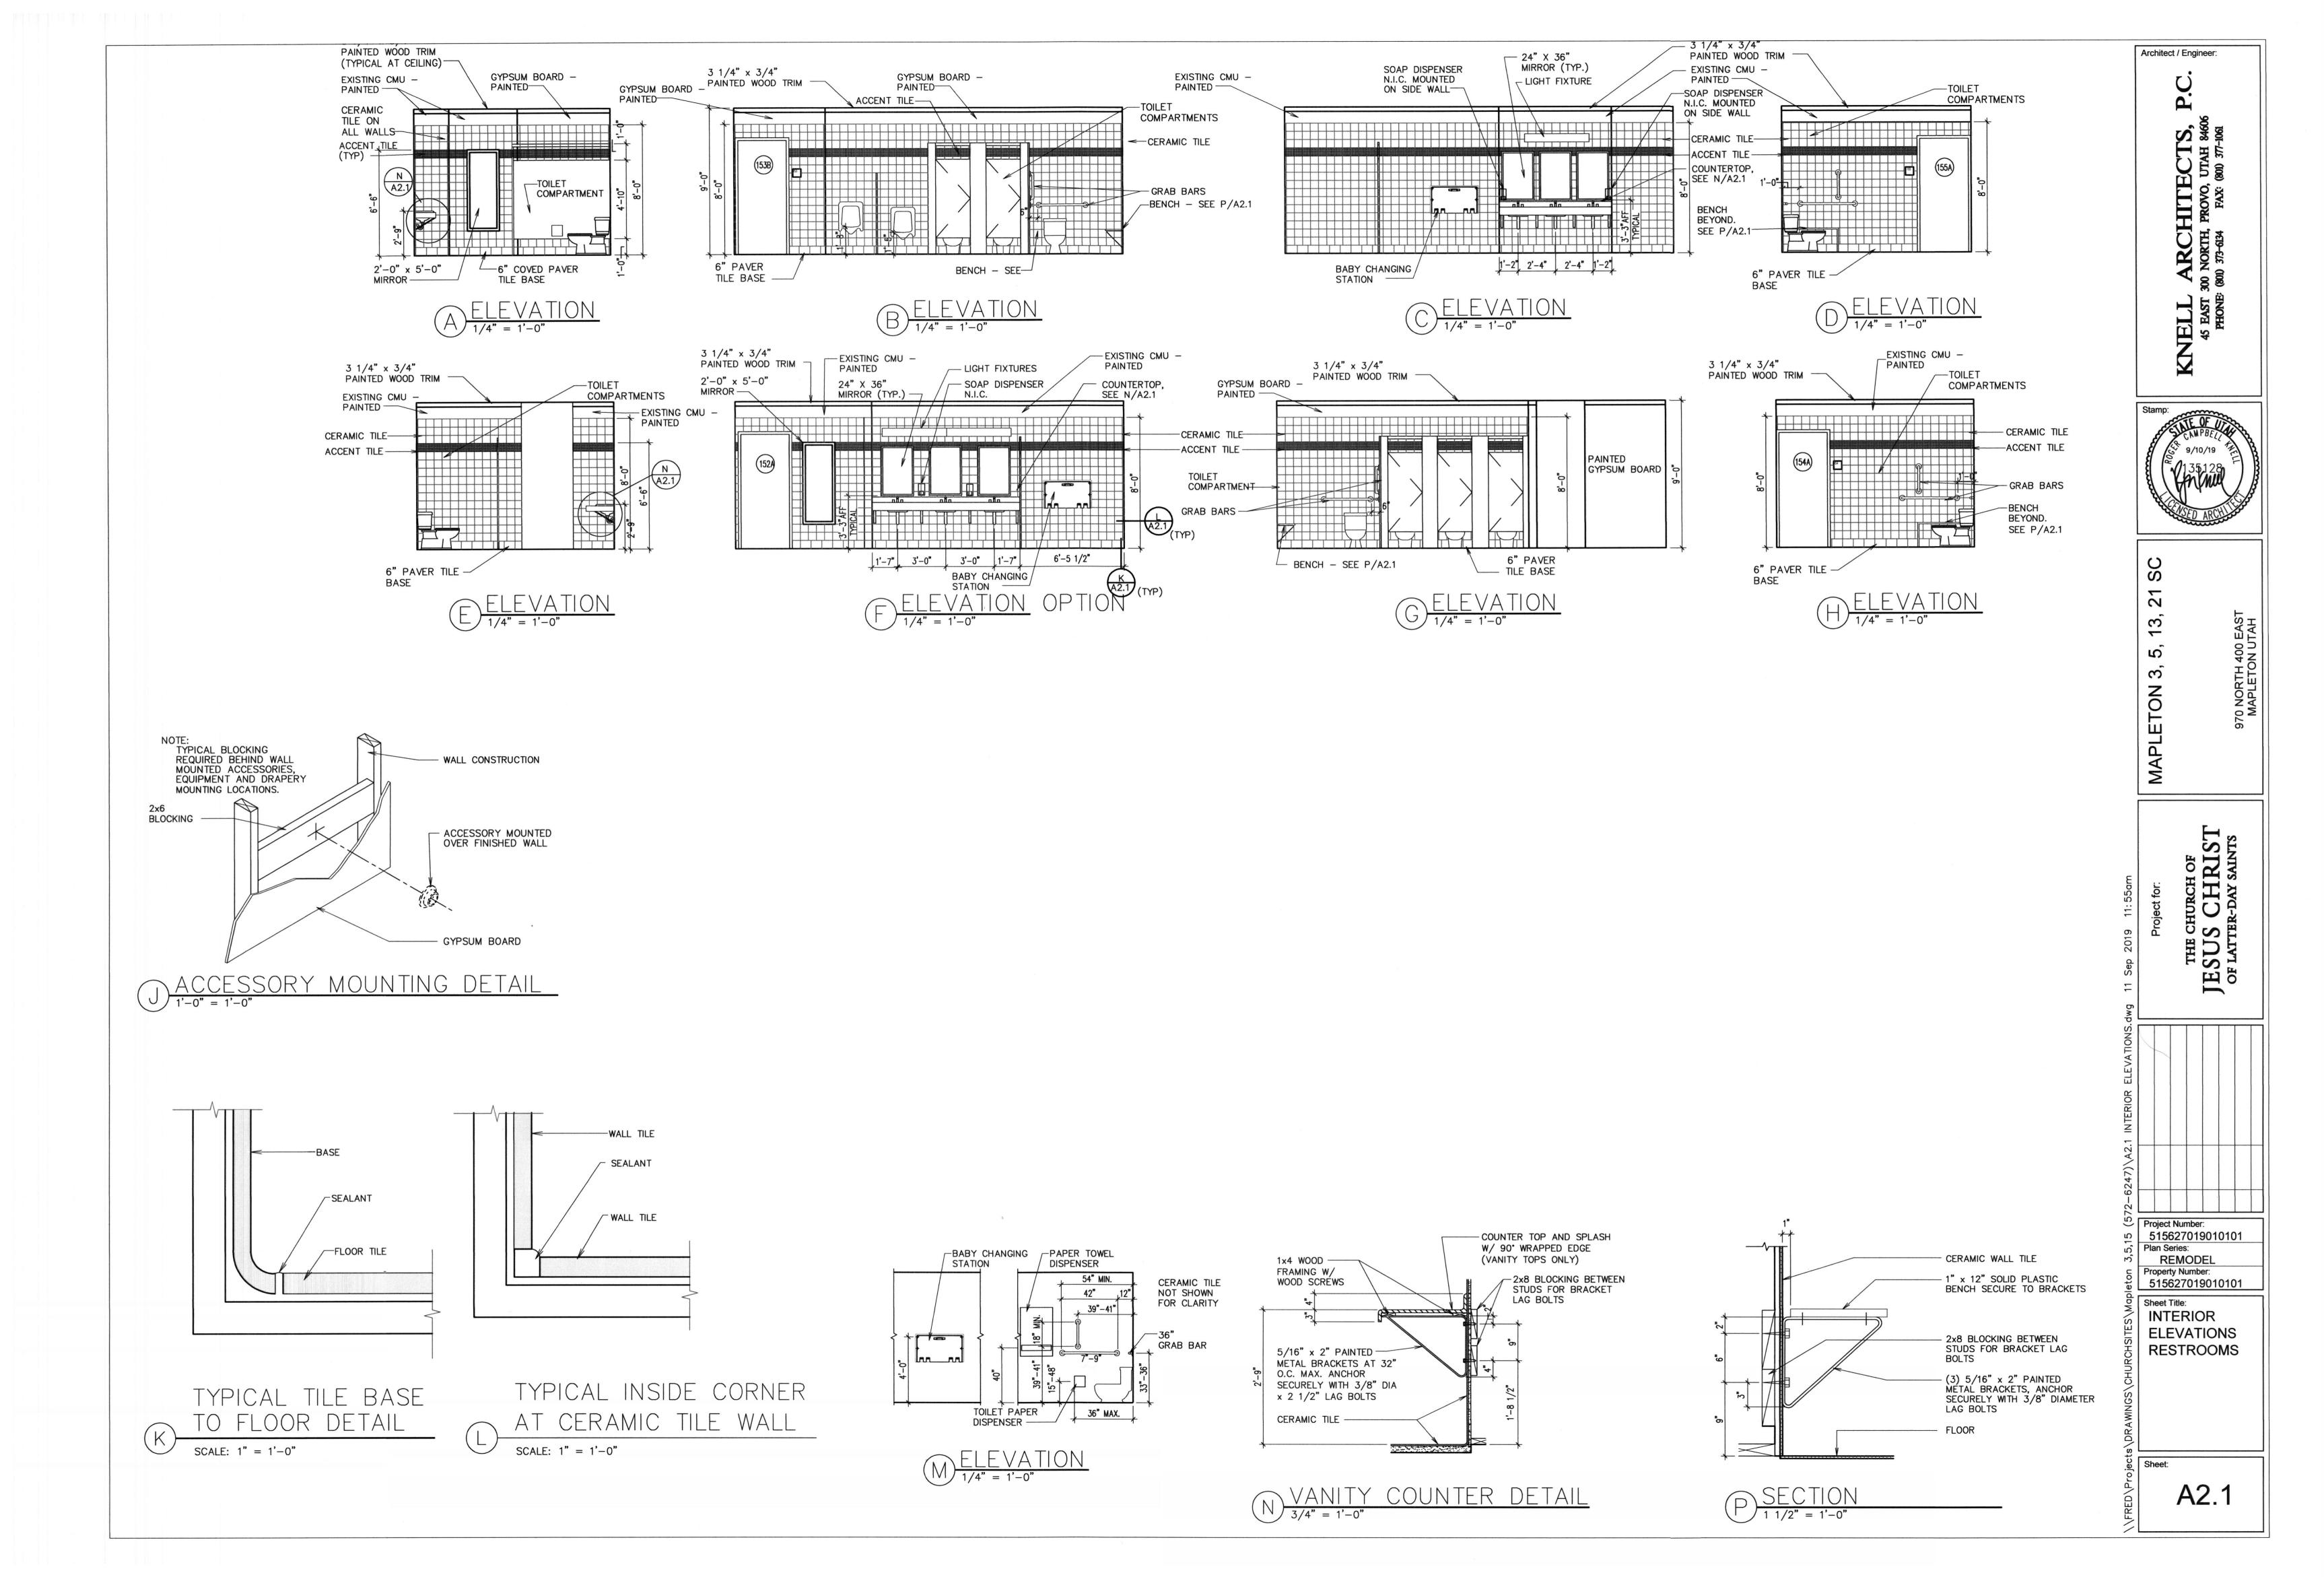

BUILDING SIGNAGE SCHEDULE									
SIGNAGE ROOM NAME OR NUMBER	QUANTITY	SIZE	MOUNTING	PLAN ROOM NUMBER					
MEN 🖟 💍	1	6x6	A/A1.4	153					
MOTHER'S ROOM	1	6x6	A/A1.4	151					
WOMEN \$ &	1	6x6	A/A1.4	152					
BAPTISMAL FONT	2	6x6	A/A1.4	154, 155					
CAUTION: BAPTISMAL FONT ENTRY, PLEASE WATCH YOUR STEP	2	6x6	A/A1.4						
DO NOT LEAVE FONT UNATTENDED WHILE FILLING	1	3x3	MOUNT ON THE FACE OF THE DOOR OF THE FONT CONTROL BOX						

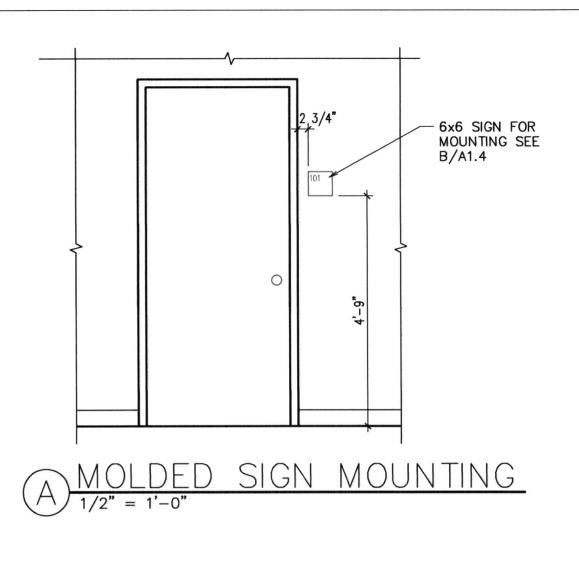

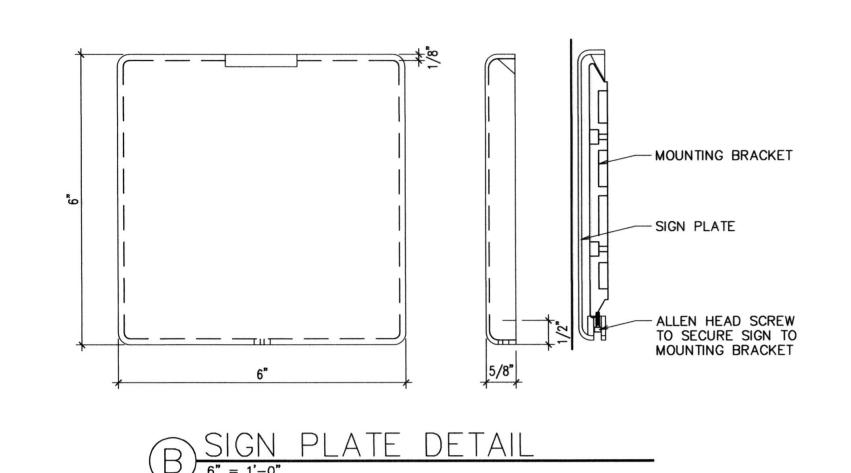

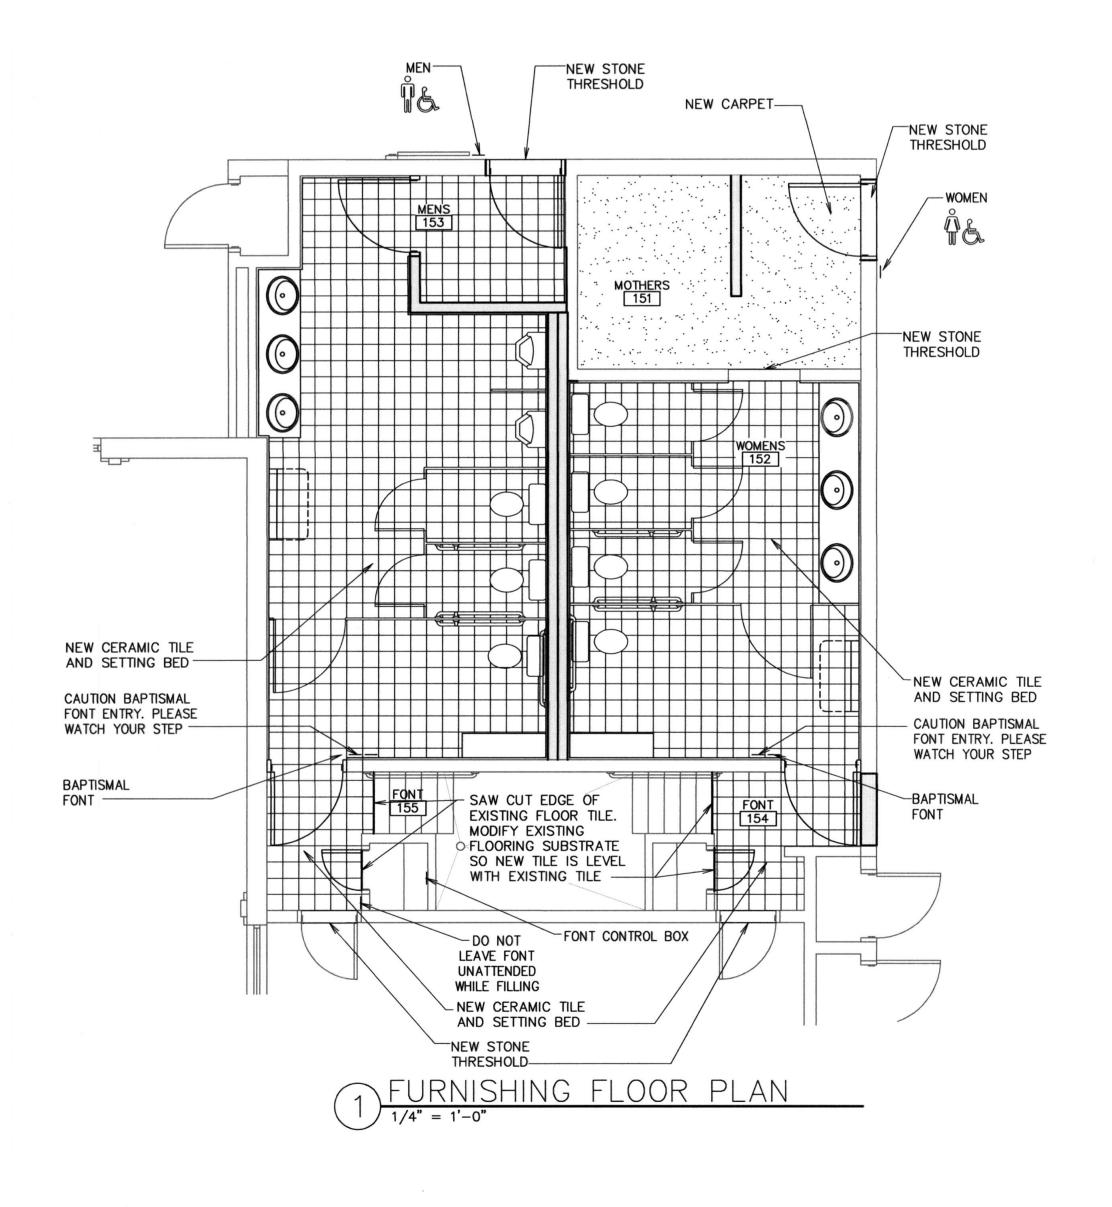

Architect / Engineer

Project Number:

515627019010101 Plan Series: REMODEL Property Number: 515627019010101


> Sheet Title: **FURNISHING** PLAN,

**ROOM** SIGNAGE AND DETAILS

Sheet:

F1.1

	ELECTRICAL SYMBOLS LEGEND
₩О	DUAL TECHNOLOGY CEILING MOUNTED OCCUPANCY SENSOR WITH OVERRIDE SWITCH
Ø PIR	DUAL TECHNOLOGY WALL MOUNTED OCCUPANCY SENSOR
	FIXTURE WITH EMERGENCY BATTERY PACK
	BRANCH CIRCUIT CONCEALED IN CEILING, WALL, OR FLOOR

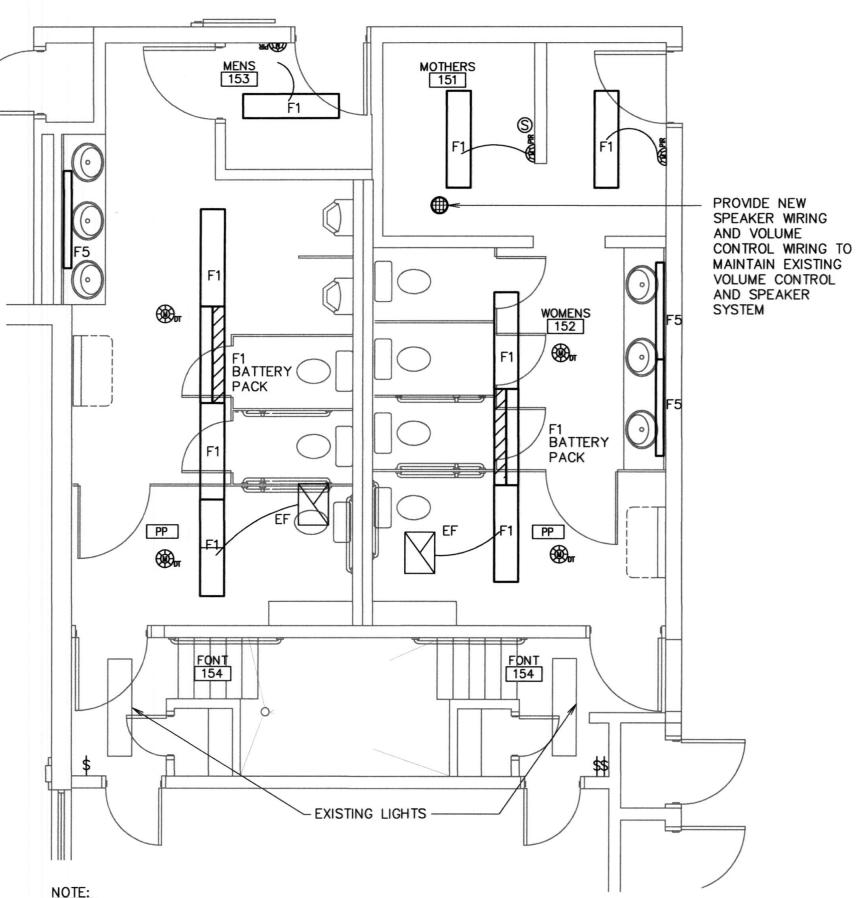

- 1. FURNISH AND INSTALL 90 MINUTE REMOTE EMERGENCY BATTERY PACK (1100 LUMENS) IN THE INDICATED FIXTURES. PROVIDE AN UN-SWITCHED CIRCUIT LEG FOR MONITORING AND BATTERY CHARGING, REFER TO SPECIFICATION FOR MORE REQUIREMENTS
- 2. LOCATE EXISTING LIGHTING CIRCUITS IN EXISTING. UTILIZE EXISTING CIRCUITS FOR NEW LIGHTS. PULL ALL NEW WIRES FOR ALL NEW LIGHTS IN NEW LOCATIONS.
- 3. PROVIDE 120V UN-SWITCH POWER TO THE LIGHTS AND FANS THRU A POWER PACK TO BE CONTROLLED BY THE OCCUPANCY SENSORS(DUAL TECHNOLOGY (DT)) AS SHOWN ON THE DETAIL.
- 1) ENLARGED ELECTRICAL PLAN
  1/4" = 1'-0"

	ELECTRICAL EXHAUST FAN SCHEDULE										
SYM	DESCRIPTION	CIRCUIT	FEEDER	VOLTS/Ø	DISCONNECT	STARTER	HP/WATTS	FLA			
EF 1	EXHAUST FAN	EXISTING	2 #12	120/1	-	_	100 W	.8			


7	EXHAUST FAN S	SCHEDU	JLE		
SYM	SERVES ROOM	MIN. ① S.C.F.M.	STATIC PRESSURE IN. W.G.	MINIMUM WATTS	REMARKS
EF 1	BATHROOM	75	0.25	81W	023

1 CONTROL: INTERLOCK WITH LIGHTS O VOLTAGE IS 115V / 1 PHASE / 60 HZ 3 PROVIDE BACKDRAFT DAMPER AND BALANCING DAMPER.

MATE		

- ALL LED FIXTURES SHALL BE LISTED BY THE DESIGN LIGHTS CONSORTIUM OR BE ENERGY STAR LABELED. LED SHALL HAVE A MINIMUM 100 LM/WATT EFFICIENCY AND A 5 YEAR WARRANTY LIFE. LED LAMPS DRIVERS SHALL HAVE INTEGRAL SURGE PROTECTORS.
- 2. REFER TO SPECIFICATIONS FOR FLUORESCENT BALLAST REQUIREMENTS.
- ALL LED LAMPS SHALL HAVE DRIVERS COMPATIBLE WITH LINE VOLTAGE DIMMERS.
- 4. THE INDICATED LED LAMP LM/WATT EFFICIENCIES INDICATED ARE MINIMAL VALUES.

	STANDARD FIXTURE SCHEDULE									
		MANUFACTURER	LAMP	LAMPS	MOUNTING	ELECTRICAL	REMARKS	SYMBOL		
TYPE	NAME	CATALOG NUMBER		TYPES		DATA				
F1	H.E. WILLIAMS	NPD-E14/A4HL-34W-30-A NPD-14RFK/A 14SP4240RT DF-14W-U(META, ALLPROAMB) 50G-S14-L45/8XX-FWAPL/15/2139WHT0-DIM-UNV ELFP14-LED-35-UE-FK14 LGM1430WHE CFP144030-FK14	40W LED	3000K	SURFACE	POWER 120 V/1-50VA	1'x4' SURFACE MOUNTED FLAT PANEL SEE SPEC 265100	1'x4'		
F5	DAY-BRIGHT METALUX DECO LSI UTHONIA COLUMBIA	CD132W-UNV-1/1EB BE132-UNV-GE-GE132MAXPLULTRA-U DWB-LED-D-4-45-UNV-DM WB132-SSOLR-UE WB132 MVOLT APLP WAL4-132	28W TB	3000K	WALL	POWER 120 V/1-28VA	4' WALL MOUNTED VANITY FIXTURE WITH ACRYLIC DIFFUSER *ELECTRONIC BALLAST SEE SPEC. 265100 MOUNT ABOVE MIRRORS AT 7'-0"	4'		

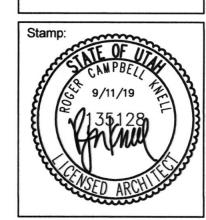

Architect / Engineer:


2


Project Number:

<u>ω</u> 515627019010101 Plan Series: REMODEL Property Number:


515627019010101 ENLARGED ELECTRICAL ₽LAN

Sheet:

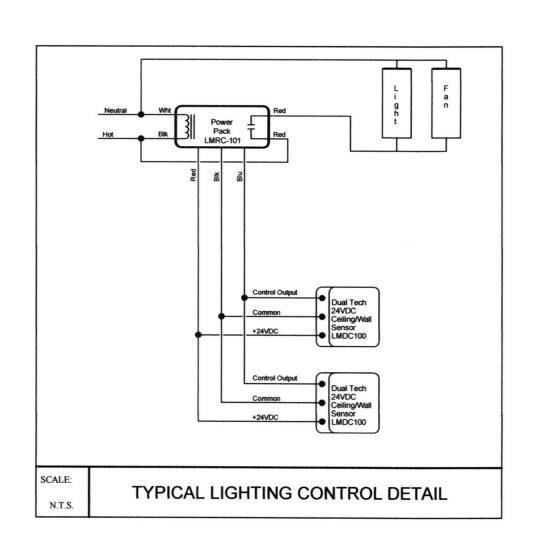

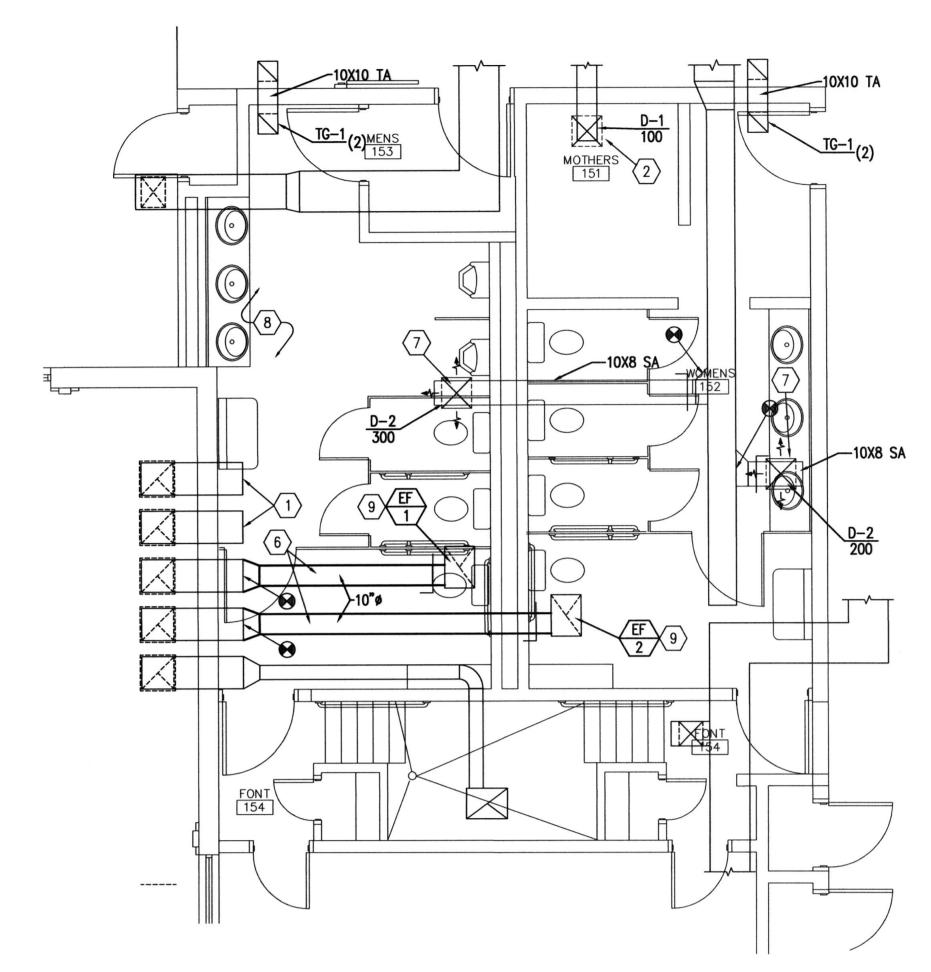

2 LARGE SCALE MECHANICAL PLAN

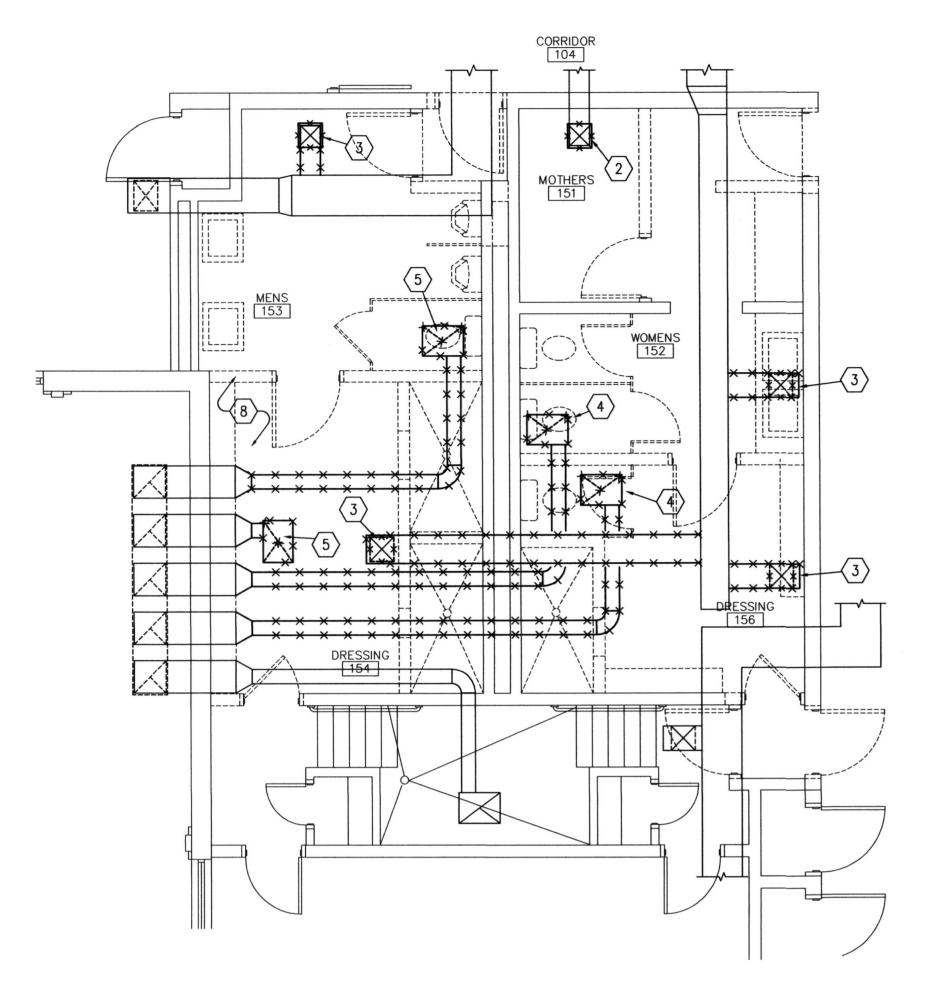

1 LARGE SCALE MECHANICAL DEMOLTION PLAN

RELOCATE OR REMOVE AND REINSTALL, DUCTS, PIPING, GRILLES. DAMPERS, LOUVERS, FIXTURES, OR ANY OTHER MECHANICAL EQUIPMENT OR DEVICES WHICH ARE ENCOUNTERED DURING DEMOLITION WHICH CONFLICT WITH THE NEW CONSTRUCTION OR WHICH ARE TO ACCOMMODATE THE NEW CONSTRUCTION. ANY EQUIPMENT, PIPING, GRILLES, DAMPERS, LOUVERS, OR FIXTURES TO REMAIN SHALL BE REINSTALLEDAT THE COMPLETION OF THIS

# **GENERAL NOTES**

- EXISTING DUCTWORK, SIZES, AND EQUIPMENT SHOWN FOR CONTRACTOR'S REFERENCE. FIELD DETERMINE EXACT SIZE, ELEVATION, AND LOCATION OF EXISTING ITEMS, INCLUDING THEIR RELATIONSHIP WITH INTENDED WORK PRIOR TO STARTING ANY
  - DRAWINGS SHOW GENERAL ARRANGEMENT OF PIPING, DUCTWORK, EQUIPMENT, ETC. FOLLOW AS CLOSELY AS ACTUAL BUILDING CONSTRUCTION AND WORK OF OTHER TRADES WILL PERMIT. BECAUSE OF THE SMALL SCALE OF THE DRAWINGS, IT IS NOT POSSIBLE TO INDICATE ALL OFFSETS, FITTINGS, AND ACCESSORIES THAT MAY BE REQUIRED. INVESTIGATE STRUCTURAL AND FINISH CONDITIONS AFFECTING THIS WORK AND ARRANGE WORK ACCORDINGLY. PROVIDE SUCH FITTINGS, VALVES, AND ACCESSORIES REQUIRED TO MEET CONDITIONS.
- 3. PATCH AND REPAIR ALL EXISTING SURFACES DAMAGED BY NEW CONSTRUCTION TO MATCH EXISTING.
- 4. BALANCE SYSTEMS BEING REVISED TO CFM'S SHOWN. MAKE ADJUSTMENTS NECESSARY TO ACHIEVE AIR FLOW QUANTITIES SHOWN ON DRAWINGS.
- 5. DUCT DIMENSIONS ARE CLEAR DIMENSIONS INSIDE DUCT LINER.
- DO NOT ROUTE PIPES ABOVE ELECTRICAL PANELS. MAINTAIN CLEAR ACCESS SPACE IN FRONT OF ALL ELECTRICAL PANELS 4'-0" DEEP AND 6'-6" HIGH.
- SAW CUT OR CORE DRILL ALL NEW PENETRATIONS THROUGH EXISTING MASONRY CONSTRUCTION.
- IF CONTRACTOR ENCOUNTERS MATERIAL THAT MAY CONTAIN ASBESTOS, HE SHALL IMMEDIATELY STOP WORK IN THIS AREA AND NOTIFY THE OWNER.
- 9. DEMOLITION GENERAL:
- a. REMOVAL OF EQUIPMENT, PIPING, OR DUCTWORK TO INCLUDE REMOVAL OF ALL RELATED APPURTENANCES SUCH AS WIRING, CONDUIT, SUPPORTS, ETC. AND MODIFICATIONS REQUIRED FOR A COMPLETE OPERATING
- b. REMOVE BRANCH CONDUIT AND WIRE COMPLETELY. TERMINATE AT JUNCTION BOX.
- c. PATCH AND REPAIR ALL EXISTING SURFACES (WALL, ROOF, FLOOR, CEILING, ETC.) TO MATCH EXISTING.
- 10. REMODEL GENERAL: a. ALL NEW CONDUIT, PIPING, DUCT, EQUIPMENT, AND APPURTENANCES TO BE CONCEALED UNLESS OTHERWISE
  - EXISTING SURFACES (WALL, ROOF, FLOOR, CEILING, ETC.)
     TO BE REMOVED AS REQUIRED AND REPLACED TO MATCH

# **KEYED NOTES**

- 1 CAP EXISTING EXHAUST DISCHARGE DUCT NOT BEING RE-USED. 2 INSTALL NEW CEILING SUPPLY DIFFUSER AT EXISTING BRANCH SUPPLY DUCT. TRANSITION AS REQUIRED.
- REMOVE EXISTING CEILING SUPPLY GRILLE AND RELATED BRANCH DUCTWORK BACK TO MAIN SUPPLY DUCT AND CAP.
- REMOVE EXISTING CEILING EXHAUST FAN AND RELATED DUCTWORK BACK TO EXTERIOR WALL. EXTERIOR DISCHARGE TO REMAIN FOR RECONNECTION.
- REMOVE EXISTING CEILING EXHAUST FAN AND RELATED DUCTWORK BACK TO EXTERIOR WALL AND CAP.
- 6 ROUTE NEW EXHAUST DUCT FROM NEW CEILING EXHAUST FAN TO EXISTING EXTERIOR DISCHARGE. TRANSITION AS REQUIRED.
- 7 Install New Ceiling Supply Grille and Branch Ductwork. Field Verify exact locations and Sizes.
- 8 EXISTING RETURN AIR TUNNEL BELOW. PROTECT AS REQUIRED DURING ALL CONSTRUCTION ACTIVITIES.
- 9 INSTALL NEW CEILING EXHAUST FAN AND BRANCH DUCTWORK. FIELD VERIFY EXACT LOCATIONS AND SIZES.

	L E G	E N	D
SYMBOL	DESCRIPTION	SYMBOL	DESCRIPTION
	BRANCH DUCT TAKE-OFF.		MANUAL VOLUME DAMPER
<b>*</b>	SINGLE THICKNESS TURNING VANES	+=+	BACKDRAFT DAMPER (INSTALL AT EACH EXHAUST DISCHARGE DUCT)
	DUCT TRANSITION	<i>\\\\\\\\\\\\\\\\\\\\\\\\\\\\\\\\\\\\\</i>	EXISTING DUCT TO BE REMOVED
EA	EXHAUST AIR	<u></u>	EXISTING DUCT TO REMAIN
TA	TRANSFER AIR	<del>                                   </del>	EXISTING DUCT TO REMAIN

VAN BOERUM Murray · Logan · St. George · Tempe

**VBFA Project Number: 19396** 

& FRANK ASSOCIATES, INC. CONSULTING ENGINEERS 181 East 5600 South 801.530.3148 T Murray, UT 84107 801.530.3150 F

Project Number: 515627019010101 Plan Series:

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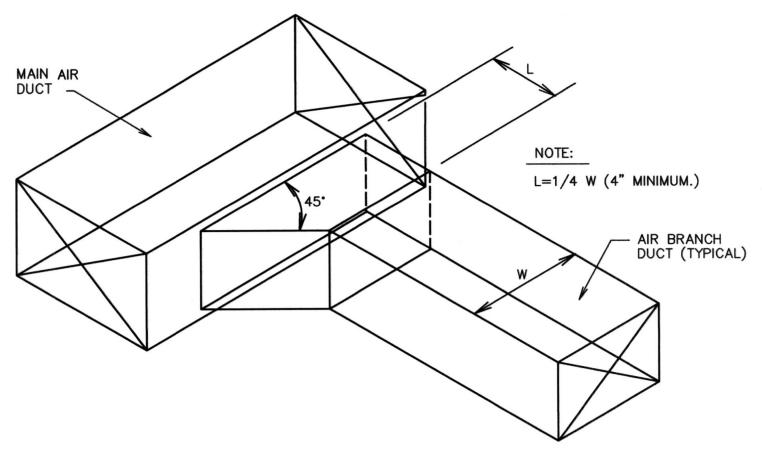
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Architect / Engineer

Stamp:

REMODEL Property Number:

515627019010101 MECHANICAL FLOOR PLAN



SUPPLY OR RETURN AIR DUCT BRANCH CONNECTION DETAIL


SCALE: NONE

				TRANSVER	SE REINFO	RCING (1)	
					AT JOINT	S	
DIMENSION OF LONGEST SIDE, INCHES	SHEET METAL GAGE (ALL FOUR SIDES)	MINIMUM REINFORCING ANGLE SIZE AND MAXIMUM LONGITUDINAL SPACING BETWEEN TRANSVERSE JOINTS &/OR INTERMEDIATE REINFORCING	MIN. H. IN.	DRIVE SLIP PLAIN S SLIP RECOM- MENDED GAGE	HEMMED S SLIP RECOM- MENDED GAGE	ALTER'NT BAR SLIP RECOM- MENDED GAGE	REIN- FORCED BAR SLIP RECOM- MENDED GAGE
UP THRU 12	26	NONE REQUIRED	1	26	26	24	24
13 – 18	24	NONE REQUIRED	1	24	24	24	24
19 - 30	24	1"X1"X1/8" @ 60 IN	1	_	24	24	24
31 - 36	22	1"X1"X1/8" @ 60 IN	1	_	_	22	22


(1) TRANSVERSE REINFORCING SIZE IS DETERMINED BY DIMENSION OF SIDE TO WHICH ANGLE IS APPLIED.

(2) LONGITUDINAL JOINTS TO BE PITTSBURG OR SNAP LOCK TYPE.



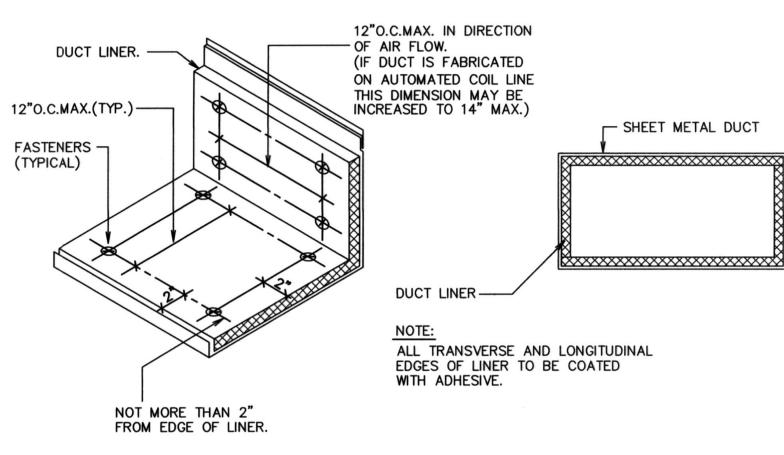



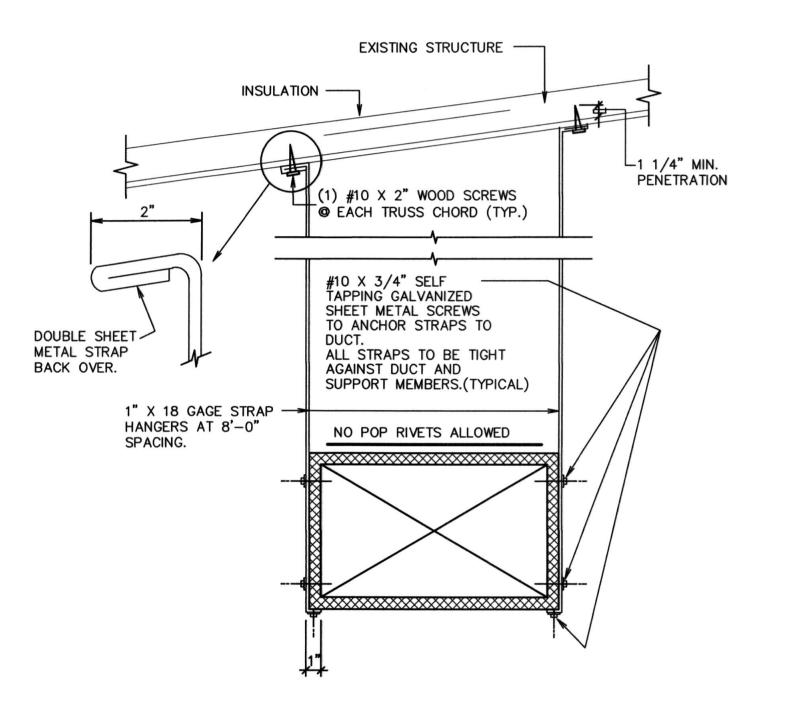

DUCT STRAP HANGER DETAIL

SCALE: NONE

	EXHAUST	FA	N SCH	IEDULE	23
MARK	SERVES ROOM	SERVES ROOM  MIN. 1 STATIC PRESSURE IN. W.G.		MIN. WATTS	REMARKS
(EF)	MEN'S RESTROOM 105	350	0.3	212W	PROVIDE BACK-DRAFT DAMPER
EF 2	WOMEN'S RESTROOM 104	350	0.3	212W	PROVIDE BACK-DRAFT DAMPER

SET BALANCE DAMPERS SHOWN
 ON M1.1 TO CFM LISTED

2 CONTROL BY DIVISION 26.

DIFFUSER				SCH	EDULE	(2	2) (5)
MARK	C.F.M. RANGE	DIFFUSER	NECK	BLOW	PATTERN	AIR DIS	T./SIDE
MARK	C.F.M. RANGE	I. RANGE SIZE CONN.		BLOW	PATIENN	A (%)	B (%)
D-1	100	6X6	6x6	3 WAY	<b>d</b> A <b>b</b> B	38	31
D-2	200-300	12X12	12x12	3 WAY	<b>A</b> A <b>B</b> B	38	31

	REGISTER, LOUVER & GRILLE SCHEDULE										
MARK	TYPE	SERVICE	CFM 1 RANGE	NOMINAL SIZE	REMARKS	3					
TG-1	CEILING 4	EILING 4 TA 3		12X12		V					

- MAXIMUM NC=25 @ MAXIMUM CFM NOTED.
- 3 SEE SPECIFICATIONS FOR APPROVED MANUFACTURERS.
- FINISH SHALL BE OFF-WHITE BAKED ENAMEL.

	EXHAUST	FA	N SCH	IEDULE	23
ARK	SERVES ROOM	MIN. 1 S.C.F.M.	STATIC PRESSURE IN. W.G.	MIN. WATTS	REMARKS
EF 1	MEN'S RESTROOM 105	350	0.3	212W	PROVIDE BACK-DRAFT DAMPER
EF 2	WOMEN'S RESTROOM 104	350	0.3	212W	PROVIDE BACK-DRAFT DAMPER

③ VOLTAGE IS 115/1PHASE/60

DIFFUSER				SCHEDULE 25				
IARK	C.F.M. RANGE	DIFFUSER SIZE	NECK CONN.	BLOW	PATTERN	AIR DIS	r./side B (%)	
D-1	100	6X6	6x6	3 WAY	⊲\\\\\\\\\\\\\\\\\\\\\\\\\\\\\\\\\\\\	38	31	
D-2	200-300	12X12	12x12	3 WAY	<b>A</b> A <b>B</b> B	38	31	

	REGISTER, LOUVER & GRILLE SCHEDULE										
MARK	TYPE	SERVICE	CFM 1 RANGE	NOMINAL SIZE	REMARKS	3					
TG-1	CEILING 4	TA	350	12X12		٧					

REGISTER, LOUVER AND DIFFUSER SCHEDULE NOTES:

- SHALL BE TITUS TDC TYPE 6 OR EQUAL BY OTHER APPROVED MANUFACTURERS. (SEE SPECIFICATIONS)
- 5 FINISH: ANODIZED ALUMINUM.

Architect / Engineer

Stamp:

JESUS CHRIST OF LATTER-DAY SAINTS

Project Number: 515627019010101 REMODEL Property Number: 515627019010101


MECHANICAL DETAILS AND SCHEDULES

VAN BOERUM & FRANK ASSOCIATES, INC. CONSULTING ENGINEERS


181 East 5600 South Murray, UT 84107 801.530.3148 T 801.530.3150 F VBFA Project Number: 19396

Sheet: M501




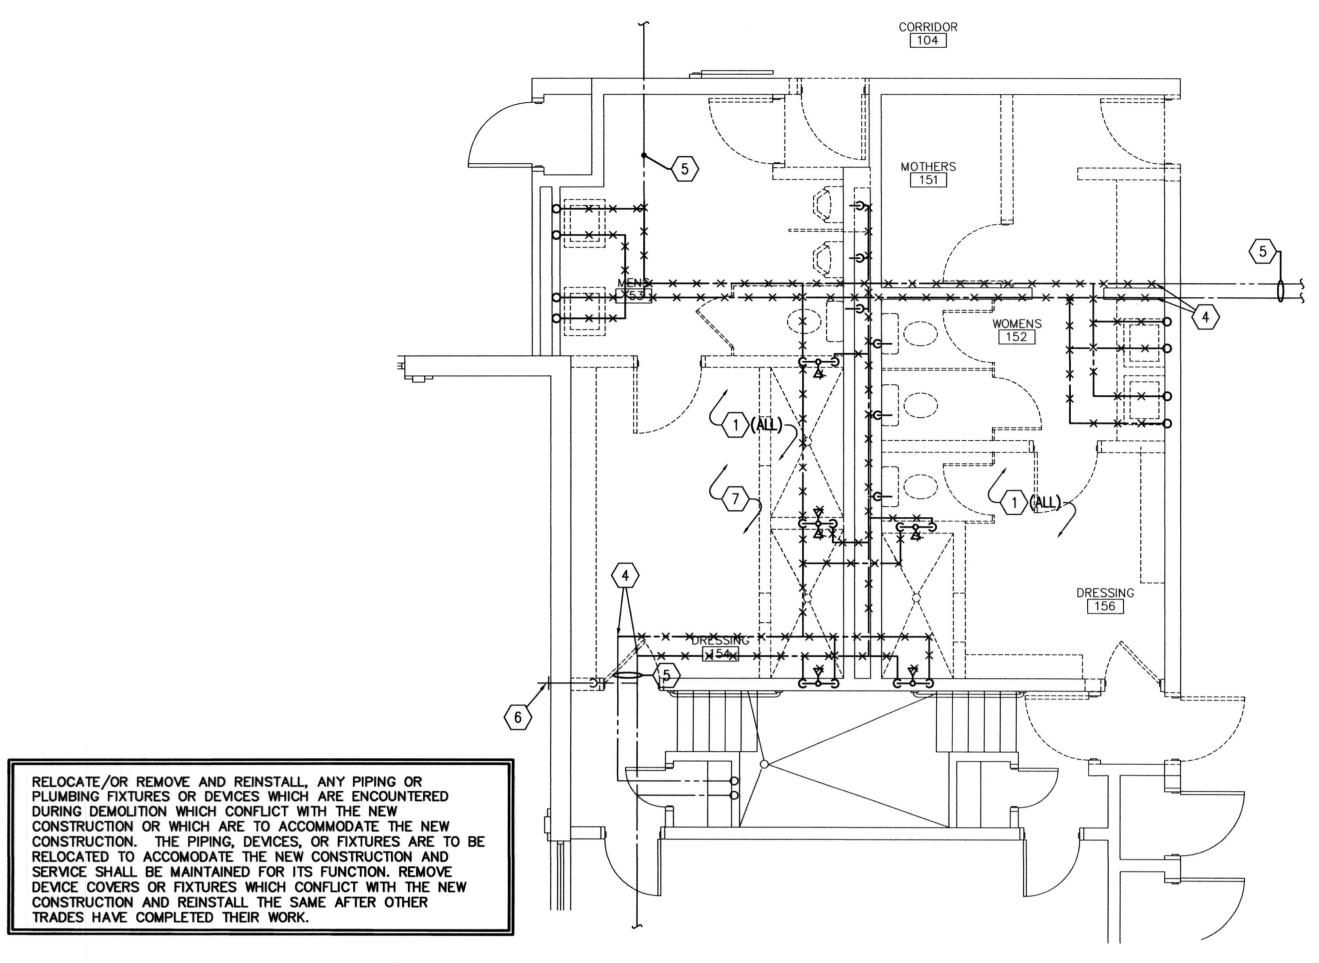


2 ENLARGED PLUMBING (DOMESTIC WATER) DEMO PLAN

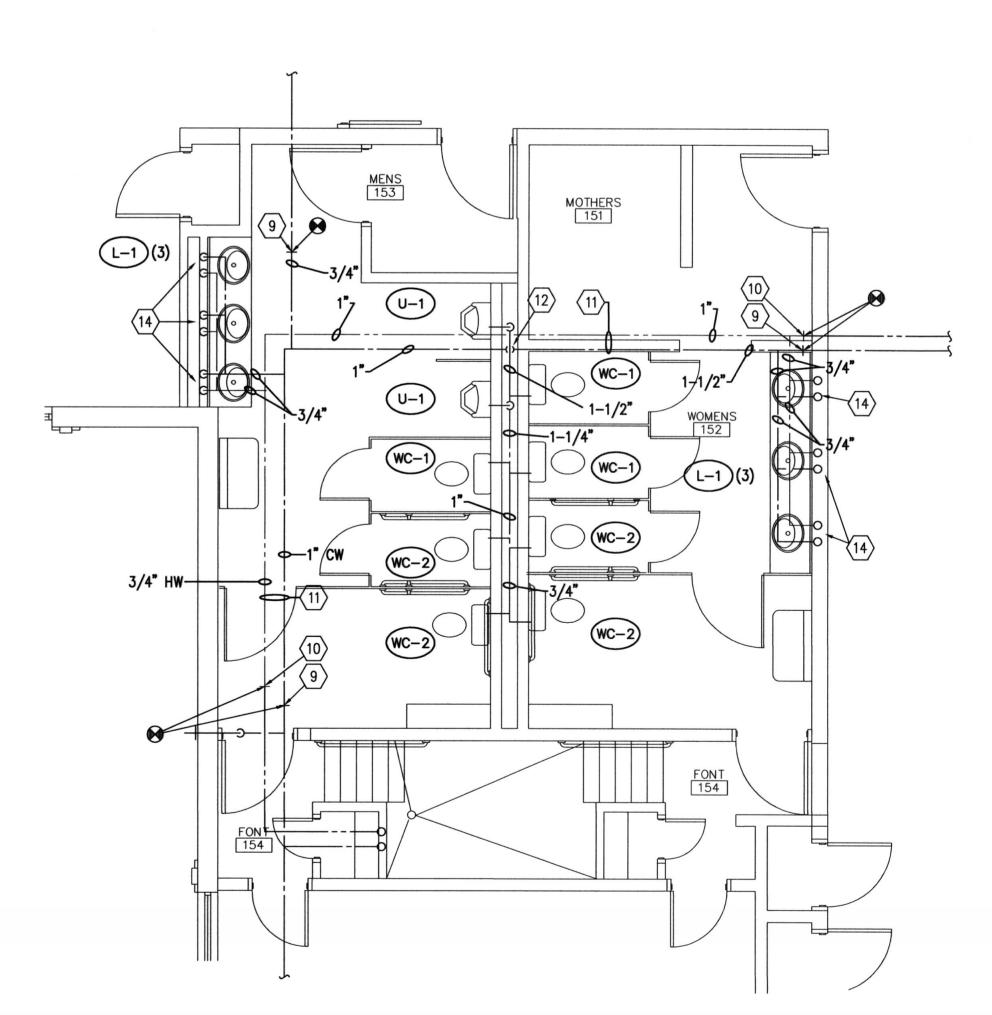

4 ENLARGED PLUMBING (DOMESTIC WATER) PLAN

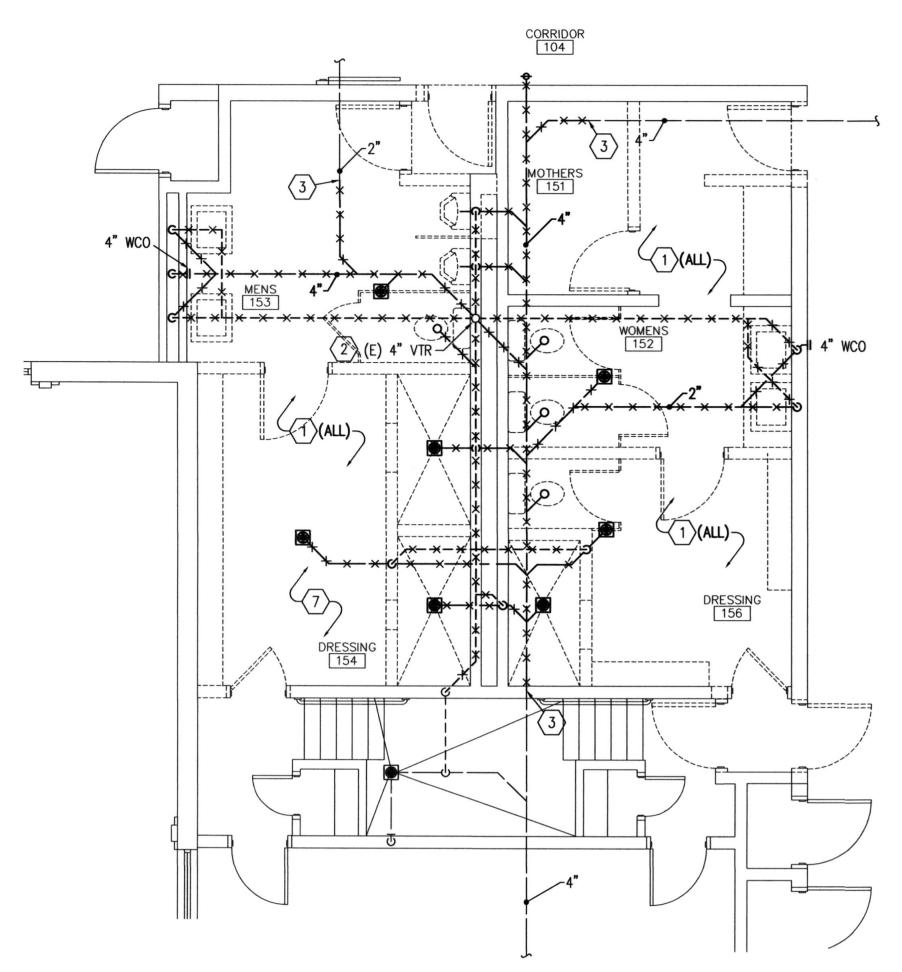

1) ENLARGED PLUMBING (WASTE & VENT) DEMO PLAN

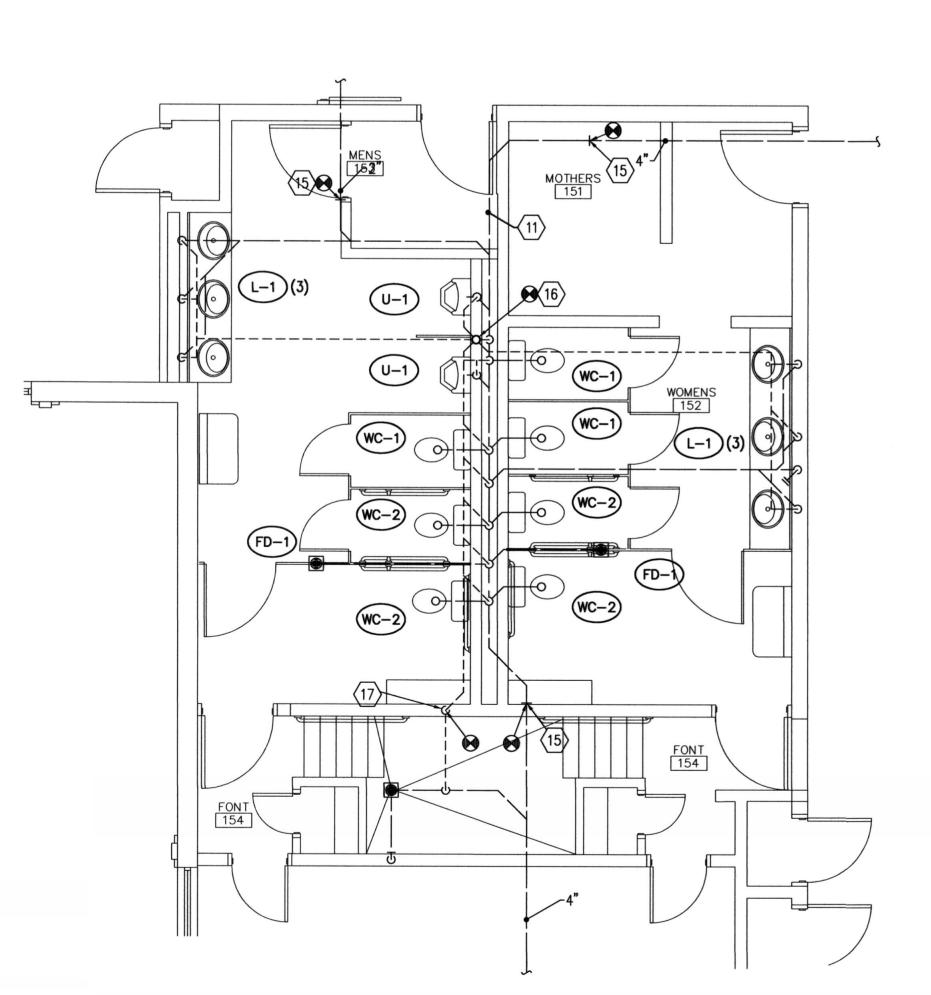

(3) ENLARGED PLUMBING (WASTE & VENT) PLAN

### **GENERAL NOTES**

- IF CONTRACTOR ENCOUNTERS MATERIAL THAT MAY CONTAIN ASBESTOS, HE SHALL IMMEDIATELY STOP WORK IN THIS AREA AND NOTIFY OWNER.
- 2. EXISTING PIPE LOCATIONS AND PIPE SIZES SHOWN HAVE BEEN TAKEN FROM EXISTING DRAWINGS. CONTRACTOR IS TO FIELD DETERMINE EXACT SIZE. ELEVATION AND LOCATION OF EXISTING PIPING INSIDE THE BUILDING AT SPECIFIED CONNECTION POINTS PRIOR TO STARTING ANY WORK.
- 3. SAW CUT OR CORE DRILL ALL NEW PENETRATIONS THROUGH EXISTING MASONRY CONSTRUCTION.
- 4. PATCH AND REPAIR ALL EXISTING SURFACES DAMAGED BY NEW CONSTRUCTION TO MATCH EXISTING.
- 5. DEMOLITION GENERAL:
- A. REMOVE ALL RELATED PIPING AND APPURTENANCES. B. REMOVE BRANCH PIPING COMPLETELY AND CAP IN MAIN. C. PATCH AND REPAIR ALL EXISTING SURFACES (WALL, ROOF, FLOOR, CEILING, ETC.) TO MATCH EXISTING.
- REMODEL GENERAL:
- A. CONCEAL ALL PIPING EQUIPMENT, AND APPURTENANCES UNLESS
- B. REMOVE EXISTING SURFACES (WALL, ROOF, FLOOR, CEILING, ECT.) AS REQUIRED AND REPLACE TO MATCH EXISTING.
- 7. REFER TO MECHANICAL SHEETS FOR ANY ADDITIONAL WORK.
- 8. ALL PLUMBING SHALL COMPLY WITH THE MOST STRINGENT OF APPLICABLE CODES, ORDINANCES OR THE SPECIFICATIONS.
- 9. ALL FIXTURES SHALL BE PROPERLY VENTED TO THE ATMOSPHERE.
- 10. FOR INDIVIDUAL LINE SIZES TO FIXTURES, SEE FIXTURE SCHEDULE, SHEET P5.1.
- 11. DUE TO THE CLOSE PROXIMITY OF THE WATER, DRAIN AND VENT PIPING AS WELL AS DUCTWORK, EQUIPMENT AND HVAC PIPING, THE PLUMBING CONTRACTOR SHALL COORDINATE THE INSTALLATION WITH THE MECHANICAL AND SHEET METAL
- 12. PROTECT ALL PLUMBING PIPING WHICH IS TO REMAIN DURING ALL CONSTRUCTION ACTIVITIES.
- 13. MINIMUM SIZE OF PIPING BELOW SLAB IS 3/4".

## **KEYED NOTES**

- 1 REMOVE EXISTING PLUMBING FIXTURE. REMOVE RELATED WASTE, VENT, AND SUPPLY PIPING BACK TO LOCATIONS SHOWN. REFER TO NEW PLUMBING PLANS, SHEET P1.1, FOR NEW PIPING CONNECTIONS. FIELD VERIFY ALL EXISTING LOCATIONS.
- 2 EXISTING VENT THOUGH ROOF TO REMAIN FOR RECONNECTION. FIELD VERIFY EXACT LOCATION.
- EXISTING MAIN WASTE OR VENT PIPING TO REMAIN FROM THIS LOCATION. REFER TO NEW WASTE AND VENT PLAN, SHEET P2.1, FOR NEW CONNECTION. FIELD VERIFY EXACT
- REMOVE EXISTING DOMESTIC WATER PIPING IN RETURN AIR TUNNEL FROM THIS POINT. REFER TO NEW DOMESTIC WATER PLAN, SHEET P2.1, FOR NEW CONNECTION. FIELD VERIFY EXACT LOCATION.
- 5 EXISTING DOMESTIC WATER PIPING IN RETURN AIR TUNNEL. FIELD VERIFY EXACT LOCATION.
- 6 EXISTING EXTERIOR WALL HYDRANT TO REMAIN.
- PIPING LOCATED IN EXISTING RETURN AIR TUNNEL BELOW.
  PROTECT DURING ALL CONSTRUCTION ACTIVITIES. FIELD VERIFY EXACT LOCATION.
- REMOVE EXISTING PLUMBING FIXTURE FOR REPLACEMENT. EXISTING WASTE, VENT, AND SUPPLY PIPING TO REMAIN FOR RECONNECTION. PROTECT DURING CONSTRUCTION.
- 9 RECONNECT TO EXISTING CW (BELOW GRADE) AT THIS LOCATION. FIELD VERIFY EXACT LOCATION.
- RECONNECT TO EXISTING HW (BELOW GRADE) AT THIS LOCATION. FIELD VERIFY EXACT LOCATION.
- NEW DOMESTIC WATER AND WASTE PIPING IN EXISTING RETURN AIR TUNNEL.
- 12 RISE NEW 1-1/2" CW UP IN NEW PLUMBING WALL.
- (13) EXISTING DOMESTIC WATER PIPING BELOW FLOOR SLAB.
- RISE NEW BRANCH PIPING UP IN NEW WALL TO SERVE LAVATORY L-2.
- CONNECT NEW WASTE PIPING TO EXISTING WASTE PIPING AT THIS LOCATION. FIELD VERIFY EXACT LOCATION.
- CONNECT NEW VENT PIPING TO EXISTING VENT THROUGH ROOF. FIELD VERIFY EXACT LOCATION.
- CONNECT NEW VENT PIPING TO EXISTING. FIELD VERIFY EXACT LOCATION.
- NEW FIXTURE. RECONNECT EXISTING WASTE, VENT, AND SUPPLY PIPING. EXTEND AS REQUIRED.
- EXISTING WASTE PIPING BELOW SLAB. FIELD VERIFY EXACT LOCATION.

181 East 5600 South

VBFA Project Number: 19396

VAN BOERUM & FRANK ASSOCIATES, INC. CONSULTING ENGINEERS

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Stamp:

Architect / Engineer

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Project Number: 515627019010101 Plan Series: REMODEL


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DEMOLITION AND FLOOR PLANS


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SYMBOL OR ABBREVIATION	MEA	ANING	;	SYMBOL OF ABBREVIATI			MEANING
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VENT THRU ROOF		VTR		UNION			
EXISTING PIPE TO BE REMOVED	<del>* *</del>	××	<del>×</del>	EXISTING TO BE RE			

Р	LUMBI	N C	}	F	ΙX	T	URE SCHEDULE
MARK	FIXTURE		PII	PE SIZE			REMARKS
WARK	TIXTORE	TRAP	WASTE	VENT	C.W.	H.W.	REMARKS
WC-1	WATER CLOSET	INT.	4"	2"	1/2"	-	FLUSH TANK. 1.28 GPF MAXIMUM.
WC-2	WATER CLOSET	INT.	4"	2"	1/2"	-	FLUSH TANK, 18" RIM HEIGHT (ADA APPROVED). 1.28 GPF MAXIMUM.
U-1	URINAL	INT.	3"	2"	3/4"	~	FLUSH VALVE, WALL HUNG
L-1	LAVATORY	1-1/4"	1-1/4"	1-1/2"	1/2"	1/2"	COUNTER TOP. 0.5 GPF MAXIMUM. 1 2
FD-1	FLOOR DRAIN	2*	2"	2"	_	-	WITH DEEP SEAL P-TRAP AND TRAP SEAL. A/P501

- (1) WHEN MOUNTED PER ARCHITECTURAL ELEVATIONS, ADA ACCESSIBILITY REQUIREMENTS ARE SATISFIED.
- 2 PROVIDE POINT-OF-USE MIXING VALVE BELOW FIXTURE. SEE SPECIFICATIONS.

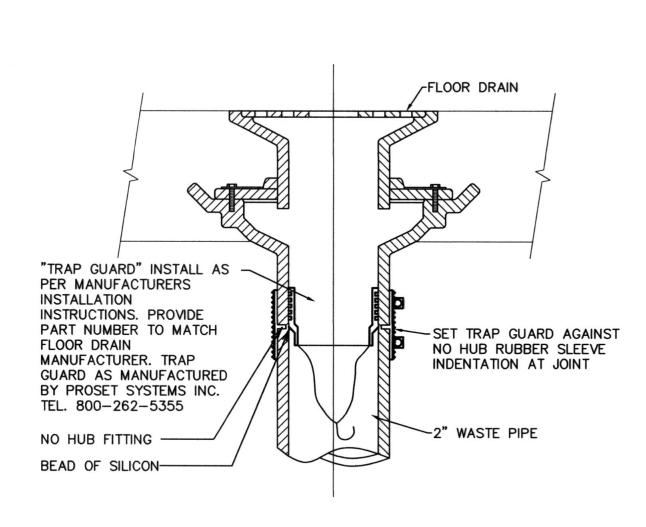

B TRAP GUARD TRAP SEAL DETAIL SCALE: NONE

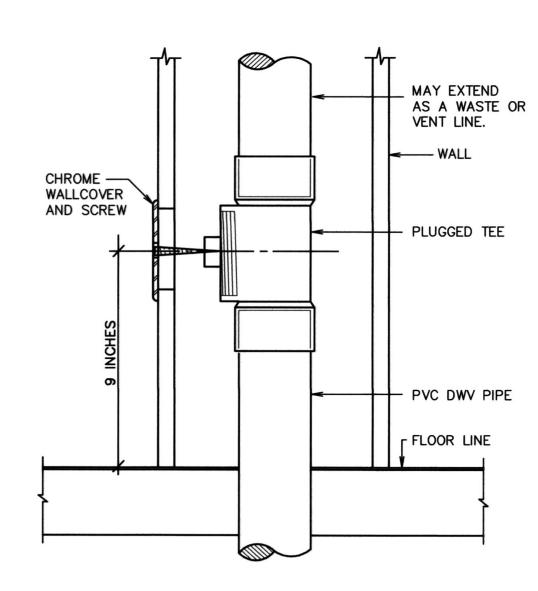

A WALL CLEANOUT DETAIL
SCALE: NONE




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970 NORTH 400 EAST

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Property Number:
515627019010

Sheet Title:
PLUMBING

PLUMBING SCHEDULE AND DETAILS

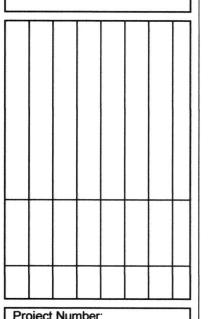VAN BOERUM

& FRANK ASSOCIATES, INC.

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P501