

MAGNA REGIONAL PARK - PHASE I

CONSTRUCTION DOCUMENTS - BID SET - VOLUME 1 OF 3

JUNE 6, 2019



Prepared for:
 2001 South State Street, Suite S4-700
 Salt Lake City, Utah 84114
 (385) 468-1800


DESIGN TEAM

Owner

Salt Lake County Parks and Recreation Division
 2001 South State Street, Suite S4-700
 Salt Lake City, Utah 84114
 P: (385) 468-1817
 Contact: Dustin Wiberg


Landscape Architect - Prime Consultant

G Brown Design Inc.
 610 East South Temple, Suite 50
 Salt Lake City, Utah 84102
 P: (801) 575-6066
 Contact: Andrew Noorlander

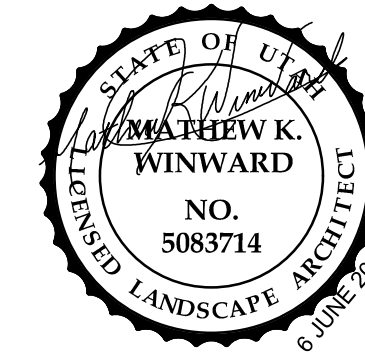

Civil Engineer

Perigee Consulting, L.L.C.
 9089 S. 1300 W., Suite 100
 West Jordan, UT 84088
 P: (801) 910-3395
 F: (801) 590-6611
 Contact: Jed Atherley

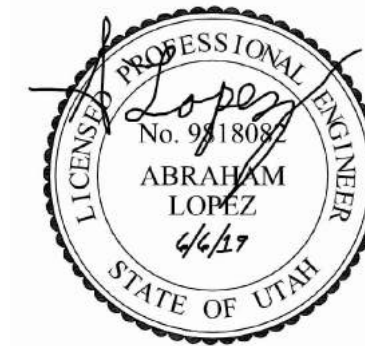

Electrical Engineer

Envision Engineering
 240 E. Morris Ave, Suite 200
 Salt Lake City, Utah 84115
 P: (801) 534-1130
 Contact: Aleksander Rankovic




Splash Pad

Water Design, Inc.
 5047 South Galleria Drive
 Salt Lake City, Utah 84123
 P: (801) 261-4009
 Contact: Brain Anderson



Architect

Range Architecture
 1086 E 2100 S
 Salt Lake City, Utah 84102
 P: (801) 694-9150
 Contact: Derek Wilson

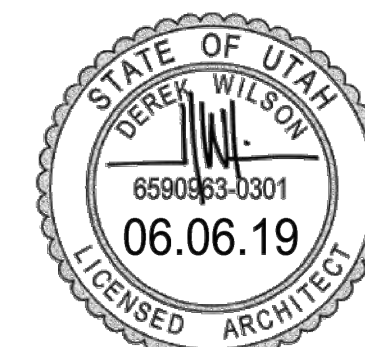

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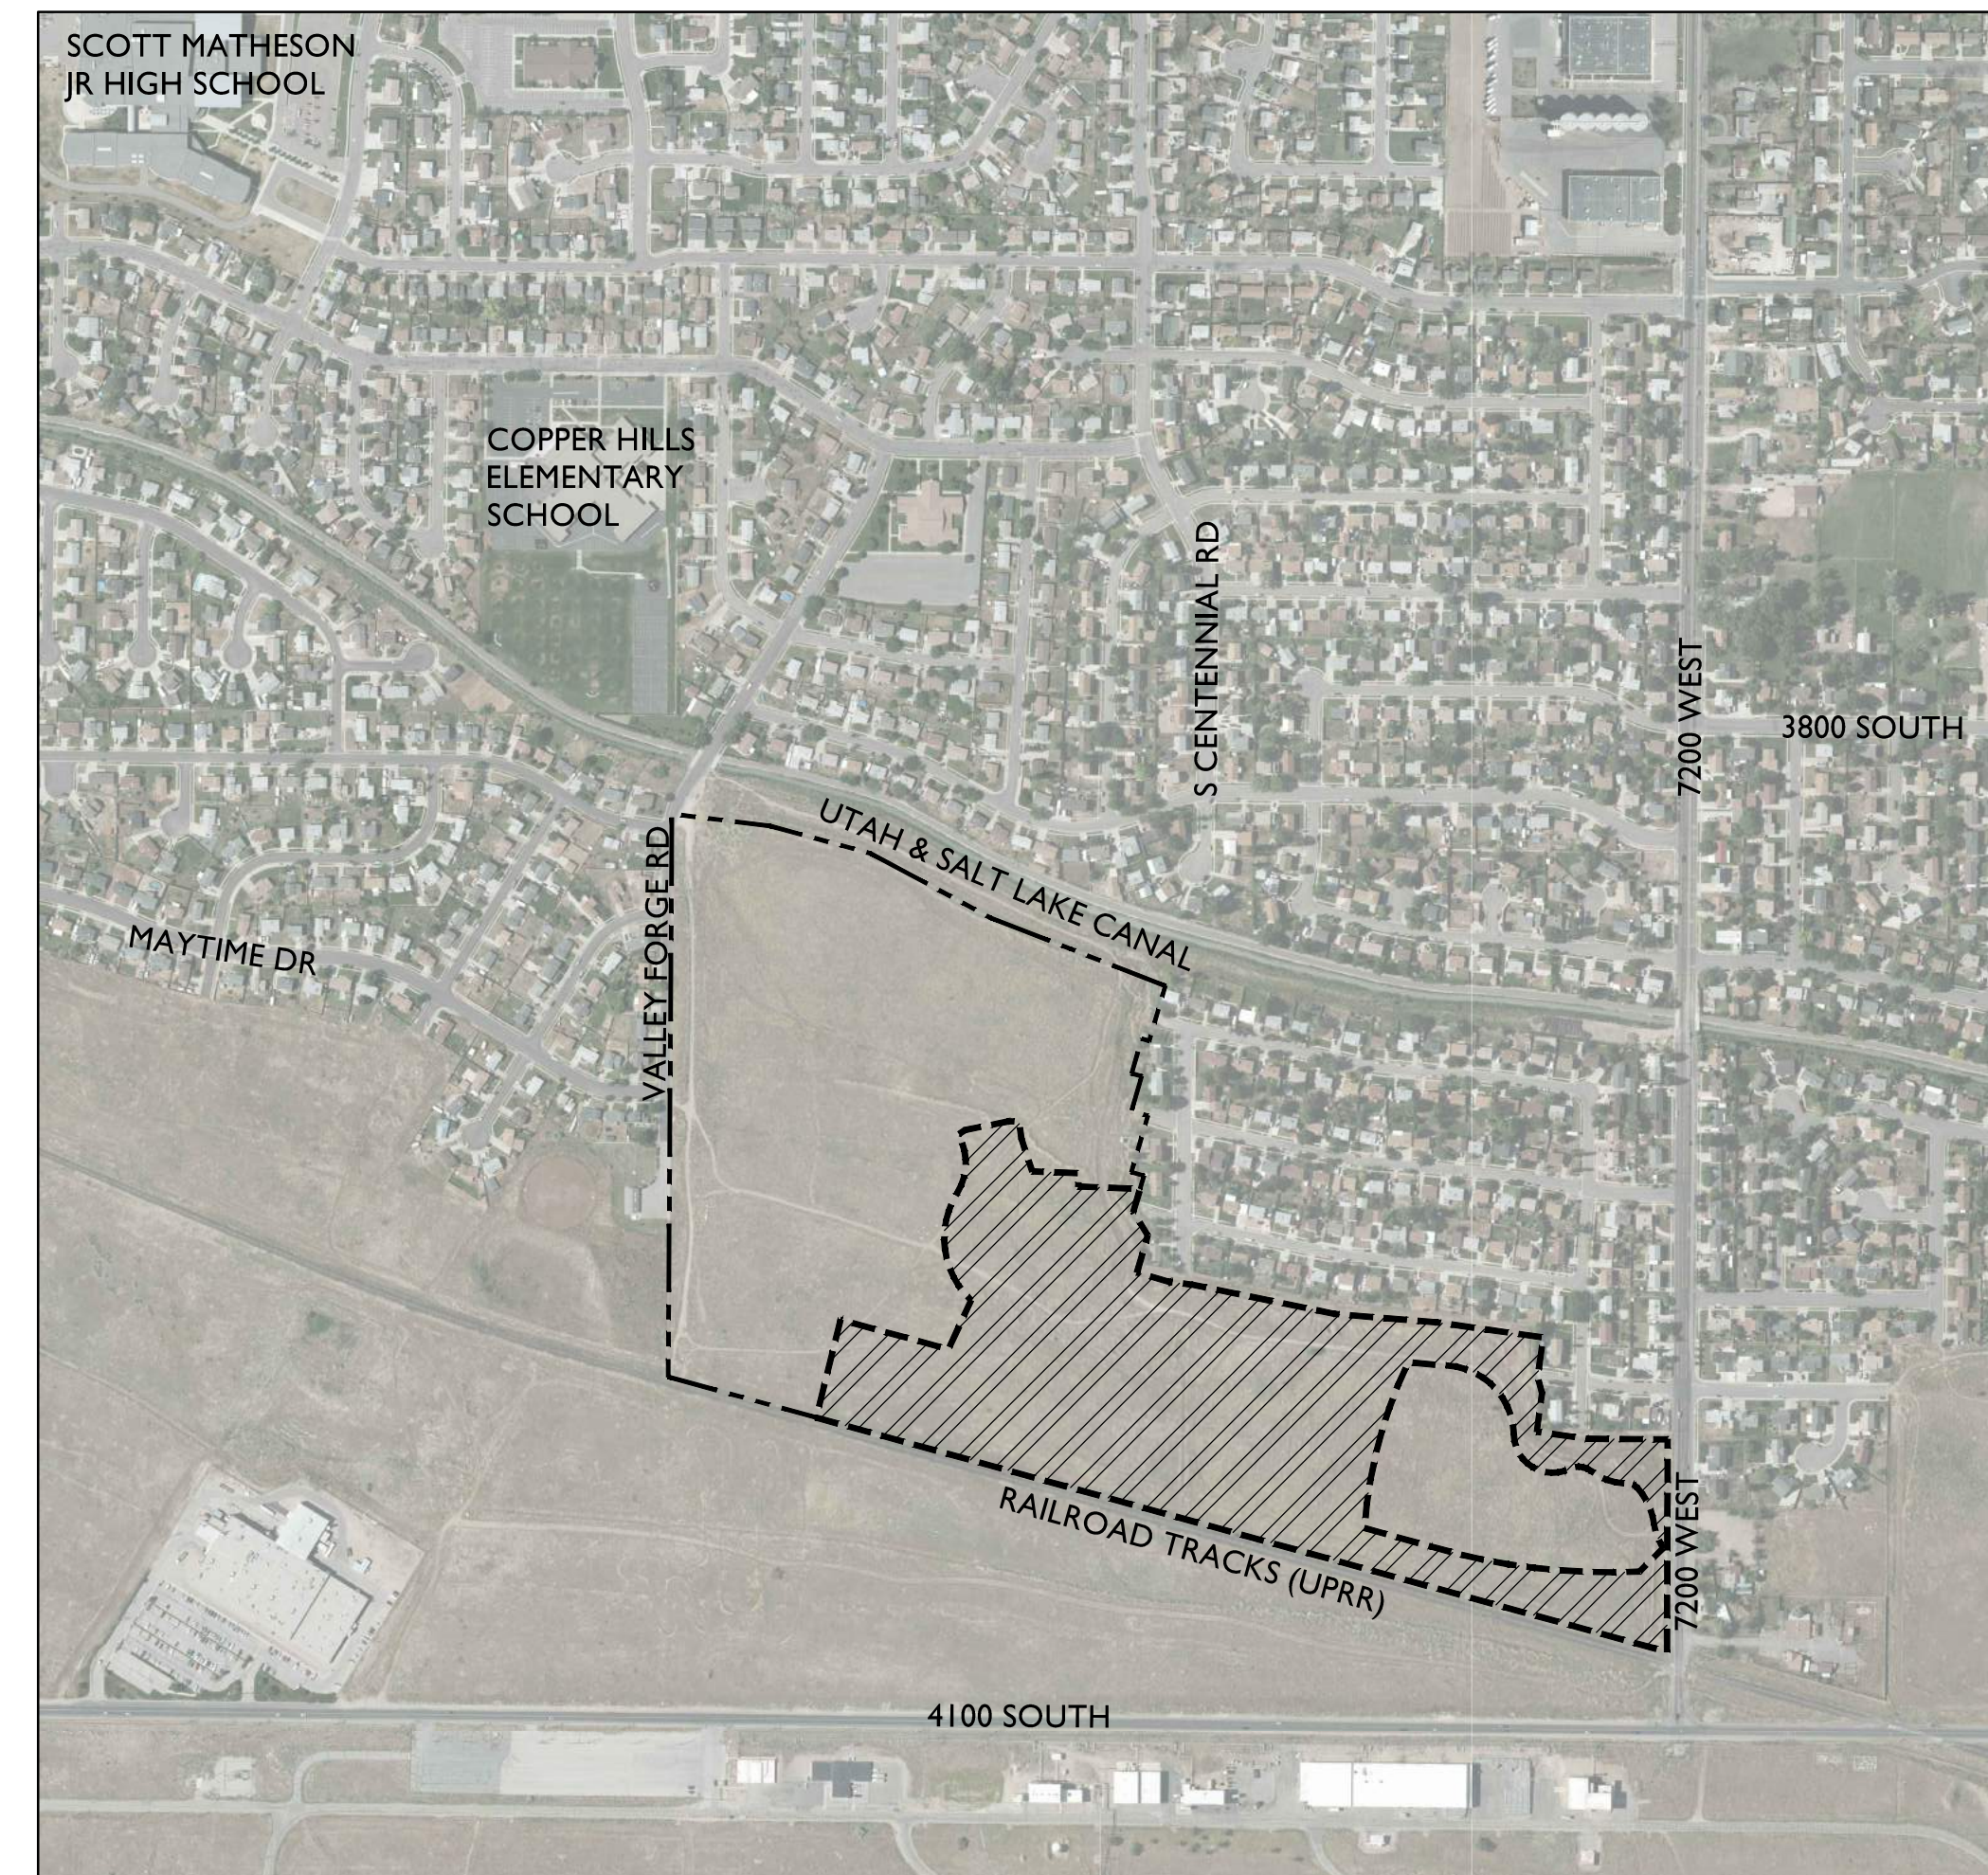
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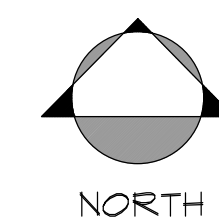
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Project Area

4042 South 7200 West
 Magna, Utah 84044



APPLICABLE CODES

International Fire Code	2015
International Plumbing Code	2014
International Fuel Gas Code	2015
International Building Code	2015
International Mechanical Code	2015
National Electrical Code	2014
International Energy Conservation Code	2015
ADA (ADAAG)	2010
Magna Township Over Pressure Zone Ordinance	Current

YEAR




G. BROWN: DESIGN INC
 SITE AND LANDSCAPE ARCHITECTS



610 East South Temple, Ste 50
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 www.gbrowndesign.com

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 ELECTRICAL ENERGY
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 BY: *[Signature]* DATE: 11/13/19
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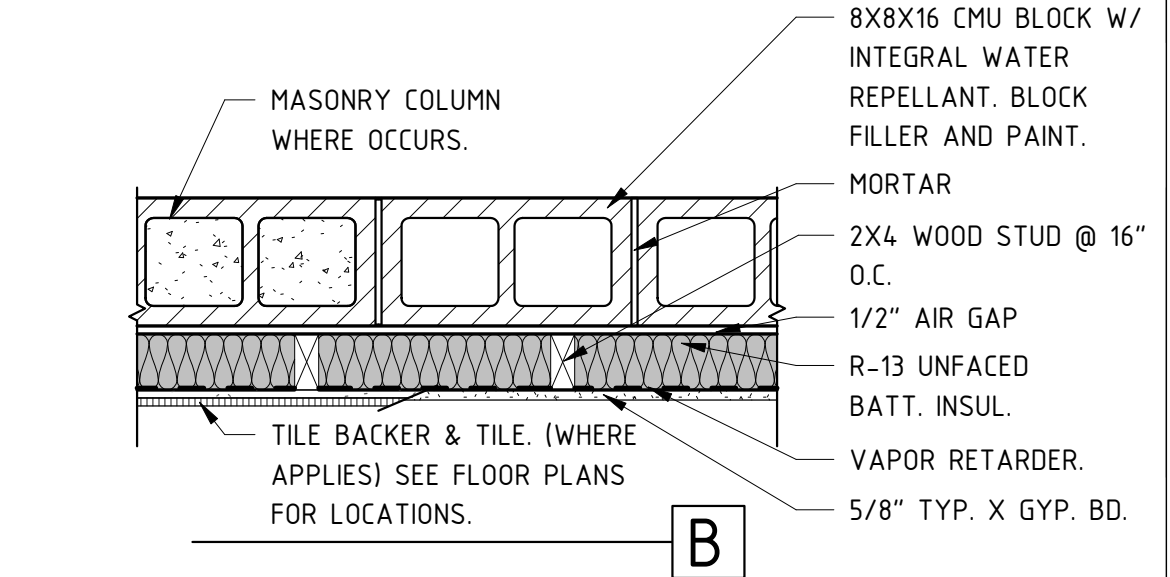
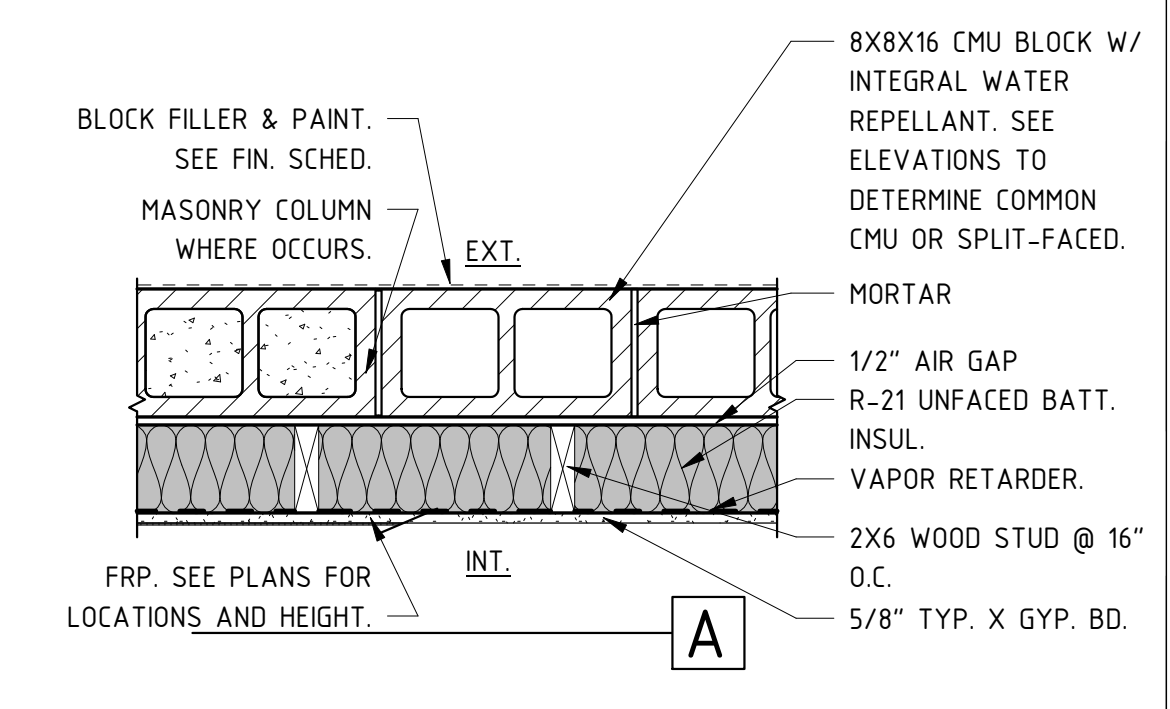
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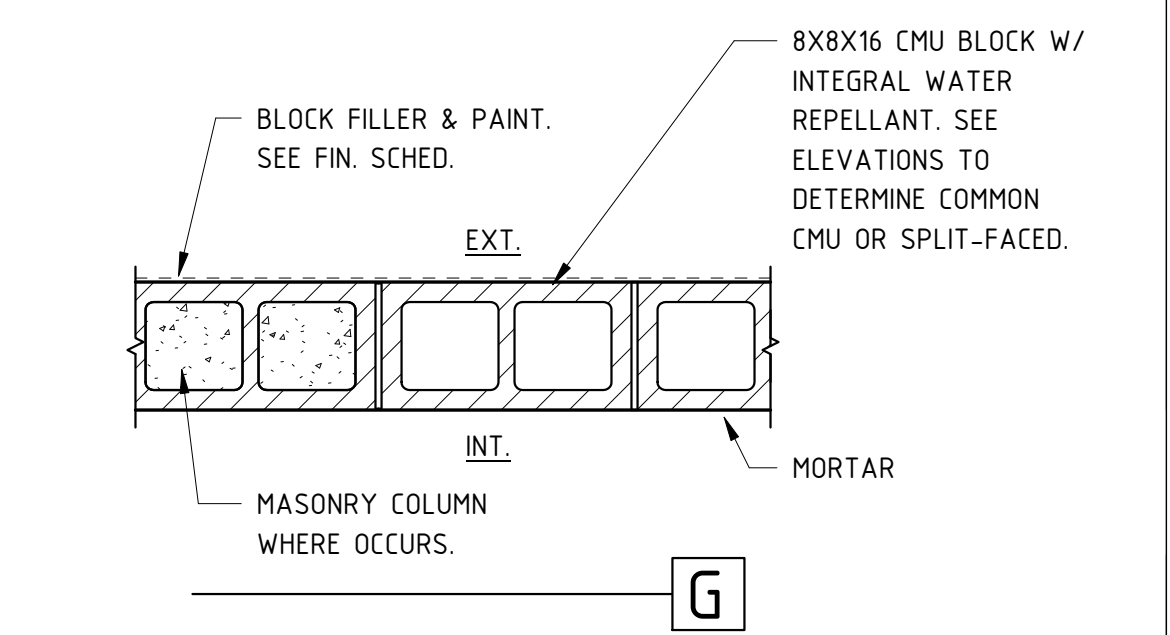
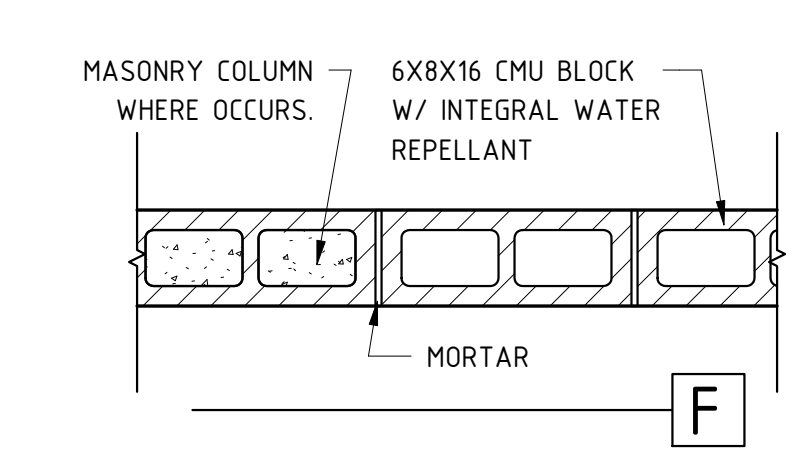
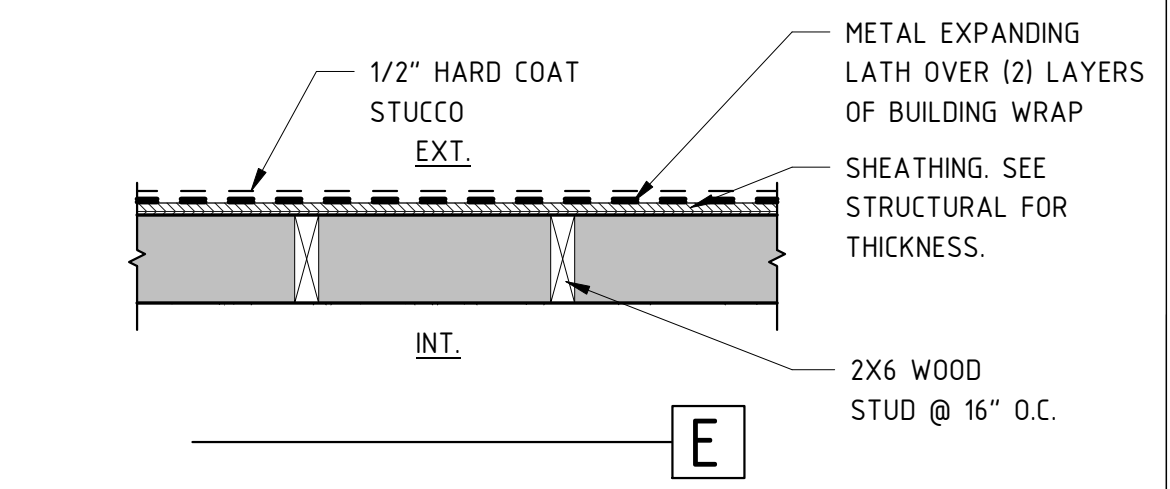
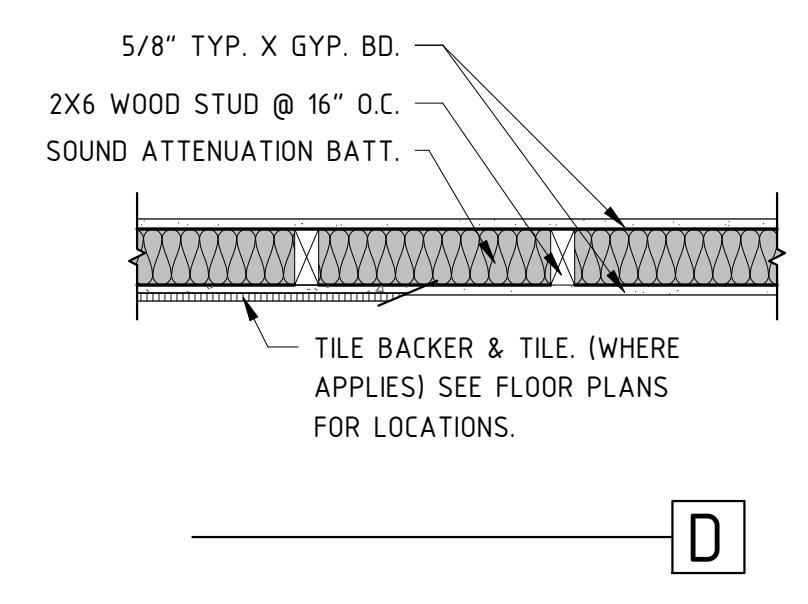
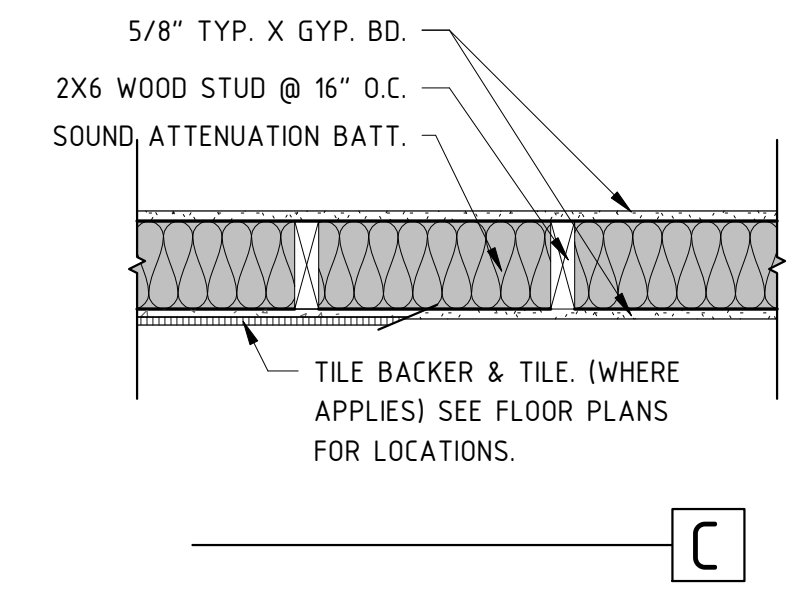
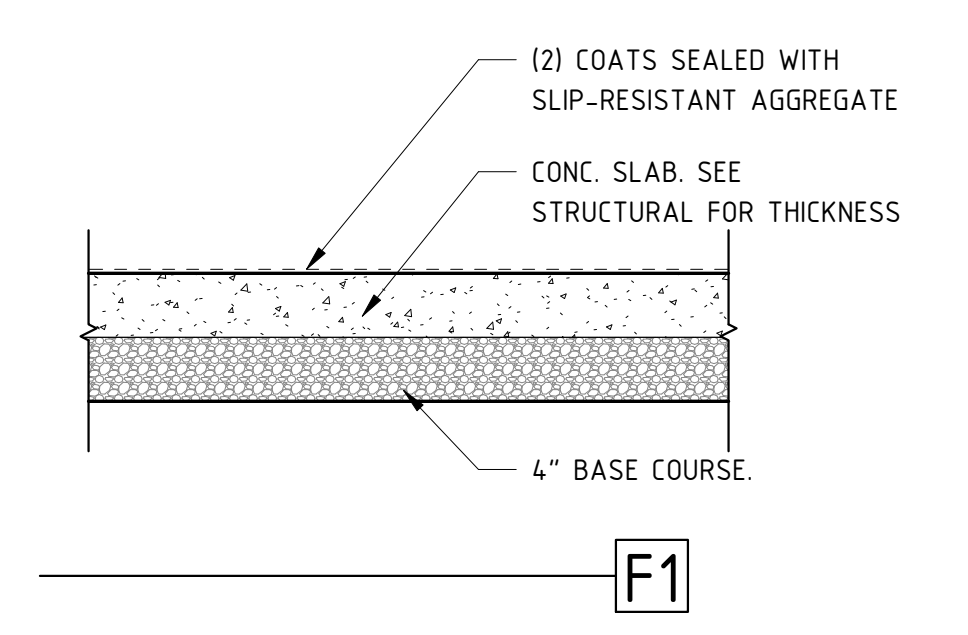
CEILING TYPES:

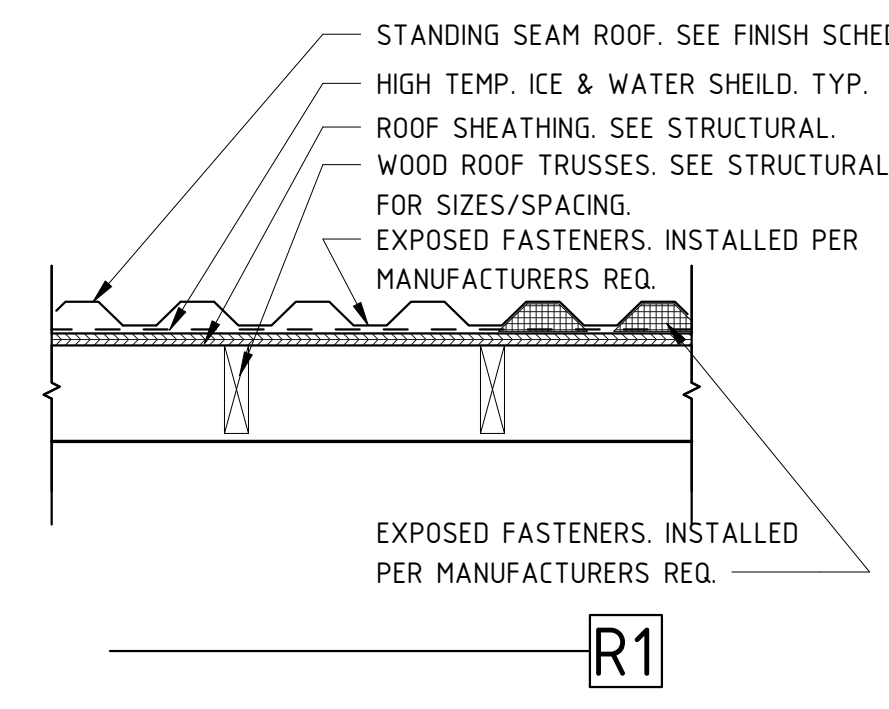

WALL TYPES:

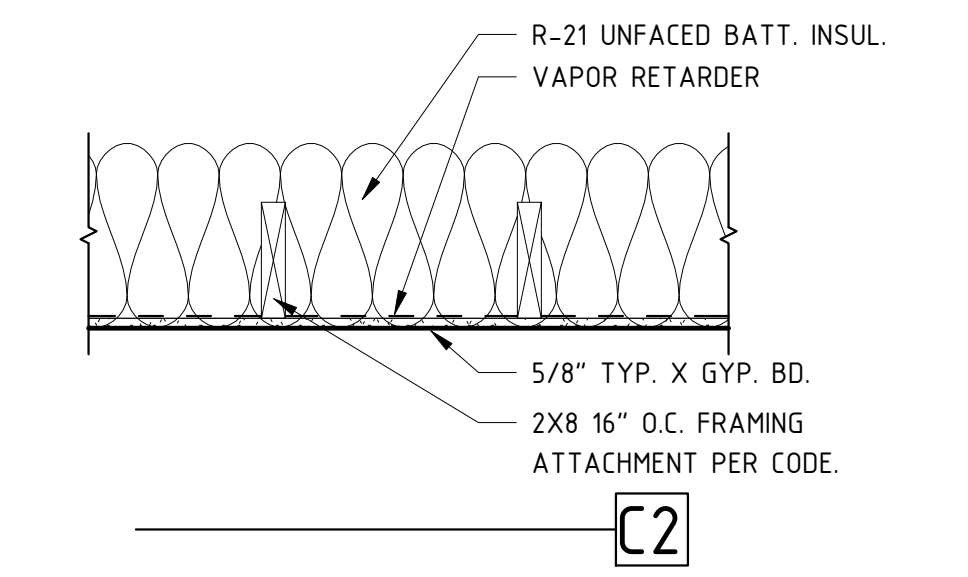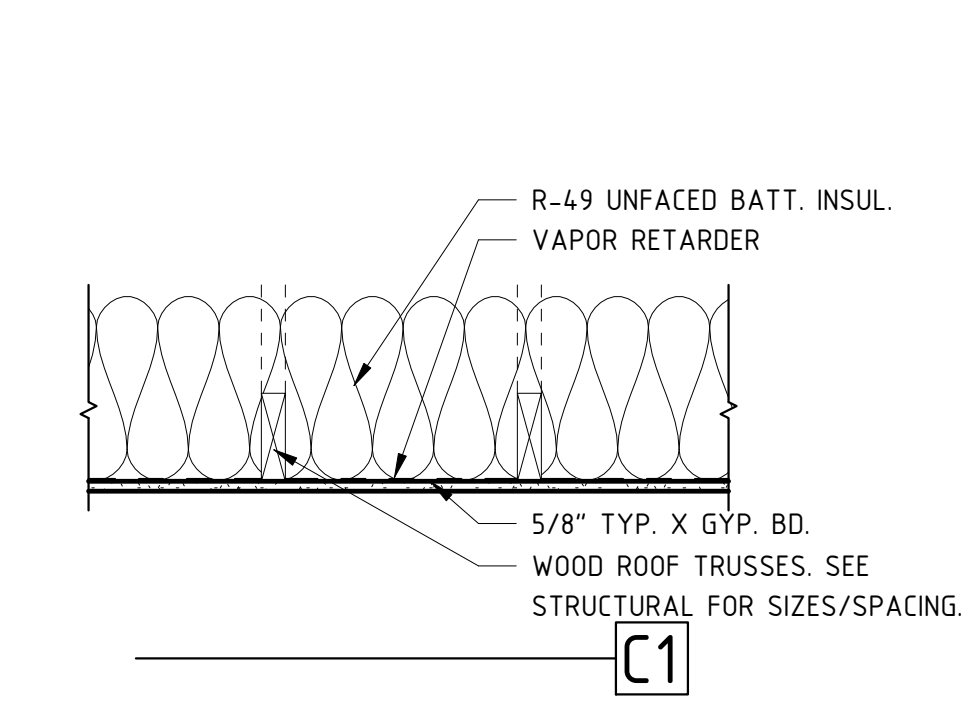

FLOOR TYPES:



G.B:D
 G. BROWN: DESIGN INC
 SITE AND LANDSCAPE ARCHITECTS
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 www.gbrowndesign.com

PREPARED FOR:
SALT LAKE COUNTY
 PARKS & RECREATION
 CONSULTANTS:
RANGE
 RANGE ARCHITECTURE & DESIGN
 3748 EAST HERRING DRIVE, SUITE 107, MIDVALE, UT 84048
 WWW.RANGEARCHITECTURE.COM 801.884.9180

MAGNA REGIONAL PARK
PHASE 1
4042 SOUTH 7200 WEST
MAGNA, UTAH 84044

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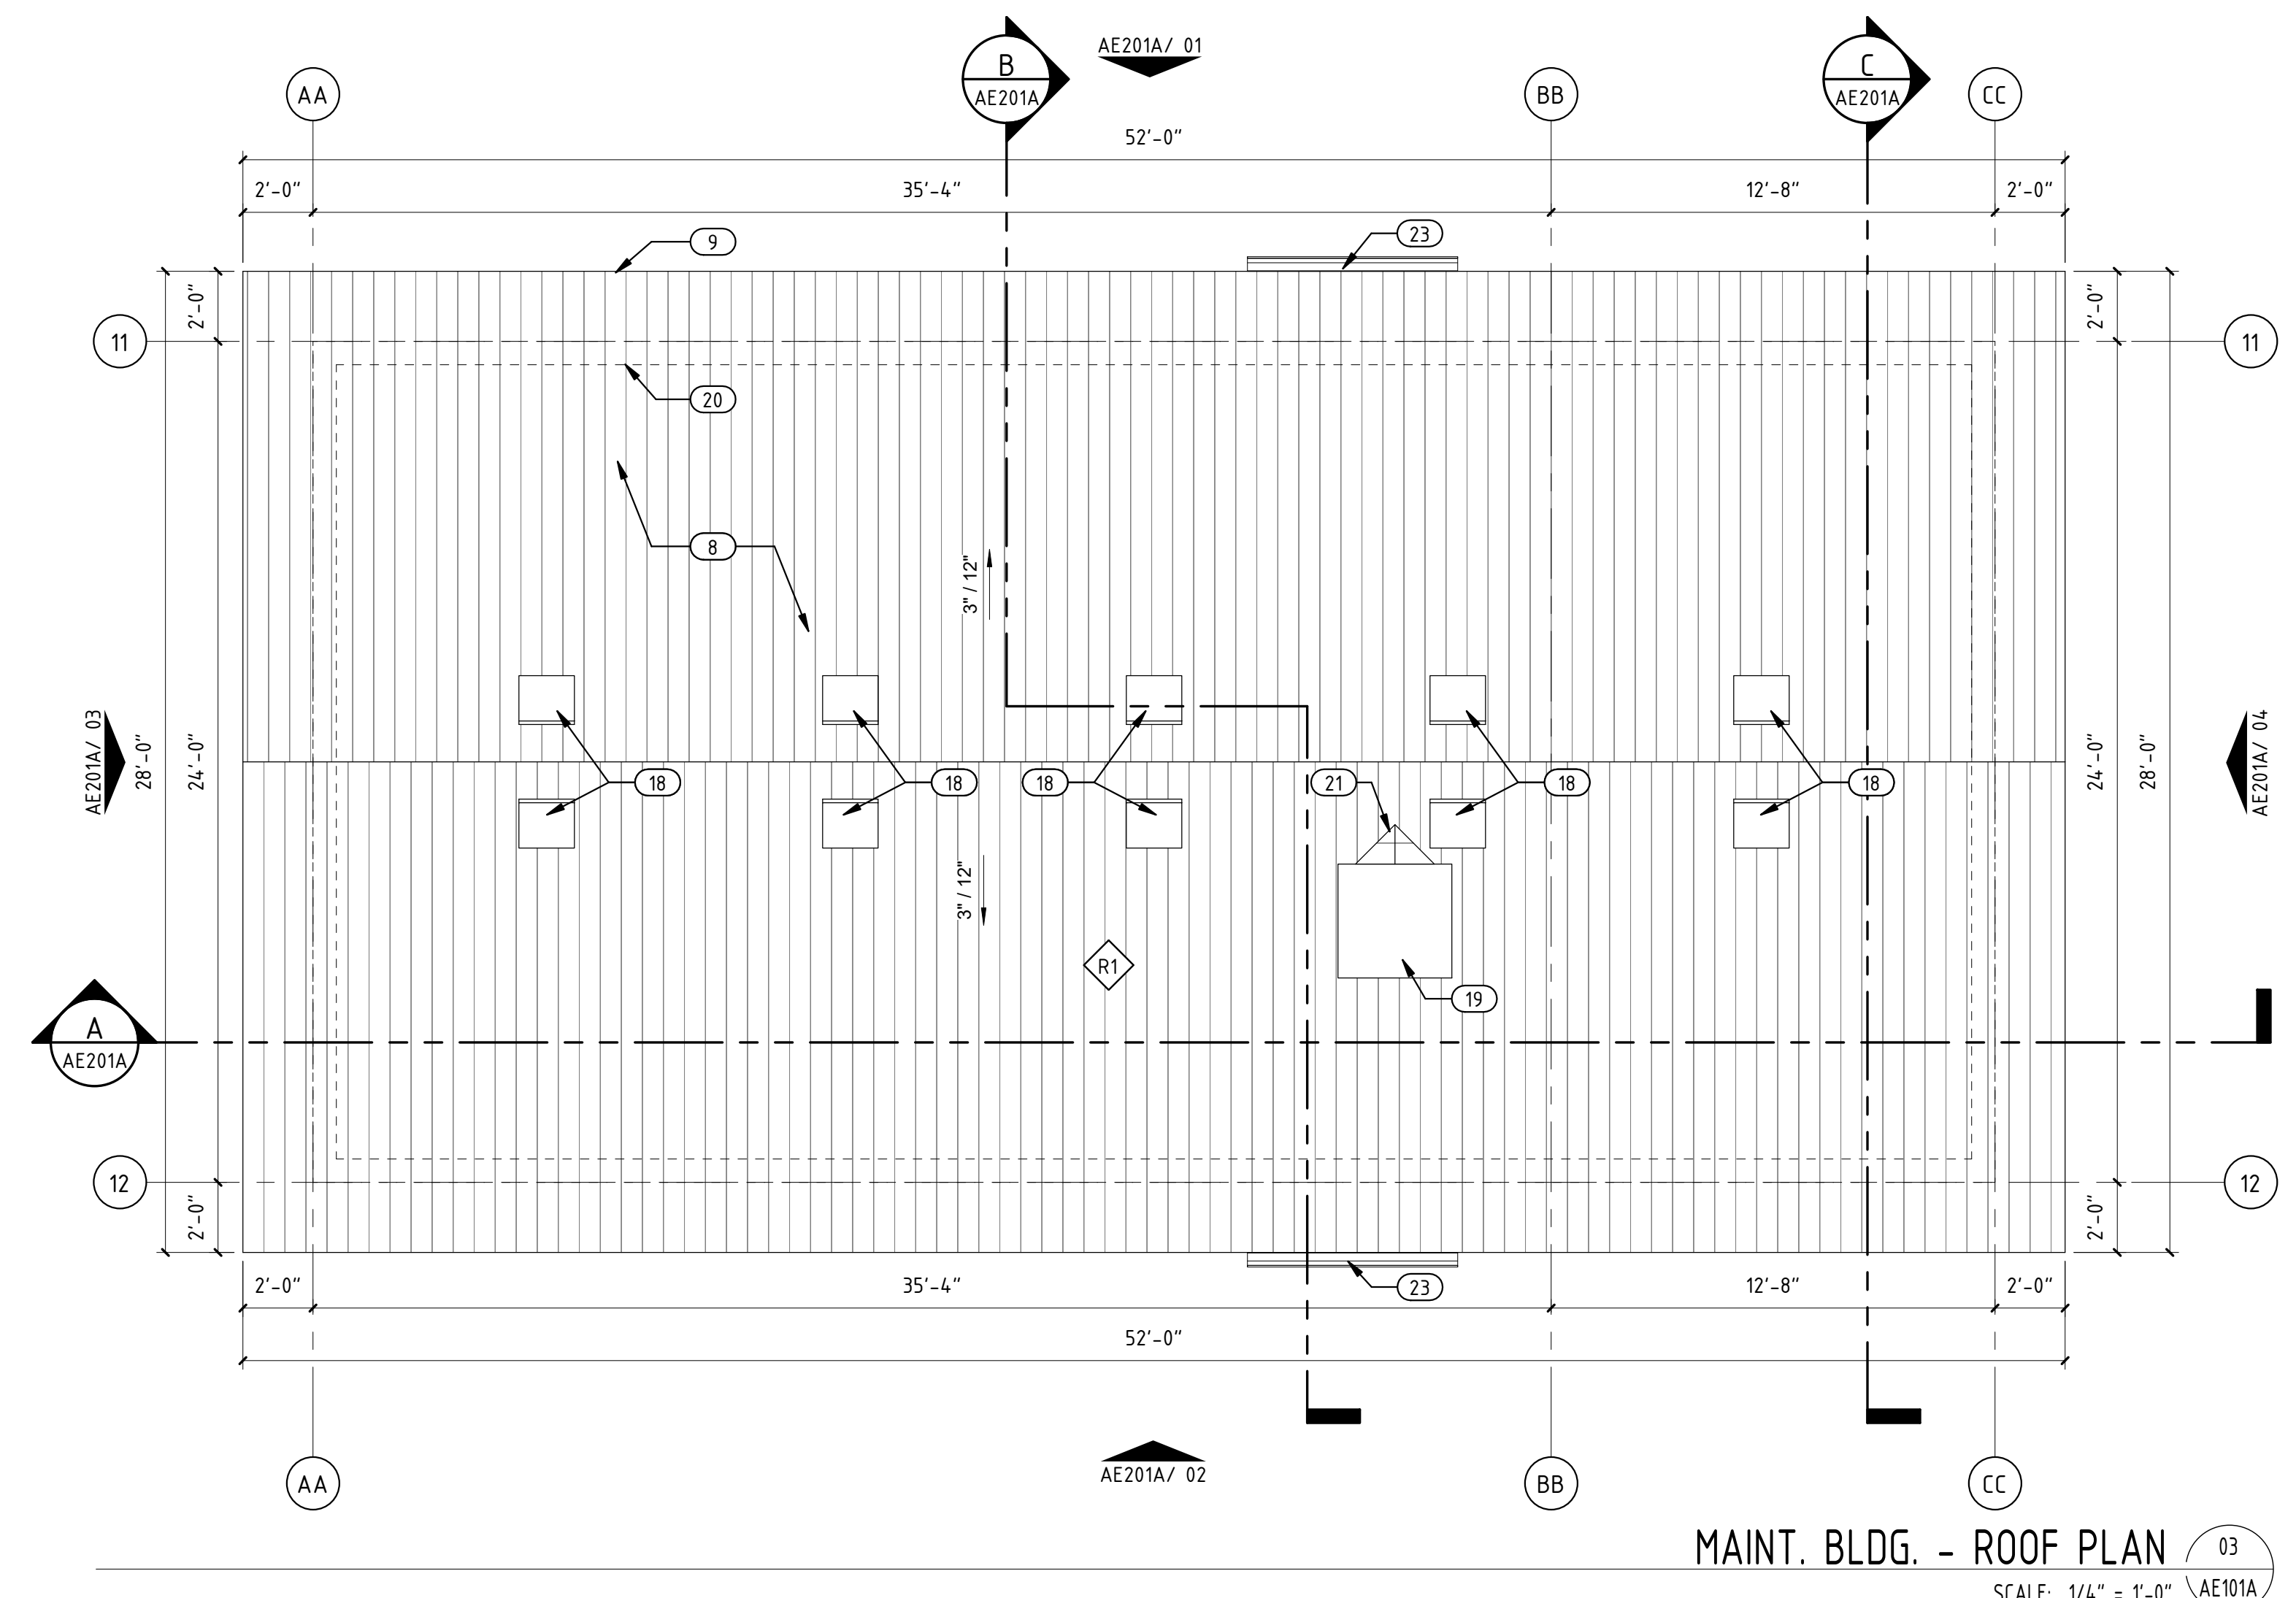
SHEET TITLE:
ASSEMBLY TYPES

DATE: 7-22-19
 DRAWN BY: CKG
 CHECKED BY: DW
 JOB NO.: U17-021

SHEET NO:
AE001

CONSTRUCTION DOCUMENTS - CONFORMED SET

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 WEST COAST CODE CONSULTANTS, INC.



MAINT. BLDG. - ATTIC VENT CALCS:



- * ATTIC CALCULATION: 1/150 S.F. RULE
 VENTILATED ATTIC AREA= 1,152 SF
- * VENTILATION REQUIRED: 1,152/150= 7.68 SF
 ROOF VENTILATION REQ.= 3.84 SF
 EAVE VENTILATION REQ.= 3.84 SF
- * ROOF VENT OPTION:
 16" X 19" VENT 61 SI
 10 X 61 SI (0.42 SF)= 4.20 SF
- * EAVE VENT (5.87 SI PER SF):
 104 L.F. X 5.87 SI (0.0408 SF)= 4.24 SF
- * TOTAL VENTILATION= 8.44 SF

GENERAL NOTES AND LEGEND:

- SEE SHEET AE001 FOR GENERAL NOTES.
- SEE TITLE SHEET FOR DRAWING INDEX.
- DO NOT SCALE DRAWINGS.
- CONTRACTOR / SUBCONTRACTOR SHALL VERIFY ALL DIMENSIONS AND CONDITIONS BEFORE BEGINNING WORK, AND SHALL REPORT TO THE ARCHITECT ANY ERRORS, INCONSISTENCIES OR OMISSIONS BEFORE BEGINNING WORK. SEE GENERAL NOTES AND SPECIFICATIONS.

- KEYED NOTES:**
- 4" CONCRETE SLAB ON VAPOR BARRIER ON 4" BASE COURSE.
 - PRE-FINISHED METAL LOCKERS. OWNER PROVIDED, OWNER INSTALLED.
 - HEATER PLATFORM. HUNG FROM STRUCTURE ABOVE. SEE DETAIL AE401.
 - 6" DIA. STEEL PIPE BOLLARD. SEE DETAILS.
 - POWERED OVERHEAD DOOR. SEE DOOR SCHEDULE ON AE601 AND ELECTRICAL PLANS.
 - DOOR. SEE DOOR SCHEDULE ON AE601.
 - TRENCH DRAIN.
 - PRE-FINISHED STANDING SEAM METAL ROOFING OVER FULL ICE & WATER SHIELD. TYPICAL AT STANDING SEAM ROOF.
 - METAL FASCIA WRAP W/CONT. DRIP EDGE. MATCH ROOF COLOR.
 - SURFACE MOUNTED LIGHTING FIXTURE. SEE ELECTRICAL DRAWINGS.
 - EXHAUST FAN. SEE MECHANICAL DRAWINGS.
 - REFINISHED VENTED ALUMINUM SOFFIT. SEE CALCS.
 - SEE LANDSCAPE SHEETS FOR WALKS AROUND BUILDING.
 - 5" CONCRETE SLAB ON VAPOR BARRIER ON 4" BASE COURSE.
 - FLOOR DRAIN.
 - FIRE EXTINGUISHER IN WALL MOUNTED CABINET.
 - PRE-FINISHED METAL WRAP FASCIA - MATCH ROOF COLOR.
 - ROOF VENT - 50 SQ. INCHES OF NET FREE AIR. INSTALL BETWEEN ROOFING RIBS AND TRUSSES.
 - ROOF TOP SWAMP COOLER. SEE MECHANICAL PLANS.
 - DASHED LINE REPRESENTS BUILDING LINE BELOW.
 - CRICKET.
 - PROVIDE GAP IN WALL TYPE A TO ALLOW SPACE FOR SECTIONAL DOOR FRAME.
 - REFINISHED ALUMINUM GUTTER. NO DOWNSPOUT.
 - AIR TIGHT CONSTRUCTION AT DRYWALL CEILING & WALLS.
 - WALL MOUNTED LIGHT. SEE ELECTRICAL.
 - PENDANT MOUNTED LIGHTING FIXTURE AT 9'-0". SEE ELECTRICAL DRAWINGS.
 - ATTIC ACCESS. SEE ACCESS. SCHED.
 - ADA ACCESSIBLE METAL LOCKER. THIS INCLUDES CLEAR FLOOR SPACE OF 48"X30". ACCESSIBLE REACH RANGE AS SHOWN ON G1002 UNOBSTRUCTED REACH AND OPERABLE PARTS FOR THE LOCKER (AND LOCK IF PROVIDED) AS INDICATED IN SECTION 309 OF ICC A117.1-09. OWNER PROVIDED, OWNER INSTALLED.

Permit Numbers
 191130 - Maintenance Building
 190726 - Restroom & Pump House

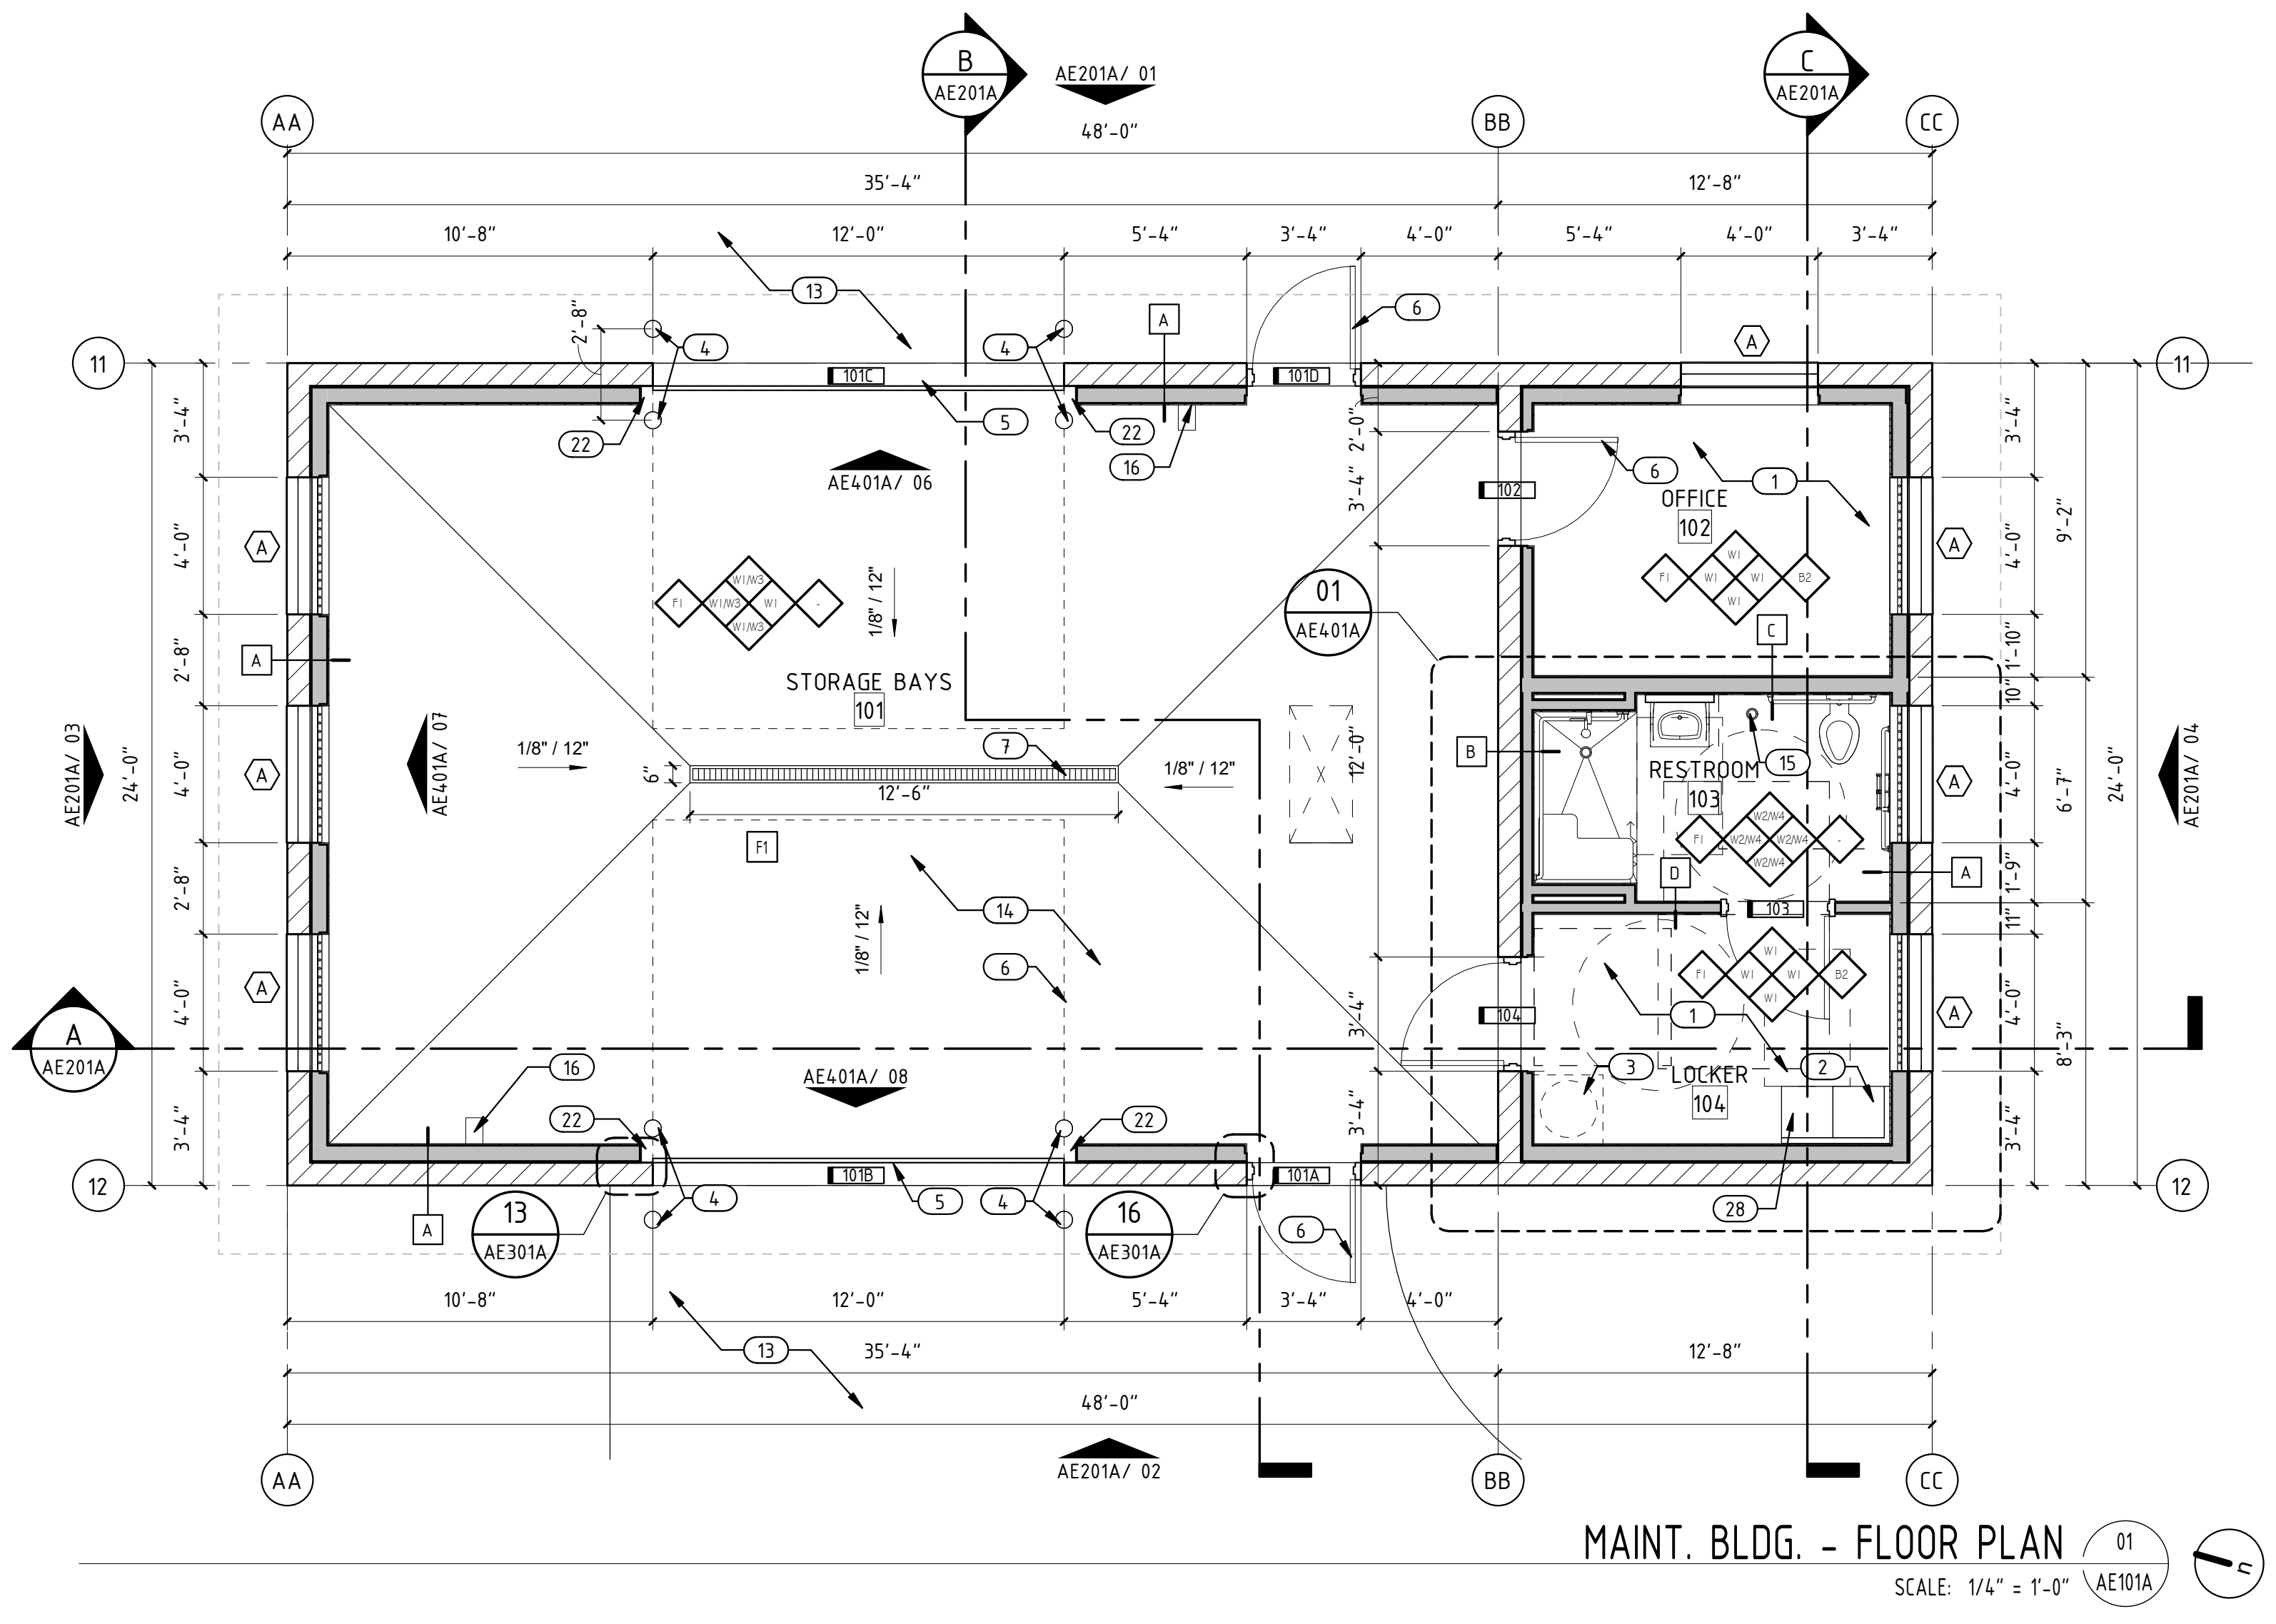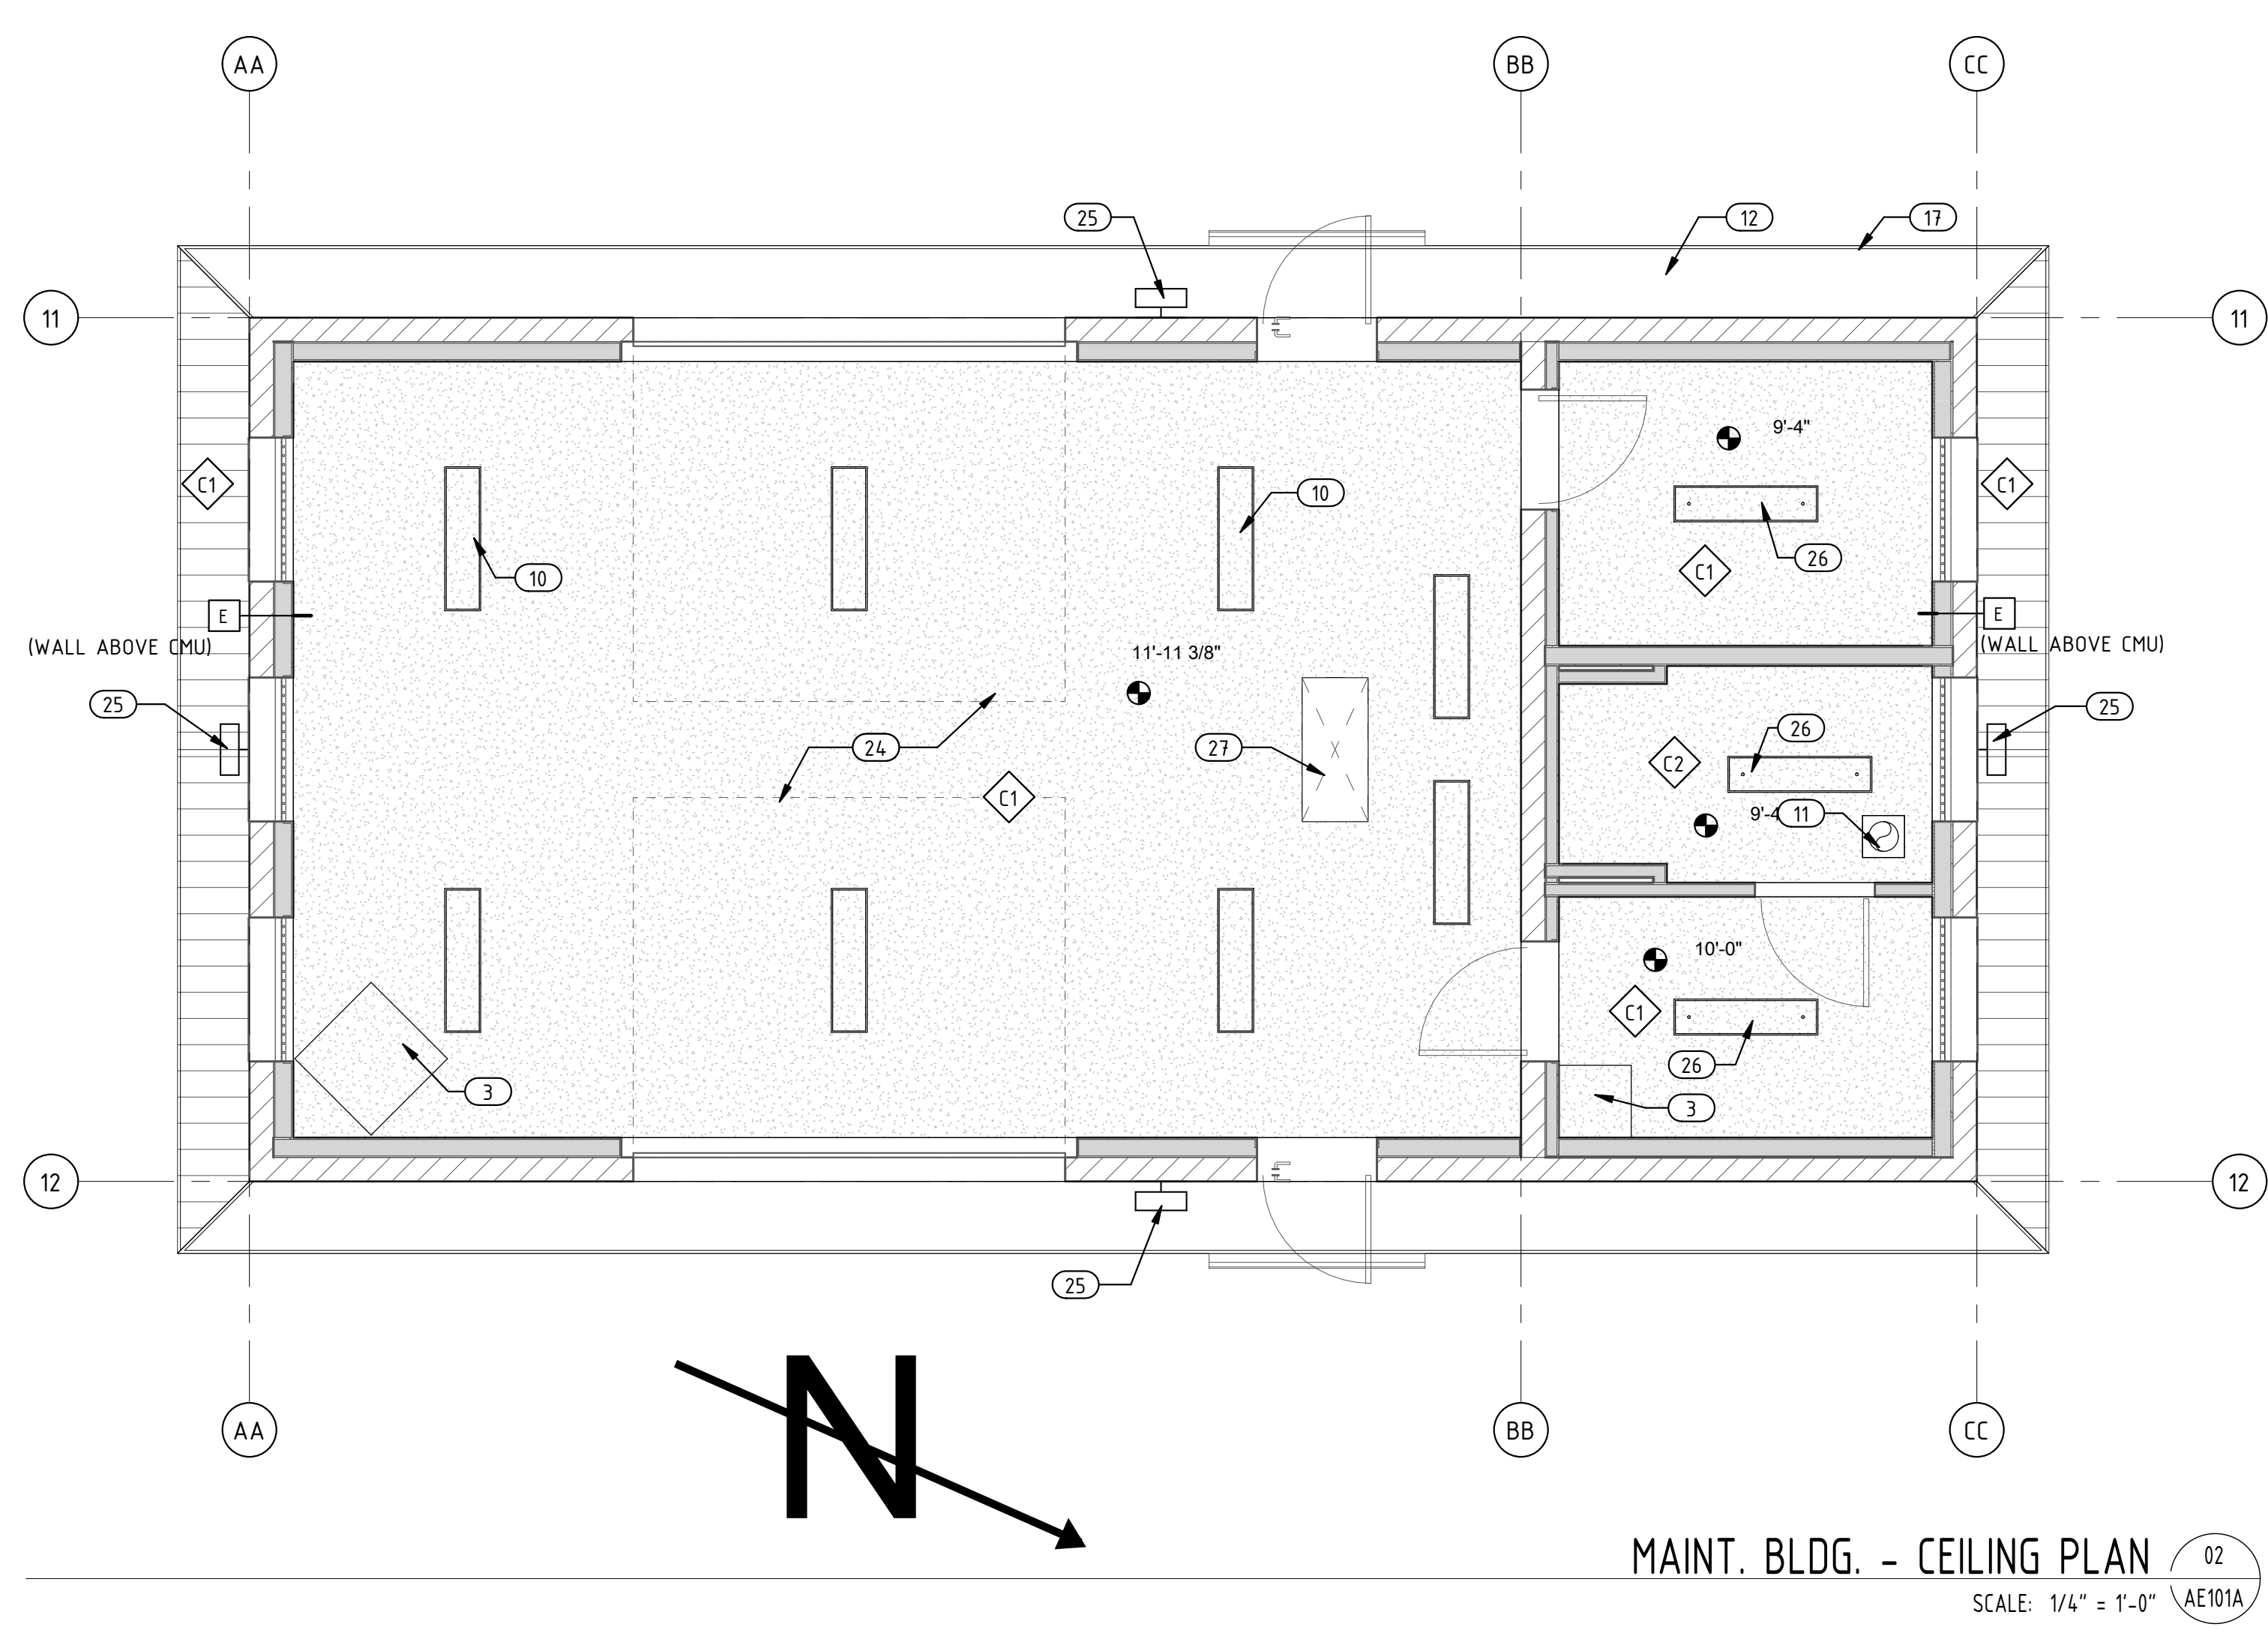

CONSTRUCTION DOCUMENTS - CONFORMED SET

PREPARED FOR:

 CONSULTANTS:

MAGNA REGIONAL PARK
 PHASE 1
 4042 SOUTH 7200 WEST
 MAGNA, UTAH 84044

REVISIONS:

▲ ASI #1	10-18-19
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SHEET TITLE:
 MAINT. BLDG. FLOOR PLANS


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DRAWN BY: CKG
CHECKED BY: DW
JOB NO.: U17-021

SHEET NO.: AE101A

G.B:D
 G. BROWN: DESIGN INC
 SITE AND LANDSCAPE ARCHITECTS
 610 East South Temple, Ste 50
 Salt Lake City, Utah 84102
 p. 801.575.6066 f. 801.575.6166
 www.gbrowndesign.com

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 BUILDING STRUCTURAL
 MECHANICAL PLUMBING
 ELECTRICAL ENERGY
 ACCESSIBILITY FIRE
 PLAN REVIEW ACCEPTANCE OF DOCUMENTS DOES NOT AUTHORIZE CONSTRUCTION TO PROCEED IN VIOLATION OF ANY FEDERAL, STATE, OR LOCAL REGULATIONS.
 BY: [Signature] DATE: 11/13/19
 WEST COAST CODE CONSULTANTS, INC.

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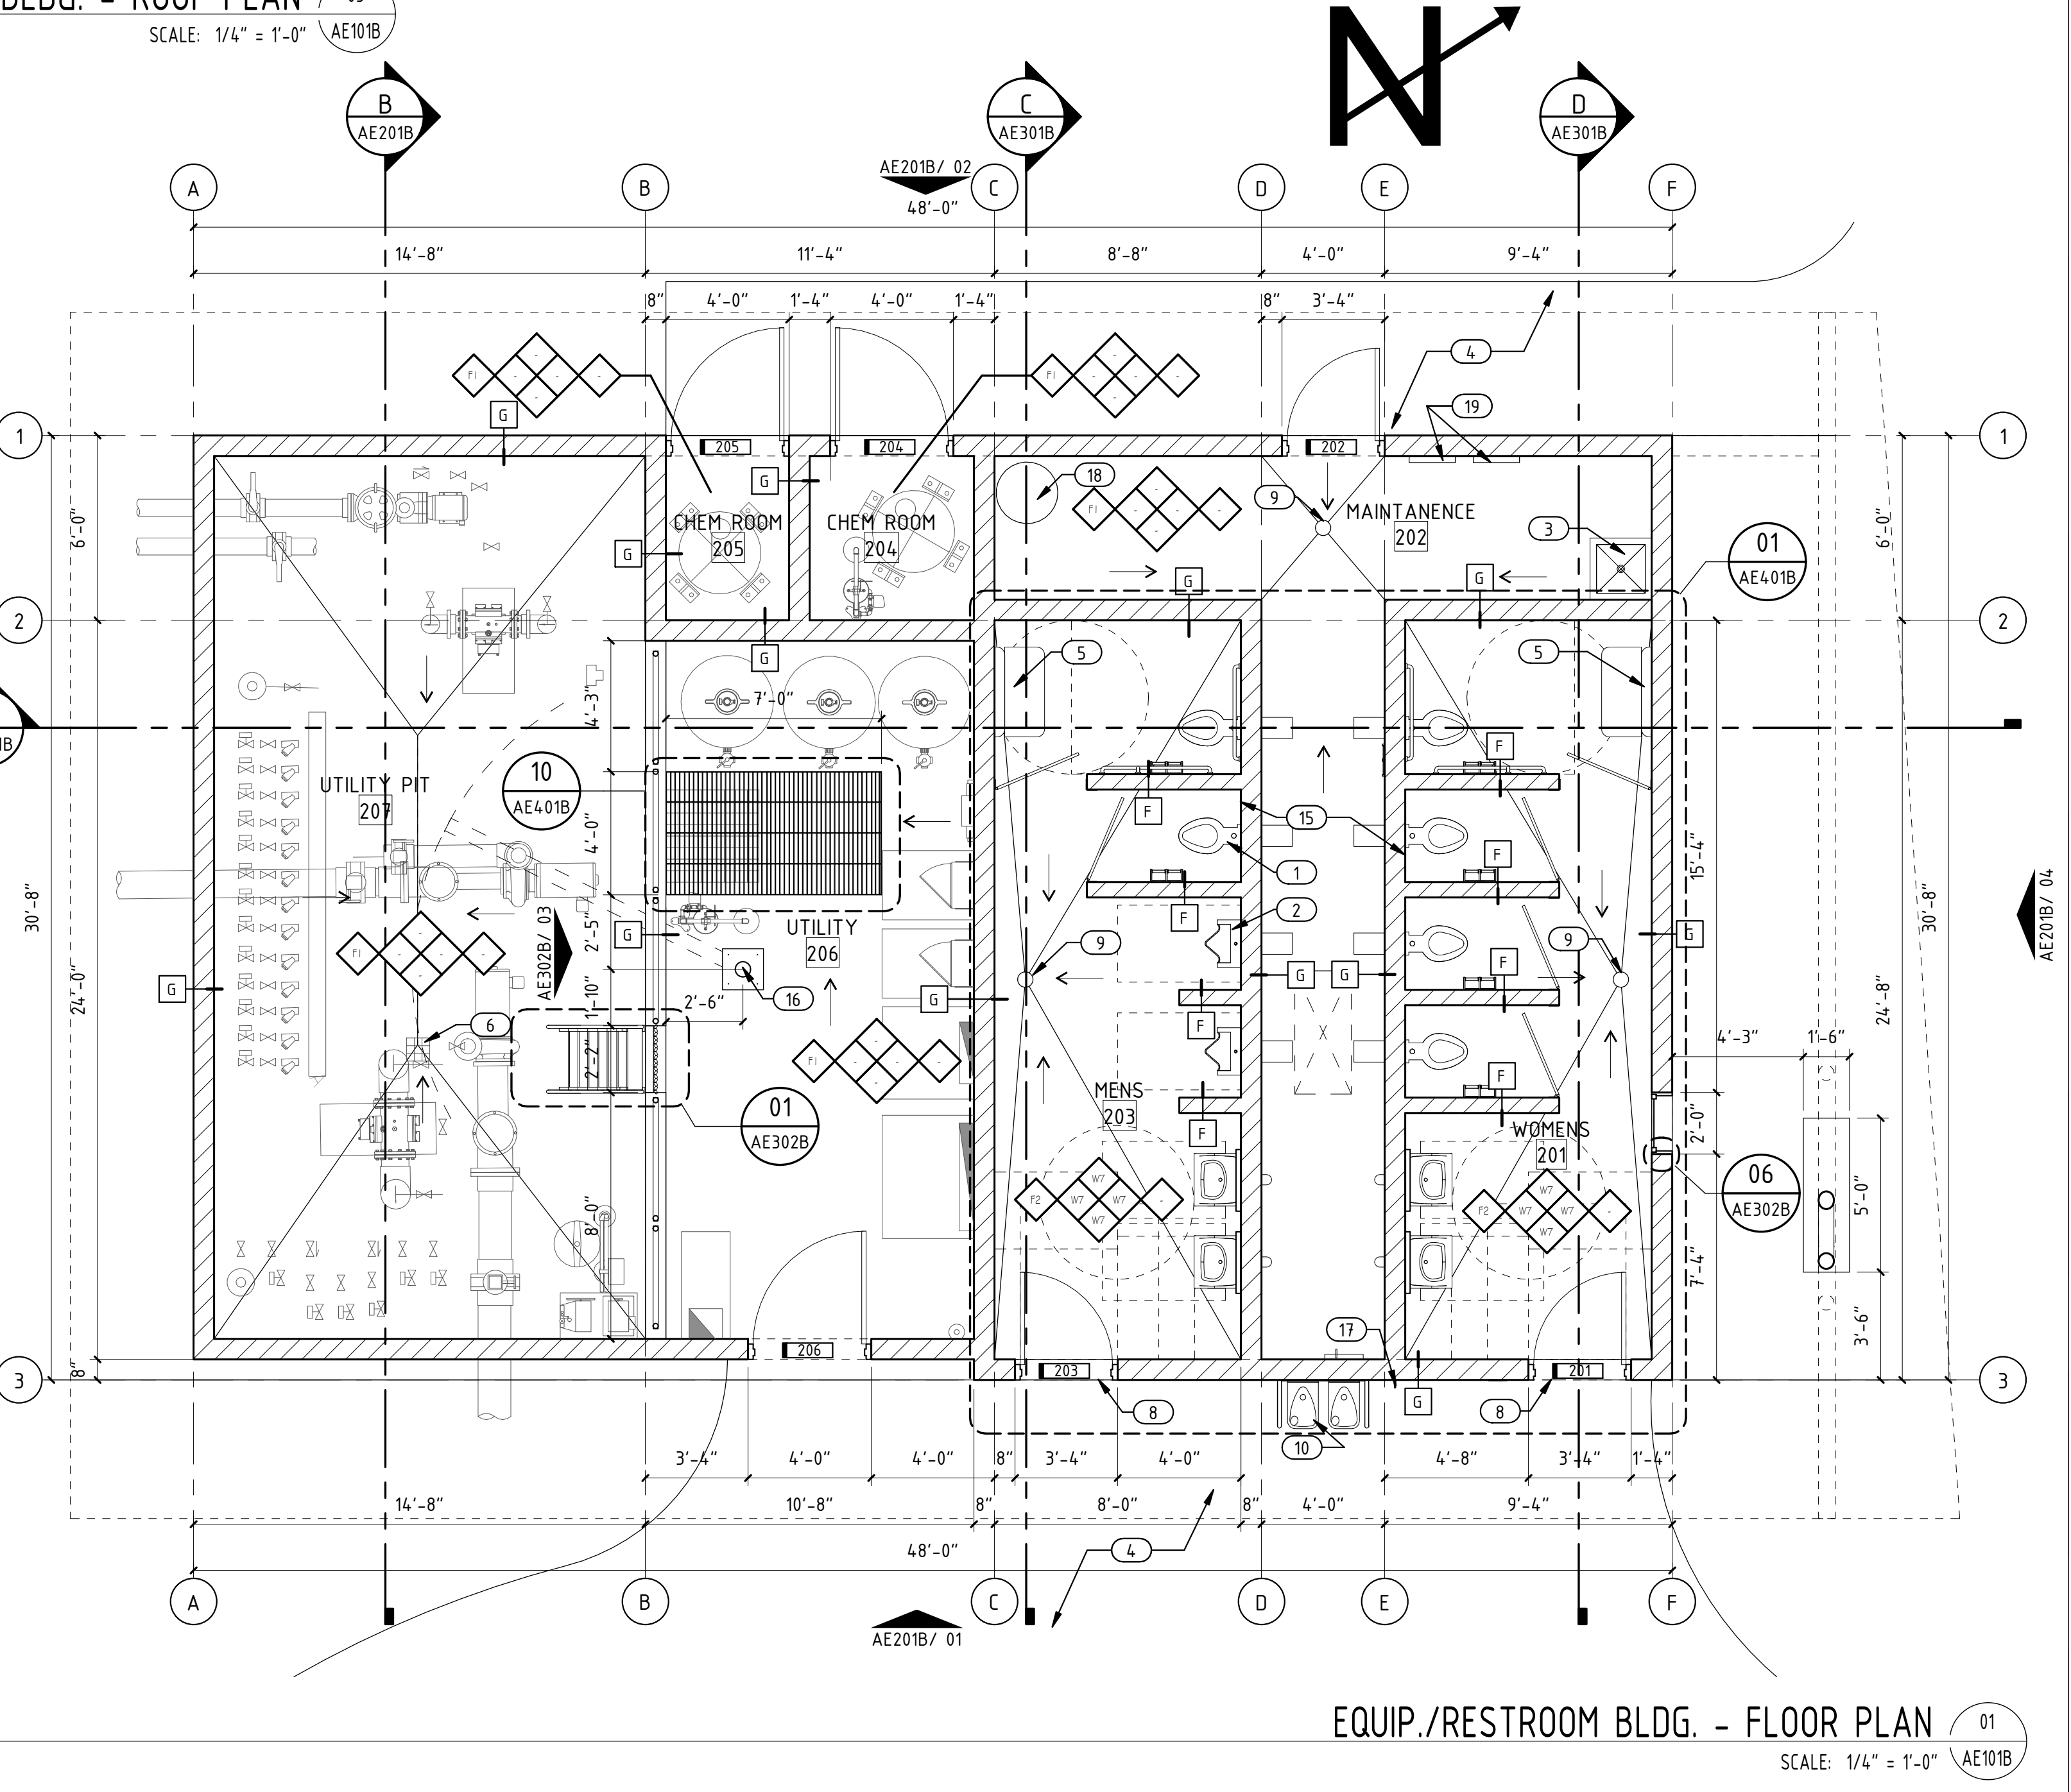
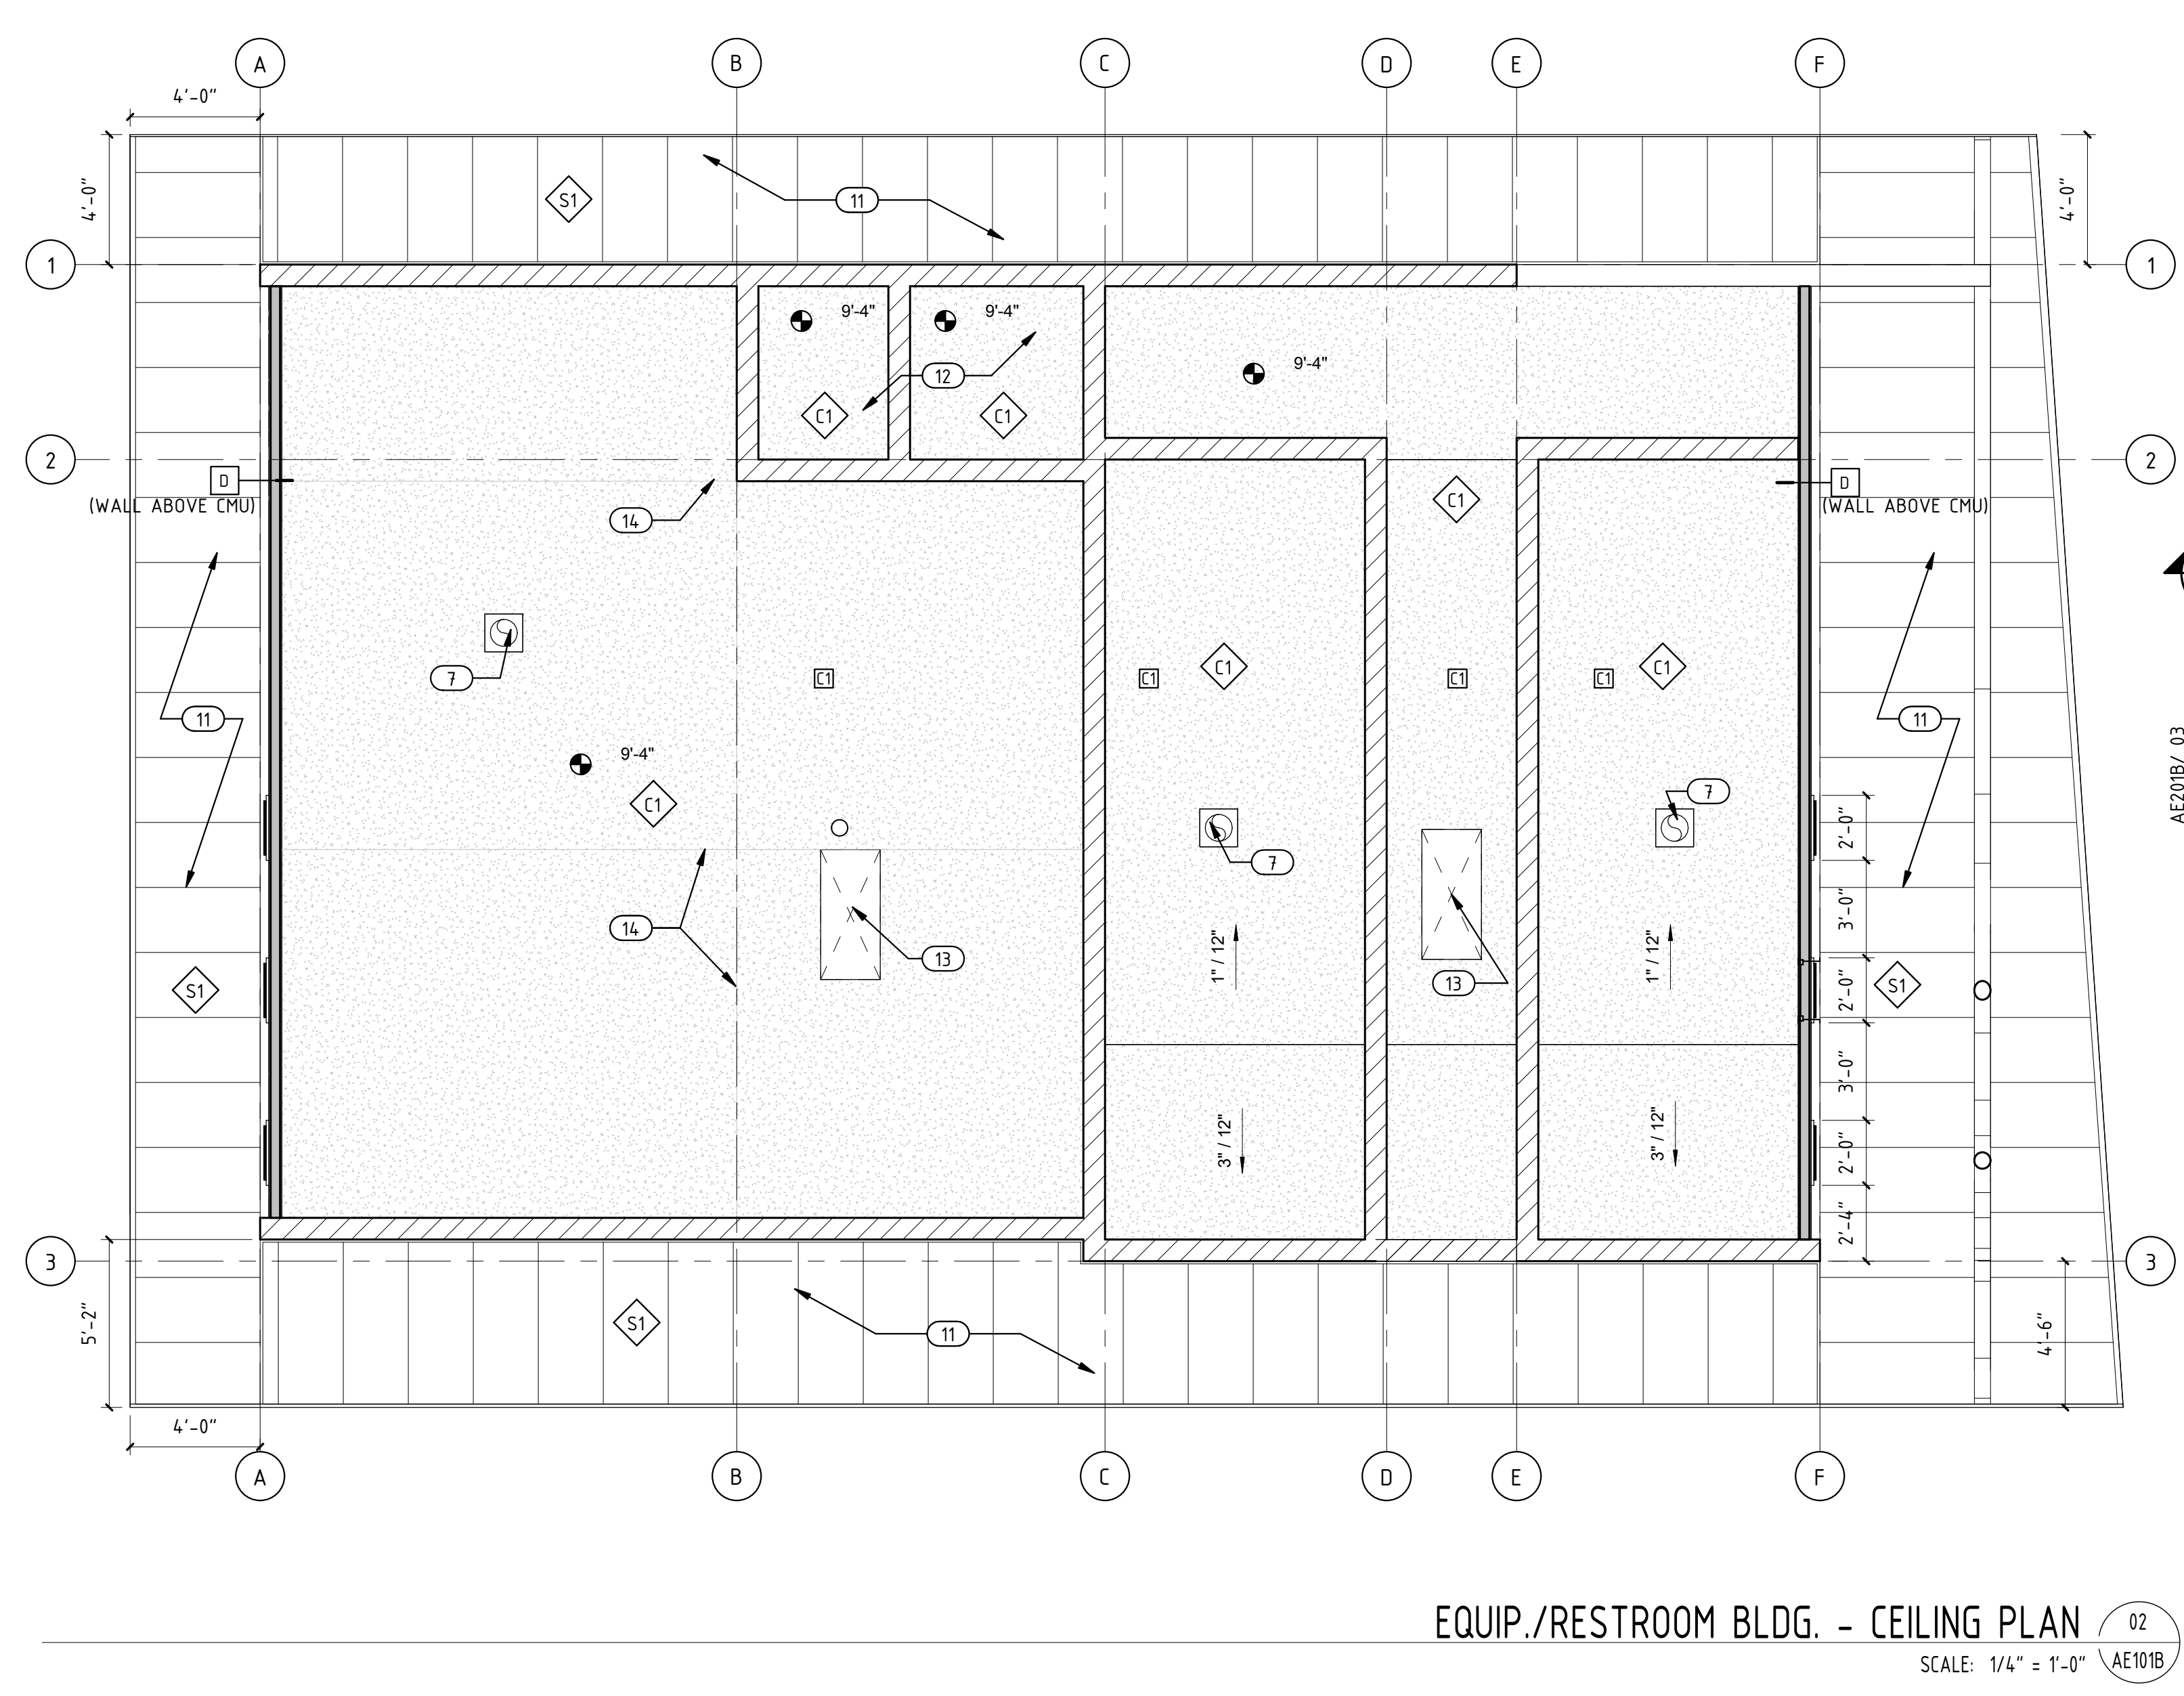
EQUIP./RESTROOM - ATTIC VENT CALCS:

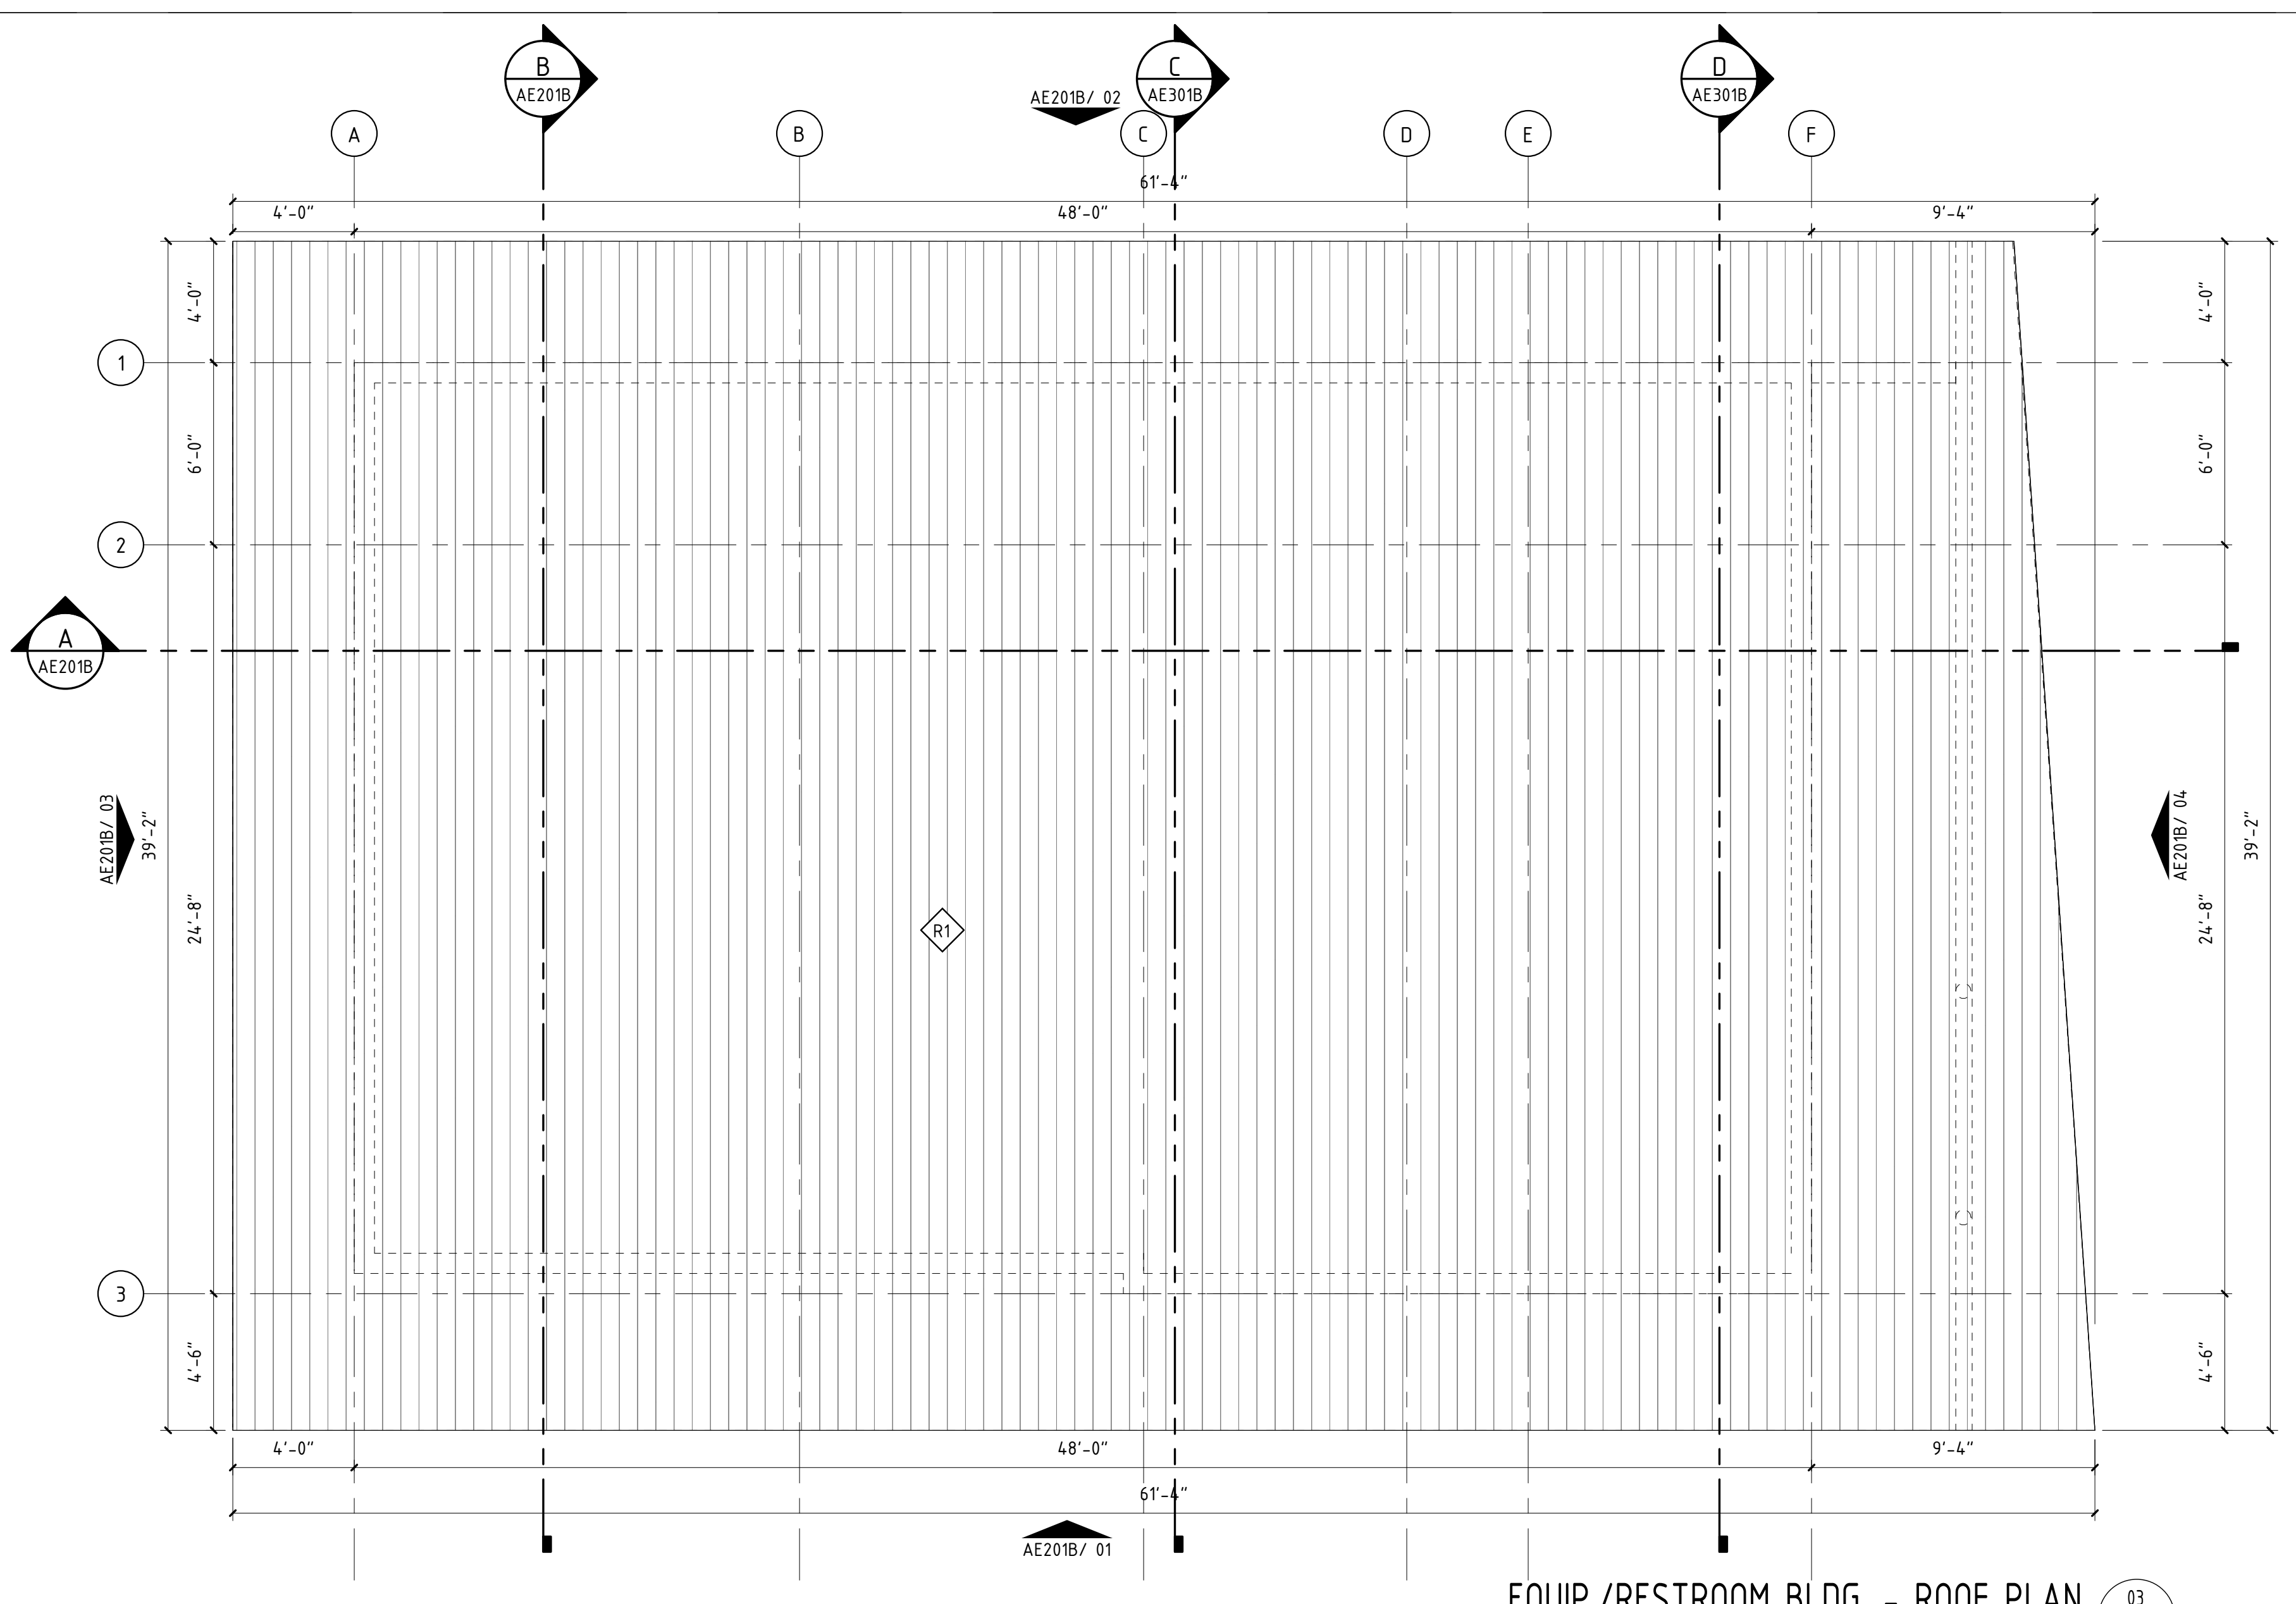- * ATTIC CALCULATION: 1/150 S.F. RULE
 VENTILATED ATTIC AREA= 1,352 SF
- * VENTILATION REQUIRED: 1,352/150= 9.01 SF
 GABLE VENTILATION REQ.= 4.51 SF
 EAVE VENTILATION REQ.= 4.51 SF
- * GABLE VENT OPTION
 24" X 14" VENT (.97 SF)
 6 X .89 SF= 5.34 SF
- * EAVE VENT (24.8 S.I. PER 1.0 LF):
 31 L.F. X 24.8 S.I. (.172 SF)= 5.33 SF
- * TOTAL VENTILATION= 10.37 SF

GENERAL NOTES AND LEGEND:

- SEE SHEET AE001 FOR GENERAL NOTES.
- SEE TITLE SHEET FOR DRAWING INDEX.
- DO NOT SCALE DRAWINGS.
- CONTRACTOR / SUBCONTRACTOR SHALL VERIFY ALL DIMENSIONS AND CONDITIONS BEFORE BEGINNING WORK, AND SHALL REPORT TO THE ARCHITECT ANY ERRORS, INCONSISTENCIES OR OMISSIONS BEFORE BEGINNING WORK. SEE GENERAL NOTES AND SPECIFICATIONS.

- KEYED NOTES:**
- WALL HUNG TOILET. SEE PLUMBING DRAWINGS.
 - WALL HUNG URINAL. SEE PLUMBING DRAWINGS.
 - HOP SINK W/ 48" X 48" FRP PANEL. STAINLESS STEEL HOP RACK & SHELF ABOVE. SEE PLUMBING DRAWINGS.
 - CONCRETE PAVING. PROVIDE EXPANSION JOINT AT FOUNDATION WALLS. TYP. SEE CIVIL DRAWINGS IN APPROVED PARK DRAWINGS.
 - CHANGING TABLE. TO BE MOUNTED 48" MAX ABOVE F.F. TO ALSO BE ACCORDANCE WITH SECTIONS 308 AND 309.3 OF ICC A117.1-09. TYP.
 - 18"X18"X24" SLUMP W/ DRAIN WITH 1"X1" RECESSED AT PERIMETER FOR RECESSED GALVANIZED 1" GRATE. SEE PLUMBING DRAWINGS.
 - EXHAUST FAN. SEE MECHANICAL DRAWINGS.
 - NO THRESHOLD. TYPICAL ON BATHROOM DOORS.
 - FLOOR DRAIN. SLOPE CONC. TO DRAIN. SEE PLUMBING DRAWINGS.
 - STAINLESS STEEL DRINKING FOUNTAIN. SEE PLUMBING DRAWINGS. ALSO SEE SHEET G1003 FOR ADA MOUNTING HEIGHTS.
 - ALUMINUM SOFFIT AND ALUMINUM FASCIA.
 - AIR TIGHT CONSTRUCTION. TYP. AT CHEM ROOMS.
 - ATTIC ACCESS. SEE ACCESS. SCHED.
 - GYP. BRD. EXPANSION JOINTS.
 - THE CMU BEHIND TOILETS NEED TO BE FLUSH TO THE CONCRETE. TYP.
 - FLOOR CRANE LOCATION. SEE STRUCTURAL AND ACCESSORIES SCHEDULE.
 - REMOVABLE KEY HOSE BIB A RECESS BOX. SEE PLUMBING.
 - EXPANSION TANK. SEE PLUMBING PLANS.
 - IRRIGATION CONTROLS. SEE ELECTRICAL PLANS.




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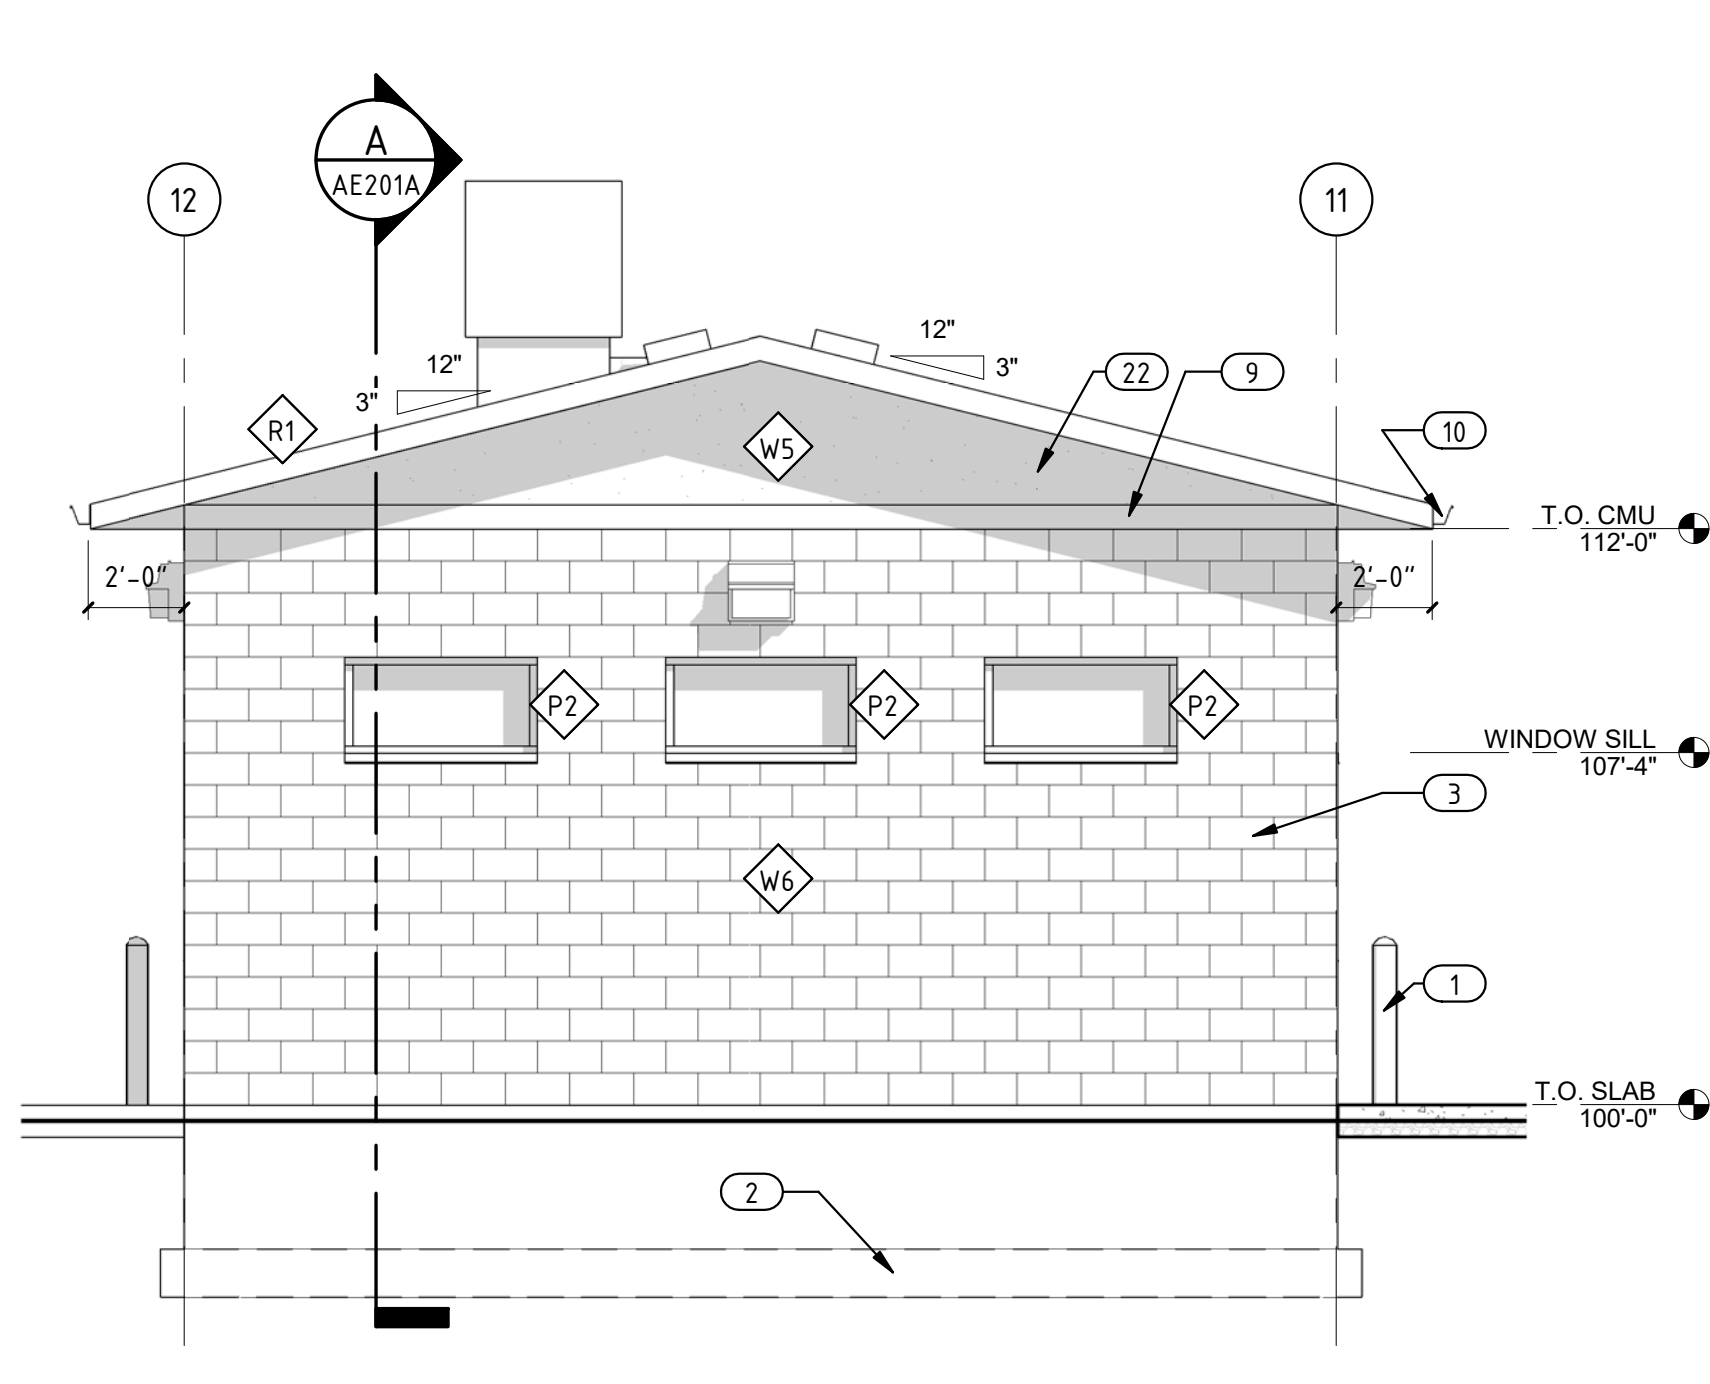


SHEET TITLE:
 EQUIP./RESTROOM BLDG.
 PLANS


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SHEET NO:
 AE101B


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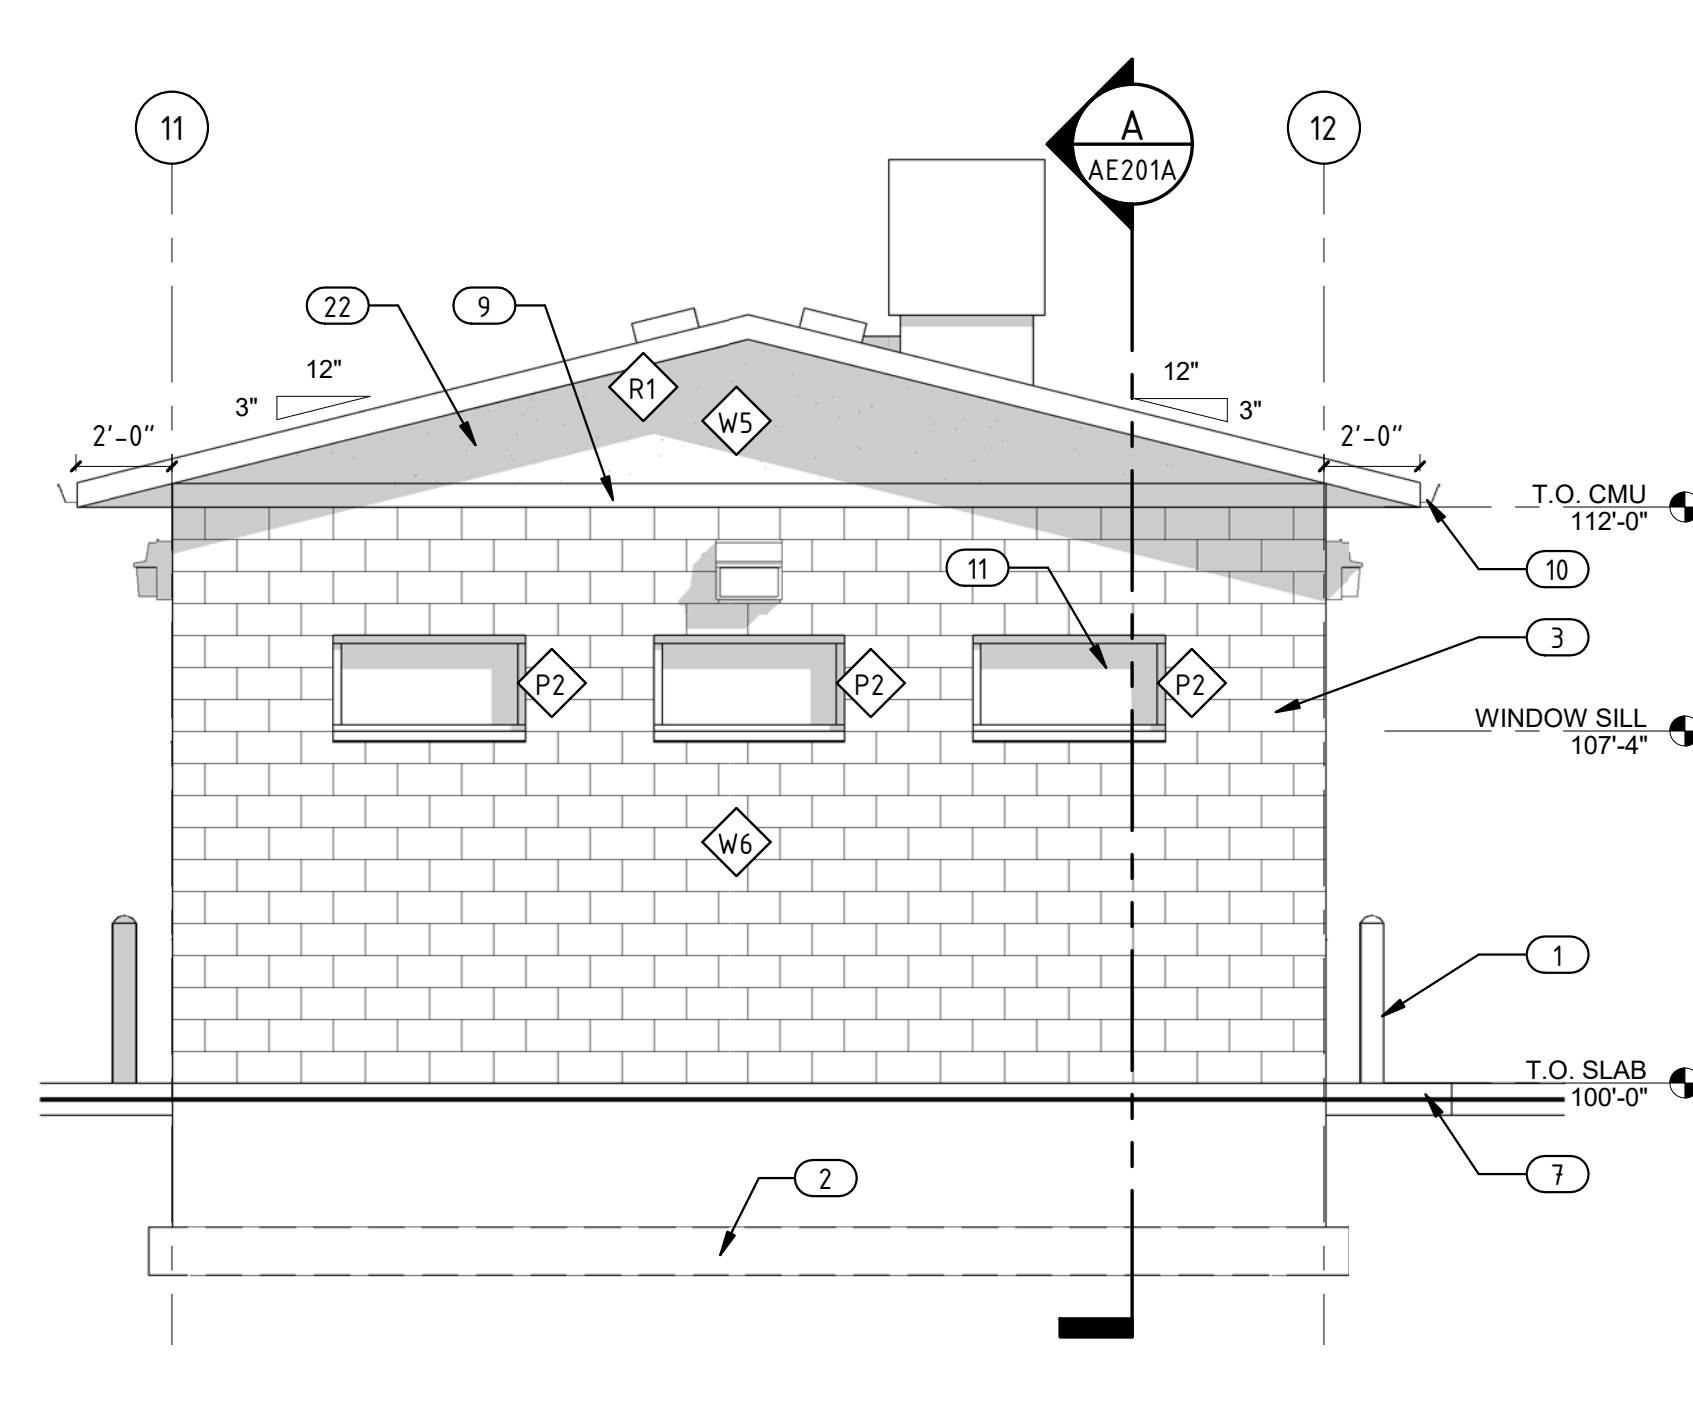
MAINT. BLDG. - ELEVATION 03
 SCALE: 1/4" = 1'-0"
 AE201A

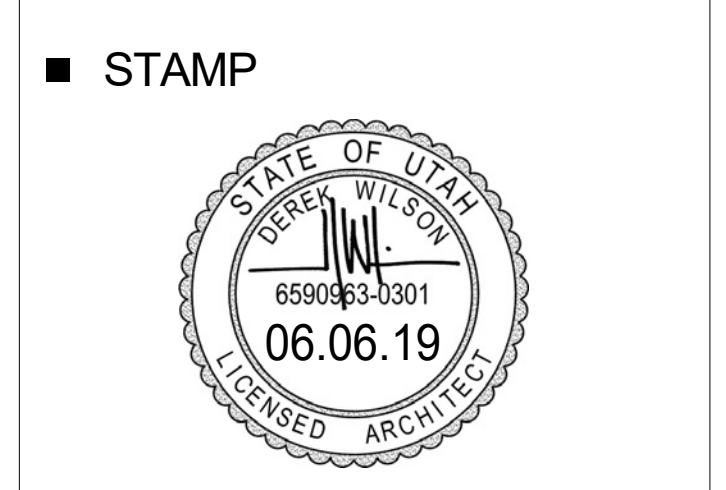

MAINT. BLDG. - ELEVATION 02
 SCALE: 1/4" = 1'-0"
 AE201A

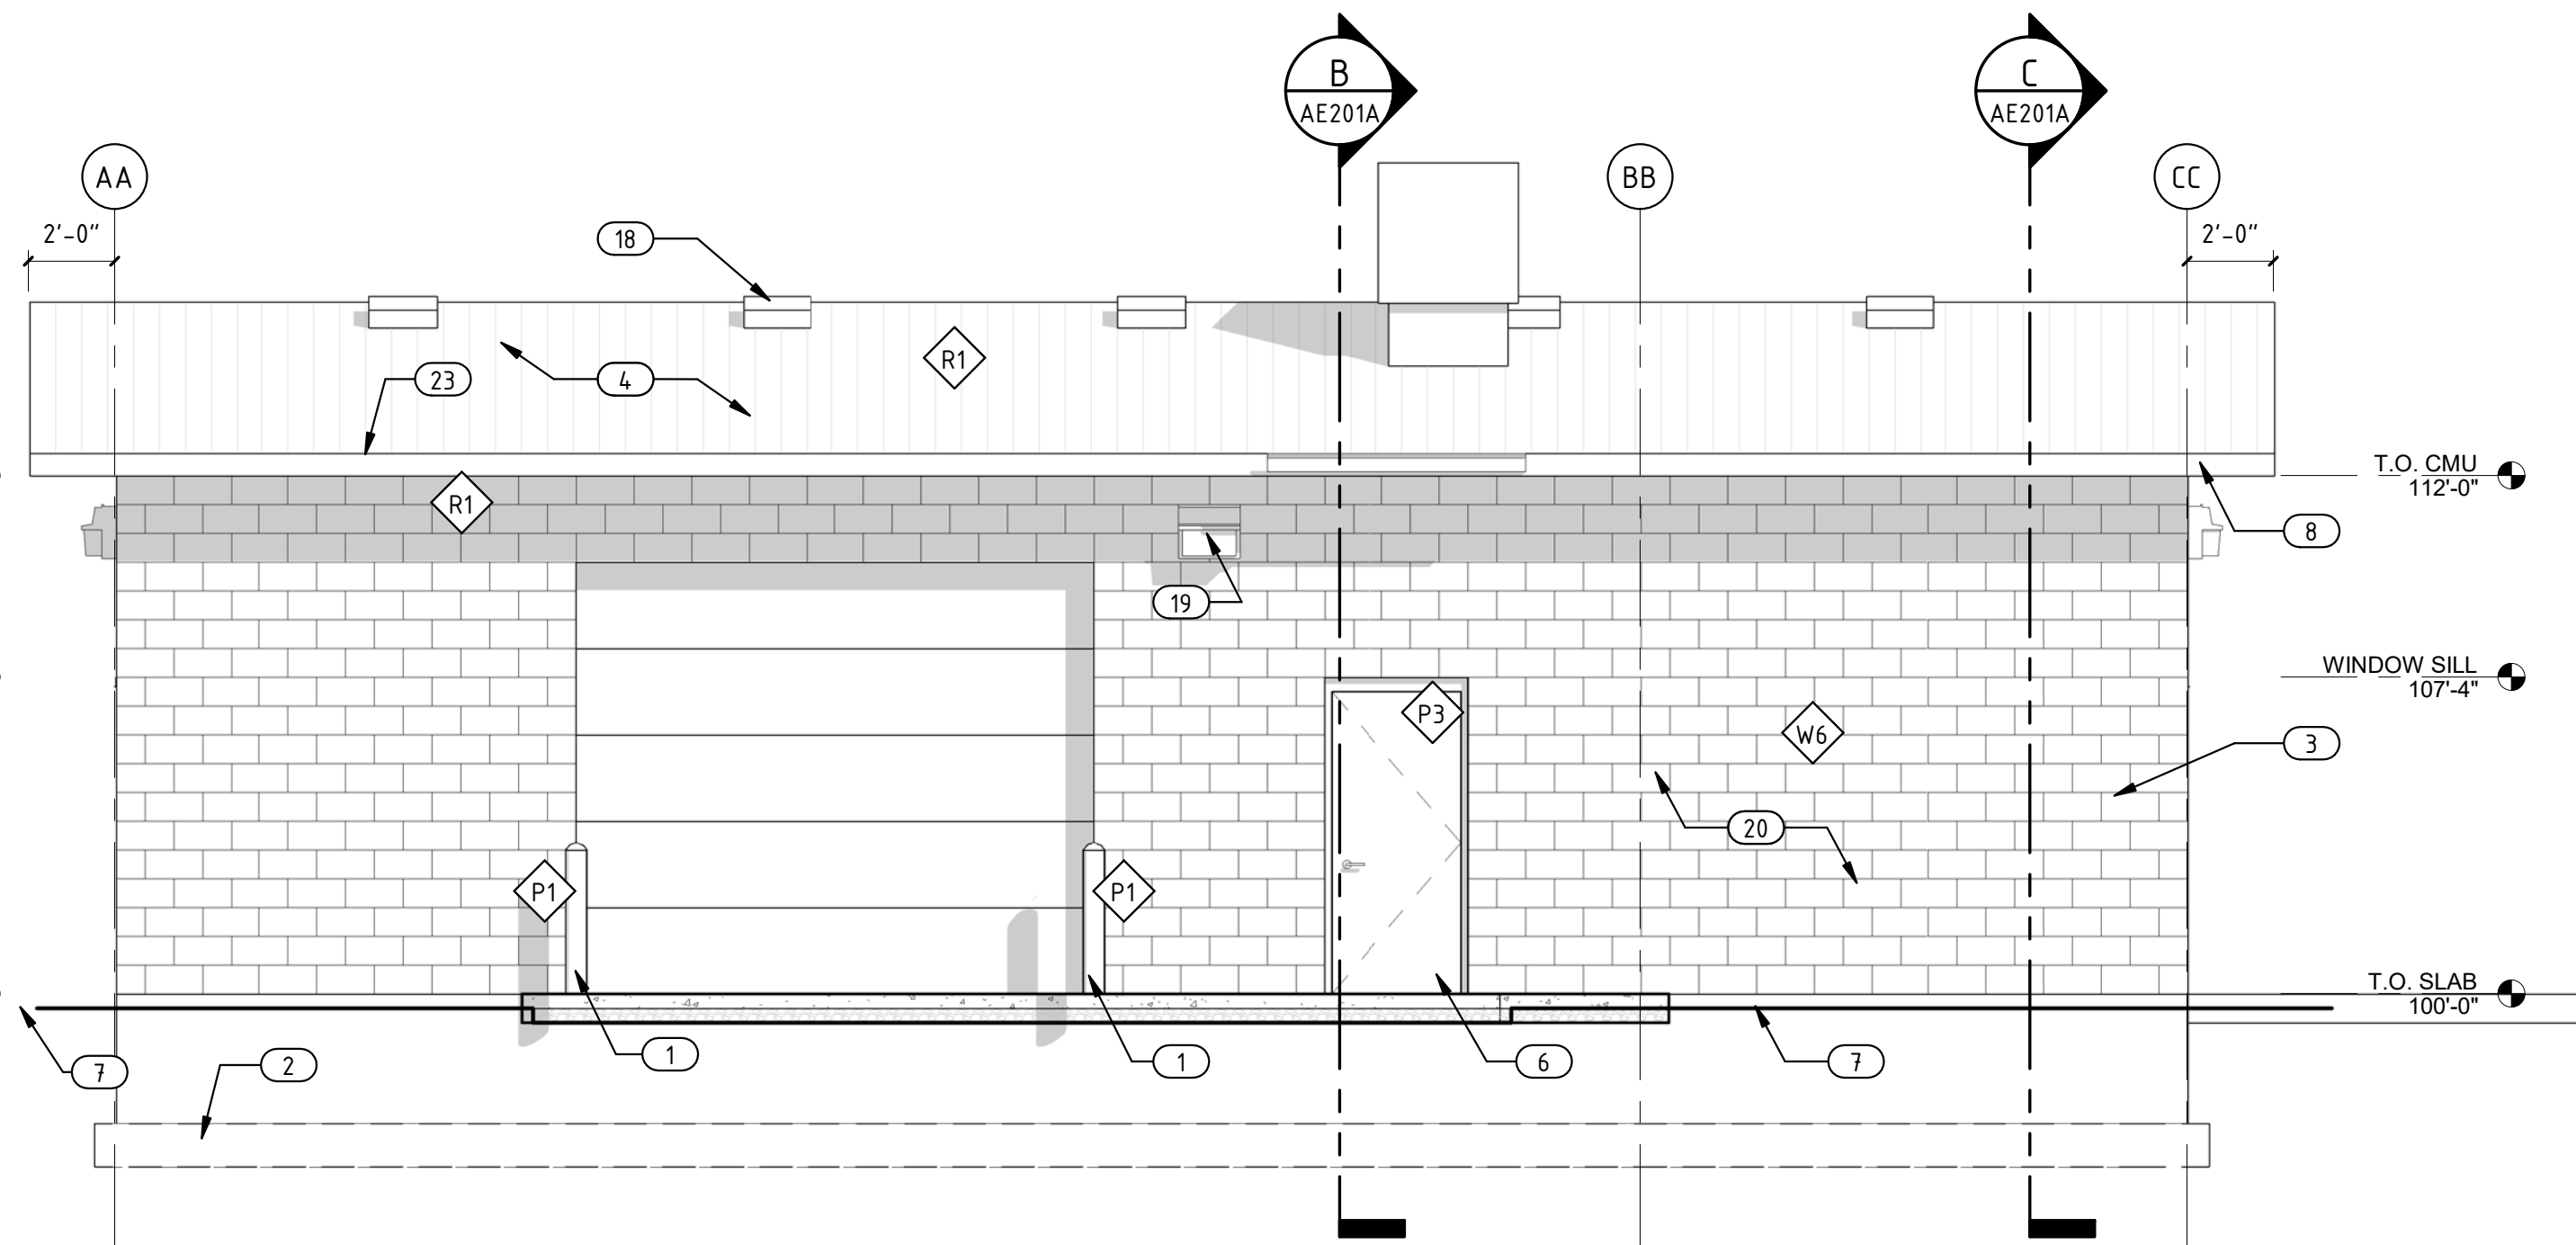

MAINT. BLDG. - ELEVATION 01
 SCALE: 1/4" = 1'-0"
 AE201A

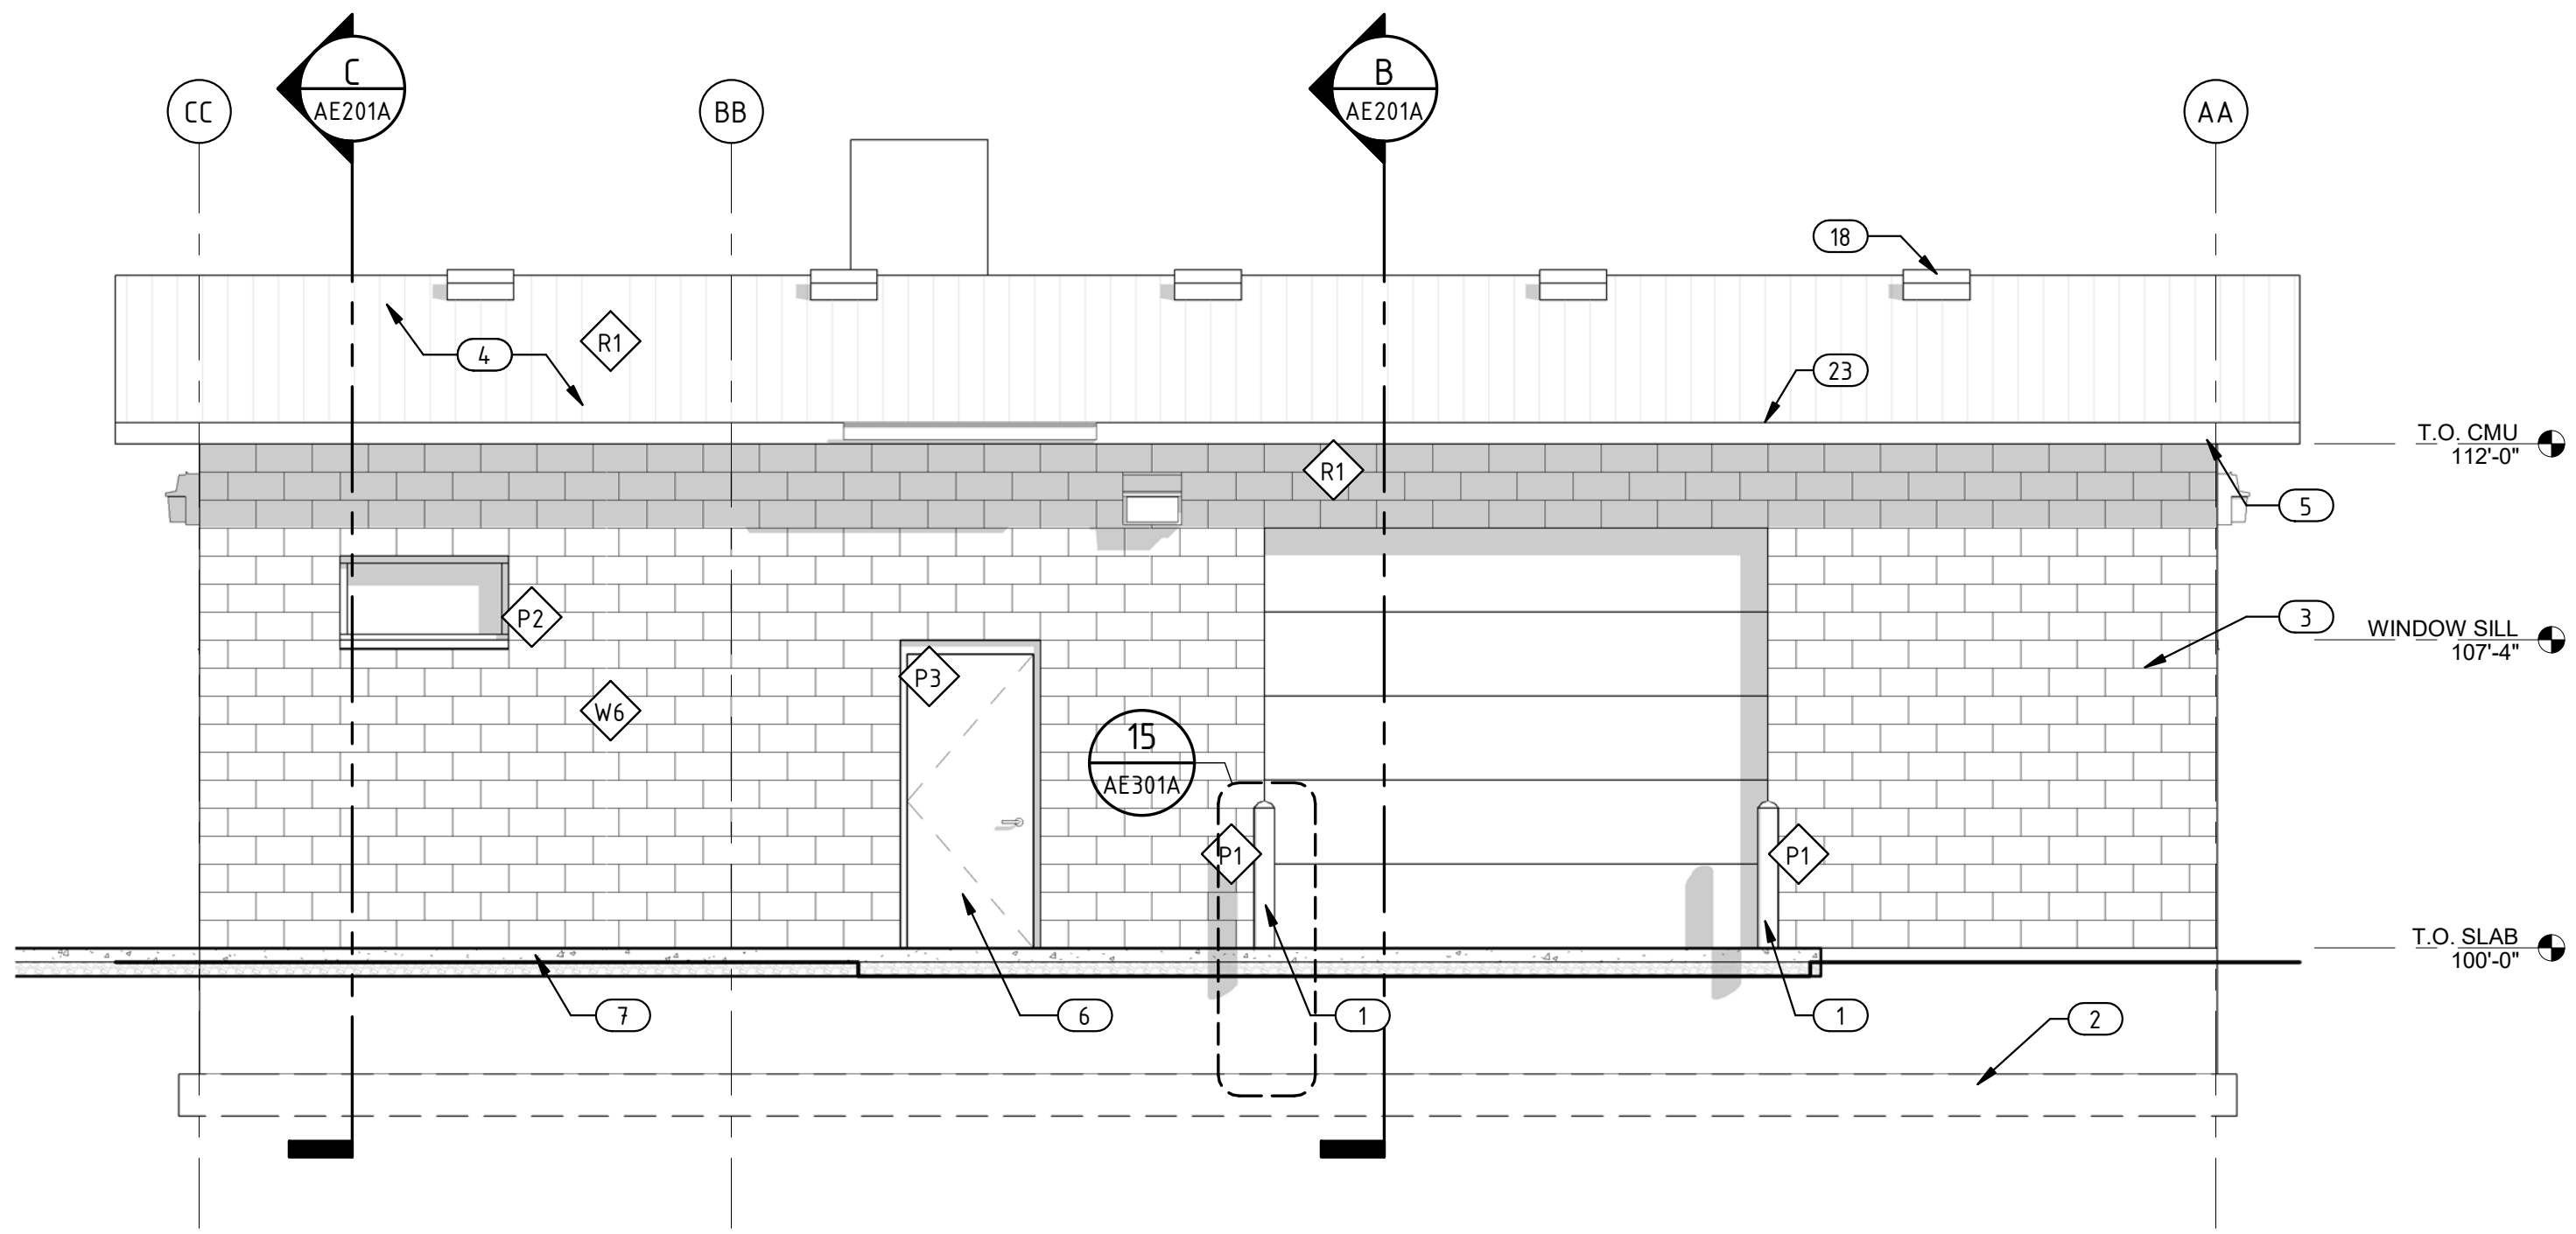

MAINT. BLDG. - ELEVATION 04
 SCALE: 1/4" = 1'-0"
 AE201A


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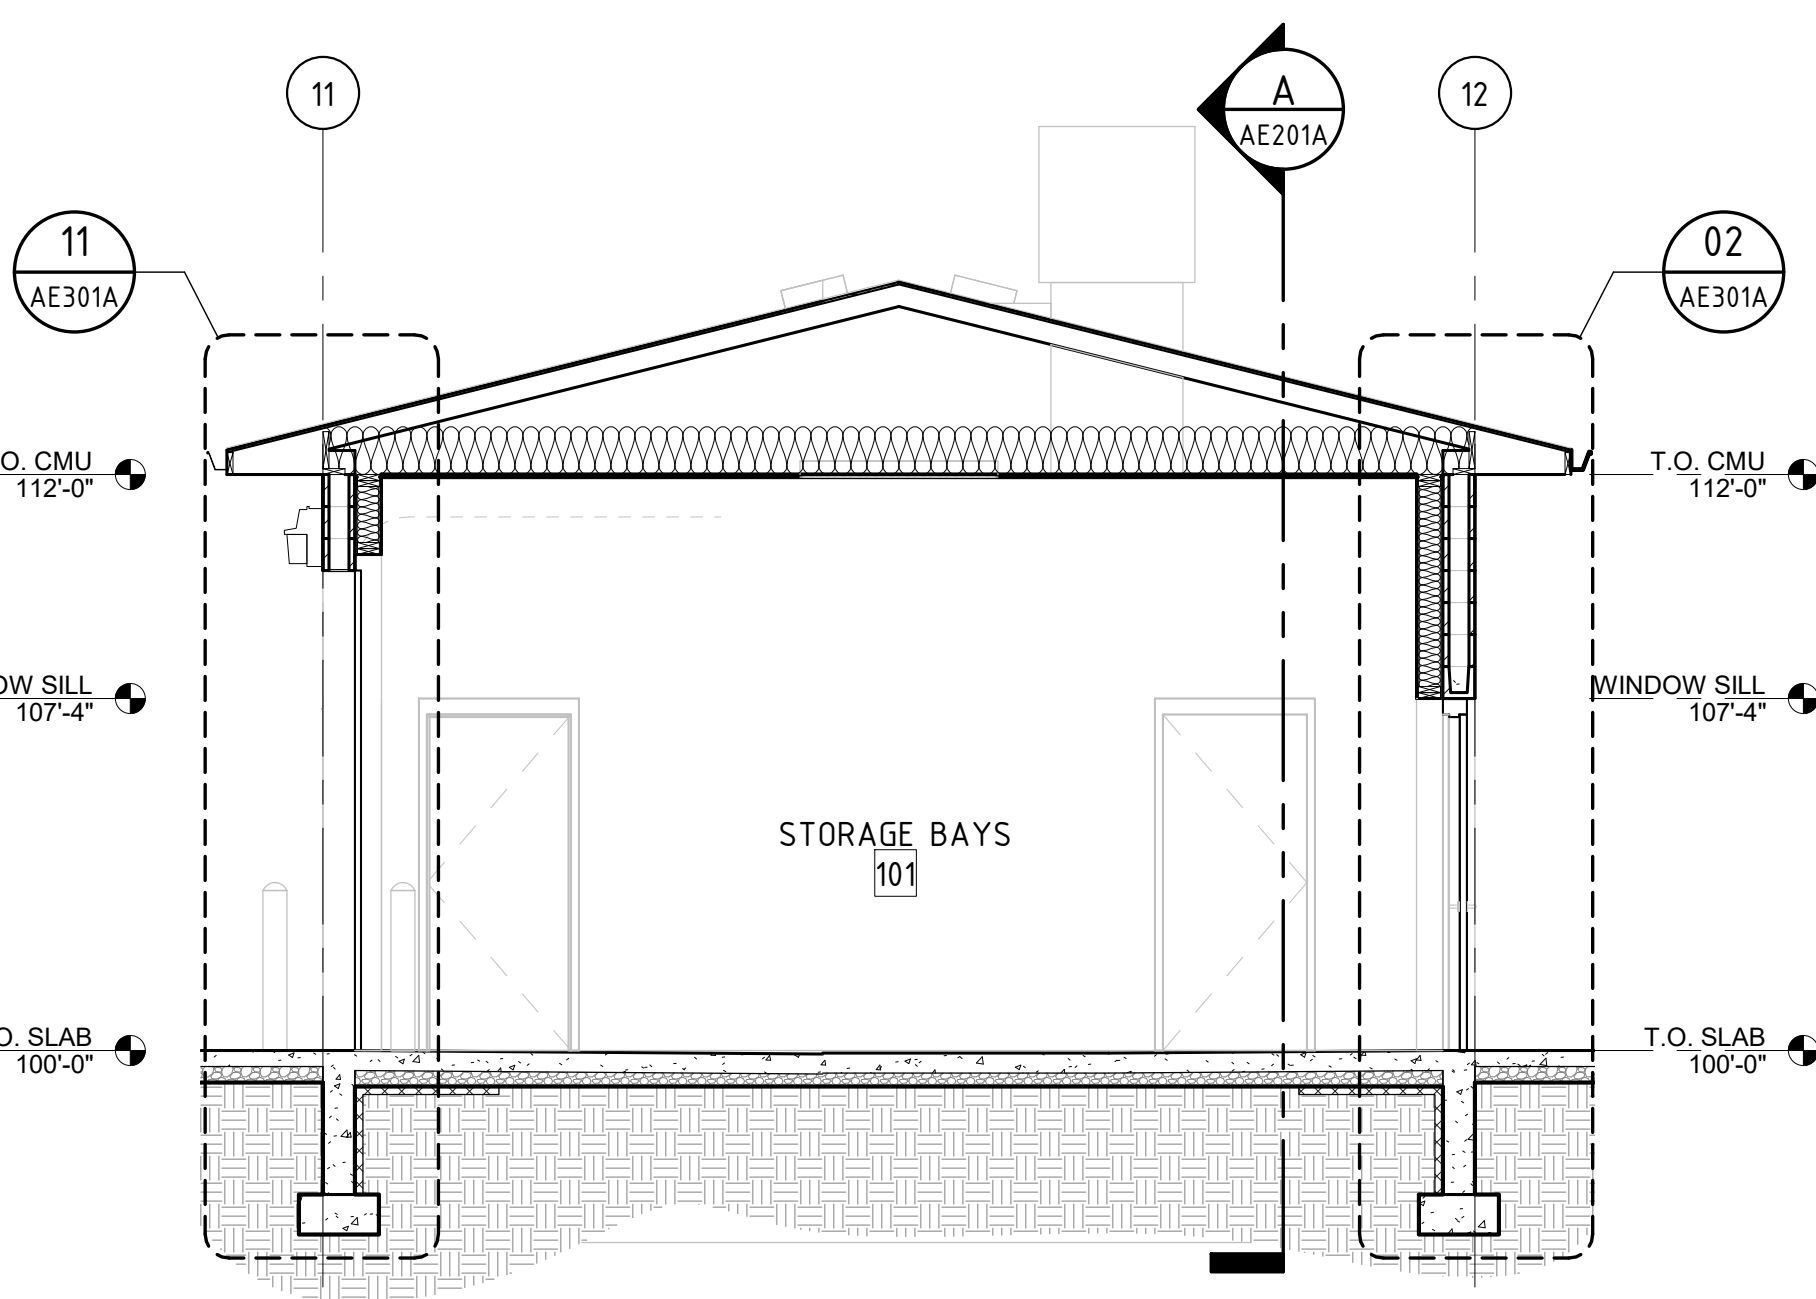
KEYED NOTES:

- 6" DIA. STEEL PIPE BOLLARD, SEE DETAILS.
- STRUCTURAL FOUNDATION AND FOOTING, SEE STRUCTURAL.
- SCHEDULED WALL TYPE, PAINTED & ANTI GRAFFITI SEALER.
- PRE-FINISHED STANDING SEAM METAL ROOFING OVER FULL ICE & WATER SHIELD, TYPICAL AT STANDING SEAM ROOF.
- ALUMINUM SOFFIT AND ALUMINUM FASCIA.
- DOOR, SEE DOOR SCHEDULE ON AE601.
- CONCRETE PAVING, SEE CIVIL DRAWINGS.
- PRE-FINISHED METAL WRAP FASCIA - MATCH ROOF COLOR.
- 6" TRIM TO MATCH STUCCO.
- PREFINISHED ALUMINUM GUTTER, NO DOWNSPOUT.
- WINDOW, SEE WINDOW SCHEDULE.
- PREFABRICATED WOOD TRUSSES, PROVIDE 2X6 TOP CHORD, SEE STRUCTURAL DRAWINGS.
- R-42 BATT INSULATION OVER CONTINUOUS VAPOR RETARDER, TYP. IN CEILING.
- 4" CONCRETE SLAB ON VAPOR BARRIER ON 4" BASE COURSE, SCHEDULED CEILING FINISH, REFER TO FINISH SCHEDULE.
- R-21 BATT INSULATION, TYP. IN EXTERIOR WALLS.
- CIP FOOTING AND FOUNDATION WALL W/ DAMPROOFING, SEE STRUCTURAL FOR DESIGN AND DEPTH, TYP.
- ROOF VENT - 50 SQ. INCHES OF NET FREE AIR, INSTALL BETWEEN ROOFING RIBS AND TRUSSES.
- WALL MOUNTED LIGHT, SEE ELECTRICAL.
- OVERHEAD DOOR, SEE DOOR SCHEDULE.
- 2" EPS INSULATION.
- HARD COATED STUCCO, SEE FINISH SCHEDULE.
- NEOPRENE METAL ROOFING INSERTS AT ROOF VOID, TYP.


FOOTING EXCAVATIONS SHALL BE INSPECTED AND APPROVED IN WRITING BY A QUALIFIED GEOTECHNICAL ENGINEER PRIOR TO CONCRETE PLACEMENT
 Reviewed by: Greg Baptist Date 11/21/2019



SECTION C
 SCALE: 1/4" = 1'-0"
 AE201A

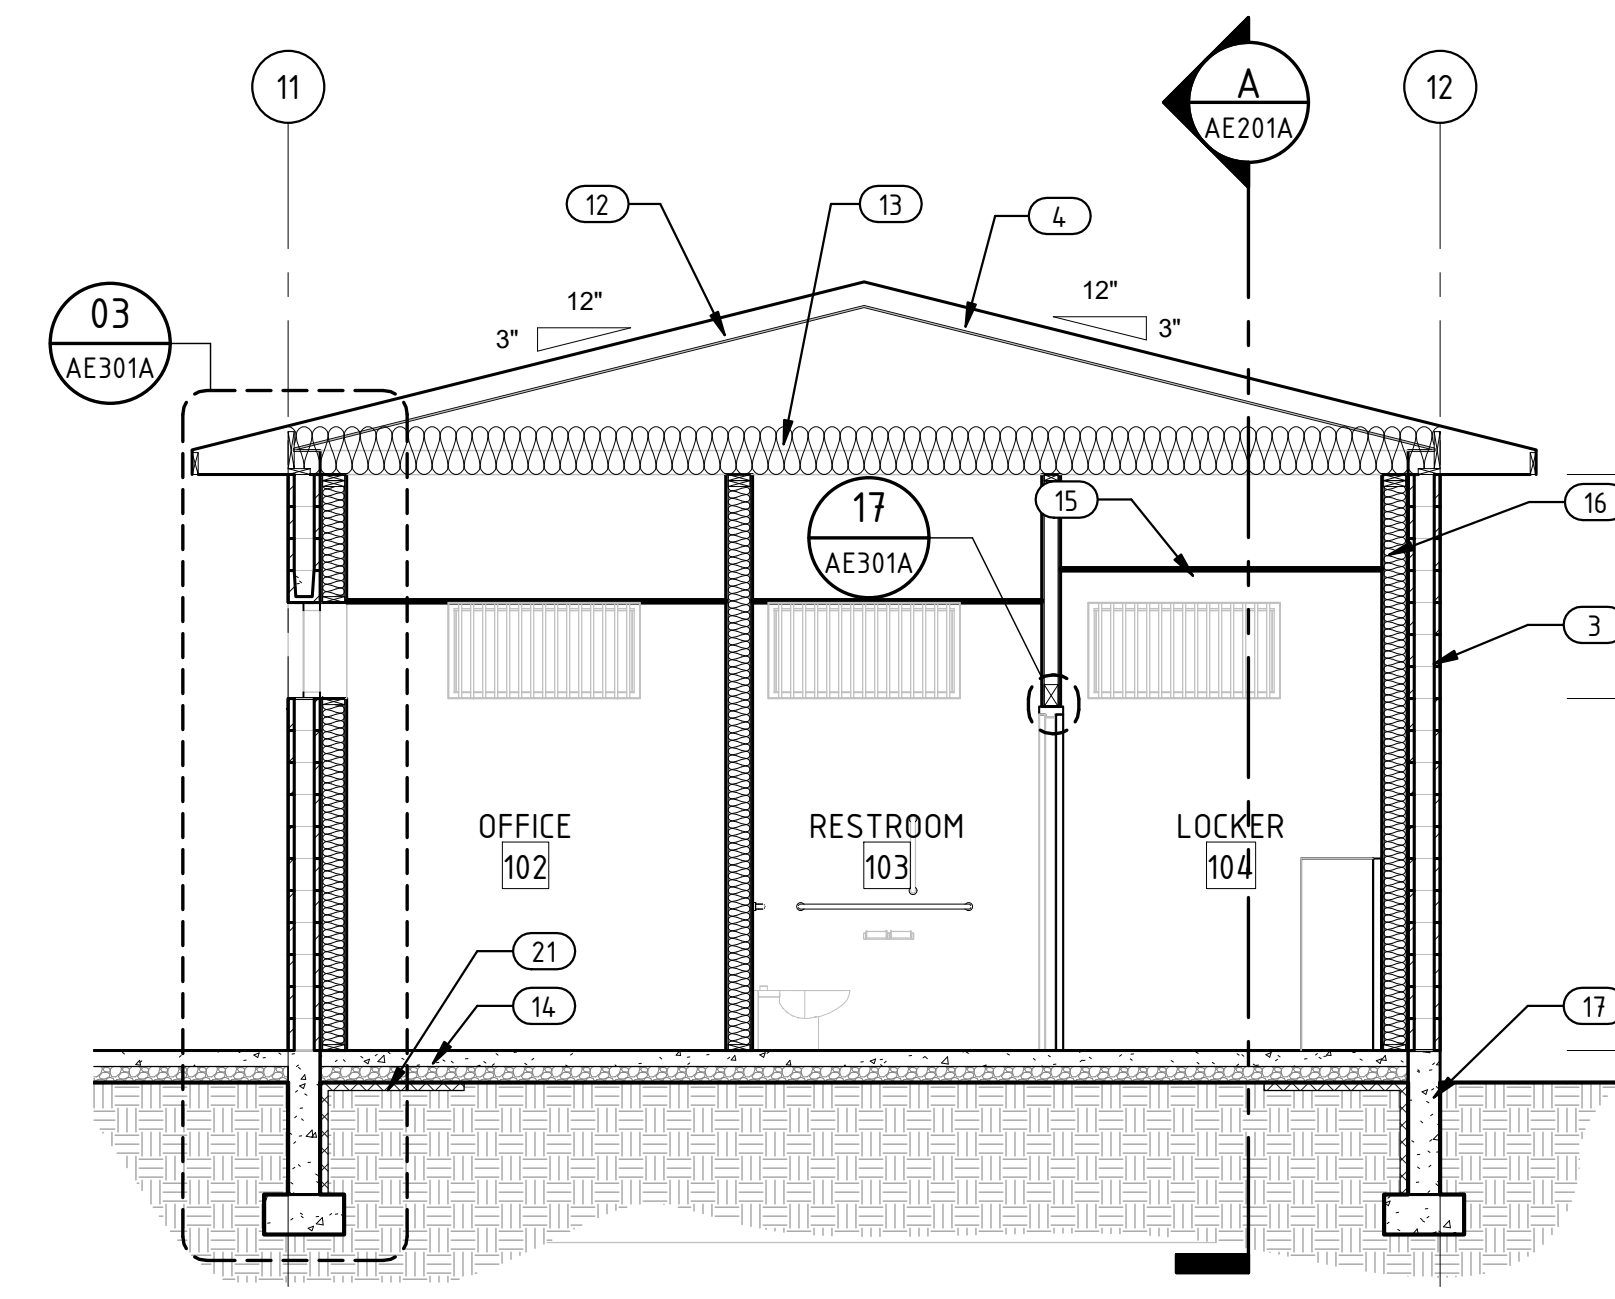

SECTION B
 SCALE: 1/4" = 1'-0"
 AE201A

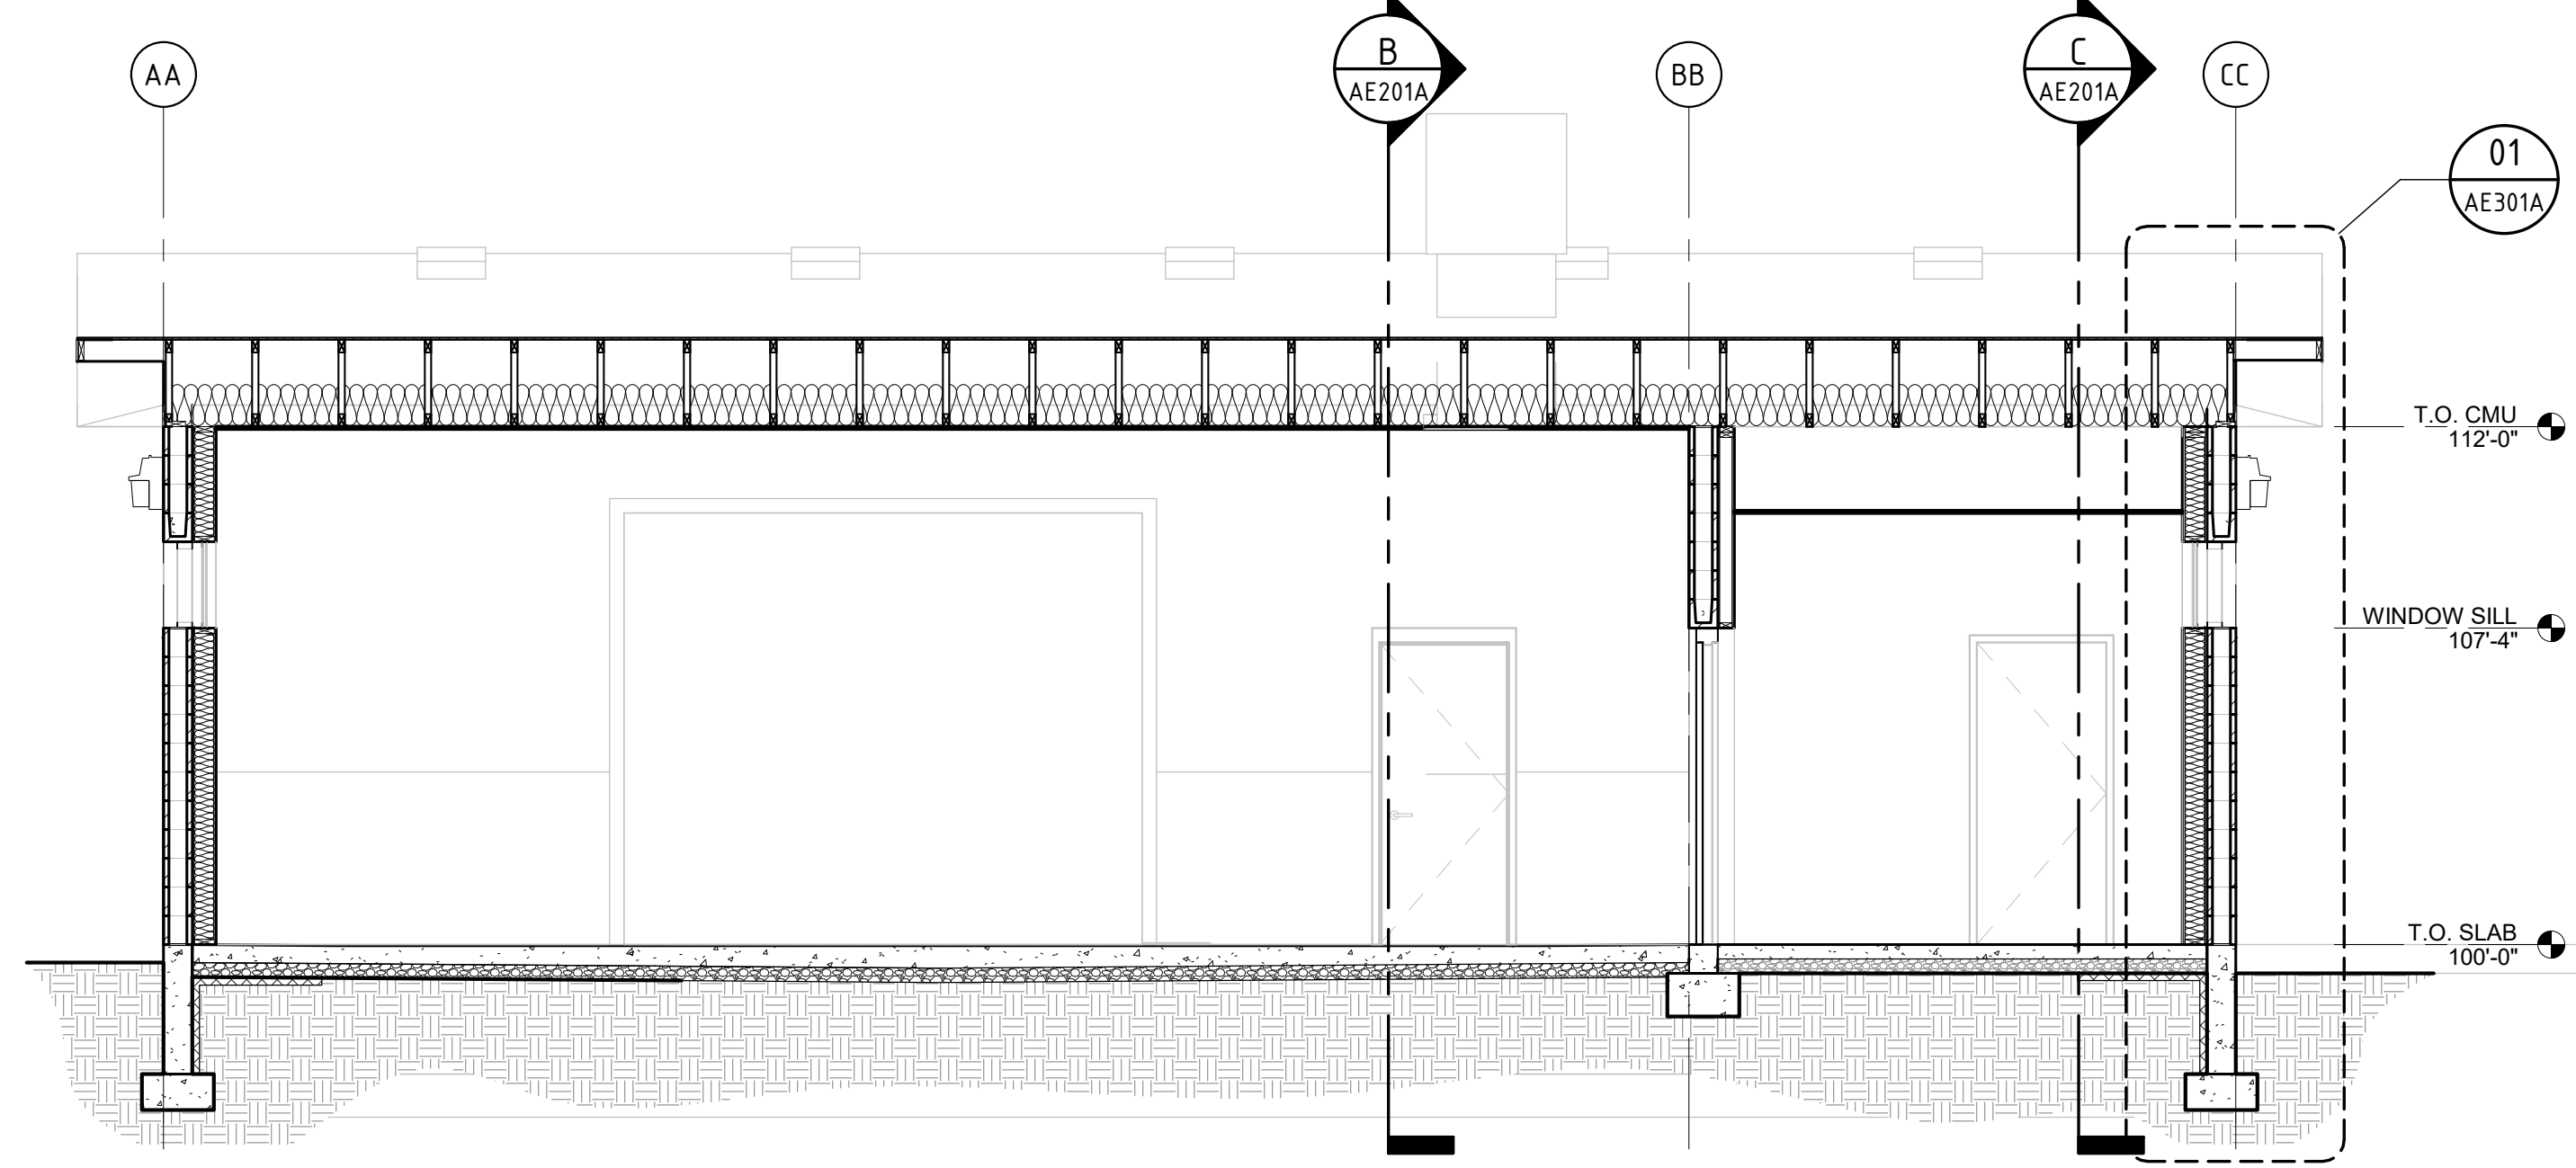

SECTION A
 SCALE: 1/4" = 1'-0"
 AE201A

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 G. BROWN: DESIGN INC
 SITE AND LANDSCAPE ARCHITECTS
 610 East South Temple, Ste 50
 Salt Lake City, Utah 84102
 p. 801.575.6066 f. 801.575.6166
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MAGNA REGIONAL PARK
PHASE 1
 4042 SOUTH 7200 WEST
 MAGNA, UTAH 84044

REVISIONS:
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SHEET TITLE:
 MAINT. BLDG.
 ELEVATIONS & SECTIONS

DATE: 7-22-19
 DRAWN BY: CKG
 CHECKED BY: DW
 JOB NO.: U17-021


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 AE201A

CONSTRUCTION DOCUMENTS - CONFORMED SET


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 FOR COMPLIANCE WITH THE APPLICABLE CONSTRUCTION CODES IDENTIFIED BELOW
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 MECHANICAL PLUMBING
 ELECTRICAL ENERGY
 ACCESSIBILITY FIRE
 PLAN REVIEW ACCEPTANCE OF DOCUMENTS DOES NOT AUTHORIZE CONSTRUCTION TO PROCEED IN VIOLATION OF ANY FEDERAL, STATE, OR LOCAL REGULATIONS.
 BY: *[Signature]* DATE: 11/13/19
 WEST COAST CODE CONSULTANTS, INC.

GENERAL NOTES AND LEGEND:

- SEE SHEET AE001 FOR GENERAL NOTES.
- SEE TITLE SHEET FOR DRAWING INDEX.
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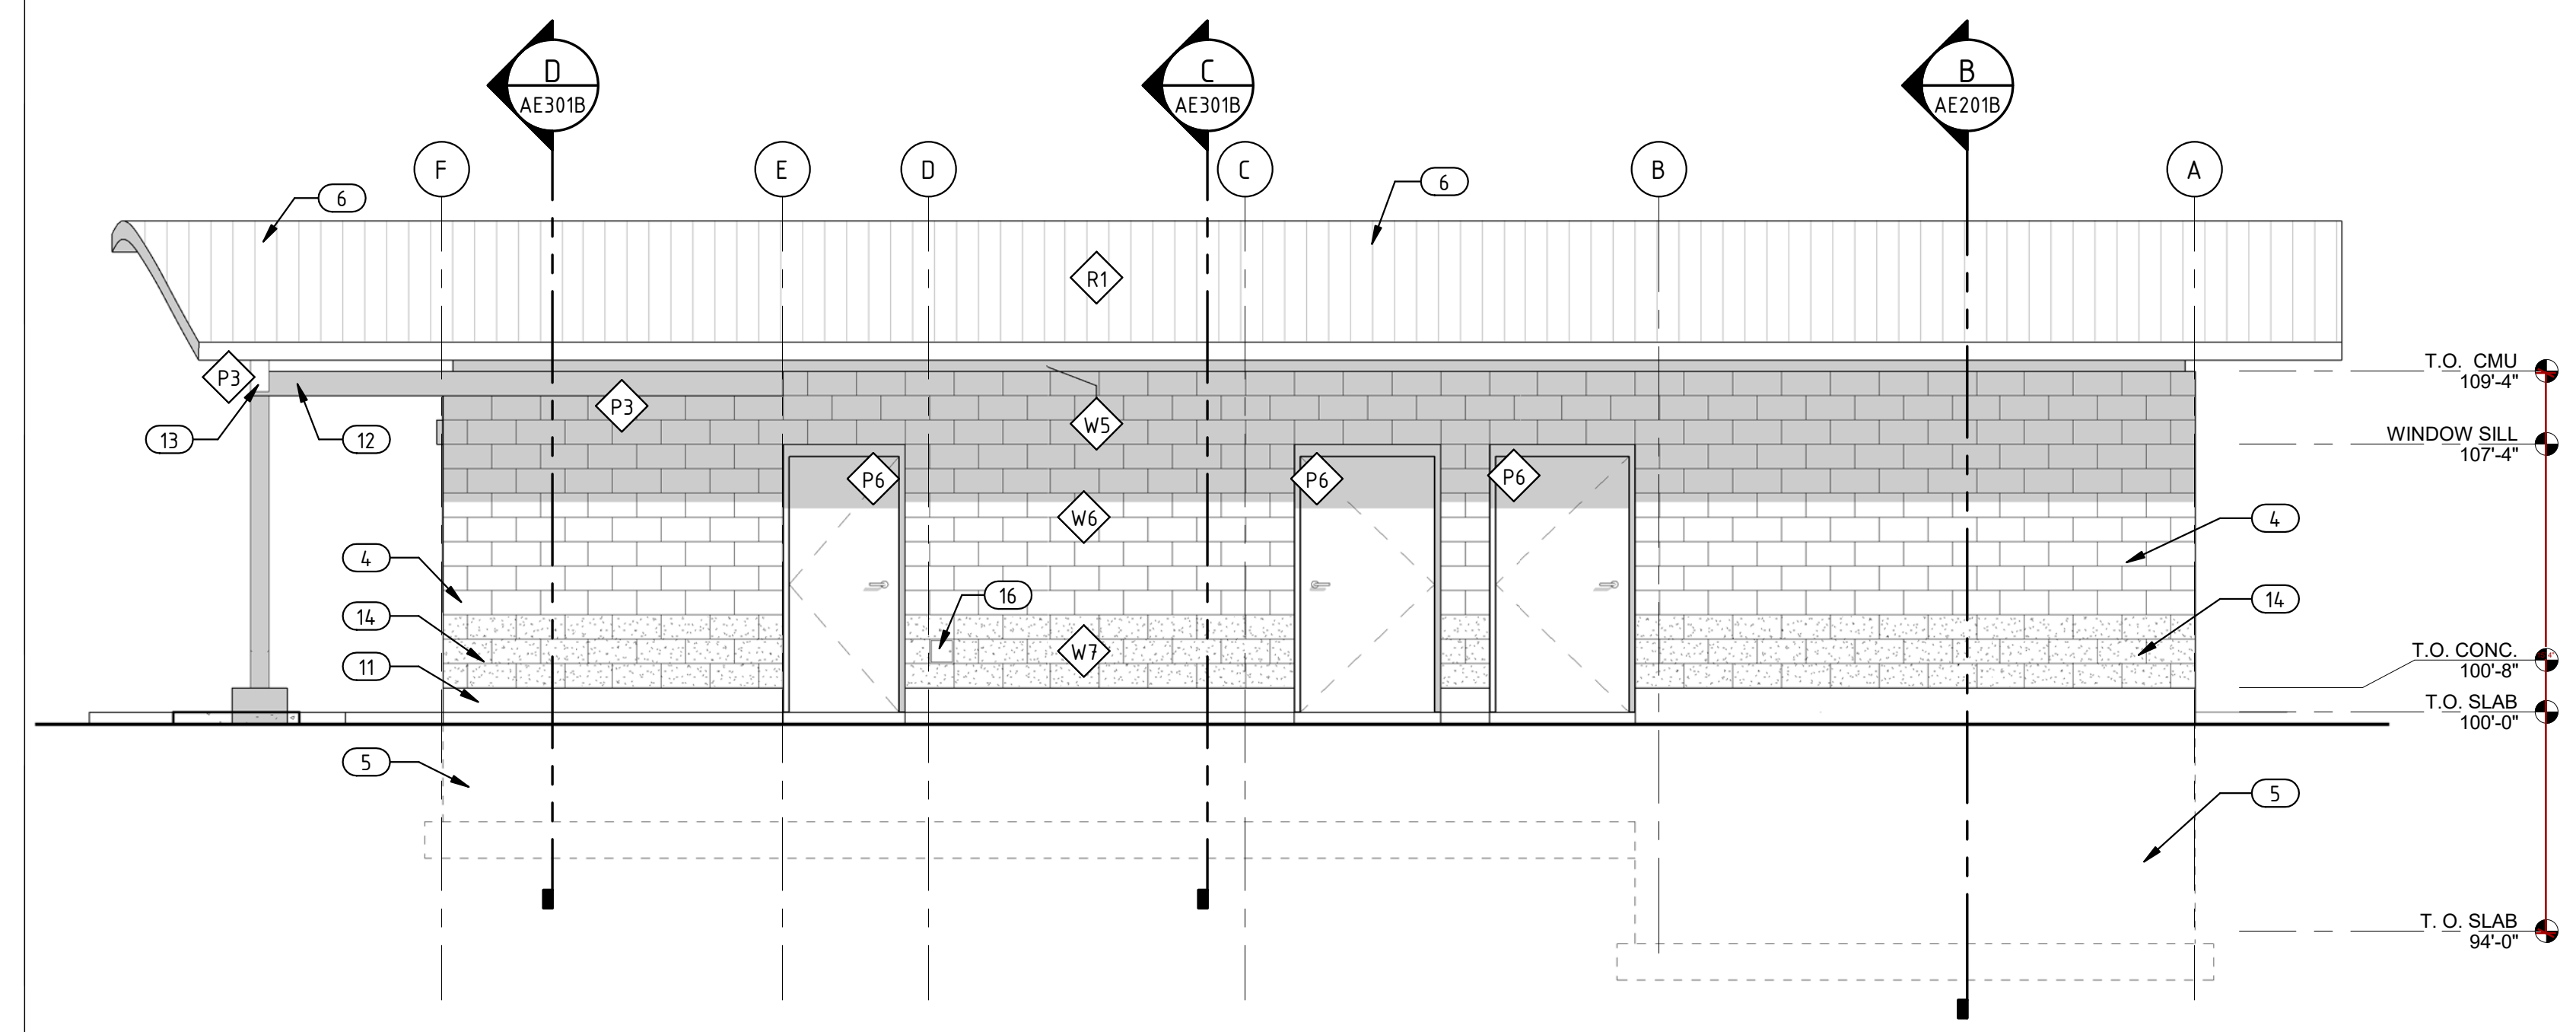
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 SCALE: 1/4" = 1'-0" AE201B

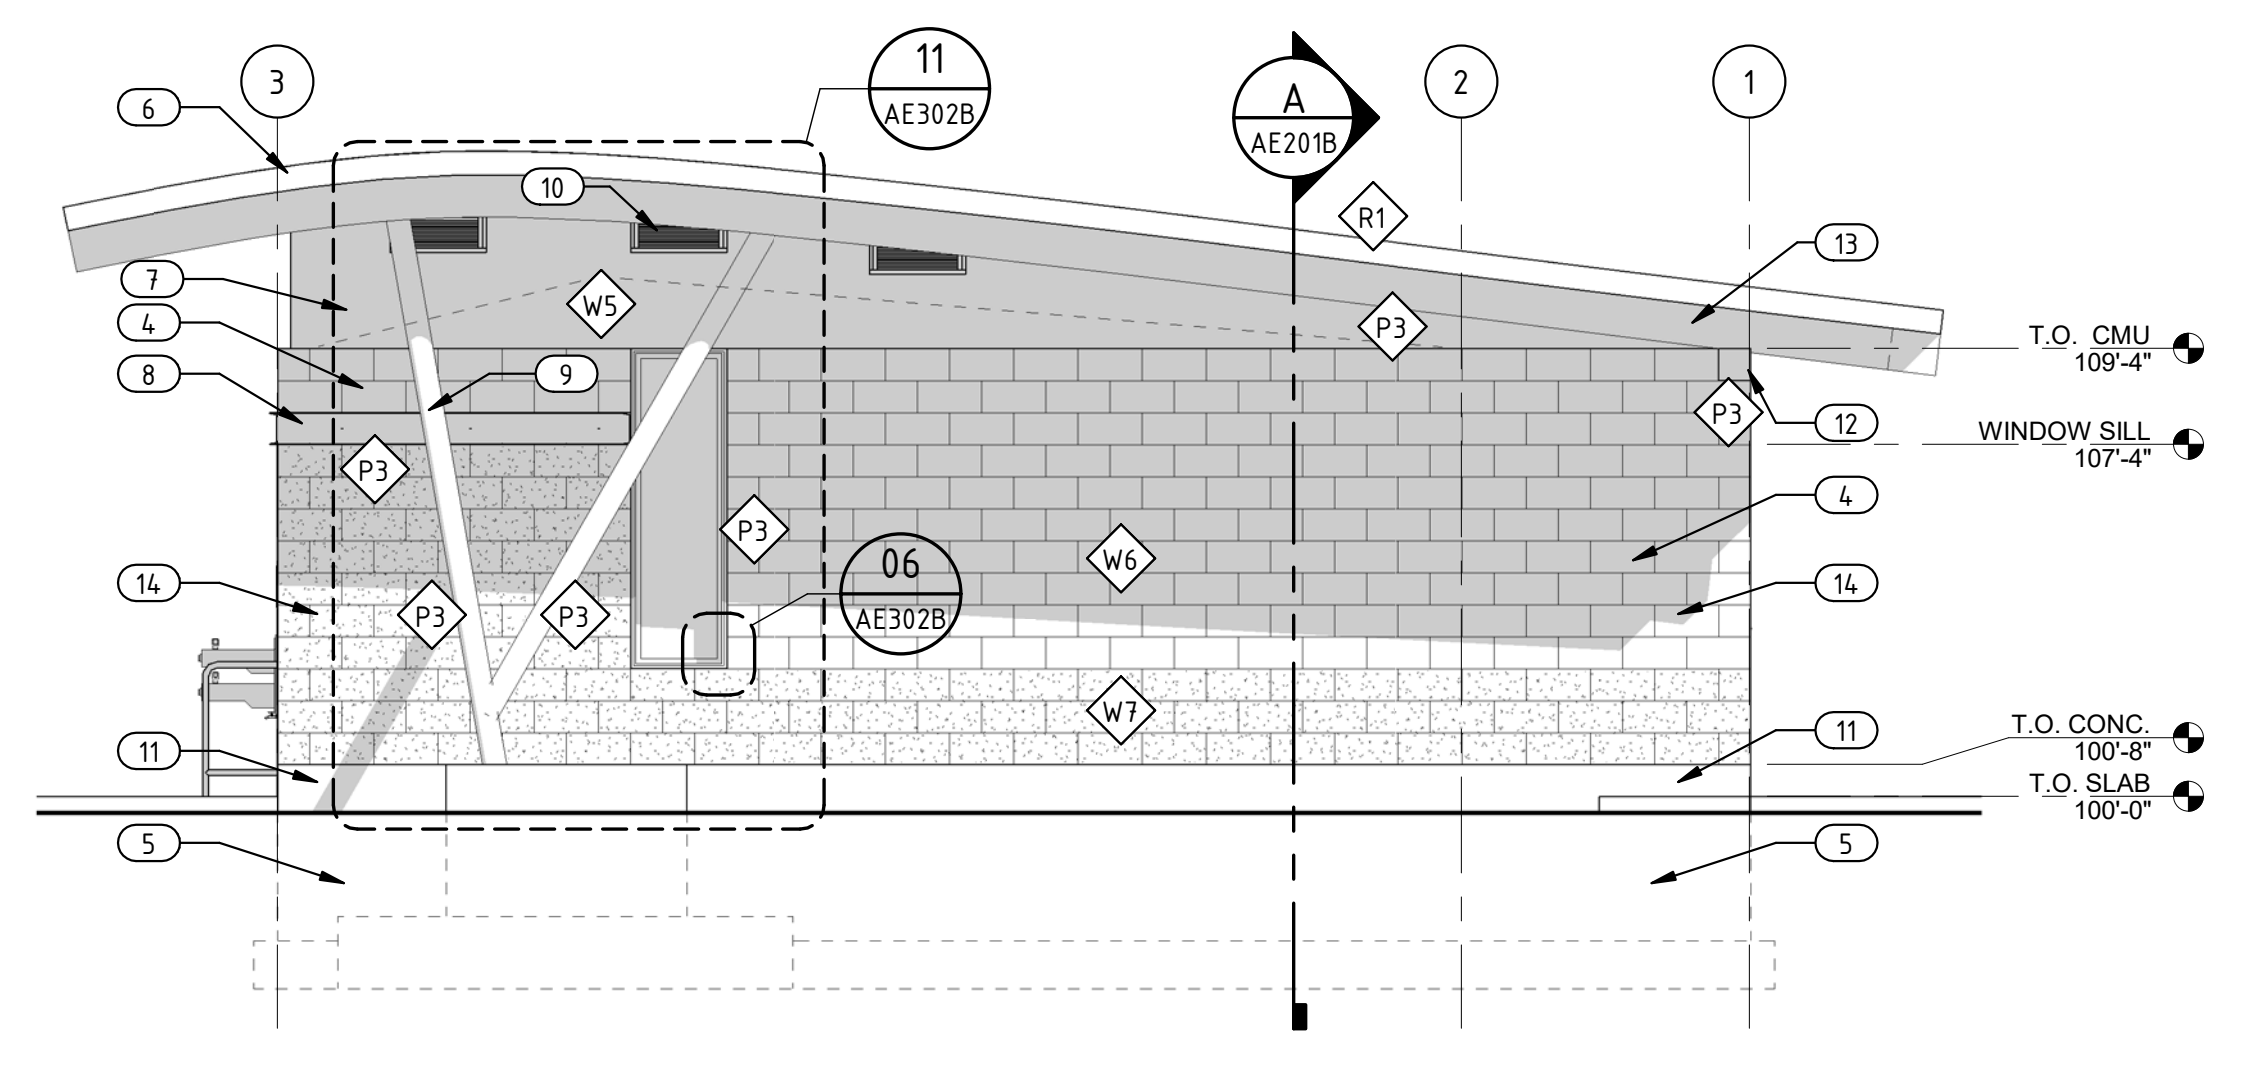


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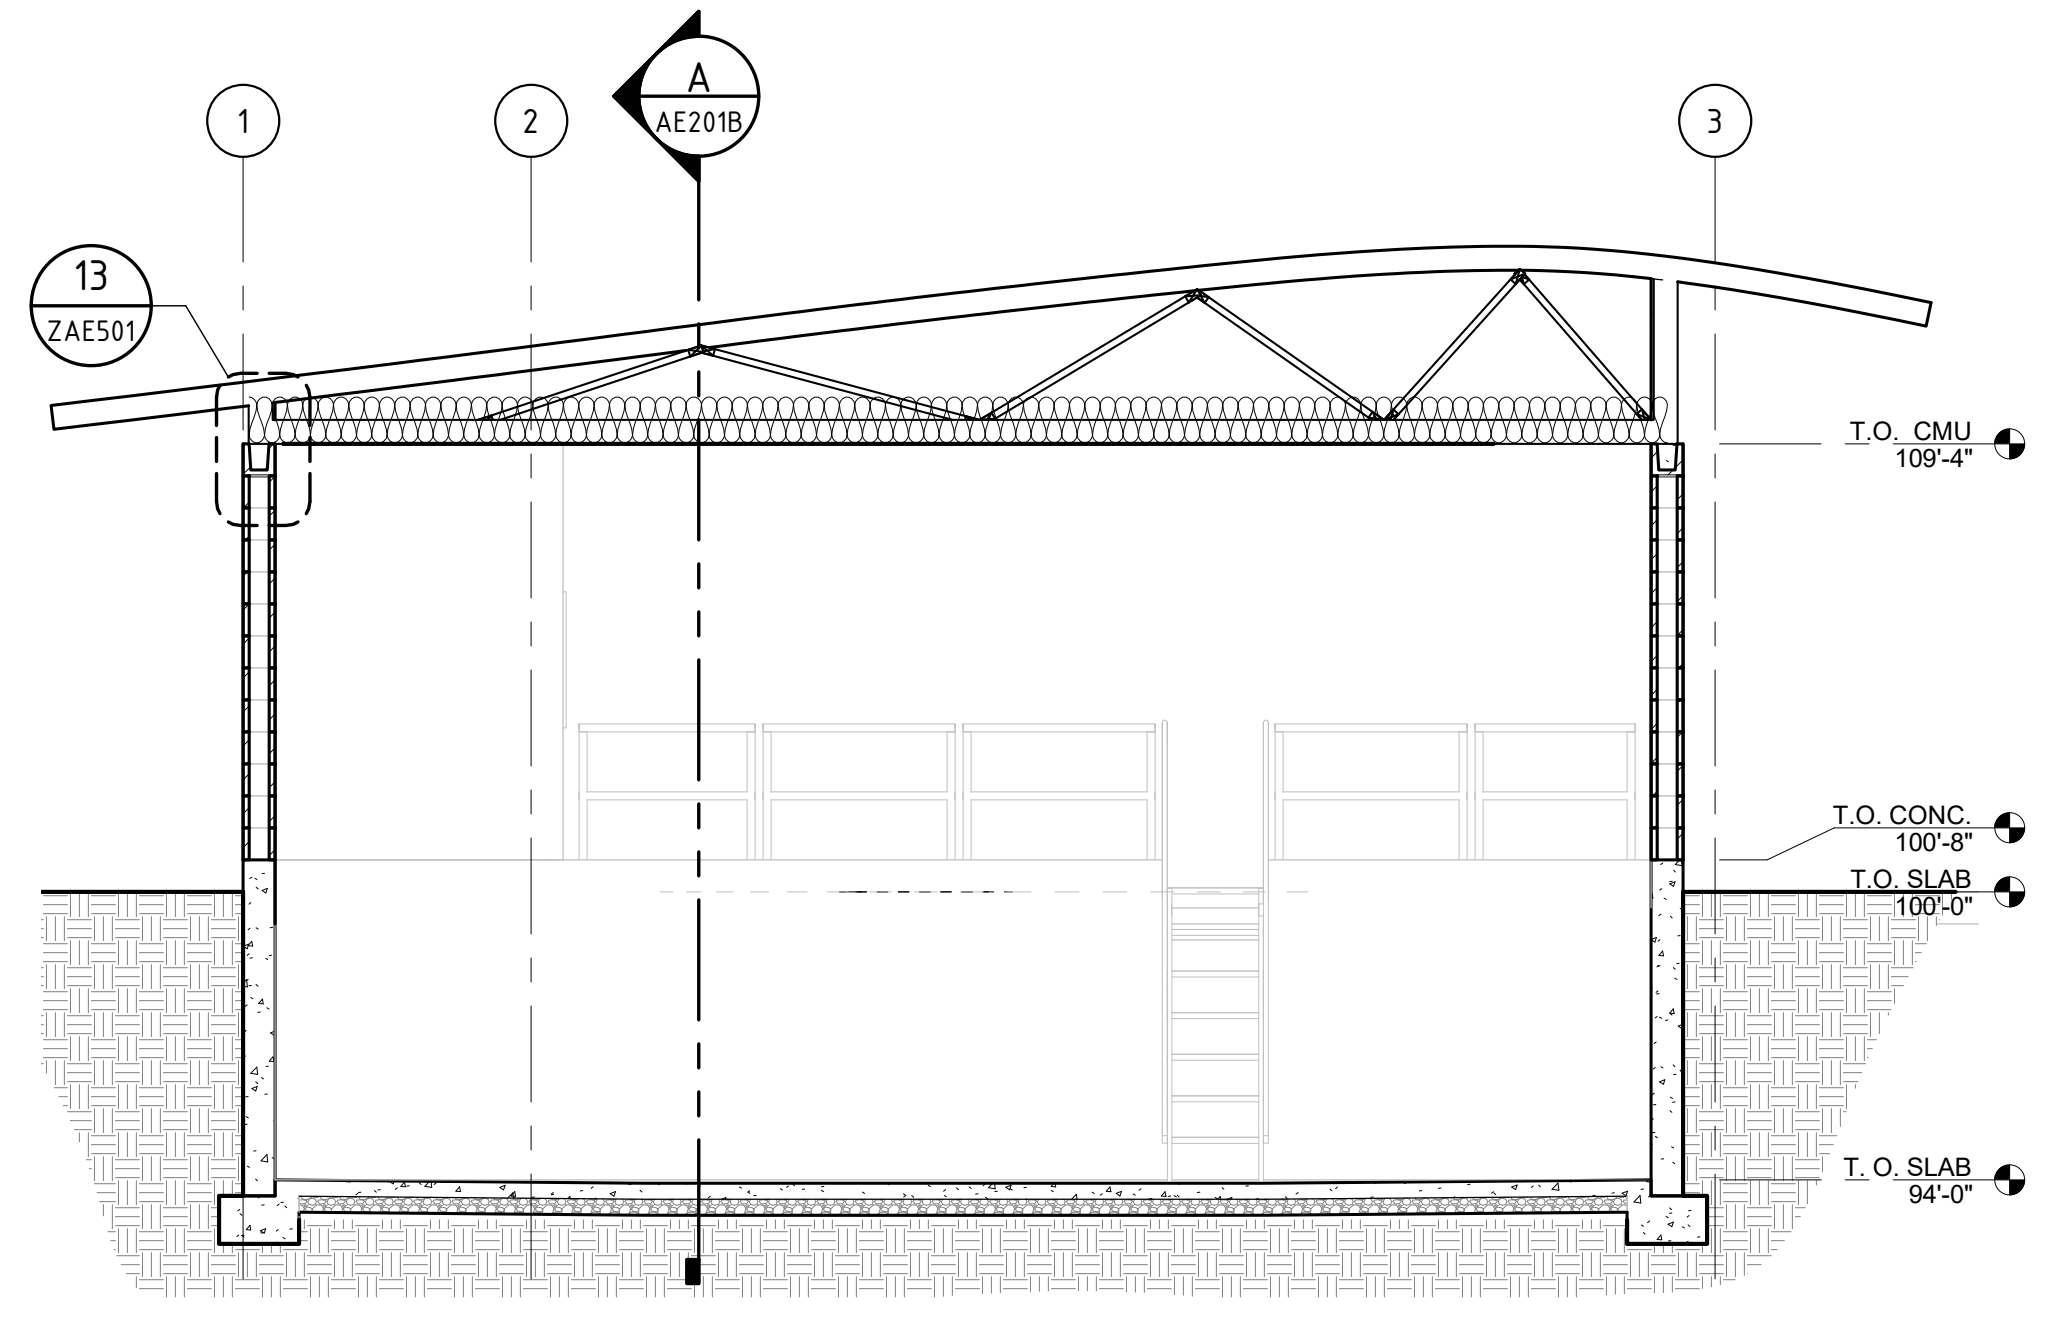
- CONCRETE PAVING. SEE CIVIL DRAWINGS.
- EXPANSION JOINT W/PORABLE CAULK AT EXTERIOR. TYP.
- FACE OF GYP. BD. 1" FROM FACE OF CMU.
- COMMON CMU. SEE WALL TYPES AND FINISH SCHEDULE. TYP.
- CIP FOOTING AND FOUNDATION WALL W/ DAMPROOFING. SEE STRUCTURAL FOR DESIGN AND DEPTH. TYP.
- PRE-FINISHED STANDING SEAM METAL ROOFING OVER FULL ICE & WATER SHIELD. TYPICAL AT STANDING SEAM ROOF.
- HARD COATED STUCCO. SEE FINISH SCHEDULE.
- C8 STEEL CHANNEL. ANCHOR WITH MASONRY ANCHORS BOLTS 32" O.C.
- 6" STEEL COLUMN. SEE FINISH SCHEDULE FOR COLOR.
- METAL ATTIC VENT W/INSECT SCREEN PAINT TO MATCH STEEL STRUCTURE COLOR. SEE VENT CALCS.
- CEMENTITIOUS PLASTER AT EXPOSED FOUNDATION WALLS. TYP.
- EXPOSED METAL BEAM. SEE STRUCTURAL FOR SIZE.
- STRUCTURAL ARCHED GLULAM. TO BE WRAPPED IN BREAK METAL AND PAINTED. SEE FINISH SCHEDULE AND STRUCTURAL.
- SPLIT FACE CMU, SHOWN HATCHED. SEE WALL TYPES AND FINISH SCHEDULE. TYP.
- ADA WALL TO FLOOR GRAB BAR FOR DRINKING FOUNTAIN, STAINLESS STEEL.
- REMOVABLE KEY HOSE BIB A RECESS BOX. SEE PLUMBING.

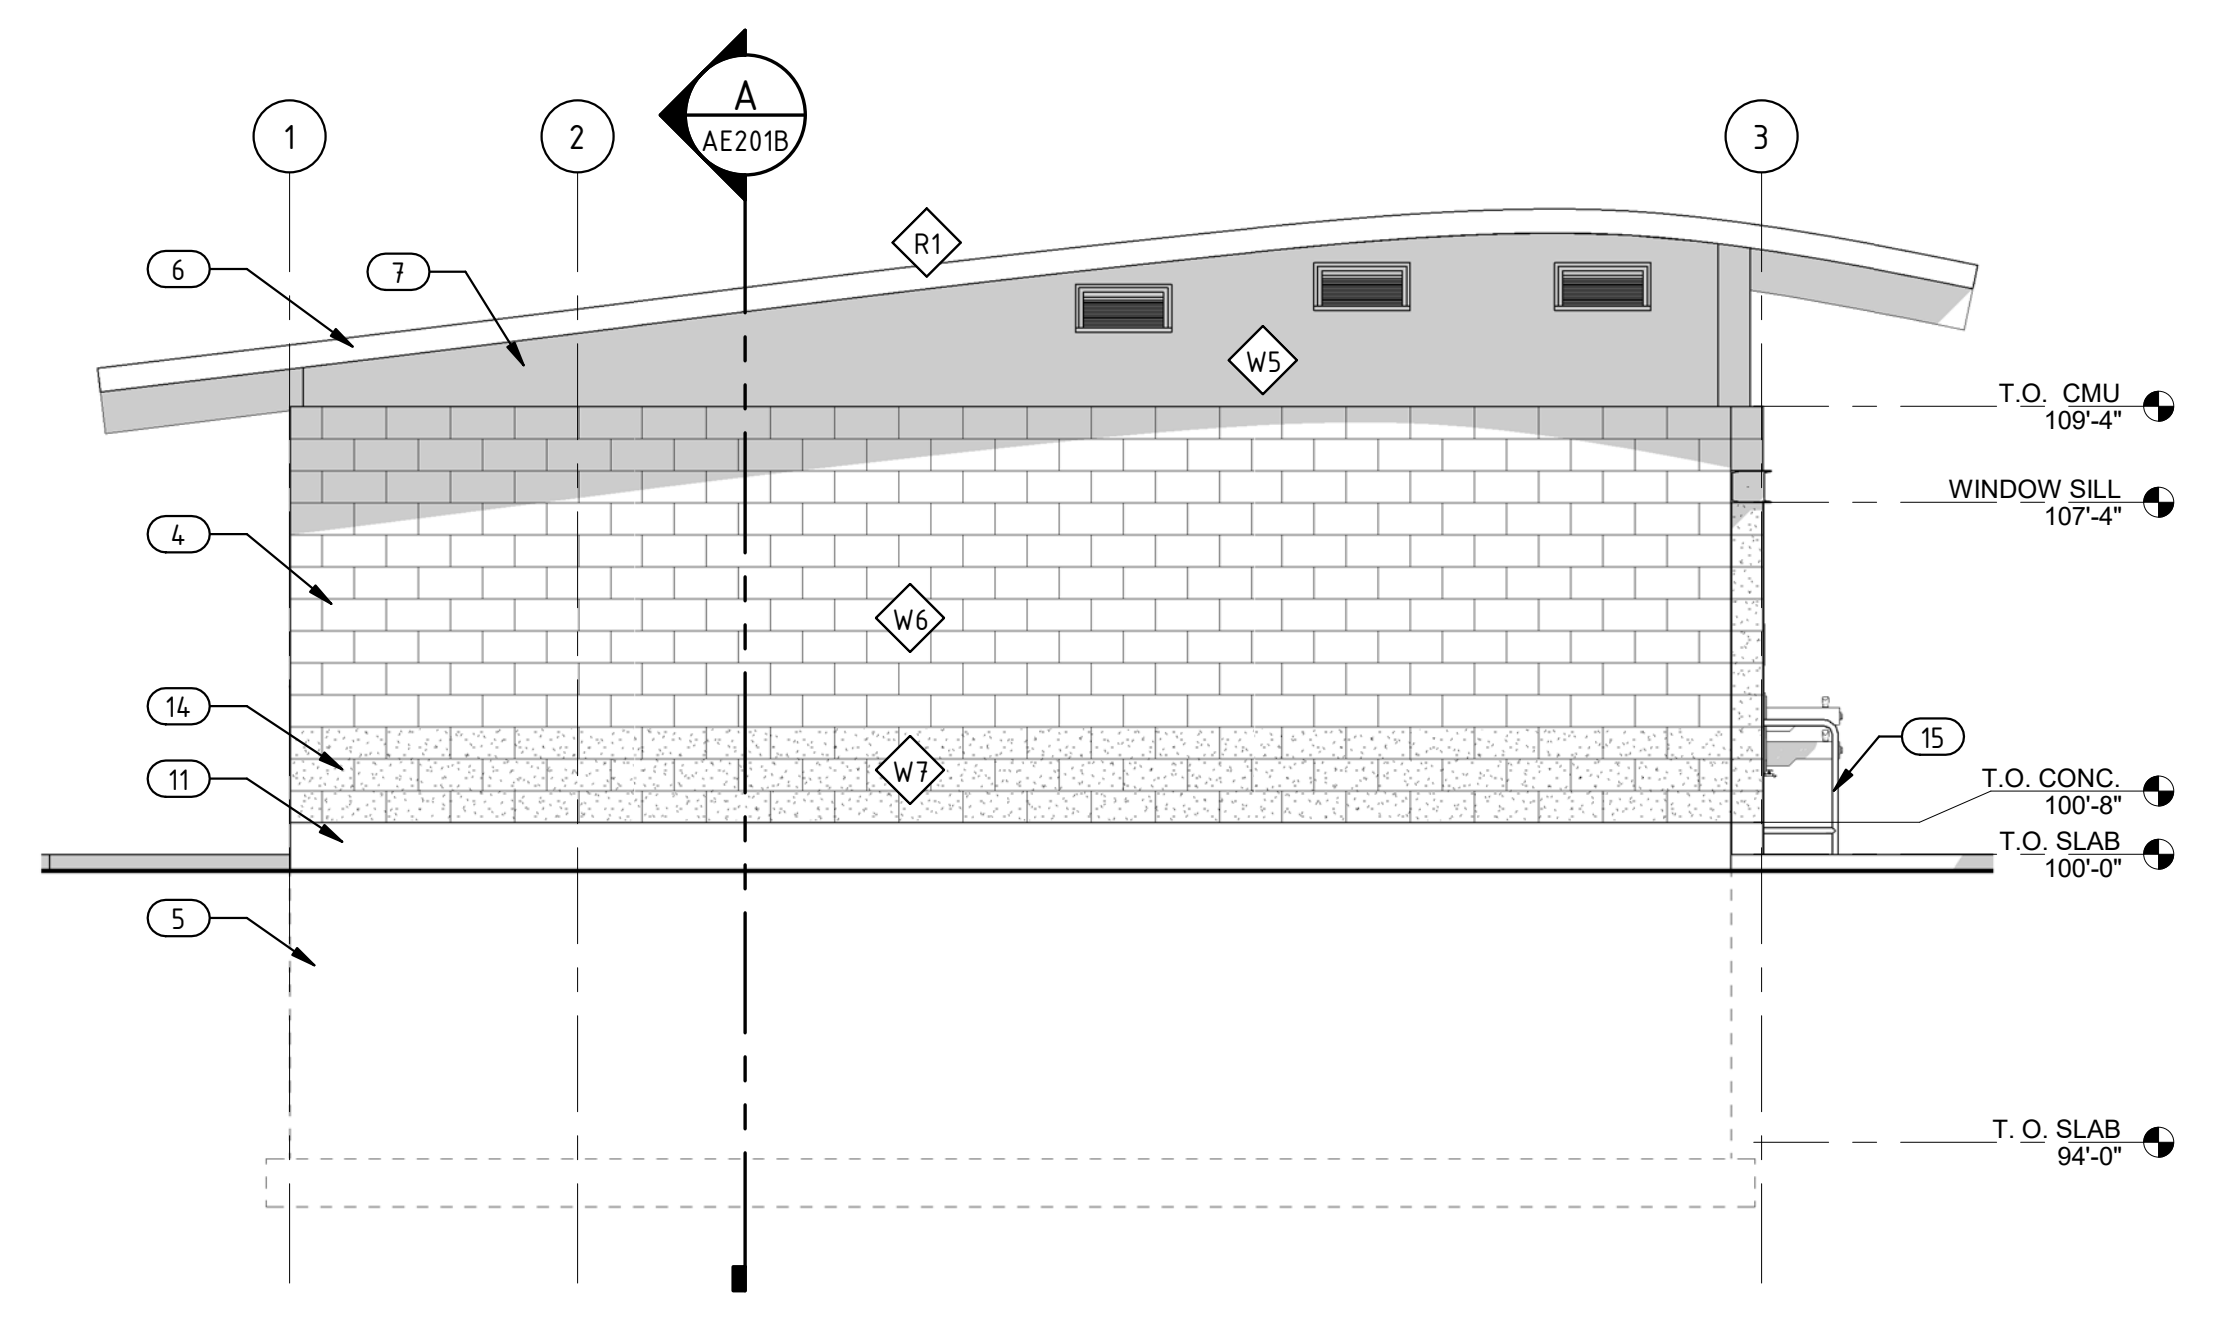


RESTROOM BLDG. - ELEVATION 02
 SCALE: 1/4" = 1'-0" AE201B



EQUIP./RESTROOM BLDG. - ELEVATION 01
 SCALE: 1/4" = 1'-0" AE201B

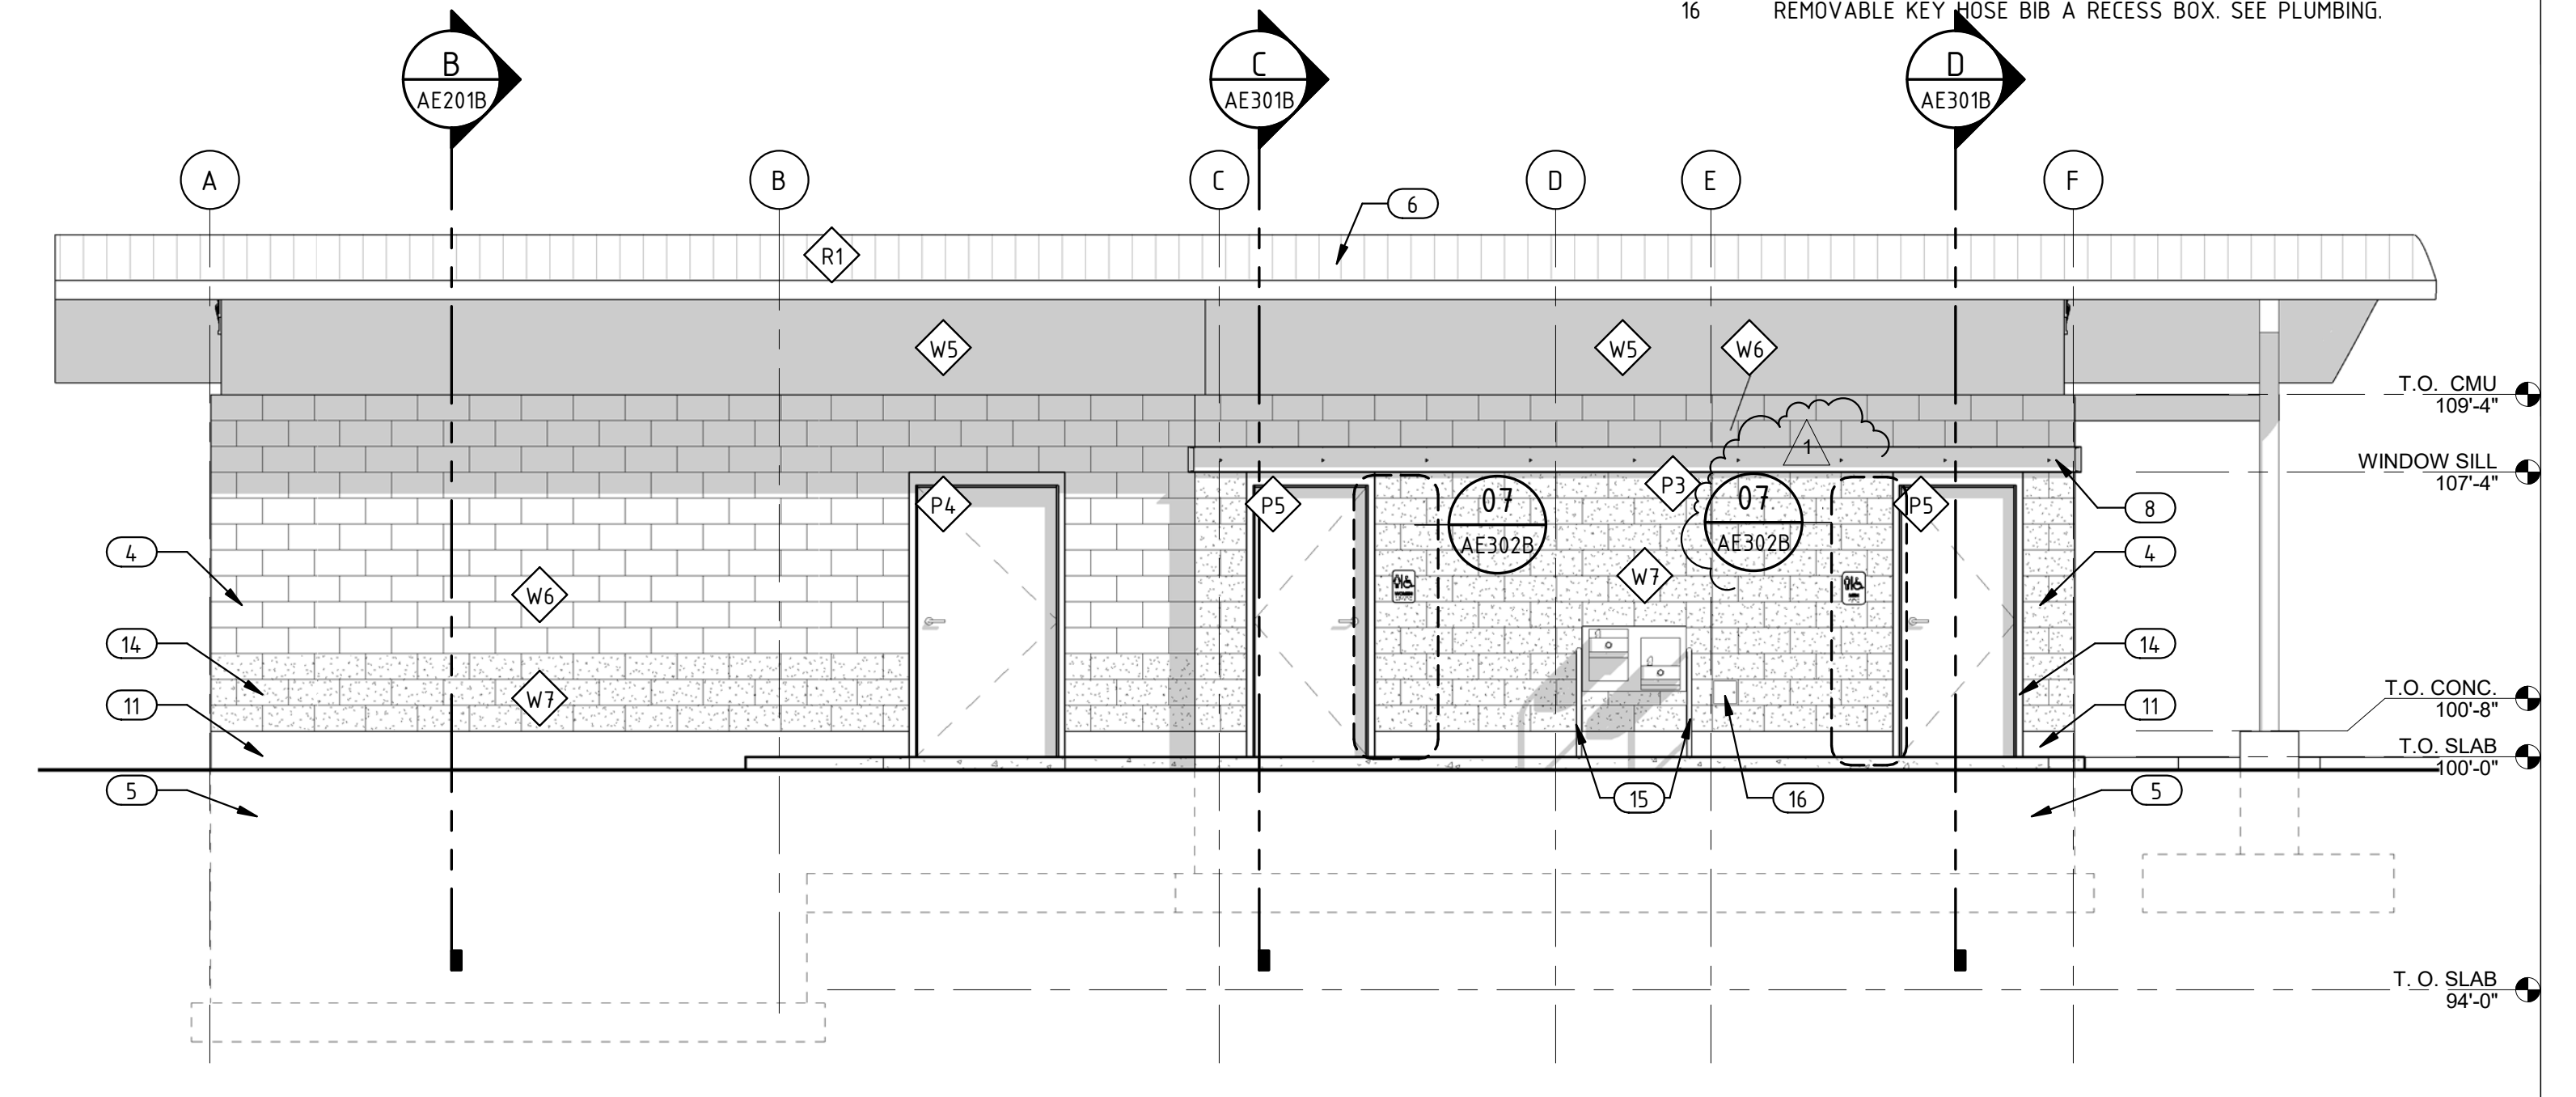

SECTION B B
 SCALE: 1/4" = 1'-0" AE201B

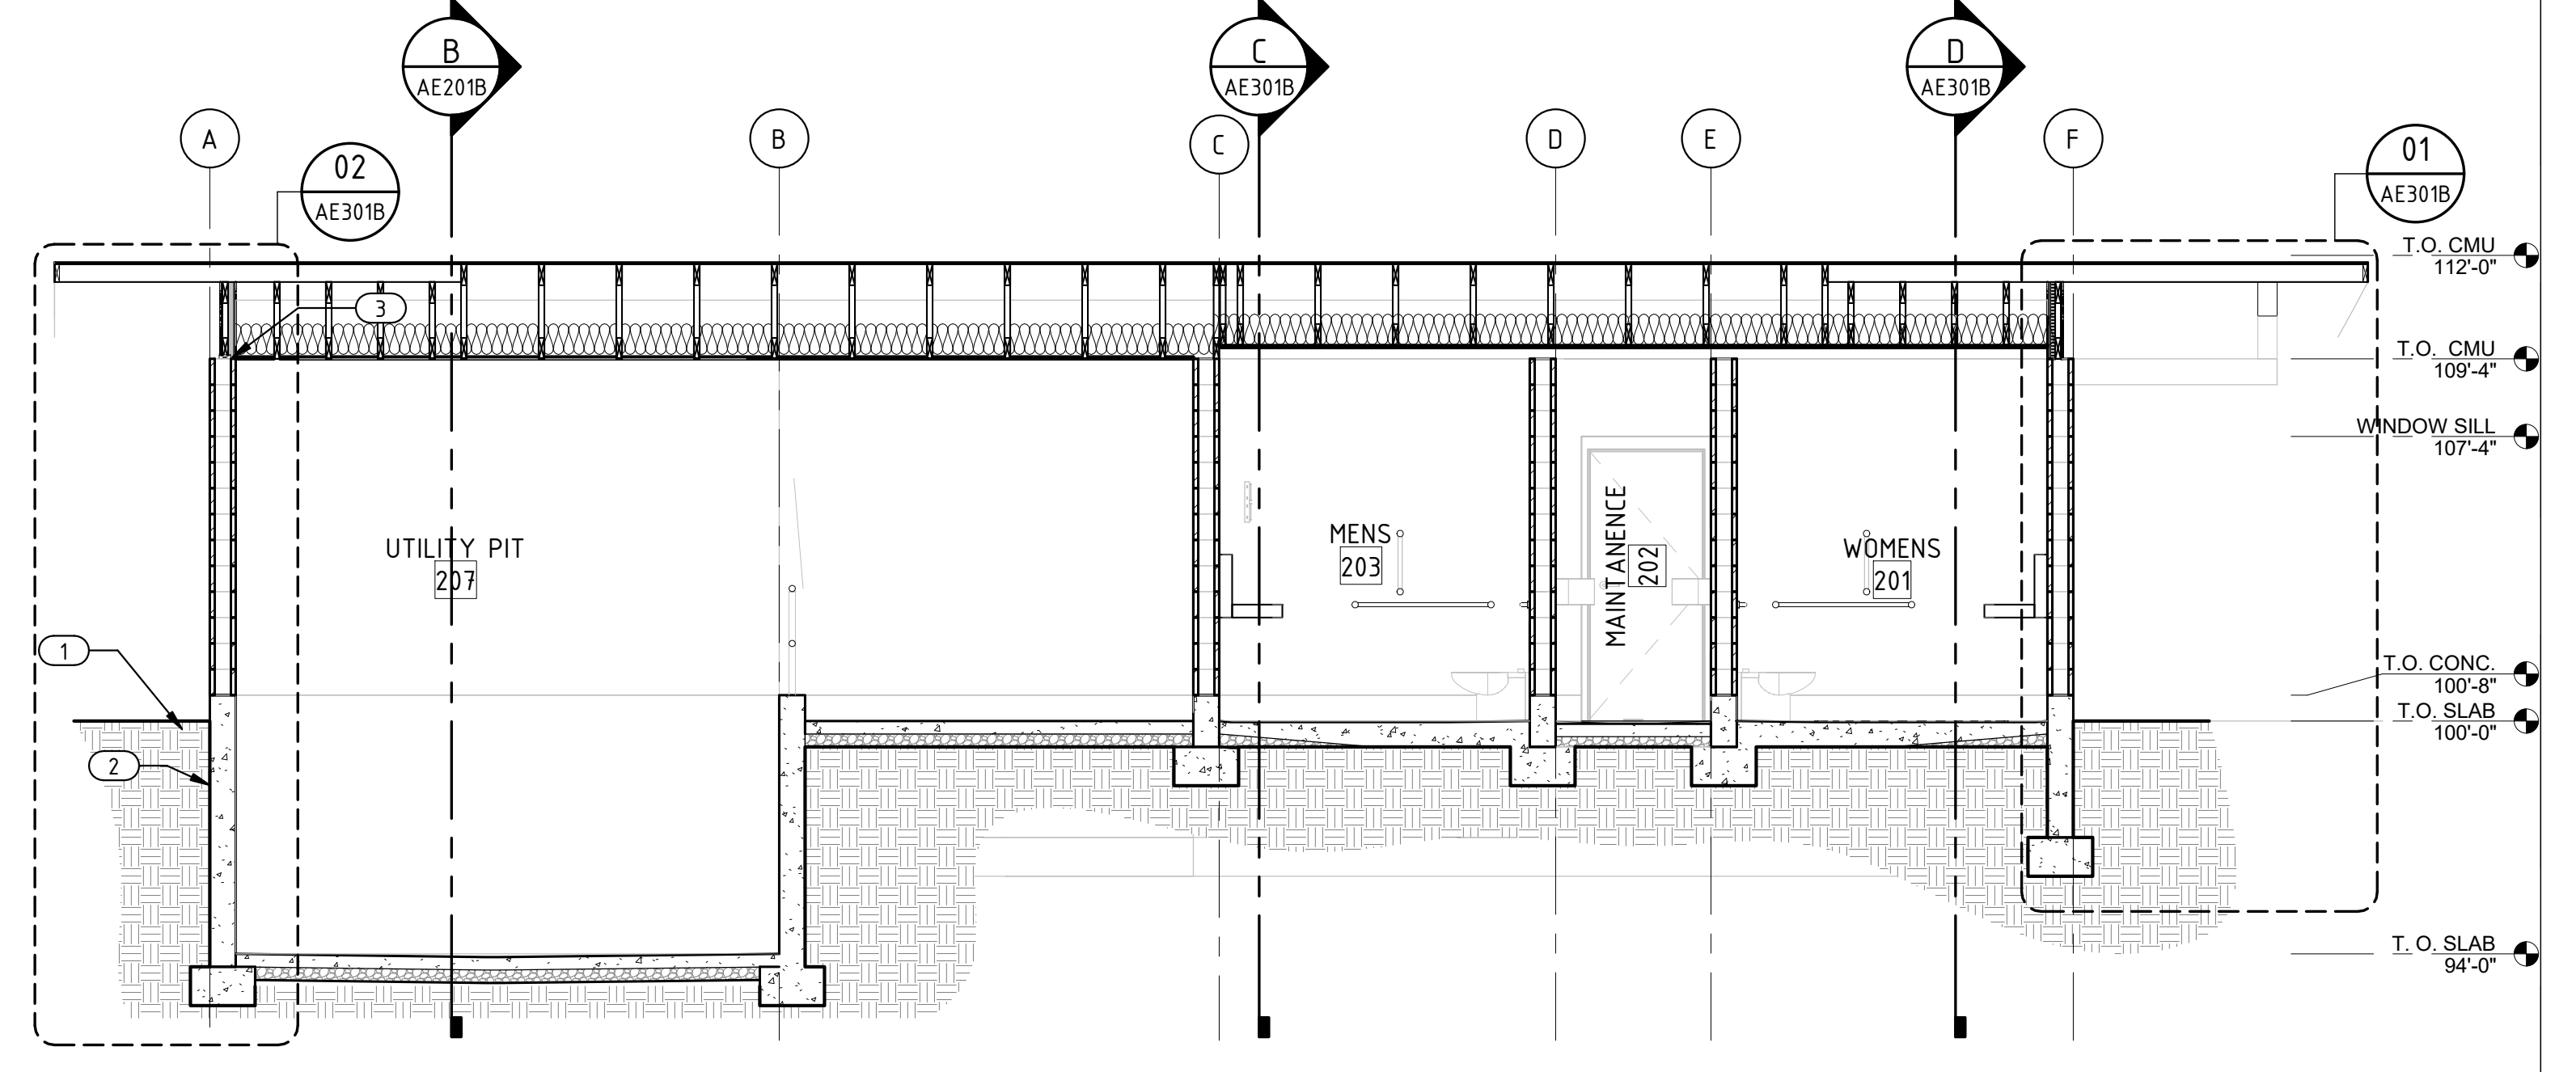

SECTION A A
 SCALE: 1/4" = 1'-0" AE201B



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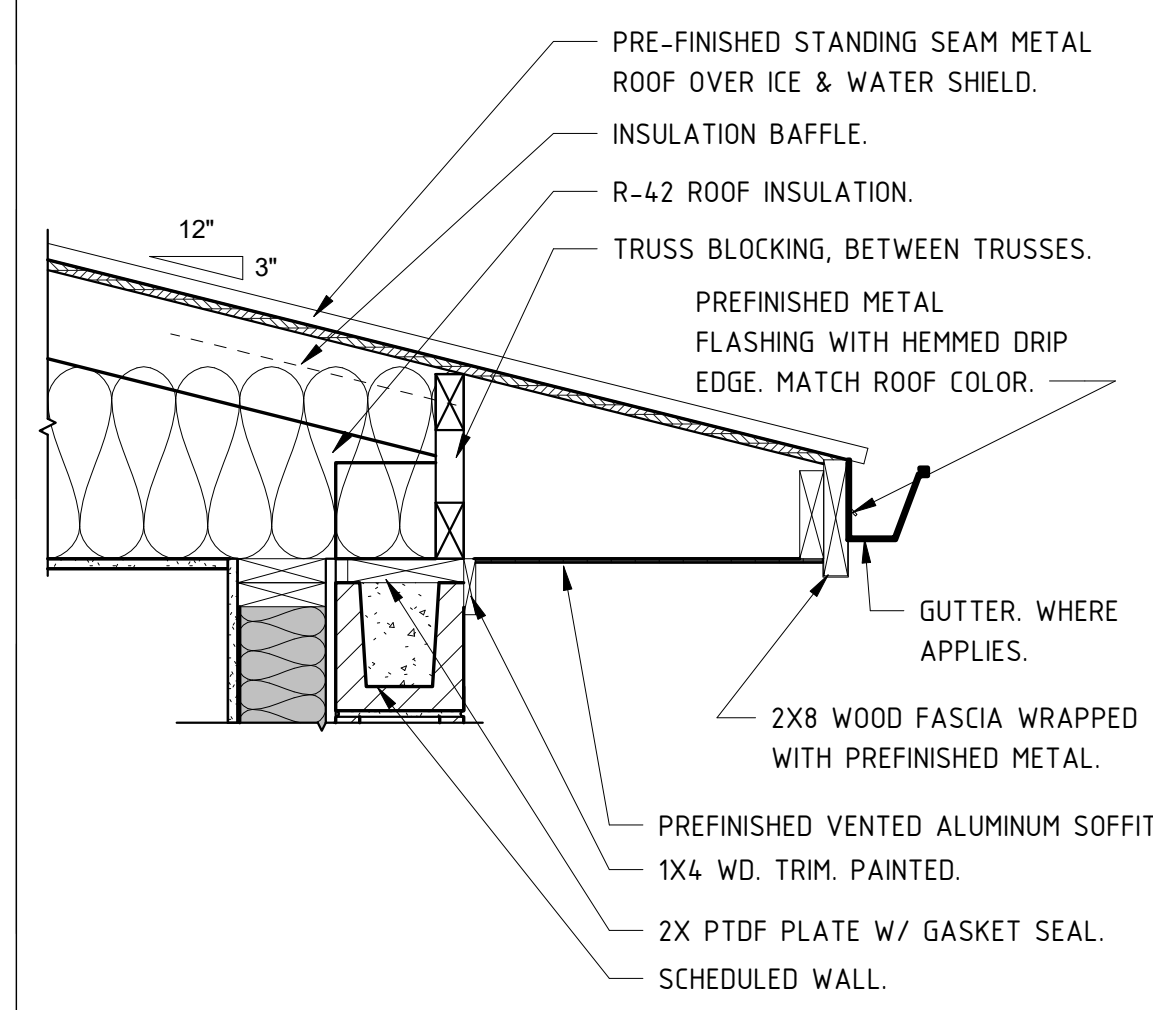
SHEET TITLE:
 EQUIP./RESTROOM BLDG.
 ELEVATIONS & SECTIONS

DATE: 7-22-19
DRAWN BY: CKG
CHECKED BY: DW
JOB NO.: U17-021


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CONSTRUCTION DOCUMENTS - CONFORMED SET


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 FOR COMPLIANCE WITH THE APPLICABLE CONSTRUCTION CODES IDENTIFIED BELOW
 MECHANICAL [] PLUMBING [] ELECTRICAL [] ENERGY [] ACCESSIBILITY [] FIRE []
 PLAN REVIEW ACCEPTANCE OF DOCUMENTS DOES NOT AUTHORIZE CONSTRUCTION TO PROCEED IN VIOLATION OF ANY FEDERAL, STATE, OR LOCAL REGULATIONS.
 BY: [Signature] DATE: 11/13/19
 WEST COAST CODE CONSULTANTS, INC.




EAVE DETAIL 09
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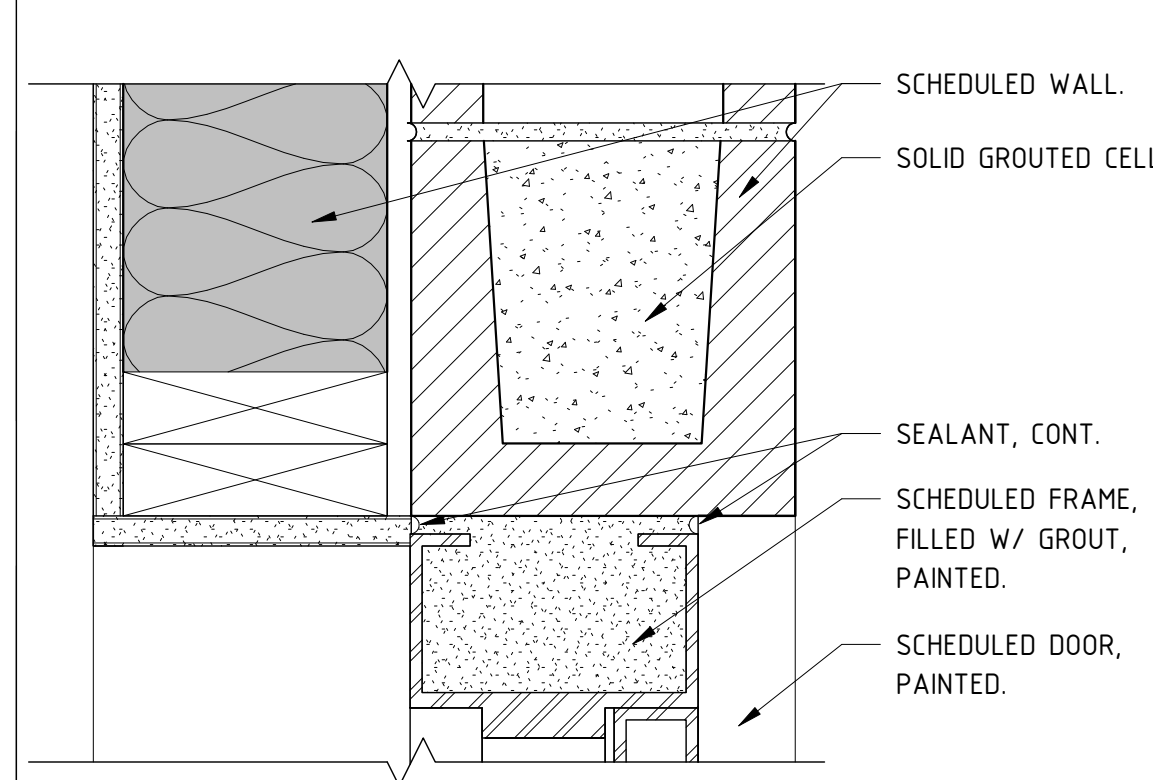
RAKE EAVE DETAIL 07
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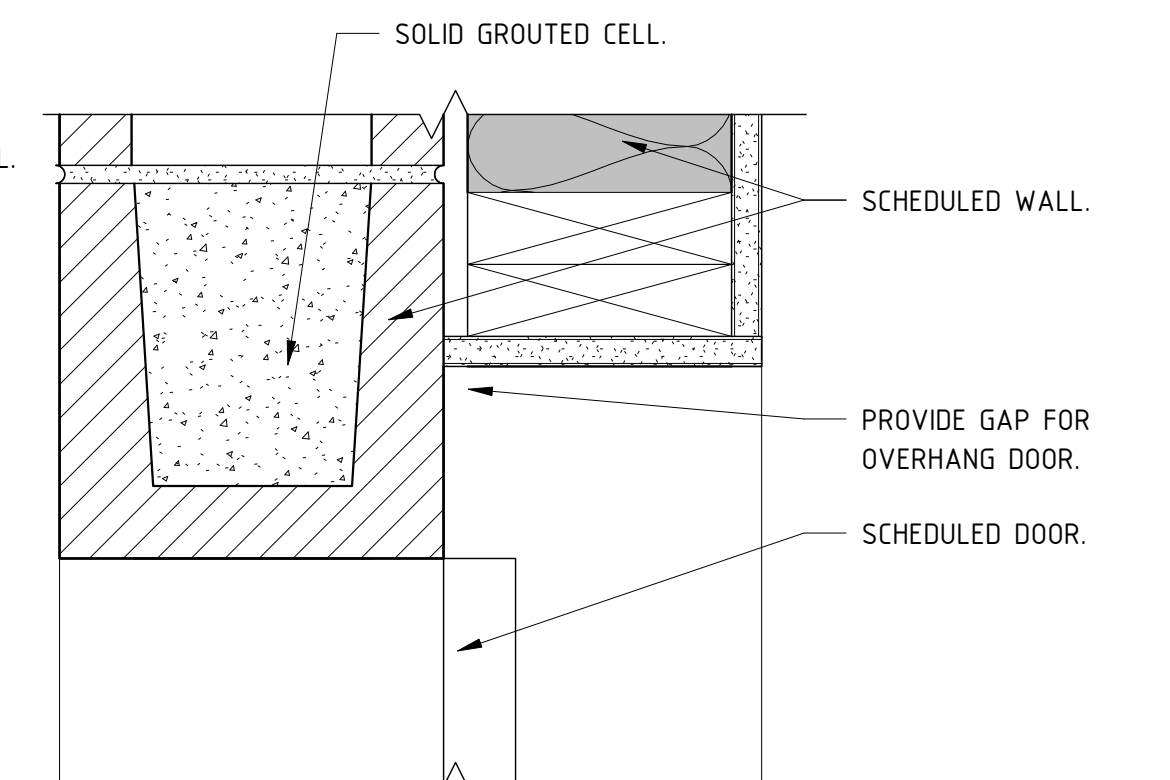
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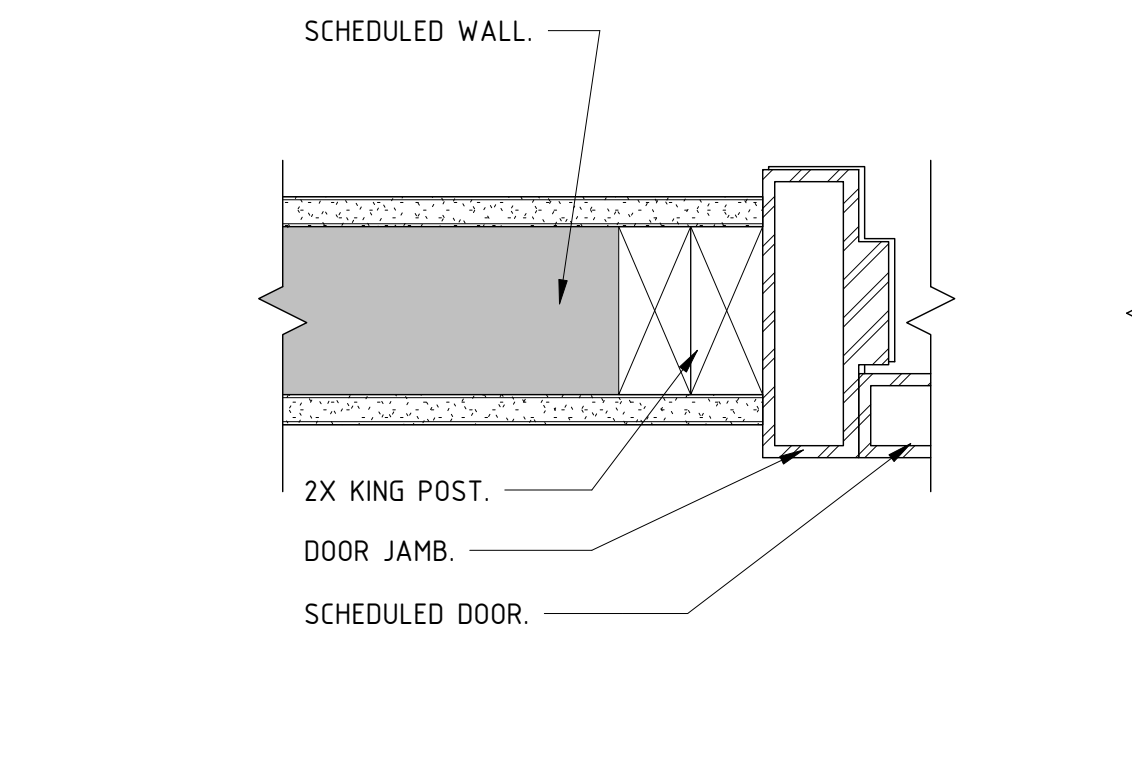
BOLLARD DETAIL 15
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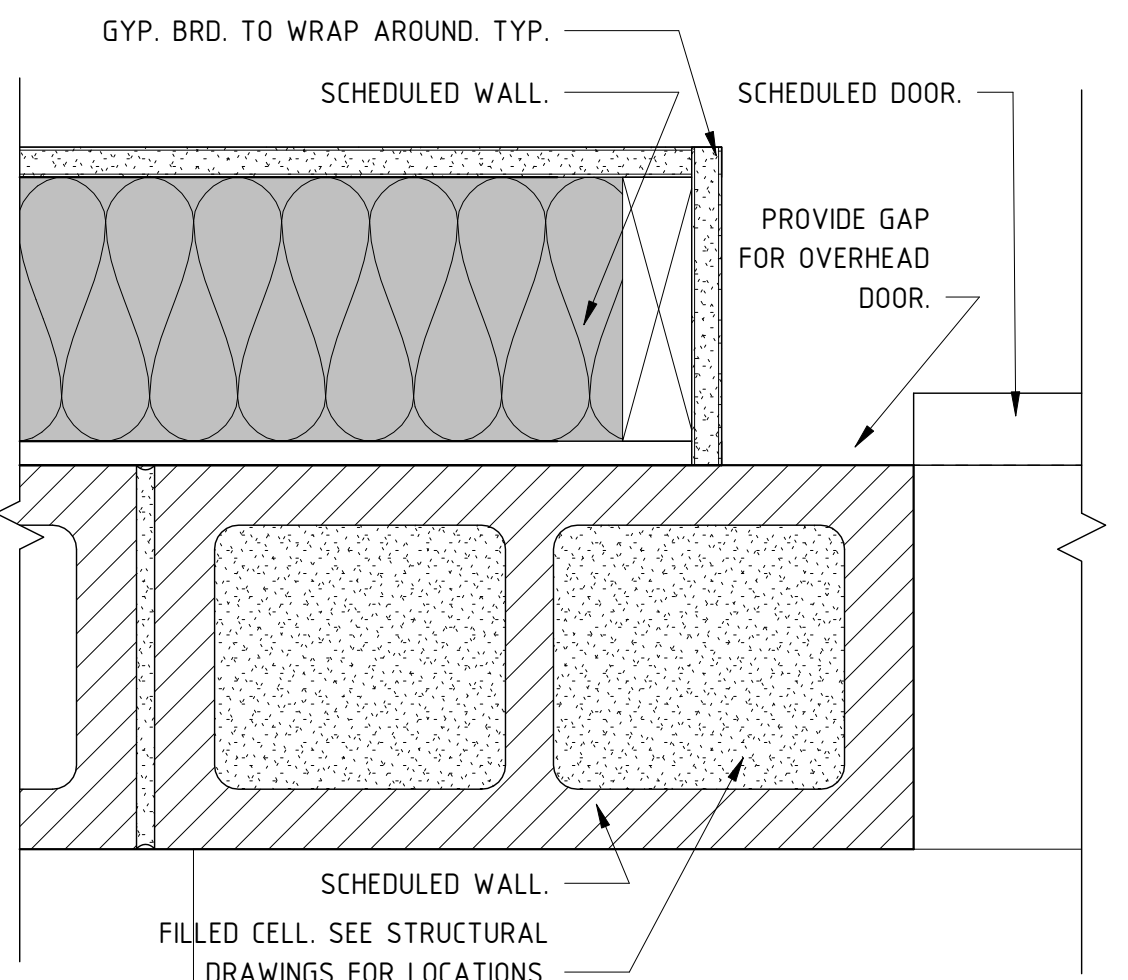
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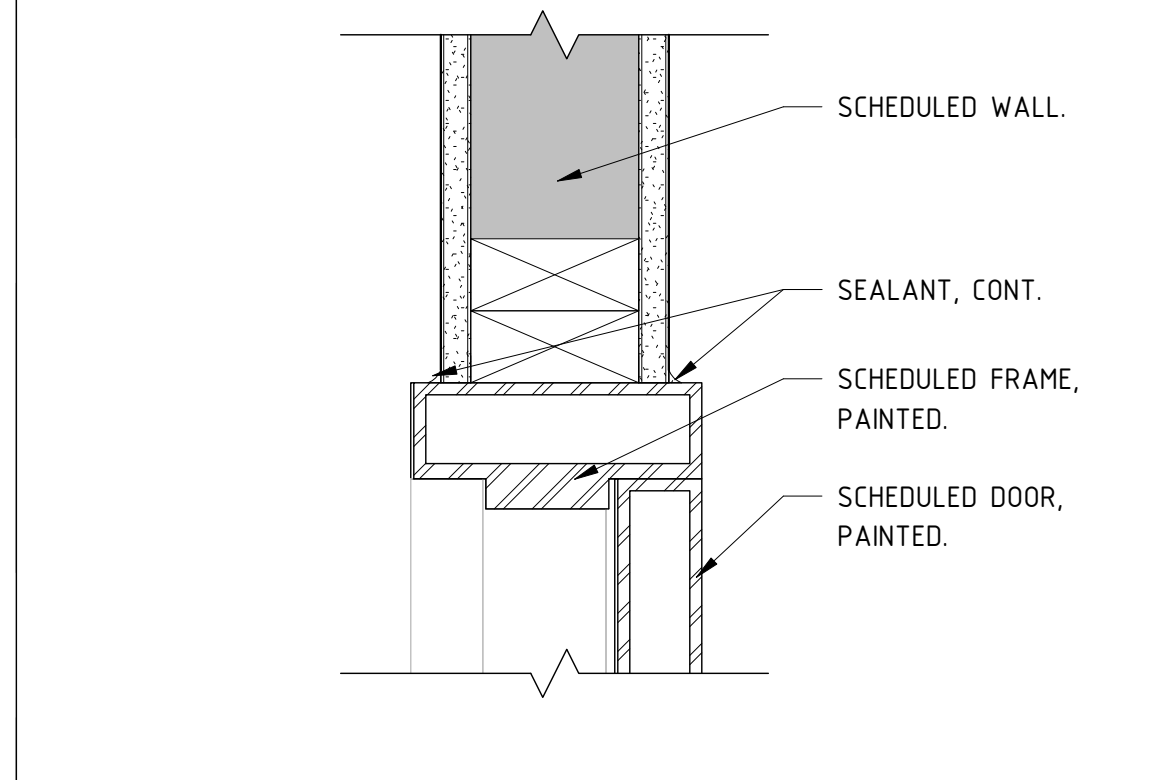
ROLL-UP DOOR HEADER 12
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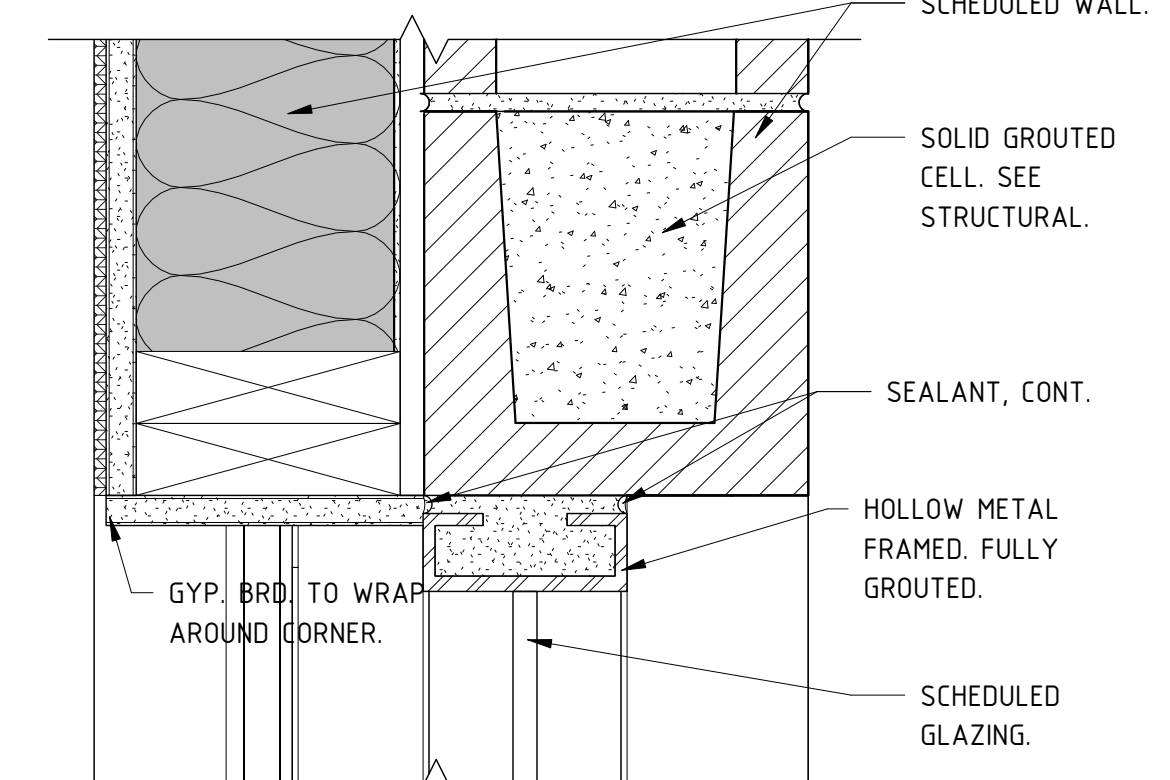
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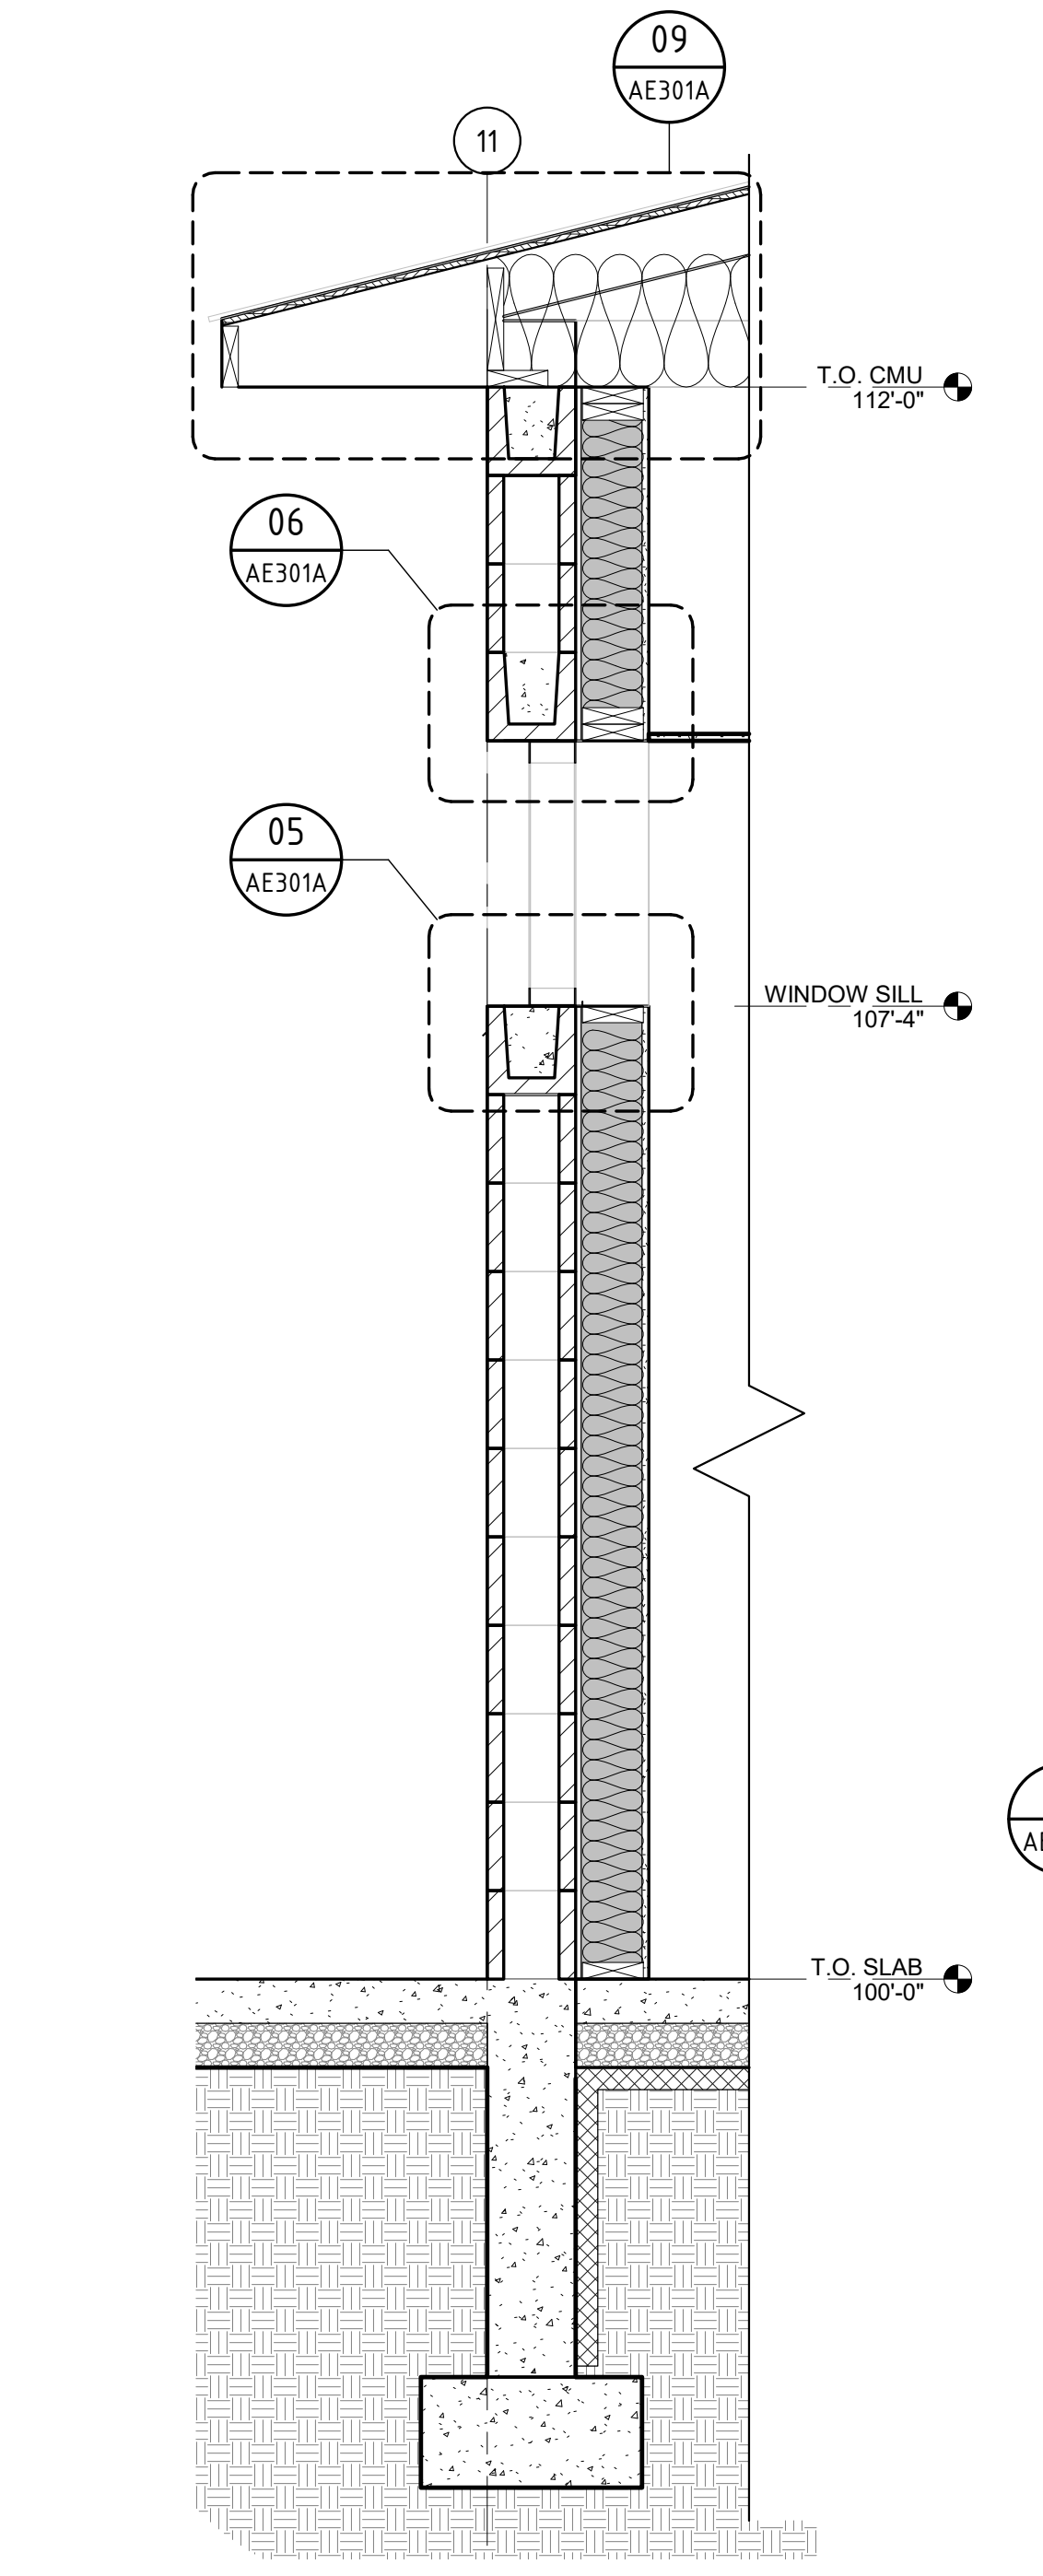
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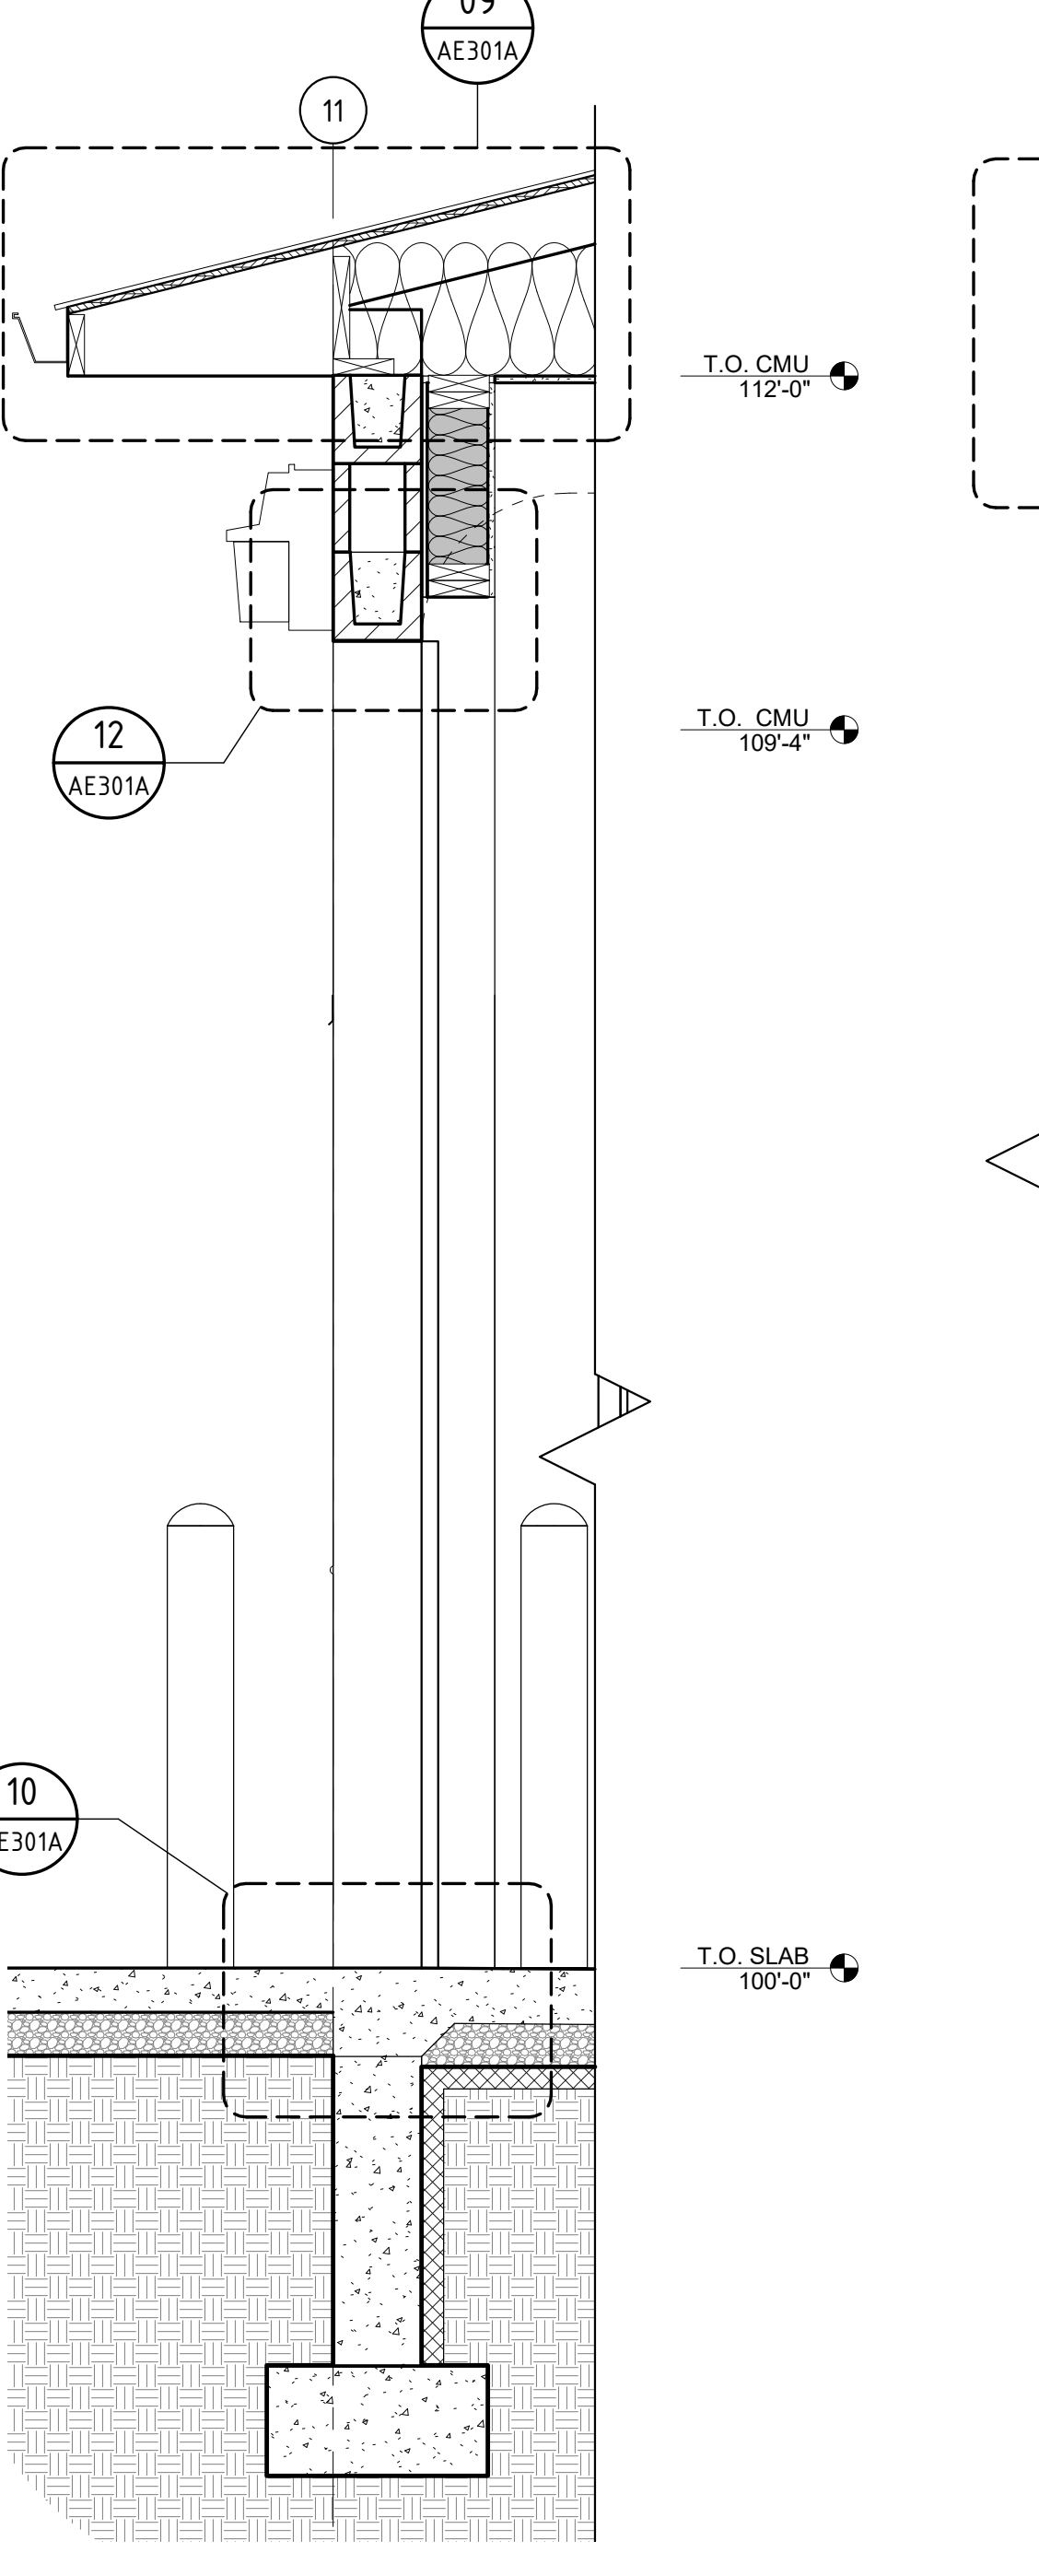
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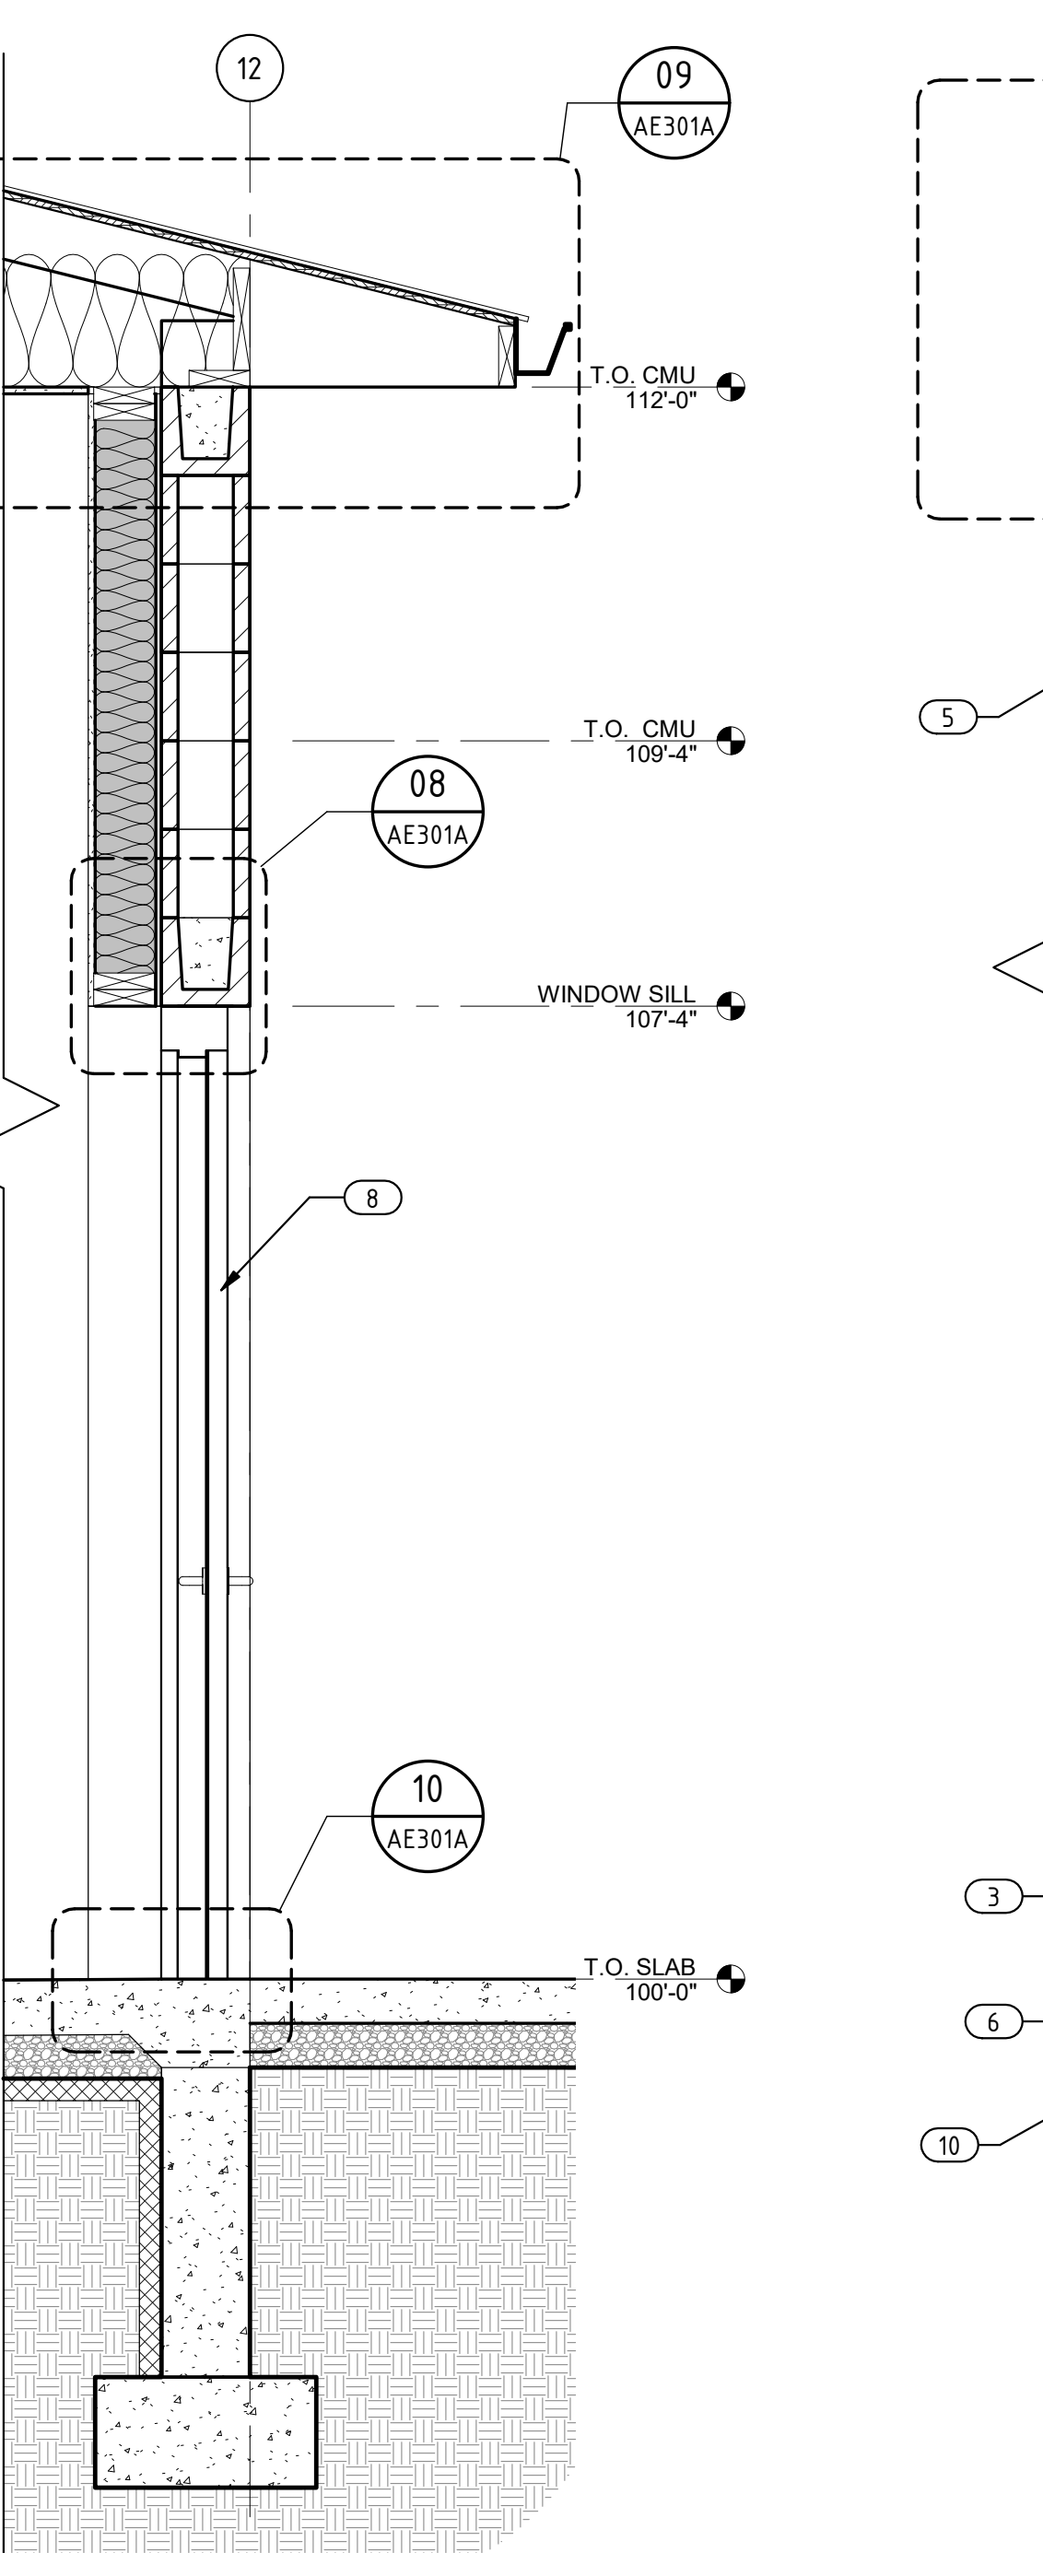
WINDOW HEADER DETAIL 06
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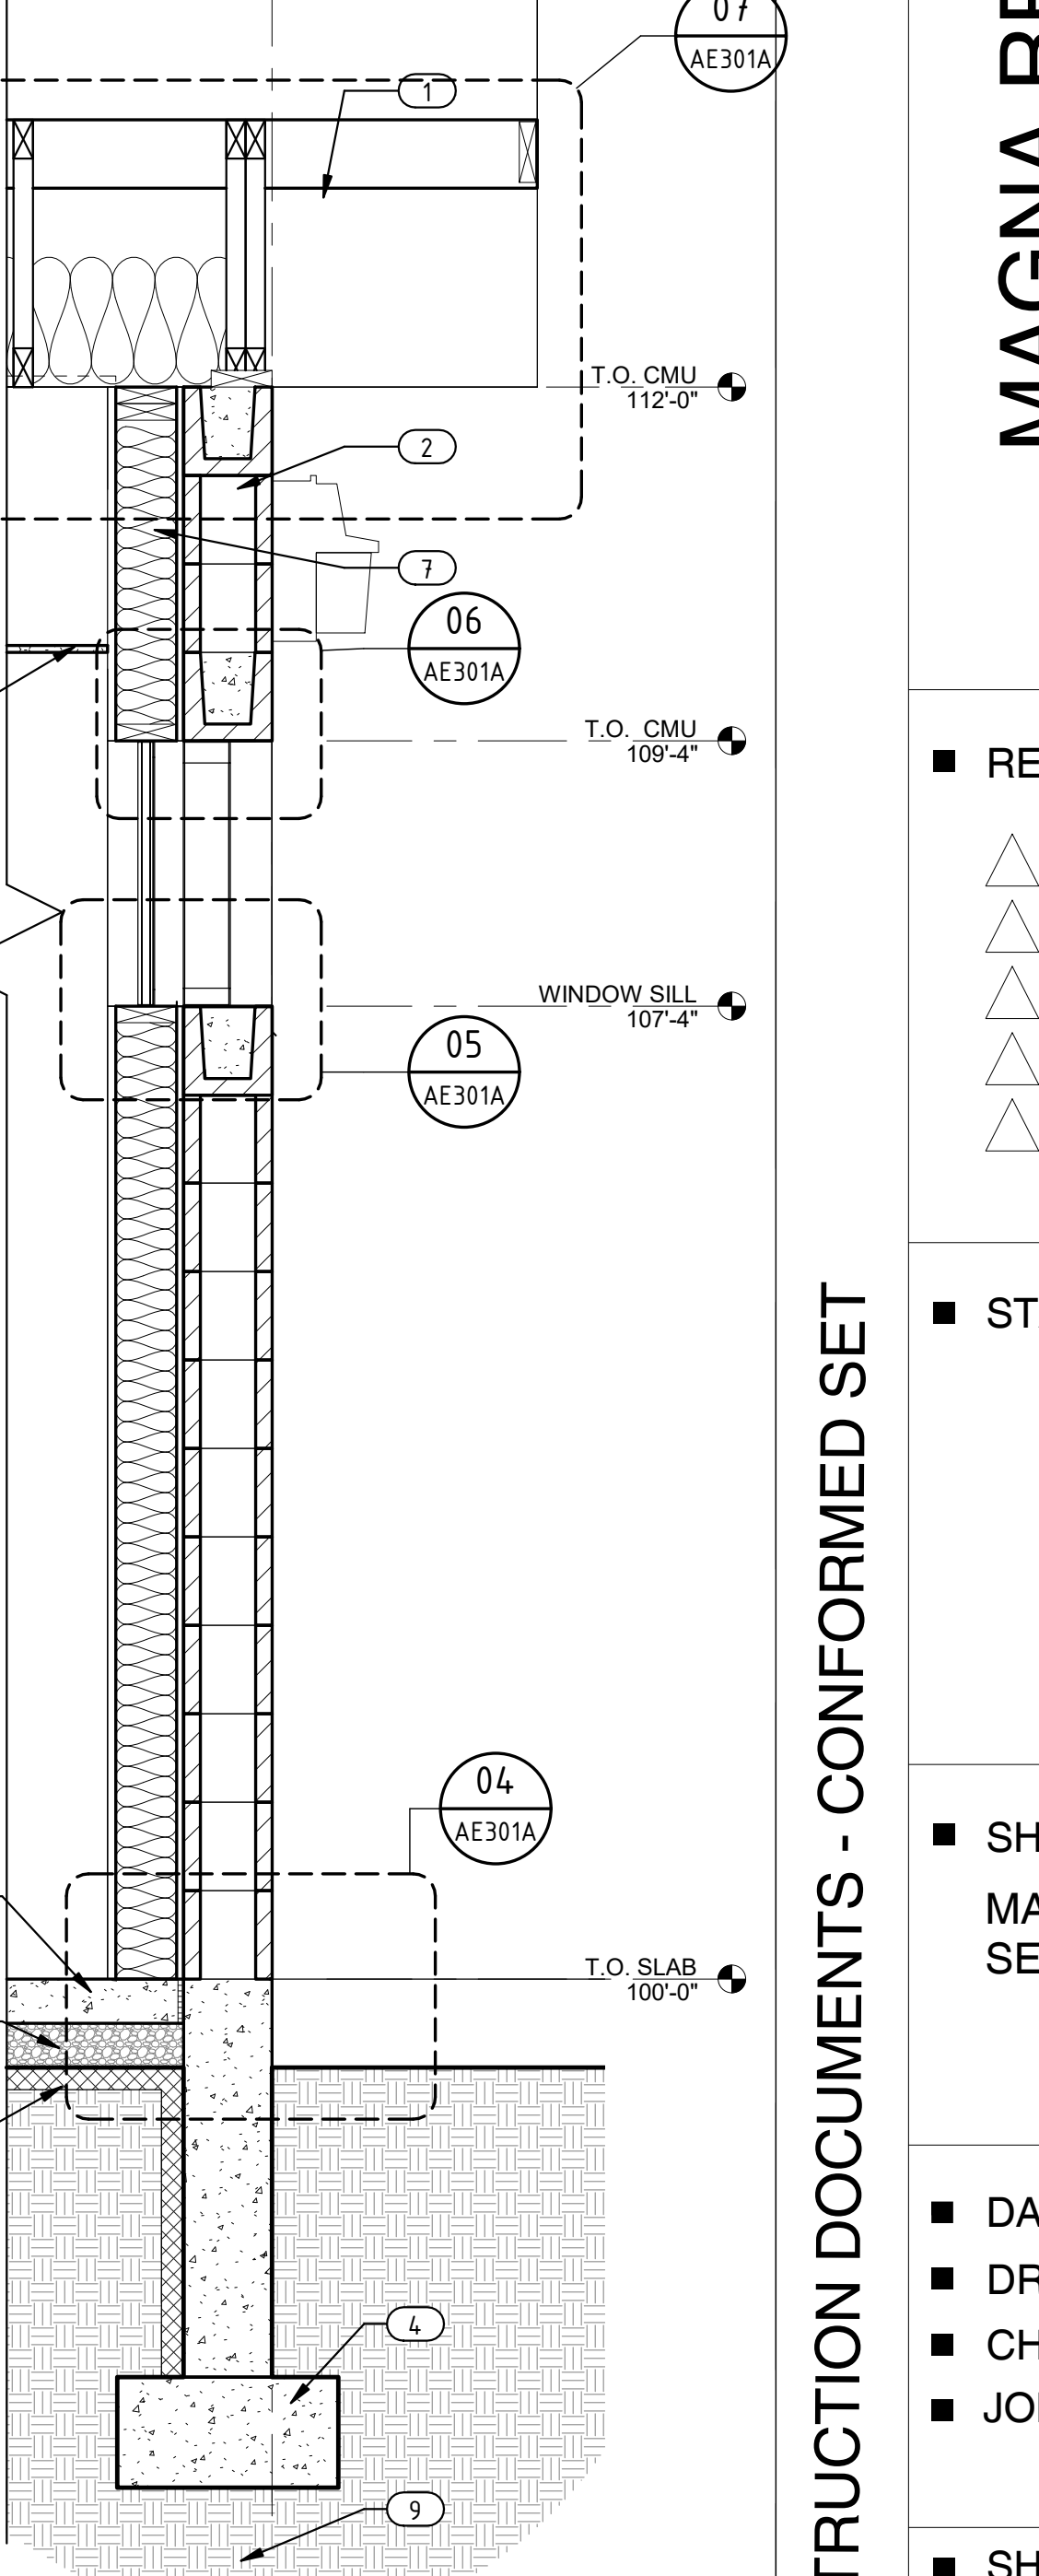
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WALL SECTION 1 11
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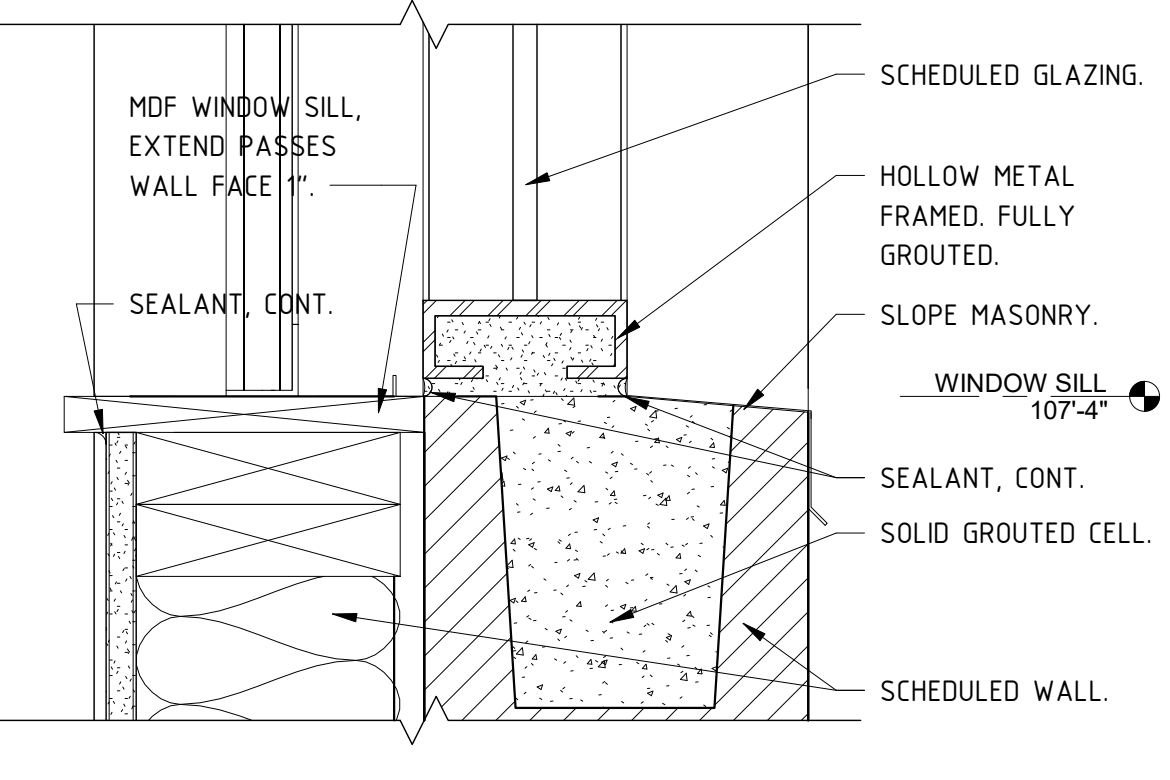
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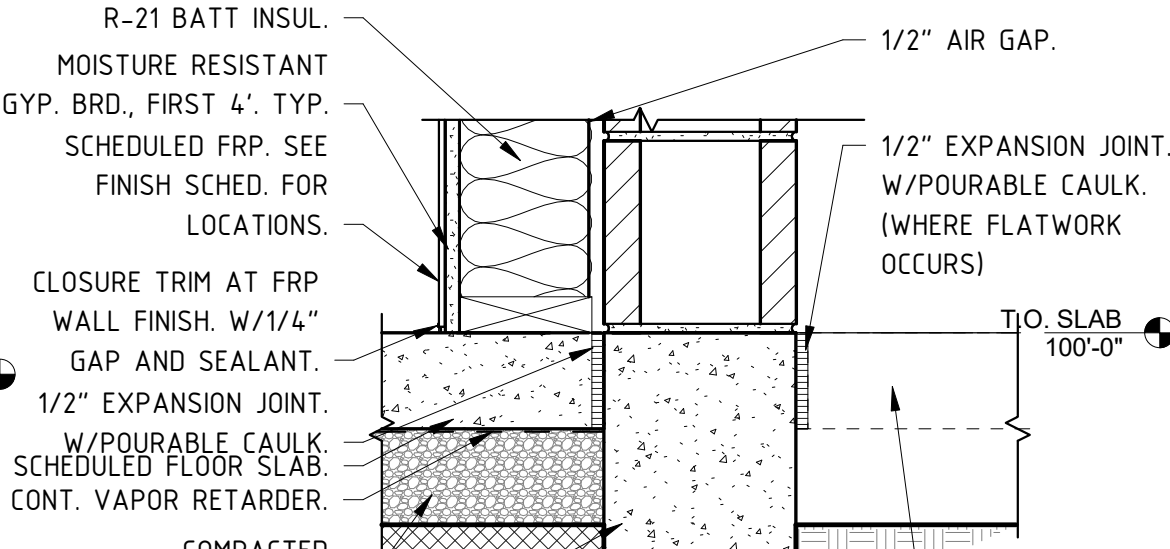
WALL SECTION 01 01
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DOOR THRESHOLD DETAIL 10
 SCALE: 3" = 1'-0" AE301A

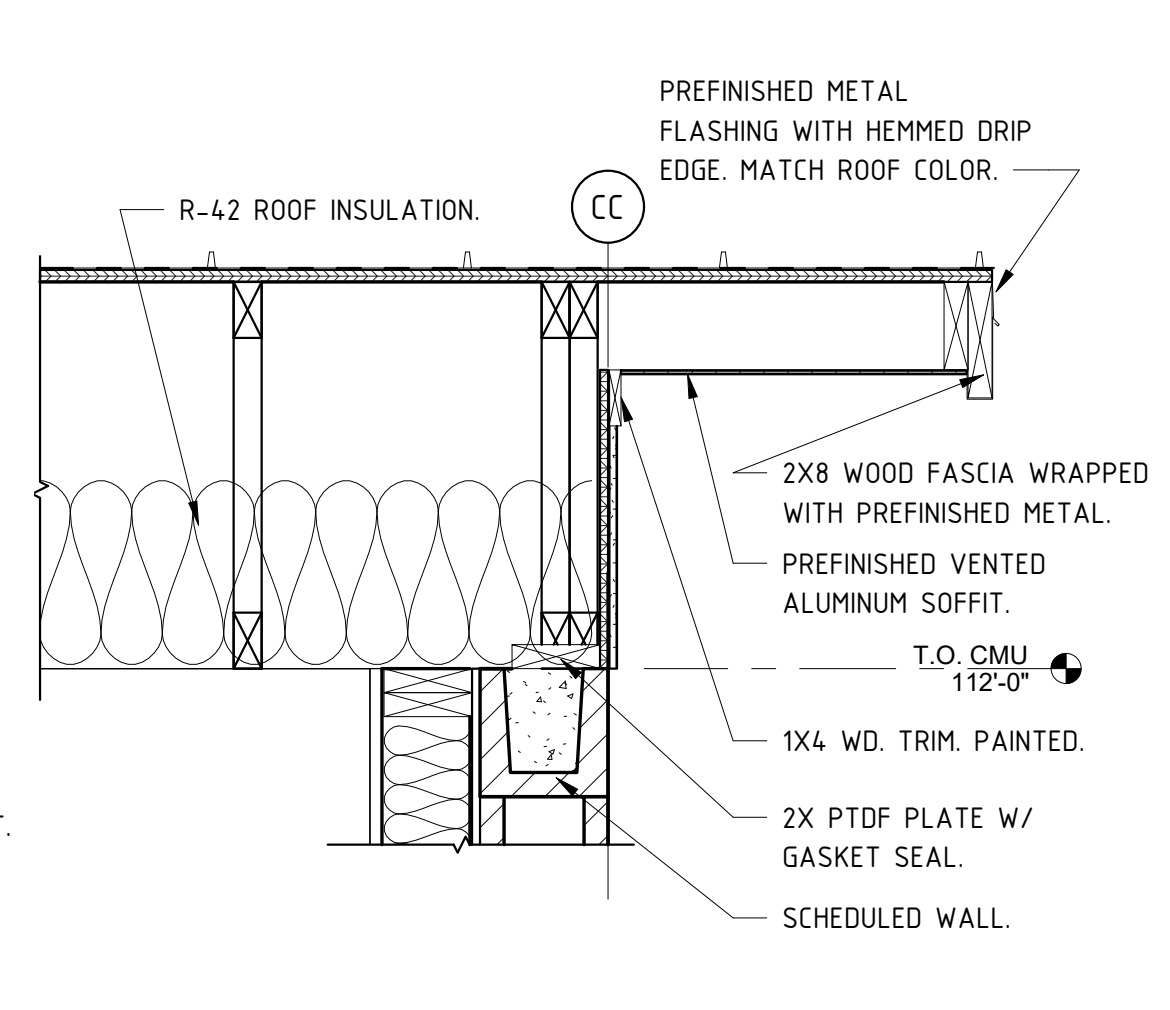

WINDOW SILL DETAIL 05
 SCALE: 3" = 1'-0" AE301A

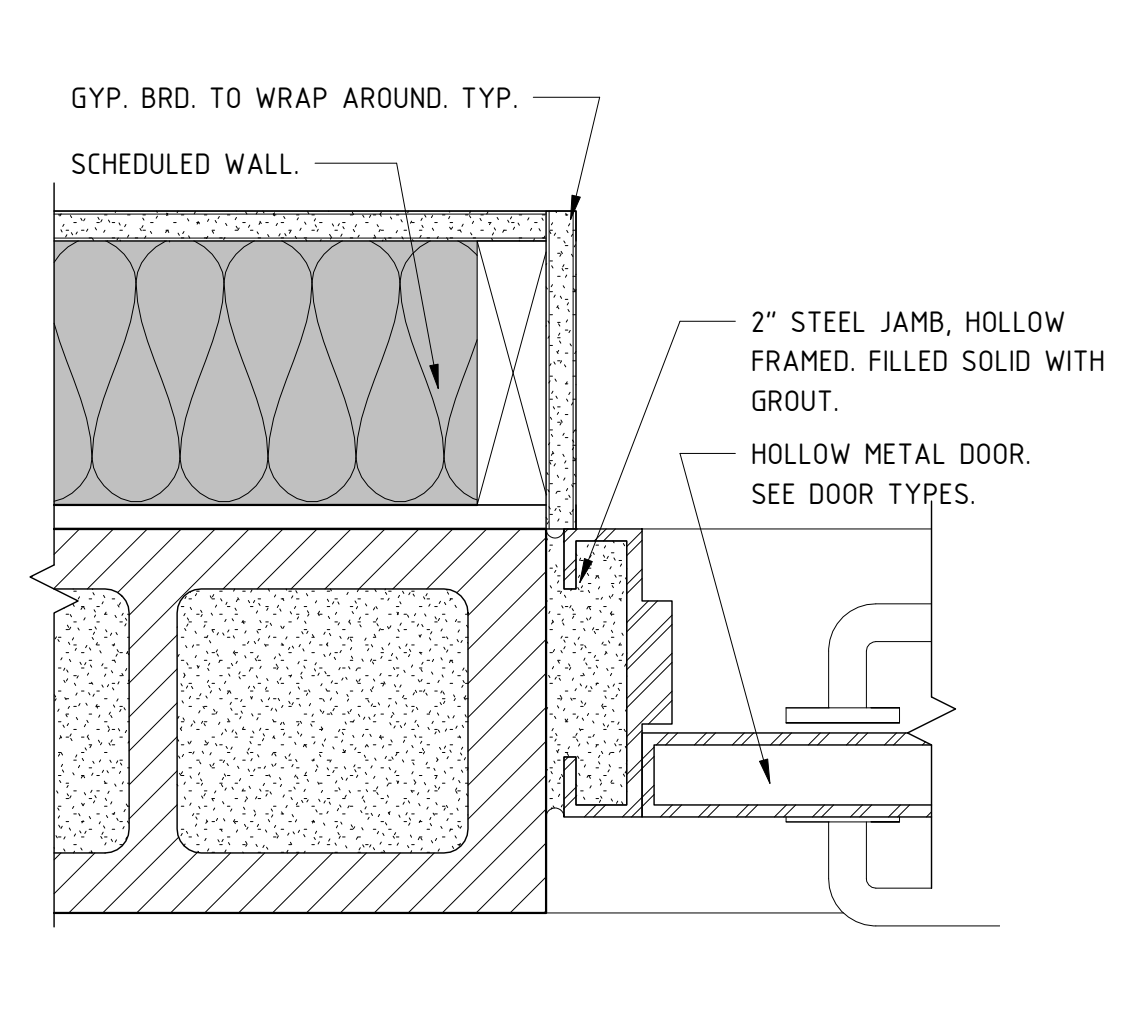

BASE OF WALL DETAIL 04
 SCALE: 1 1/2" = 1'-0" AE301A

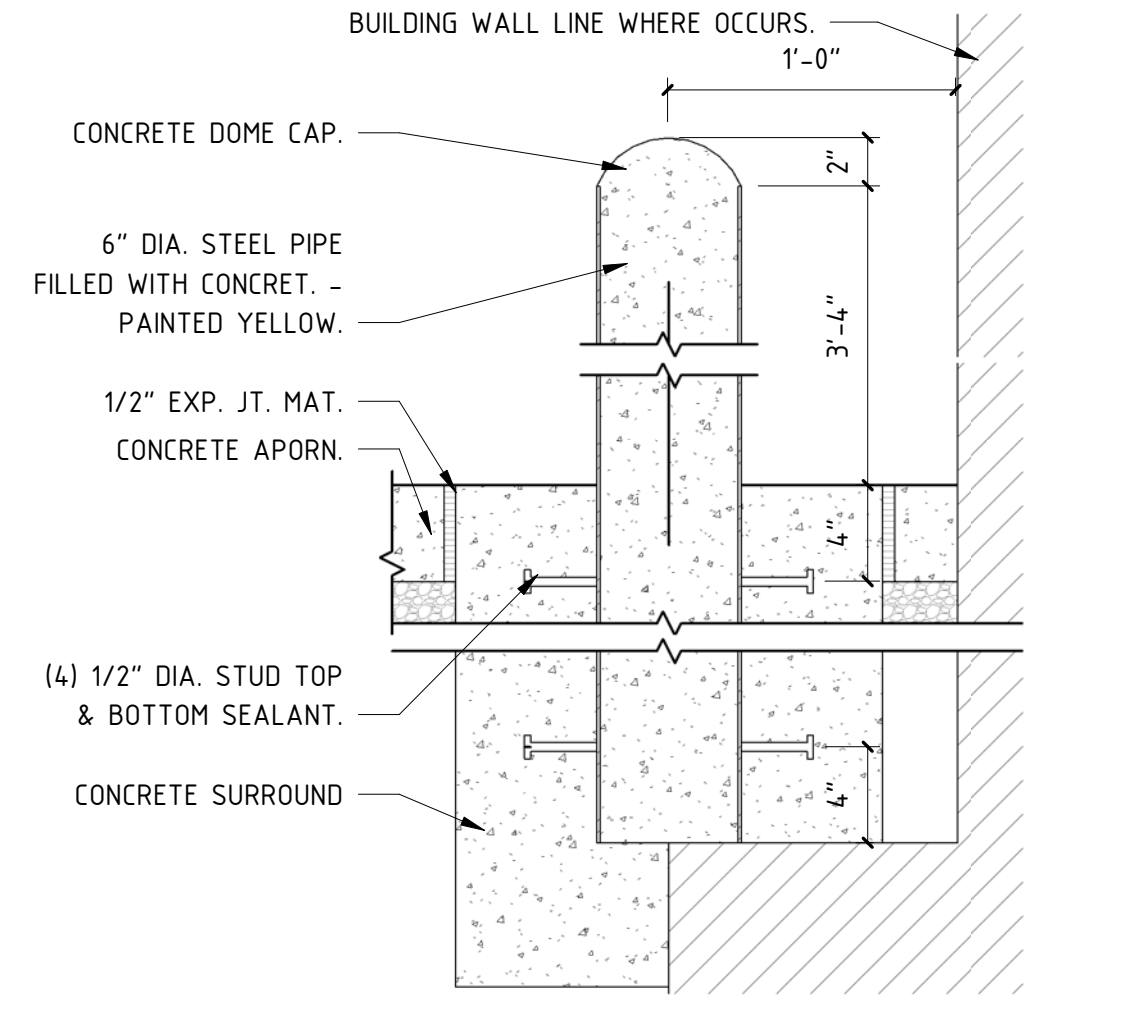GENERAL NOTES AND LEGEND:

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KEYED NOTES:

- PRE-FINISHED STANDING SEAM METAL ROOFING OVER FULL ICE & WATER SHIELD, TYPICAL AT STANDING SEAM ROOF.
- 8"X8"X16" CONCRETE MASONRY UNIT, PAINTED AND ANTI GRAFITI SEAL.
- CONCRETE SLAB, CLEAR SEALED.
- STRUCTURAL FOUNDATION AND FOOTING, SEE STRUCTURAL.
- SCHEDULED CEILING FINISH, REFER TO FINISH SCHEDULE.
- 4" COMPACTED GRANULAR FILL.
- R-21 BATT INSULATION, TYP. IN EXTERIOR WALLS.
- DOOR, SEE DOOR SCHEDULE ON AE601.
- SOILS REQUIREMENTS UNDER FOOTING - SEE GENERAL NOTE 1.
- 2" EPS INSULATION.

- REVISIONS:**
- △
 - △
 - △
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SHEET TITLE:
 MAINT. BLDG. WALL SECTIONS AND DETAILS

DATE: 7-22-19
DRAWN BY: CKG
CHECKED BY: DW
JOB NO.: U17-021

SHEET NO.: AE301A

CONSTRUCTION DOCUMENTS - CONFORMED SET



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 FOR COMPLIANCE WITH THE APPLICABLE CONSTRUCTION CODES IDENTIFIED BELOW
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 ELECTRICAL ENERGY
 ACCESSIBILITY FIRE
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 BY: *[Signature]* DATE: 11/13/19
 WEST COAST CODE CONSULTANTS, INC.

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KEYED NOTES:

- 1 STRUCTURAL FOUNDATION AND FOOTING. SEE STRUCTURAL.
- 2 CIP FOOTING AND FOUNDATION WALL W/ DAMPROOFING. SEE STRUCTURAL FOR DESIGN AND DEPTH. TYP.
- 3 R-30 FIBERGLASS INSULATION W/VAPOR RETARDER.



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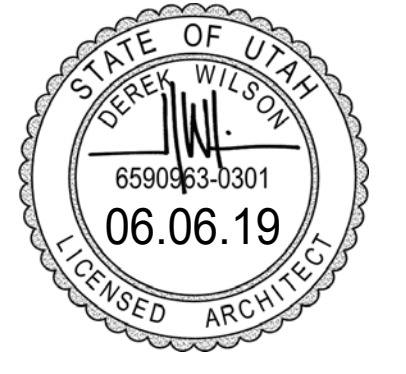
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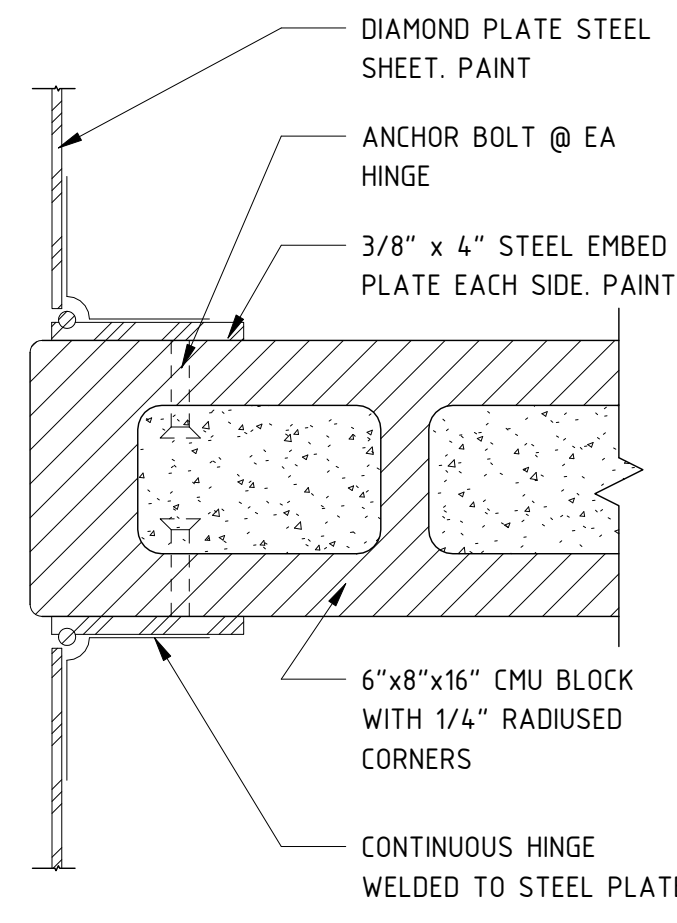
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 SECTIONS, WALL
 SECTIONS

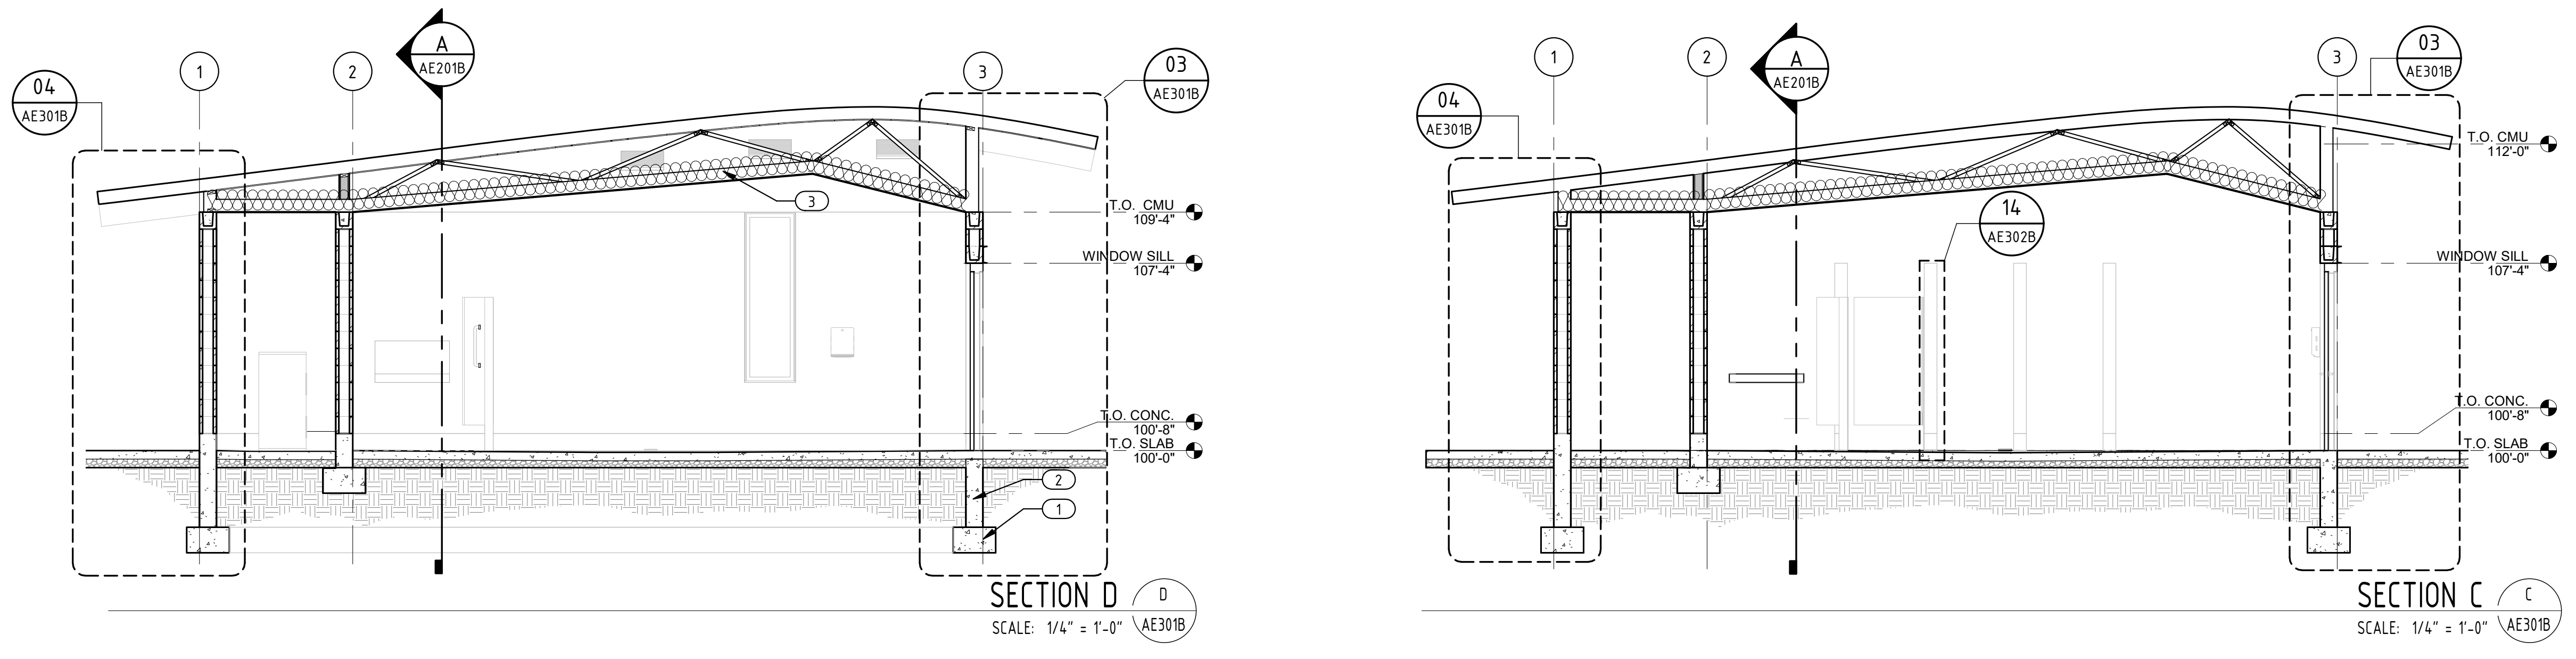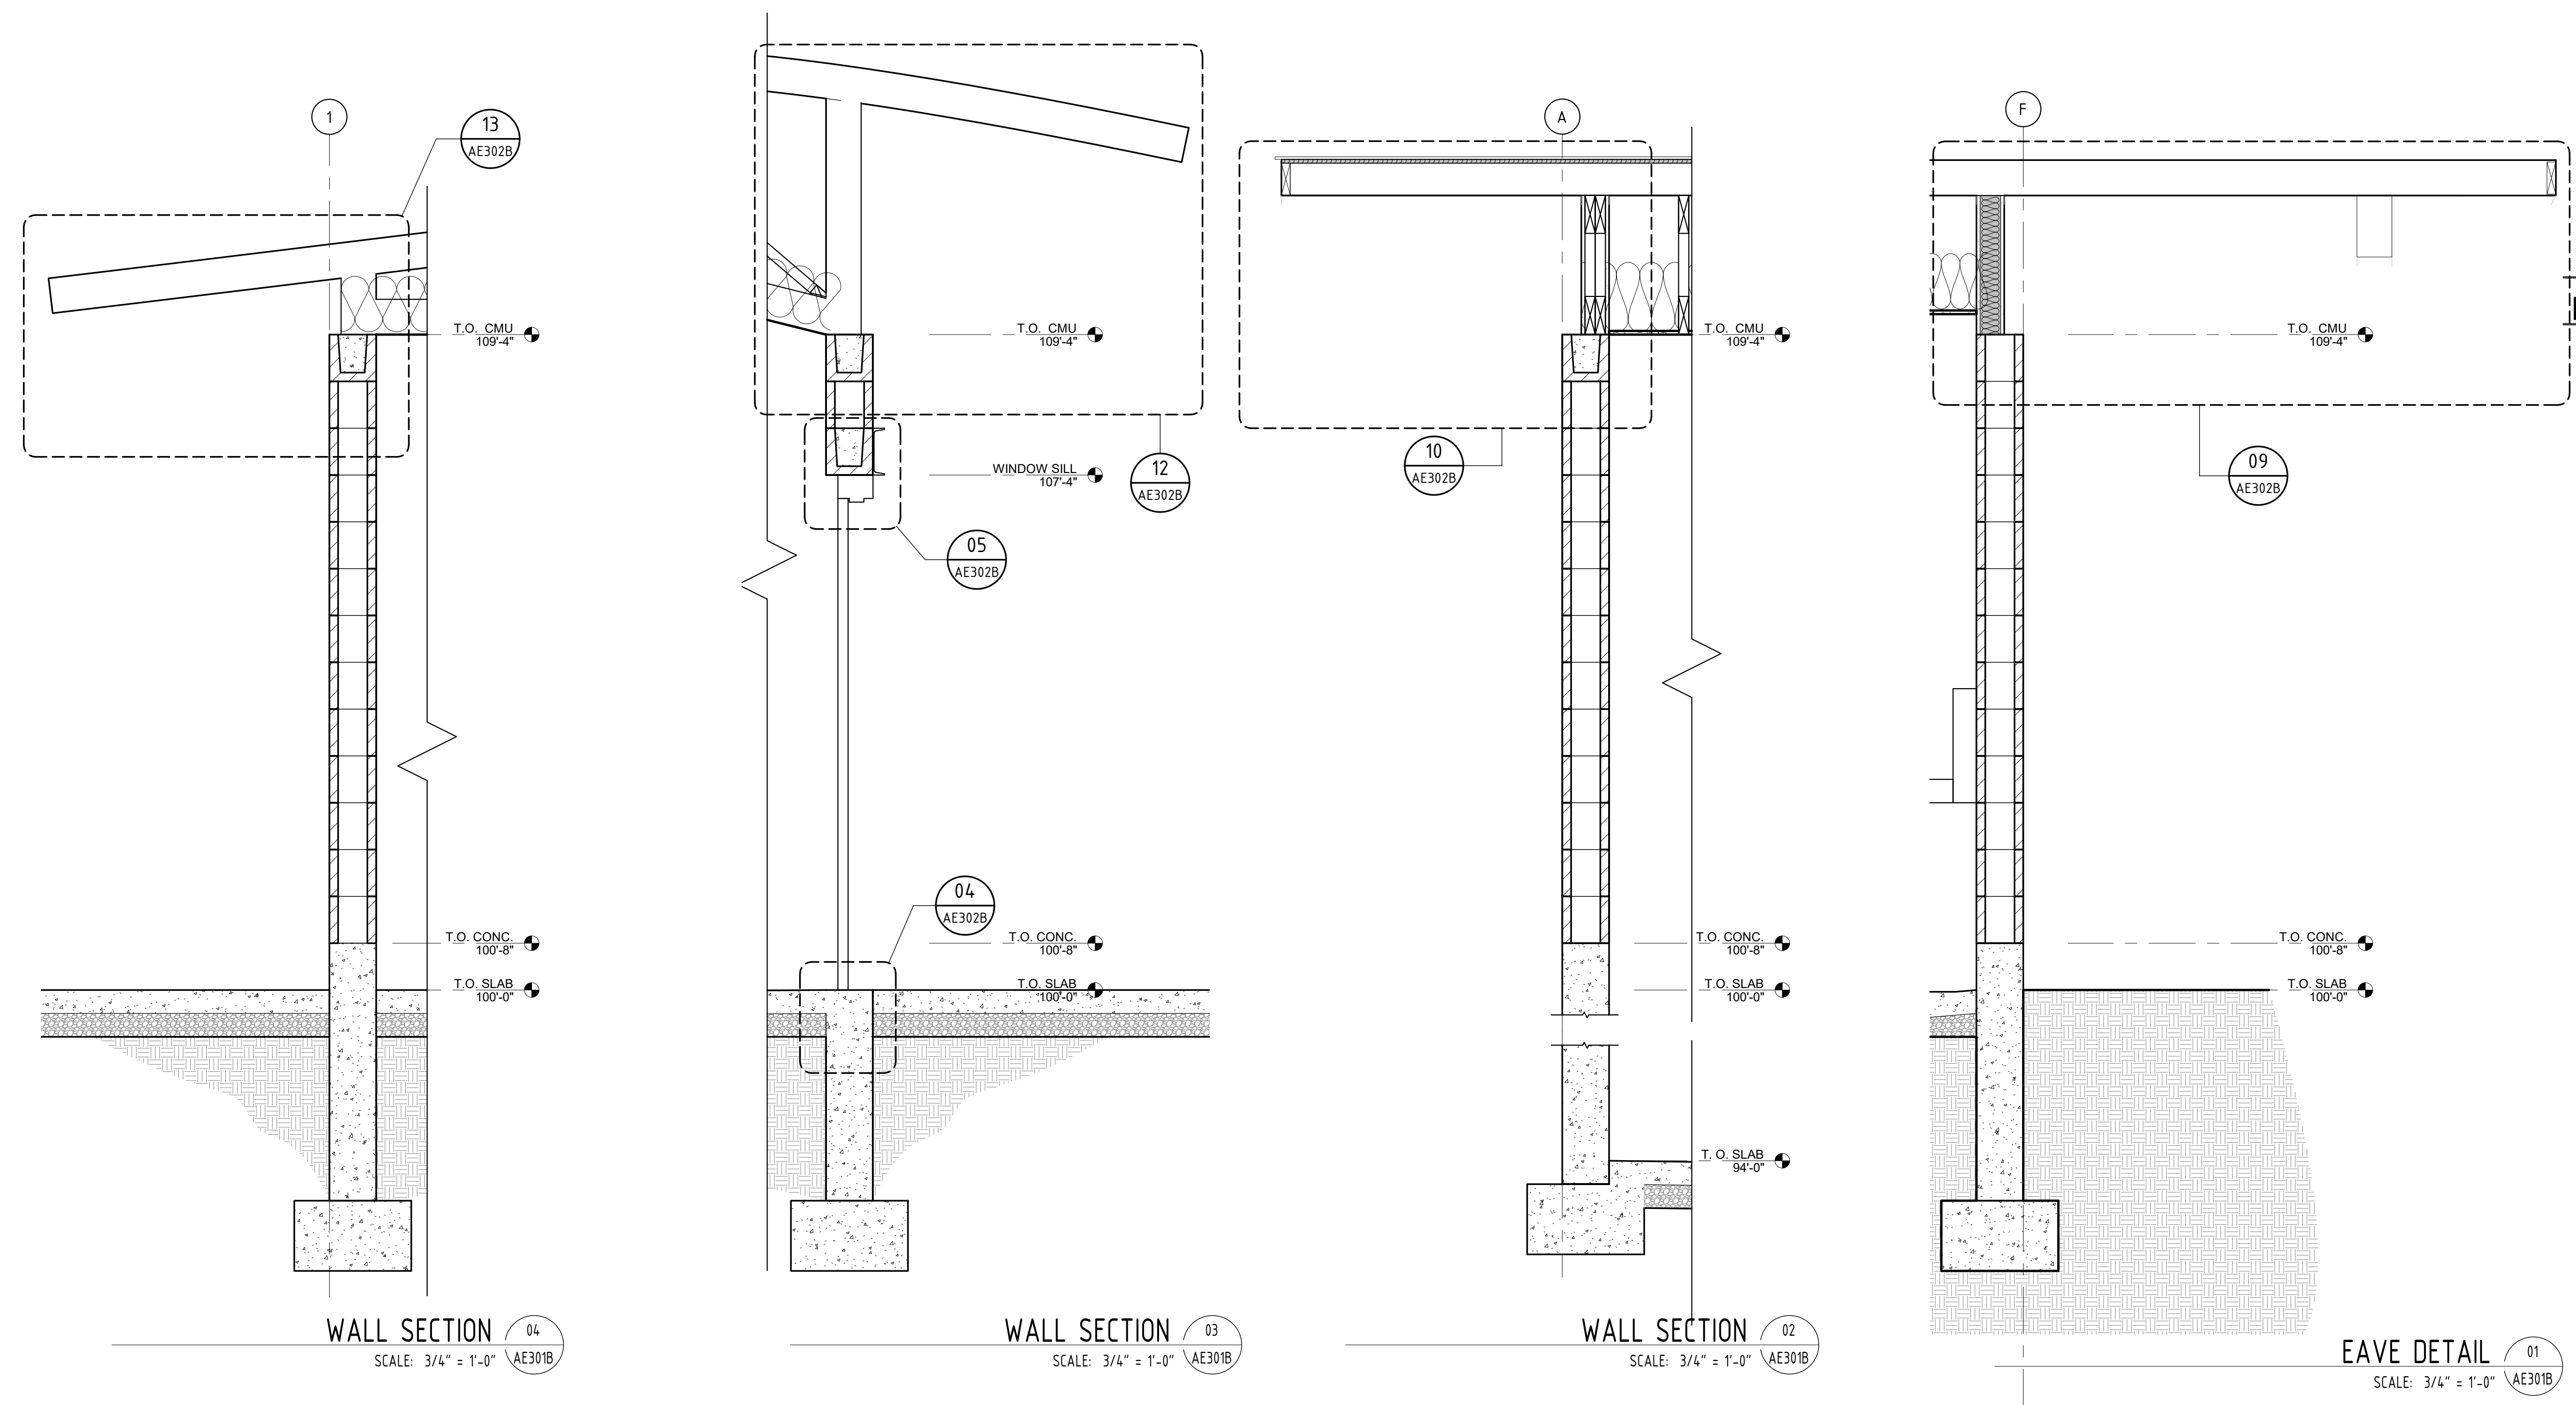DATE: 7-22-19
DRAWN BY: CKG
CHECKED BY: DW
JOB NO.: U17-021


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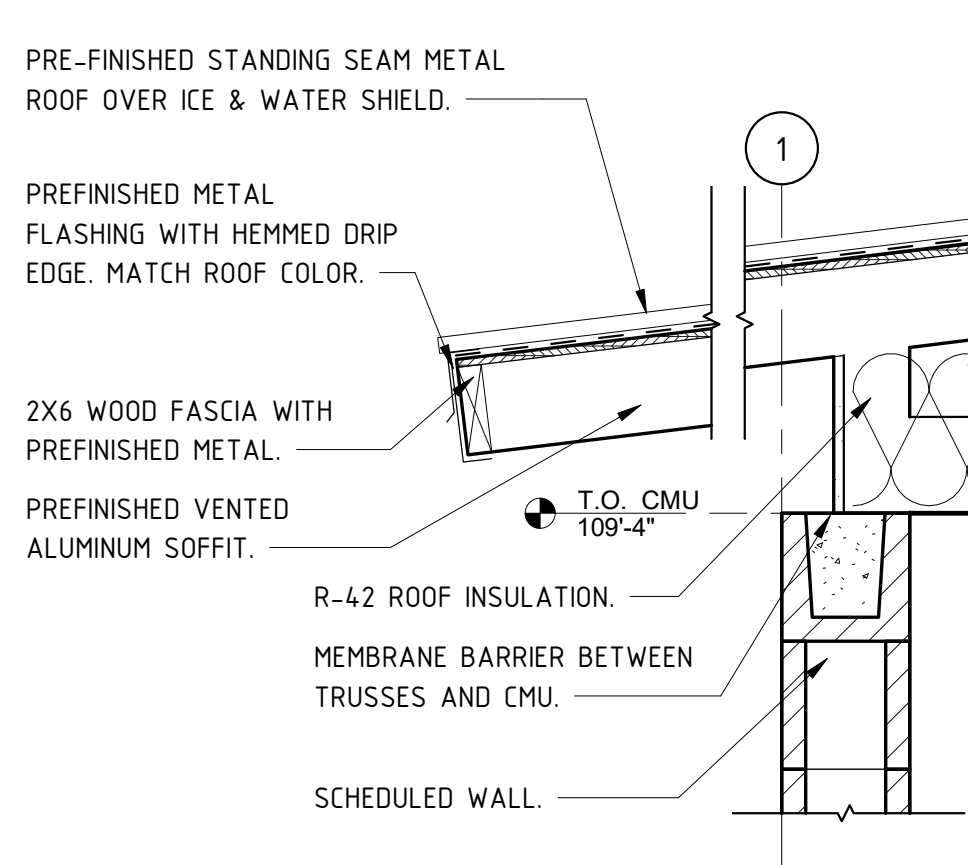
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 ELECTRICAL ENERGY
 ACCESSIBILITY FIRE
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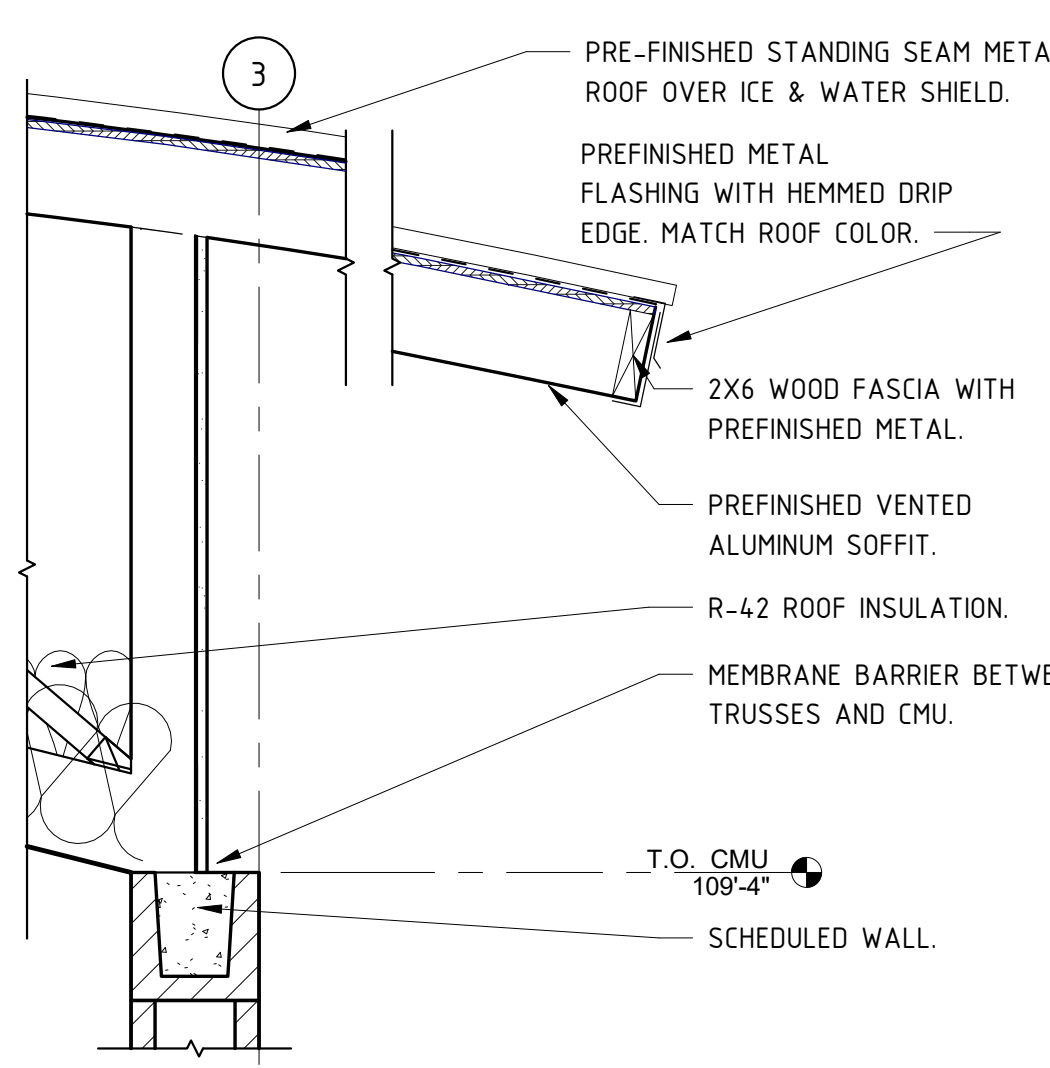
DOOR JAMB 15
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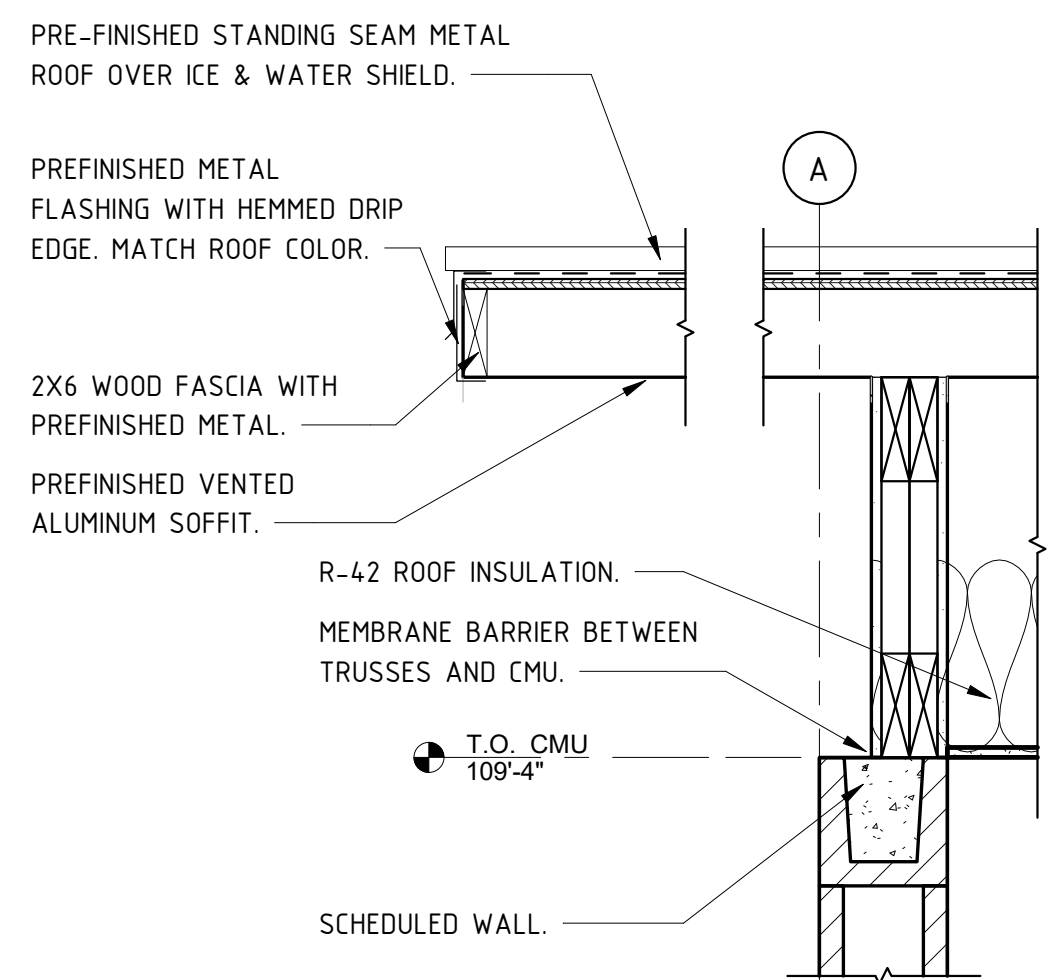
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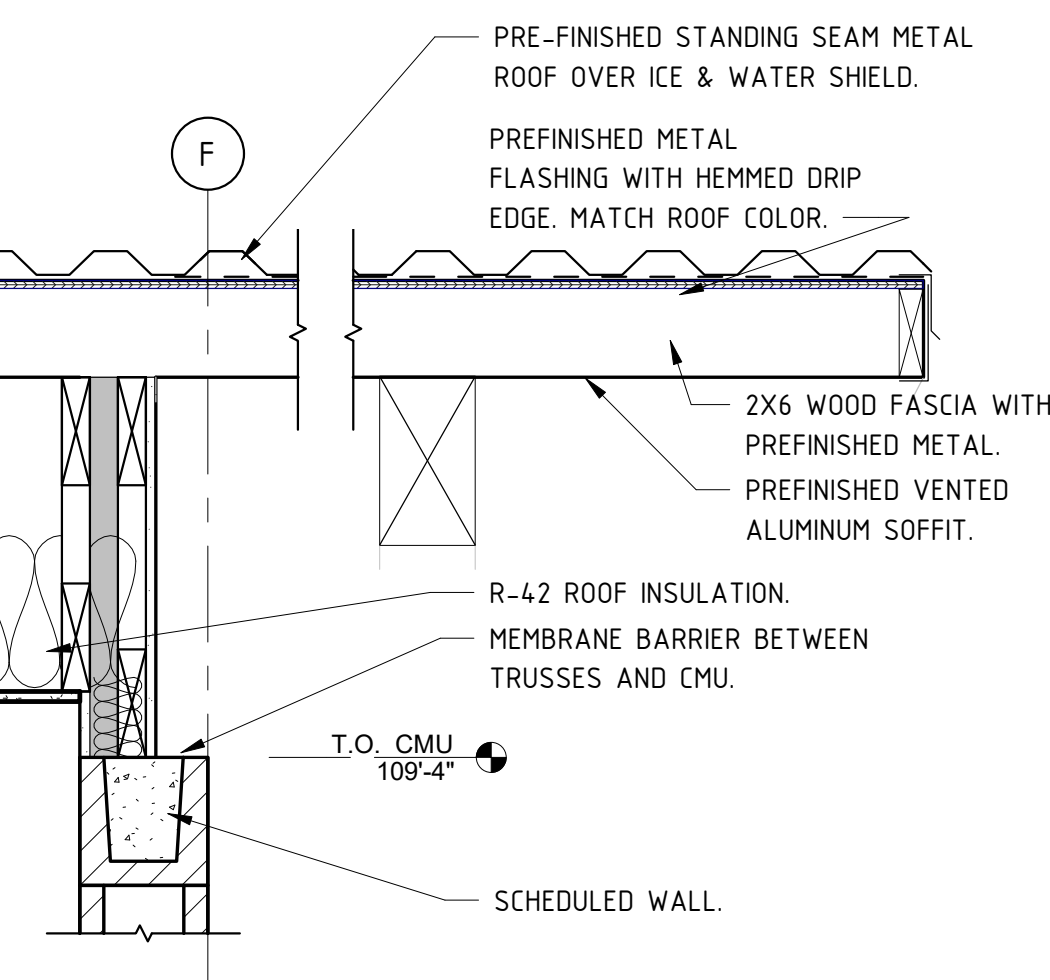
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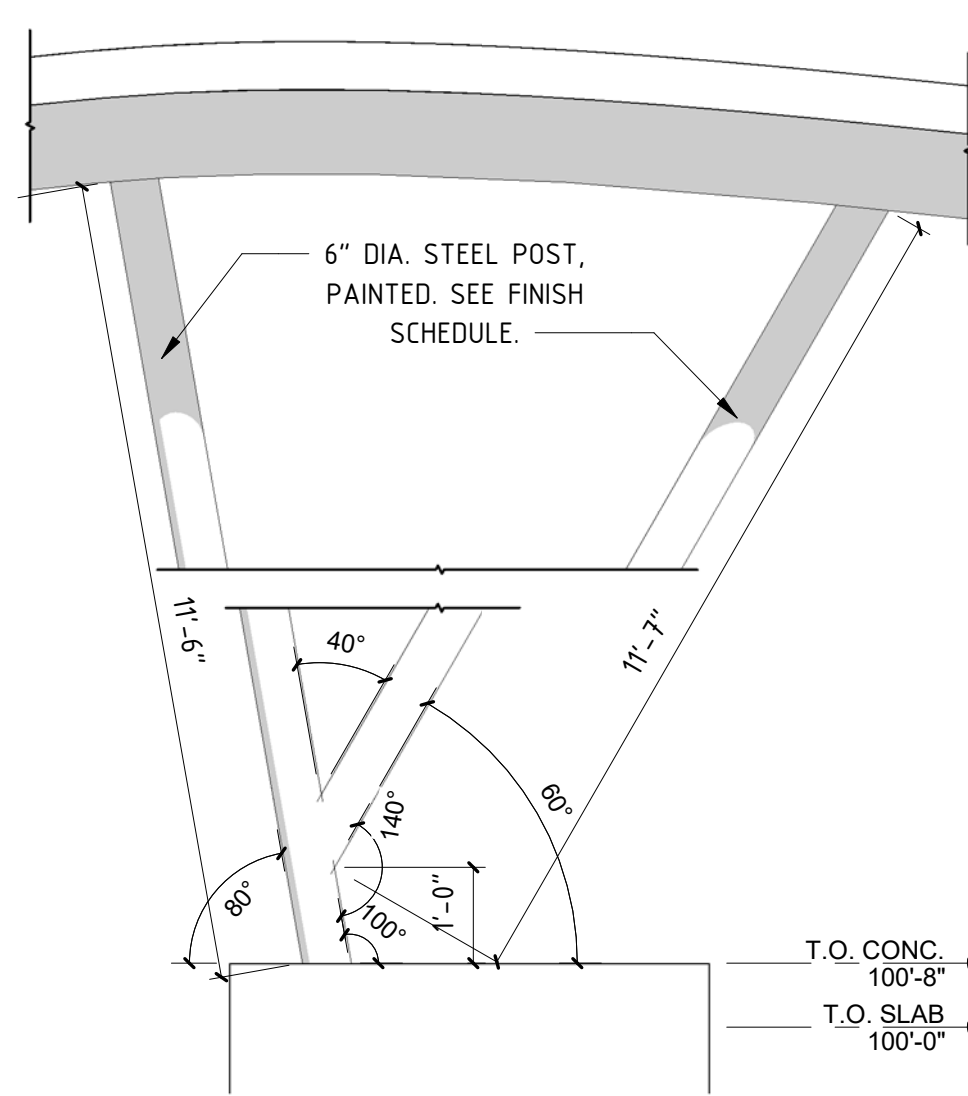
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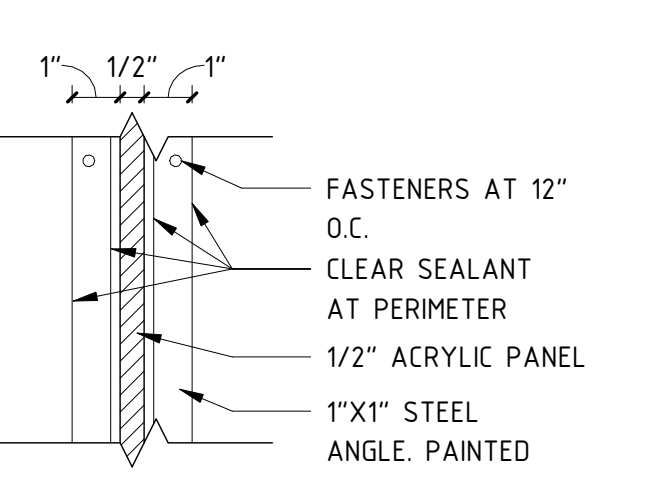
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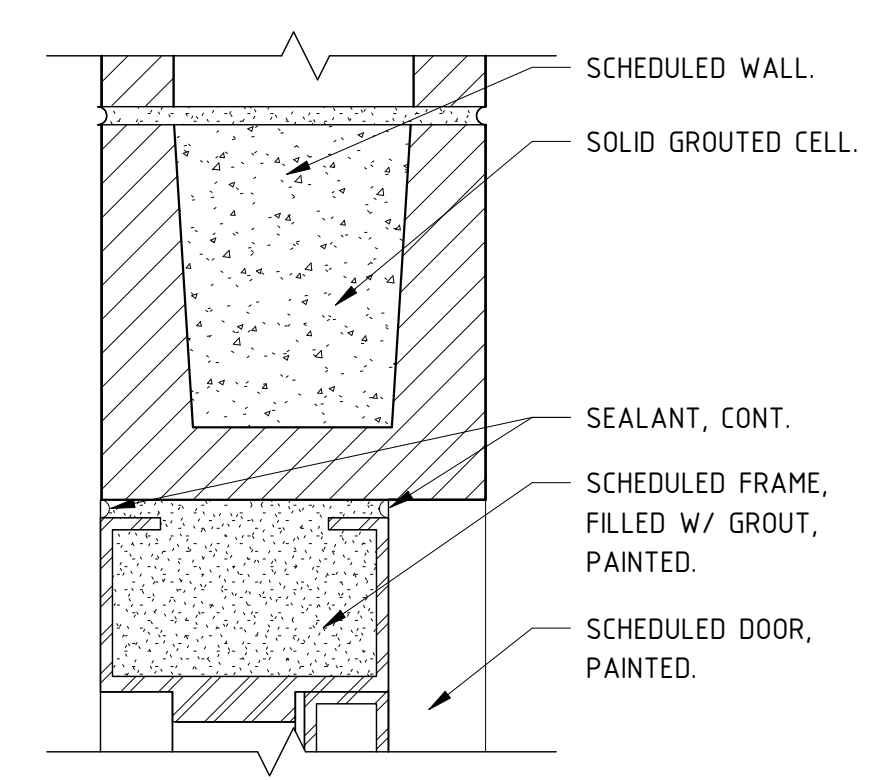
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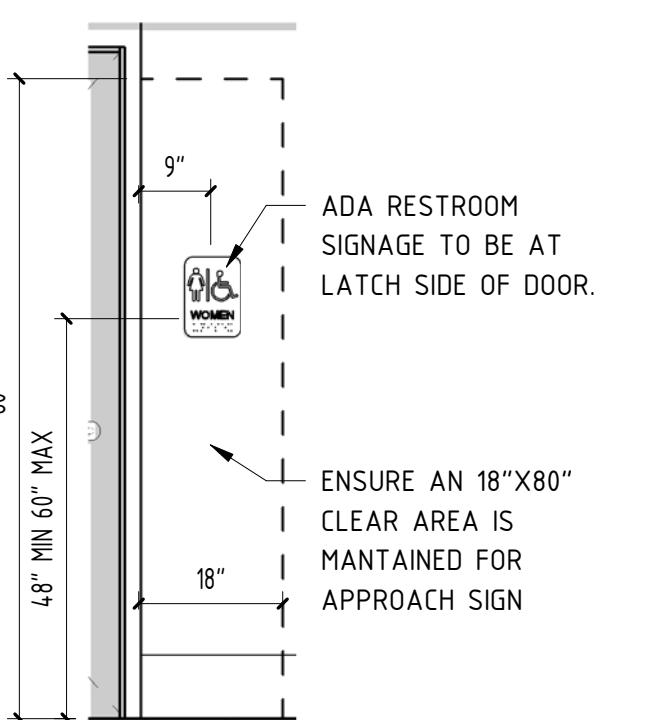
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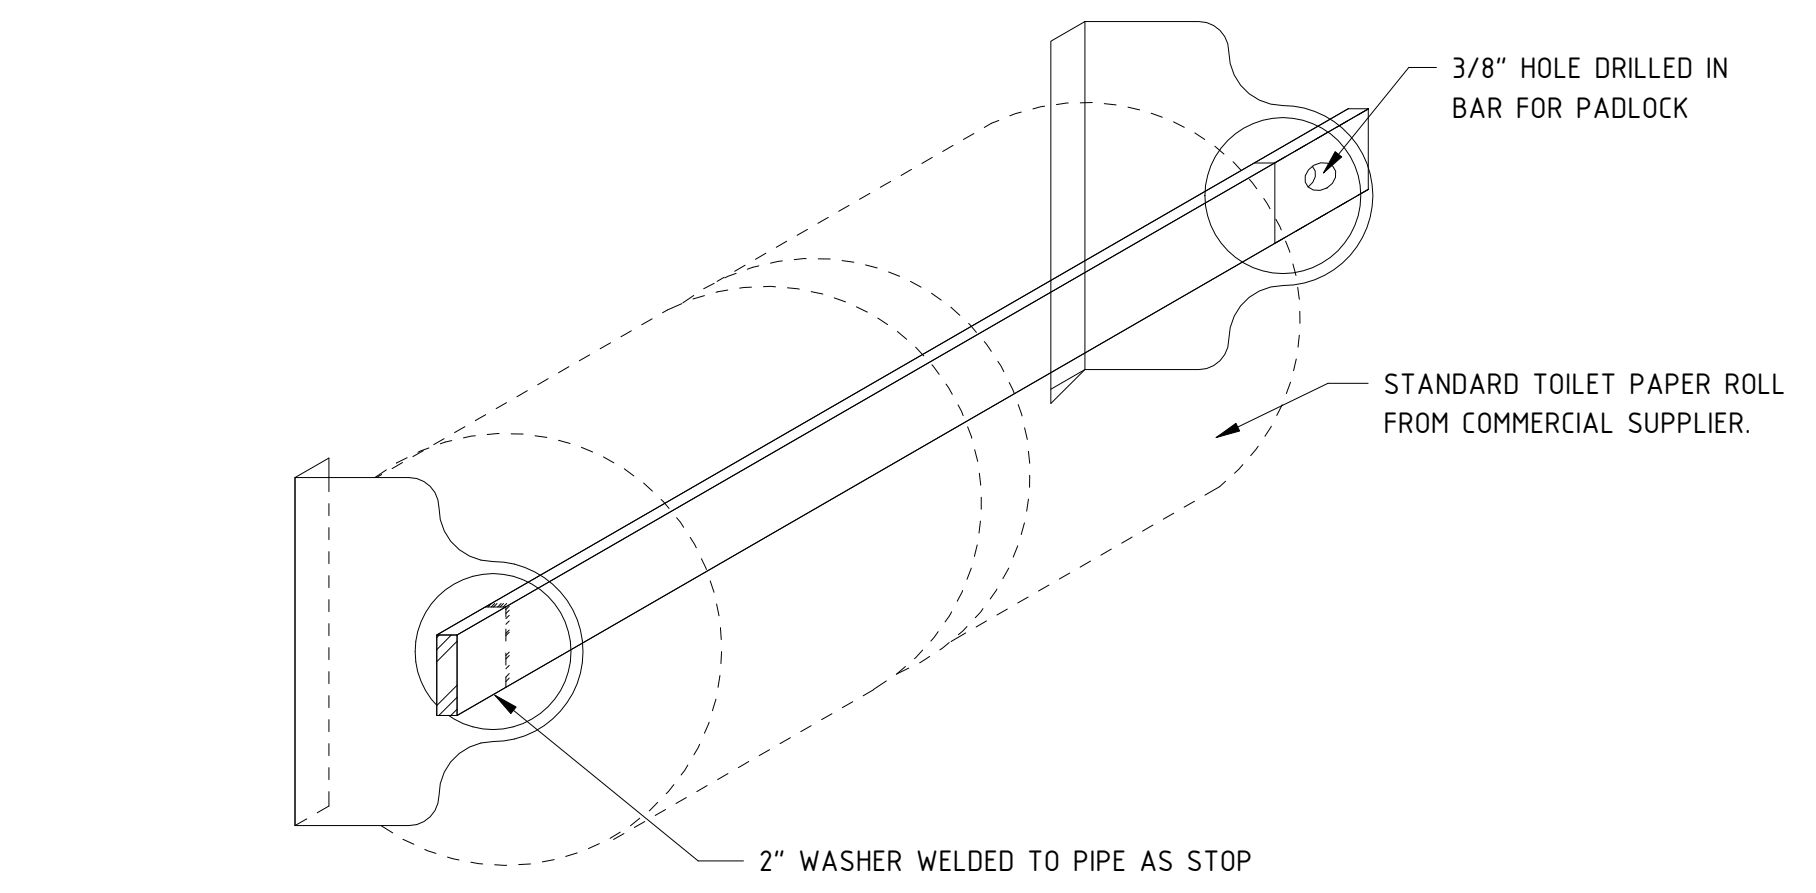
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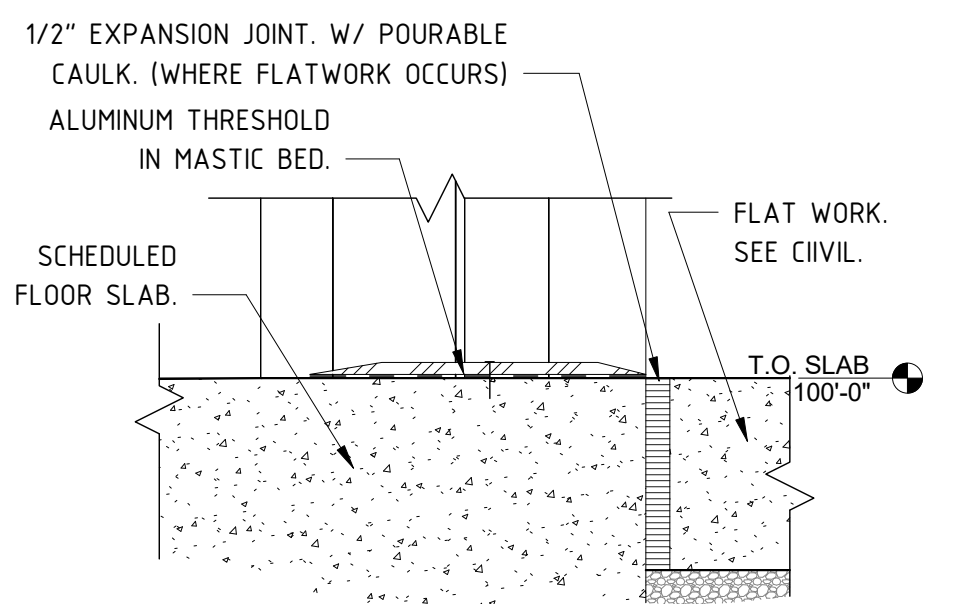
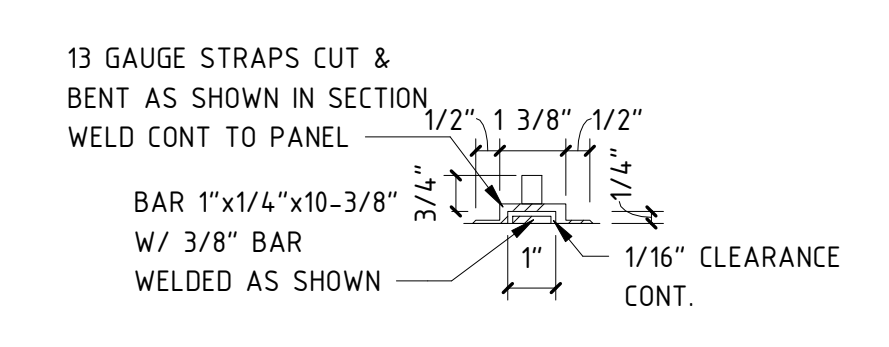
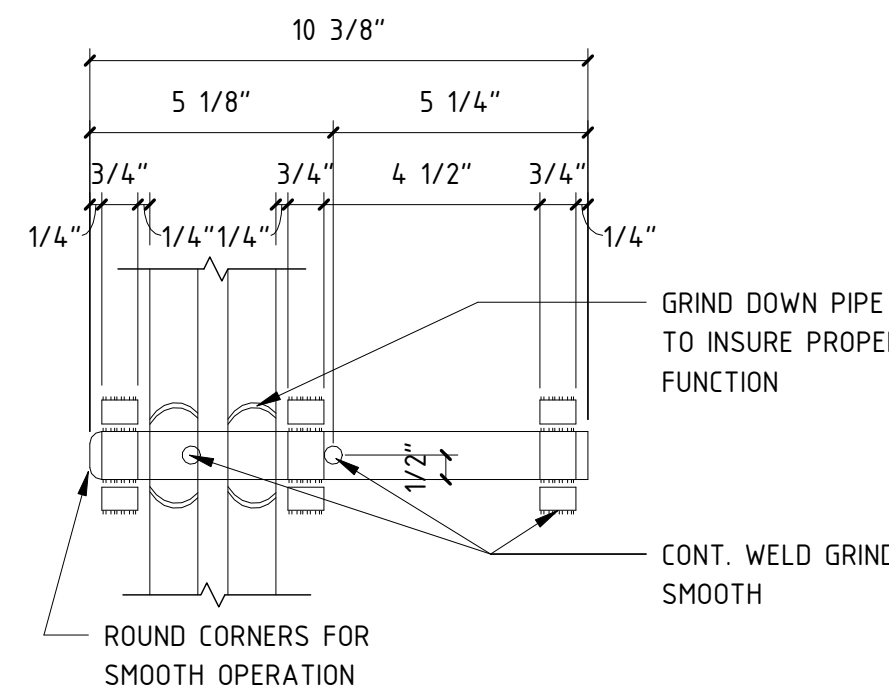
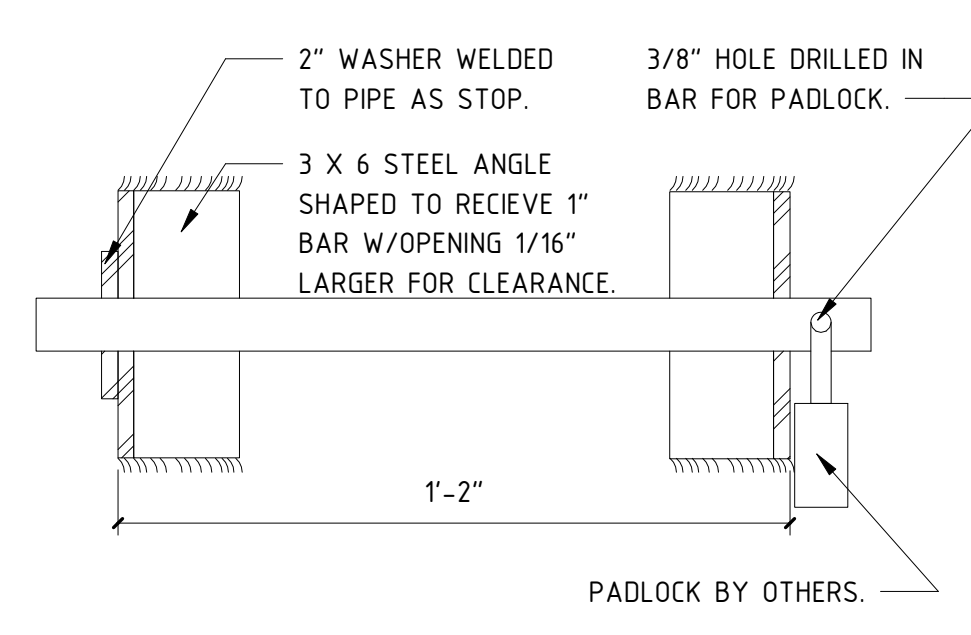
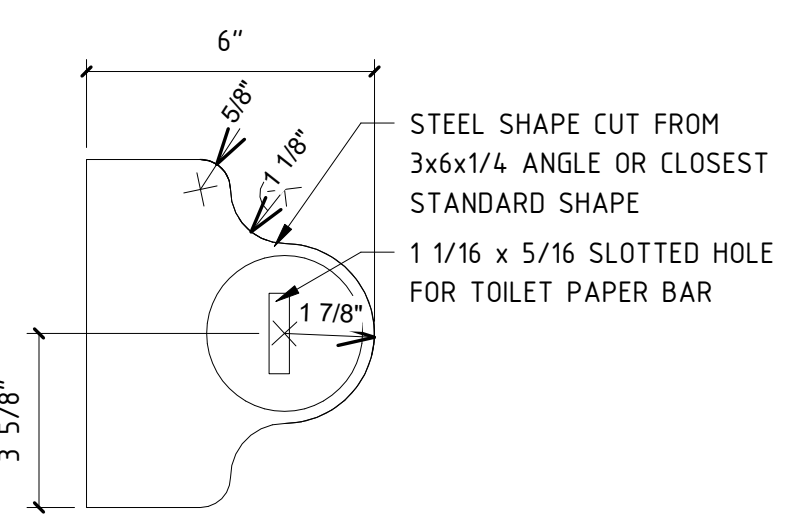
EXT. DOOR HEADER DETAIL 05
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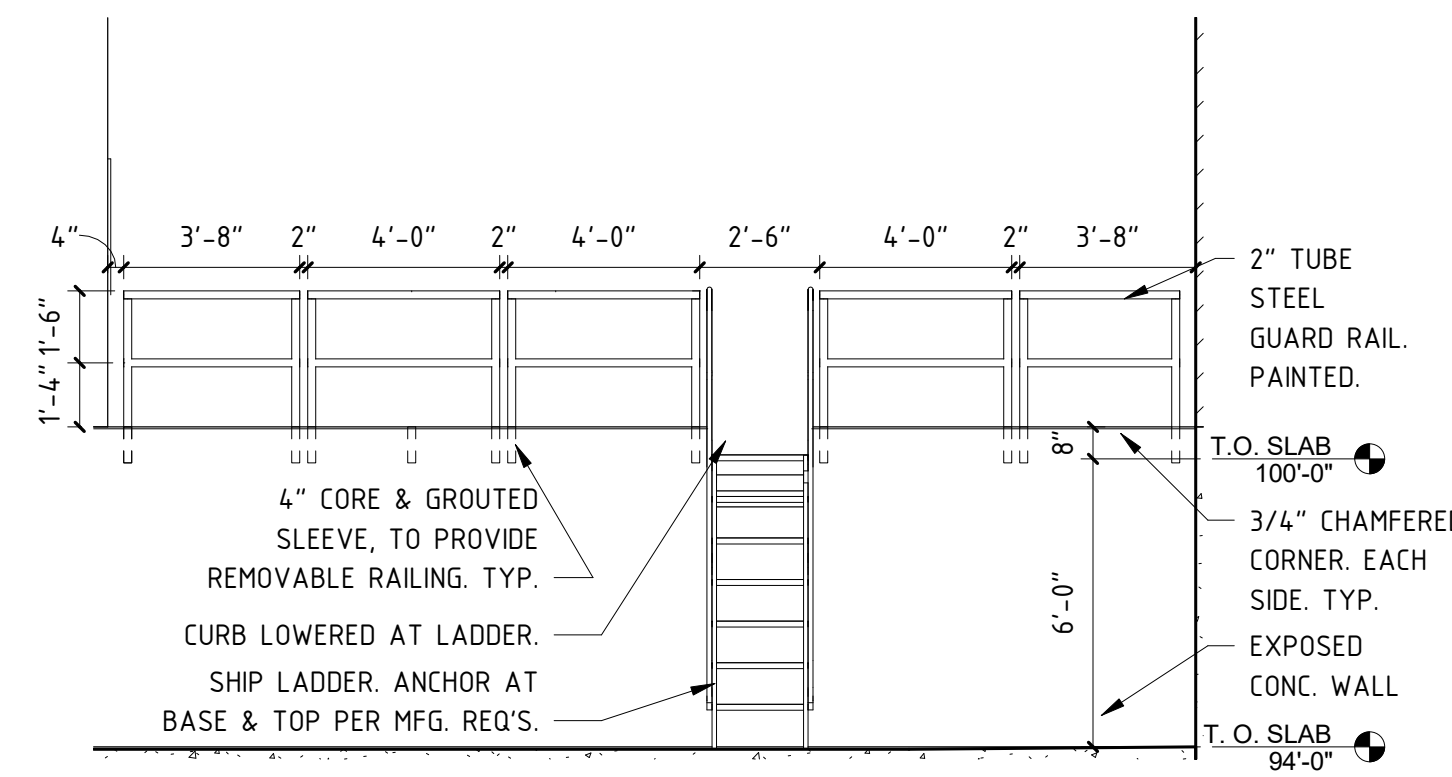
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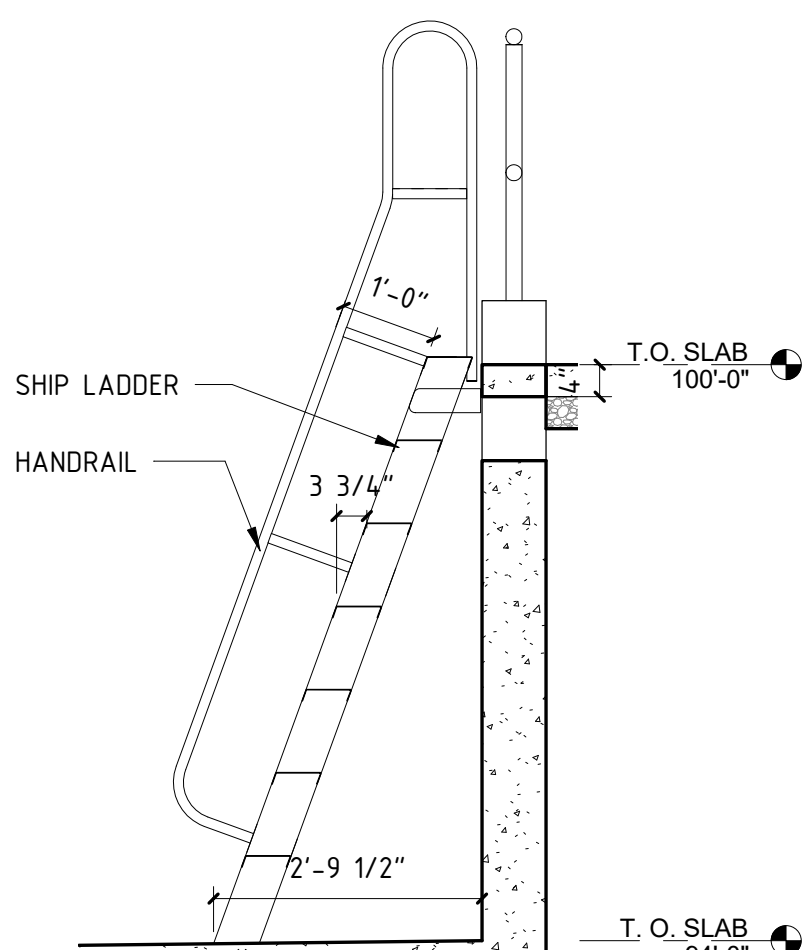
TOILET PAPER HOLDER 08
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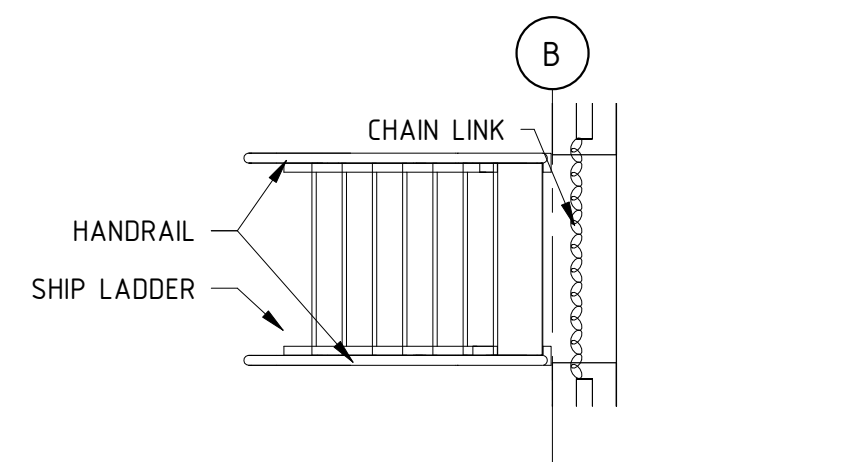
DOOR THRESHOLD DETAIL 04
 SCALE: 3" = 1'-0" AE302B



PUMP ROOM WALL ELEVATION 03
 SCALE: 1/4" = 1'-0" AE302B



SHIP LADDER ELEVATION 02
 SCALE: 1/2" = 1'-0" AE302B

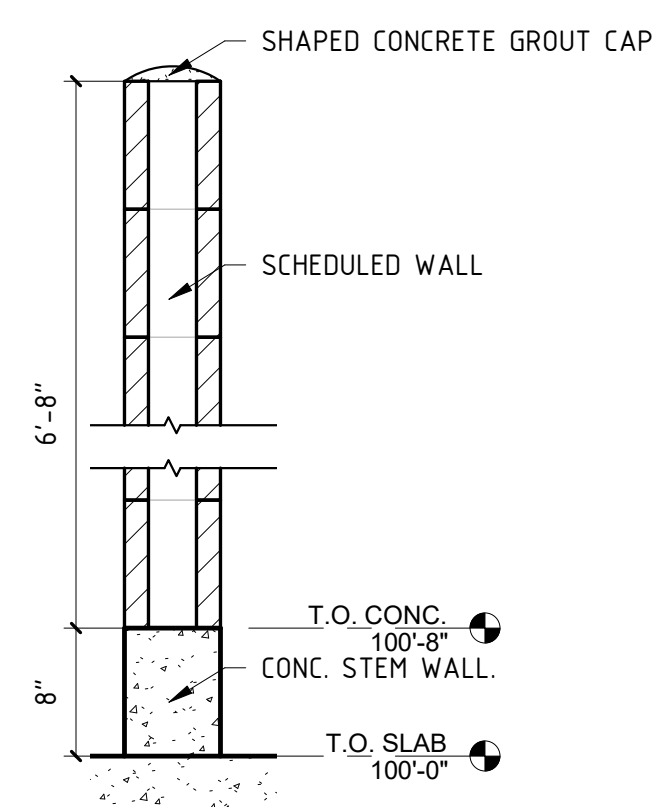

ENLARGED PLAN - SHIP LADDER 01
 SCALE: 1/2" = 1'-0" AE302B

GENERAL NOTES AND LEGEND:
 SEE SHEET AE001 FOR GENERAL NOTES.
 SEE TITLE SHEET FOR DRAWING INDEX.
 DO NOT SCALE DRAWINGS.
 CONTRACTOR / SUBCONTRACTOR SHALL VERIFY ALL DIMENSIONS AND CONDITIONS BEFORE BEGINNING WORK, AND SHALL REPORT TO THE ARCHITECT ANY ERRORS, INCONSISTENCIES OR OMISSIONS BEFORE BEGINNING WORK. SEE GENERAL NOTES AND SPECIFICATIONS.

G.B.D
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 SITE AND LANDSCAPE ARCHITECTS
 610 East South Temple, Ste 50
 Salt Lake City, Utah 84102
 p. 801.575.6066 f. 801.575.6166
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SALT LAKE COUNTY
 PARKS & RECREATION
 CONSULTANTS:
RANGE
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 3748 EAST HERMES DRIVE, SUITE 107, MIDVALE
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PHASE 1
 4042 SOUTH 7200 WEST
 MAGNA, UTAH 84044

REVISIONS:
 ▲ _____
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STAMP

 BRENT WILSON
 6590833001
 06.06.19
 LICENSED ARCHITECT

SHEET TITLE:
 EQUIP./RESTROOM BLDG. WALL DETS., ARCH DETS.

DATE: 7-22-19
 DRAWN BY: CKG
 CHECKED BY: DW
 JOB NO.: U17-021

SHEET NO:
 AE302B

CONSTRUCTION DOCUMENTS - CONFORMED SET

REVIEWED FOR CODE COMPLIANCE
 FOR COMPLIANCE WITH THE APPLICABLE CONSTRUCTION CODES IDENTIFIED BELOW:
 BUILDING STRUCTURAL
 MECHANICAL PLUMBING
 ELECTRICAL ENERGY
 ACCESSIBILITY FIRE


PLAN REVIEW ACCEPTANCE OF DOCUMENTS DOES NOT AUTHORIZE CONSTRUCTION TO PROCEED IN VIOLATION OF ANY FEDERAL, STATE, OR LOCAL REGULATIONS.
 BY: *[Signature]* DATE: 11/13/19
 WEST COAST CODE CONSULTANTS, INC.

GENERAL NOTES AND LEGEND:

- SEE SHEET AE001 FOR GENERAL NOTES.
- SEE TITLE SHEET FOR DRAWING INDEX.
- DO NOT SCALE DRAWINGS.
- CONTRACTOR / SUBCONTRACTOR SHALL VERIFY ALL DIMENSIONS AND CONDITIONS BEFORE BEGINNING WORK, AND SHALL REPORT TO THE ARCHITECT ANY ERRORS, INCONSISTENCIES OR OMISSIONS BEFORE BEGINNING WORK. SEE GENERAL NOTES AND SPECIFICATIONS.

KEYED NOTES:

- 1 LAVATORY. SEE PLUMBING DRAWINGS. TYP.
- 2 AIR DRYER. SEE ACCESSORIES SCHEDULE.
- 3 MIRROR. SEE INTERIOR ELEVATIONS AND ACCESSORIES SCHEDULE. TYP.
- 4 WALL HUNG TOILET. SEE PLUMBING DRAWINGS.
- 5 TOILET PAPER DISPENSER. SEE ACCESSORIES SCHEDULE AND DETAIL #08 ON SHEET AE302B. TYP.
- 6 STAINLESS STEEL GRAB BAR. SEE ADA DETAIL ON G002. TYP.
- 7 TOILET PAPER DISPENSER. SEE ACCESSORIES SCHEDULE AND DETAIL #08 ON SHEET AE302B. TYP.
- 8 CHANGING TABLE. TO BE MOUNTED 48" MAX ABOVE F.F. TO ALSO BE ACCORDANCE WITH SECTIONS 308 AND 309.3 OF ICC A117.1-09. TYP.
- 9 PARTITION DOOR. SEE ACCESSORIES SCHEDULE.
- 10 FLOOR DRAIN. SLOPE CONC. TO DRAIN. SEE PLUMBING DRAWINGS.
- 11 WALL HUNG URINAL. SEE PLUMBING DRAWINGS.
- 12 INSULATED PIPE WRAP. TYP. AT ADA SINKS.
- 13 REMOVABLE KEY HOSE BIB A RECESS BOX. SEE PLUMBING.

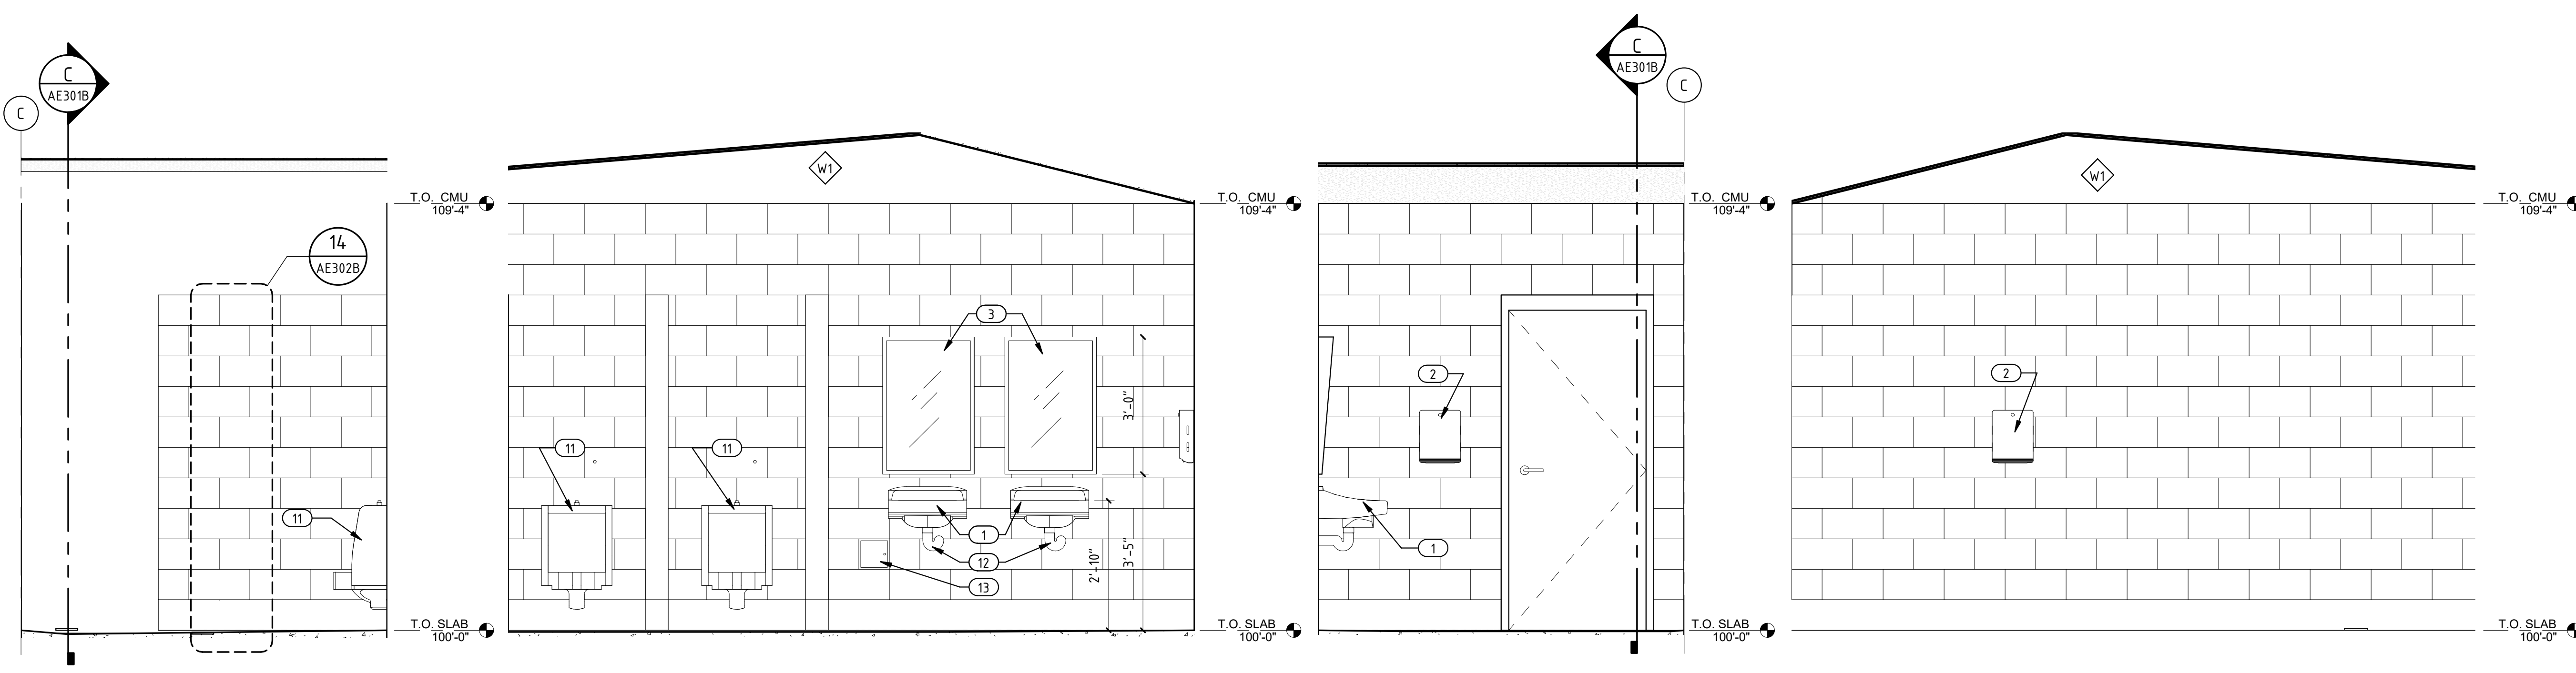


MENS R.R. - ELEVATION 09
 SCALE: 1/2" = 1'-0" AE401B

MENS R.R. - ELEVATION 08
 SCALE: 1/2" = 1'-0" AE401B

MENS R.R. - ELEVATION 07
 SCALE: 1/2" = 1'-0" AE401B

MENS R.R. - ELEVATION 06
 SCALE: 1/2" = 1'-0" AE401B

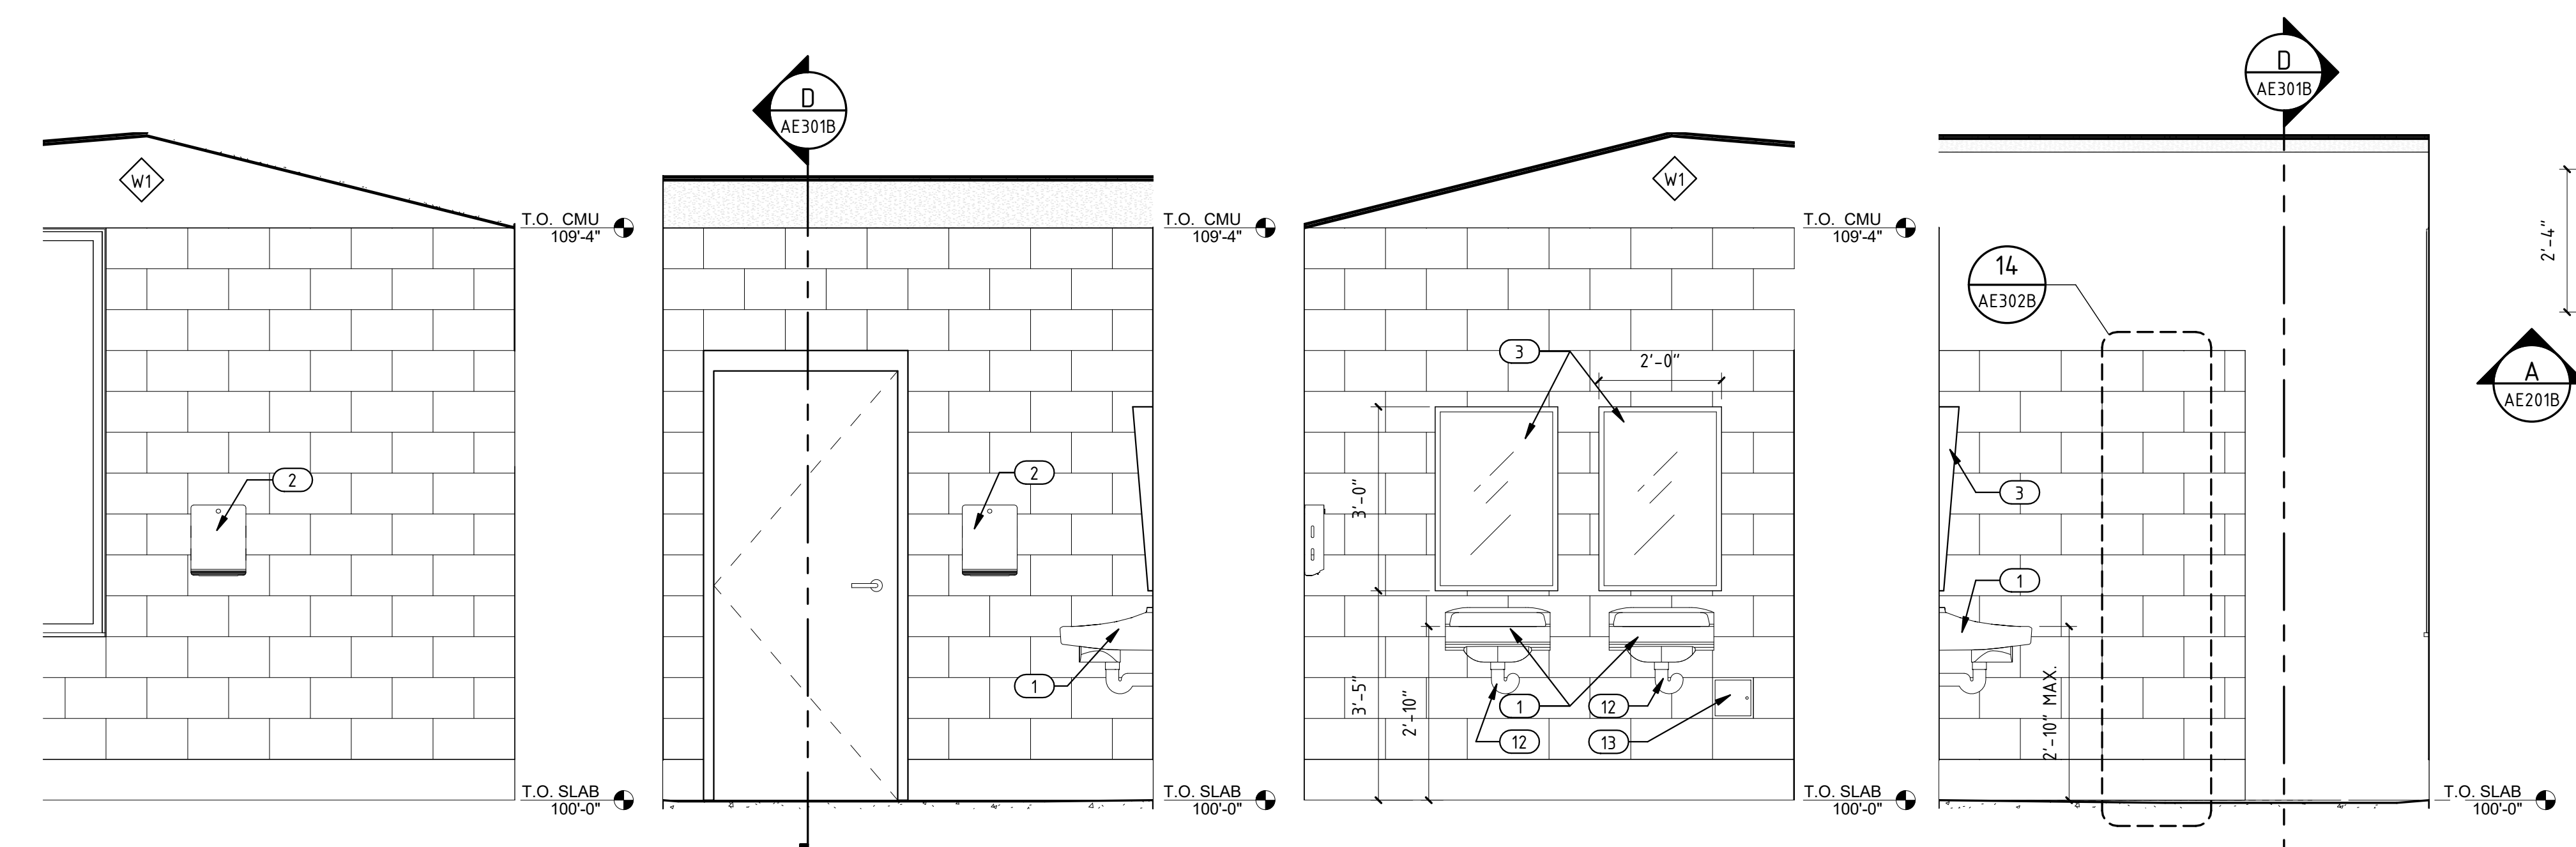


WOMENS R.R. - ELEVATION 05
 SCALE: 1/2" = 1'-0" AE401B


WOMENS R.R. - ELEVATION 04
 SCALE: 1/2" = 1'-0" AE401B

WOMENS R.R. - ELEVATION 03
 SCALE: 1/2" = 1'-0" AE401B

WOMENS R.R. - ELEVATION 02
 SCALE: 1/2" = 1'-0" AE401B

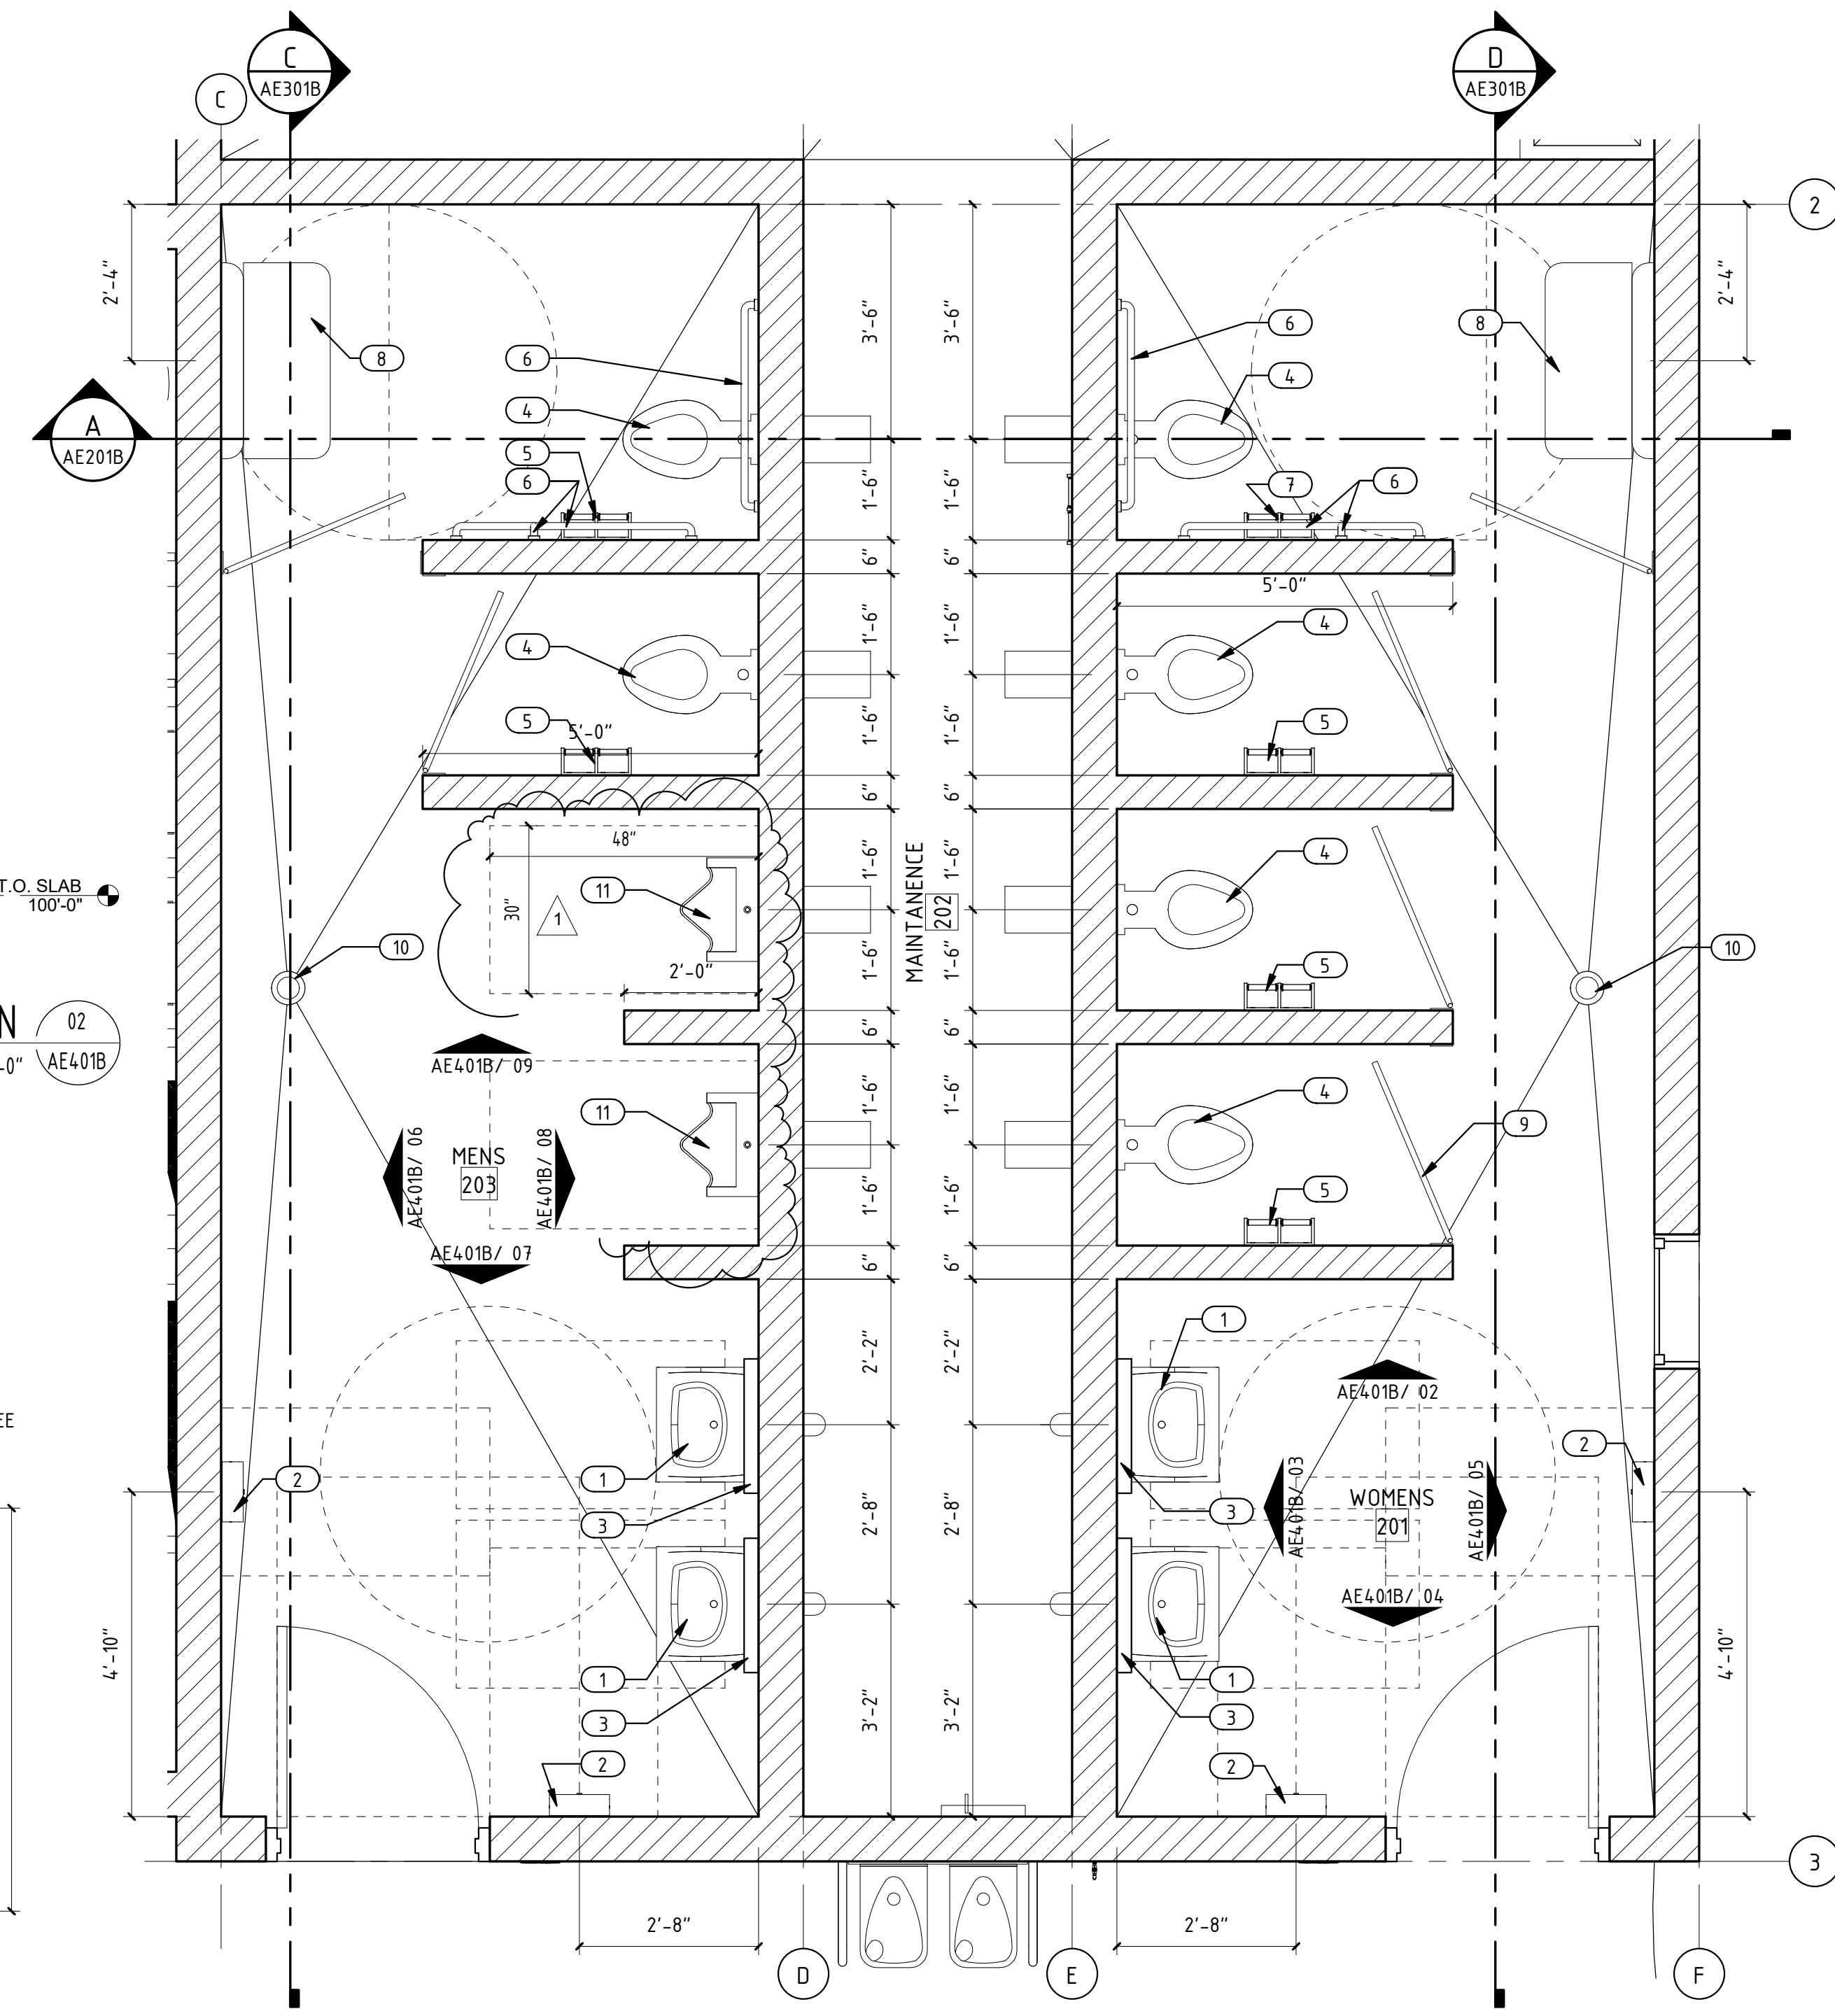


RESTROOMS - ENLARGED PLAN 01
 SCALE: 1/2" = 1'-0" AE401B

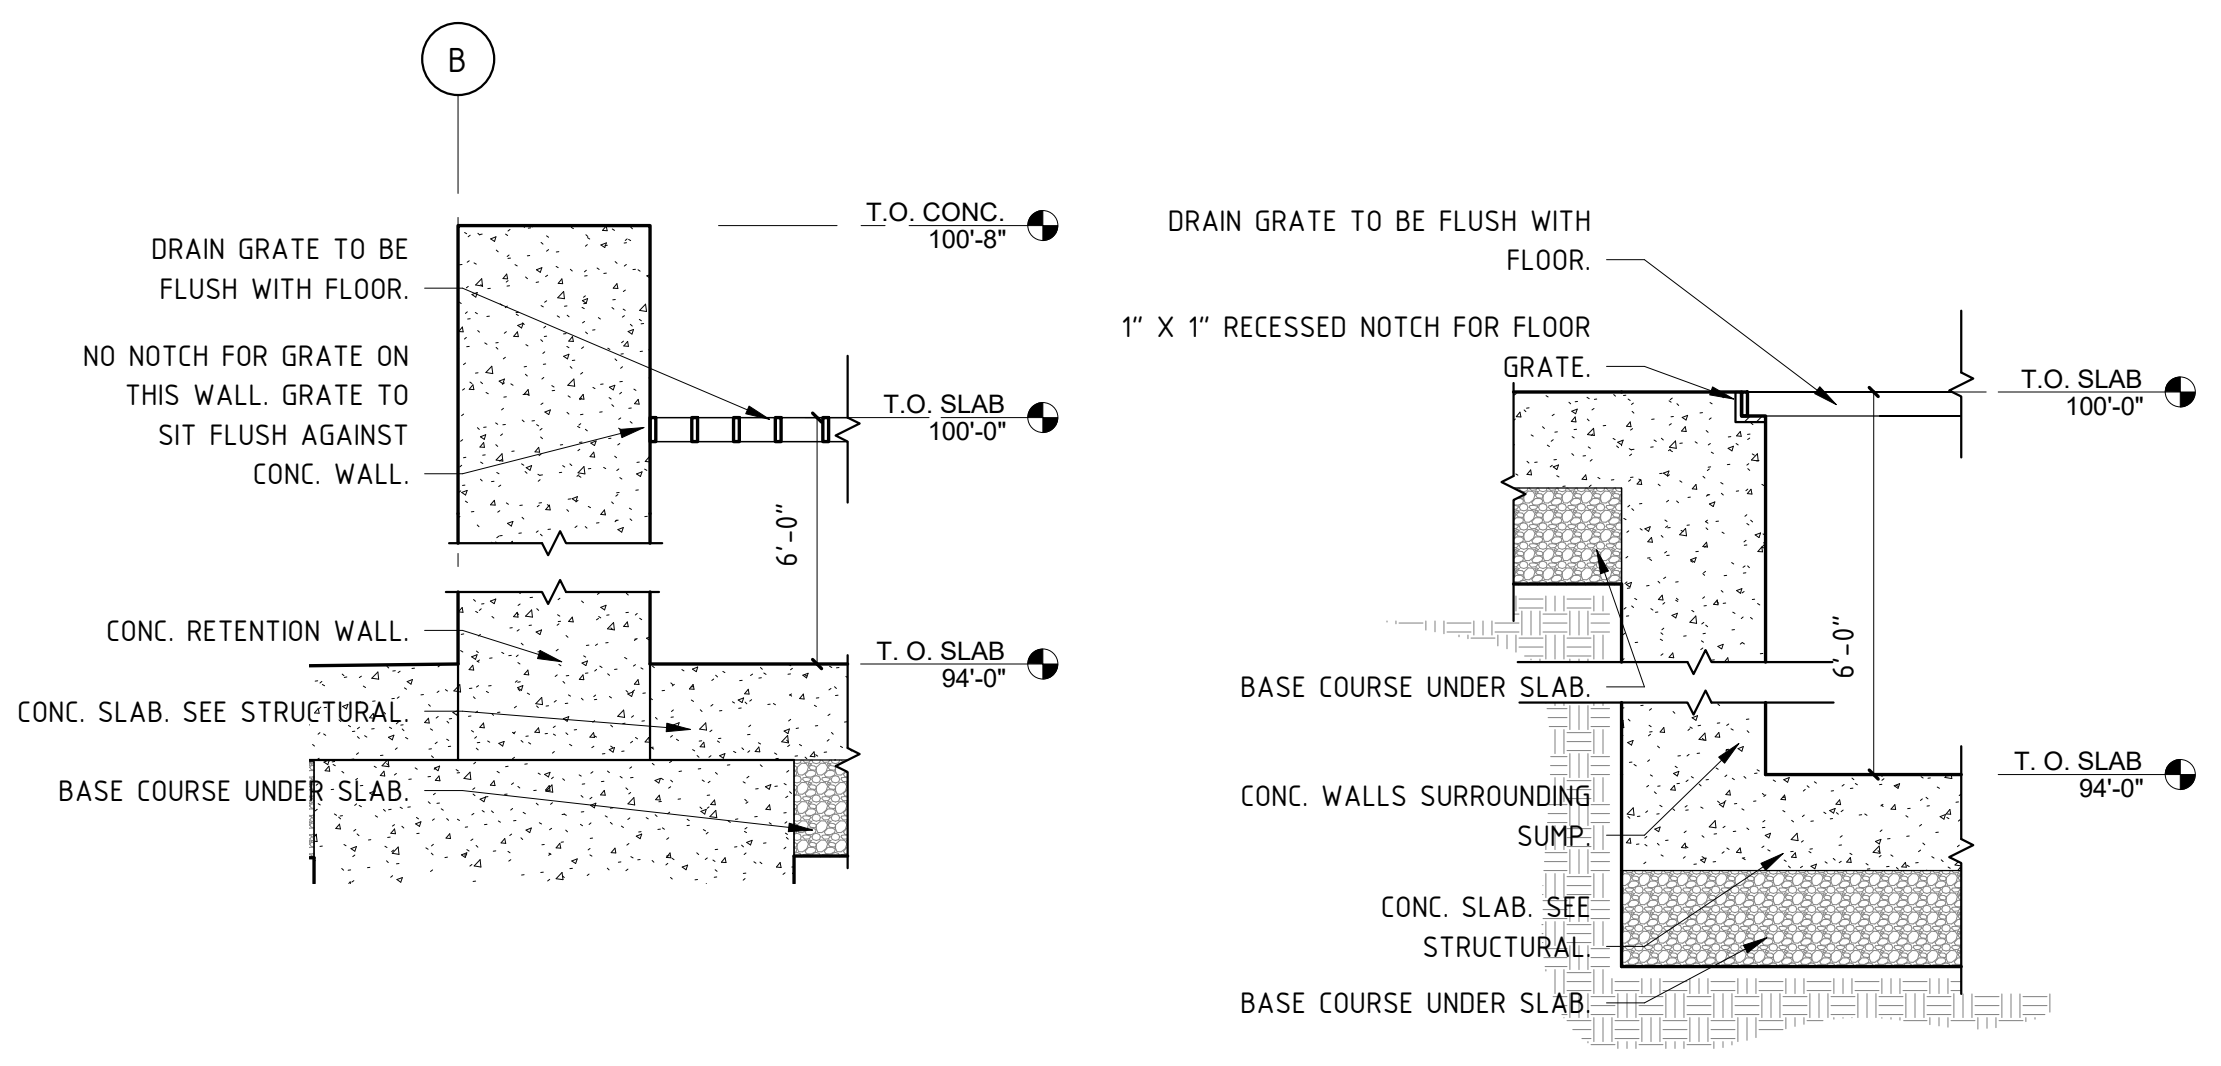

SUMP DETAIL 12
 SCALE: 1 1/2" = 1'-0" AE401B

TYP. SUMP DETAIL 11
 SCALE: 1 1/2" = 1'-0" AE401B

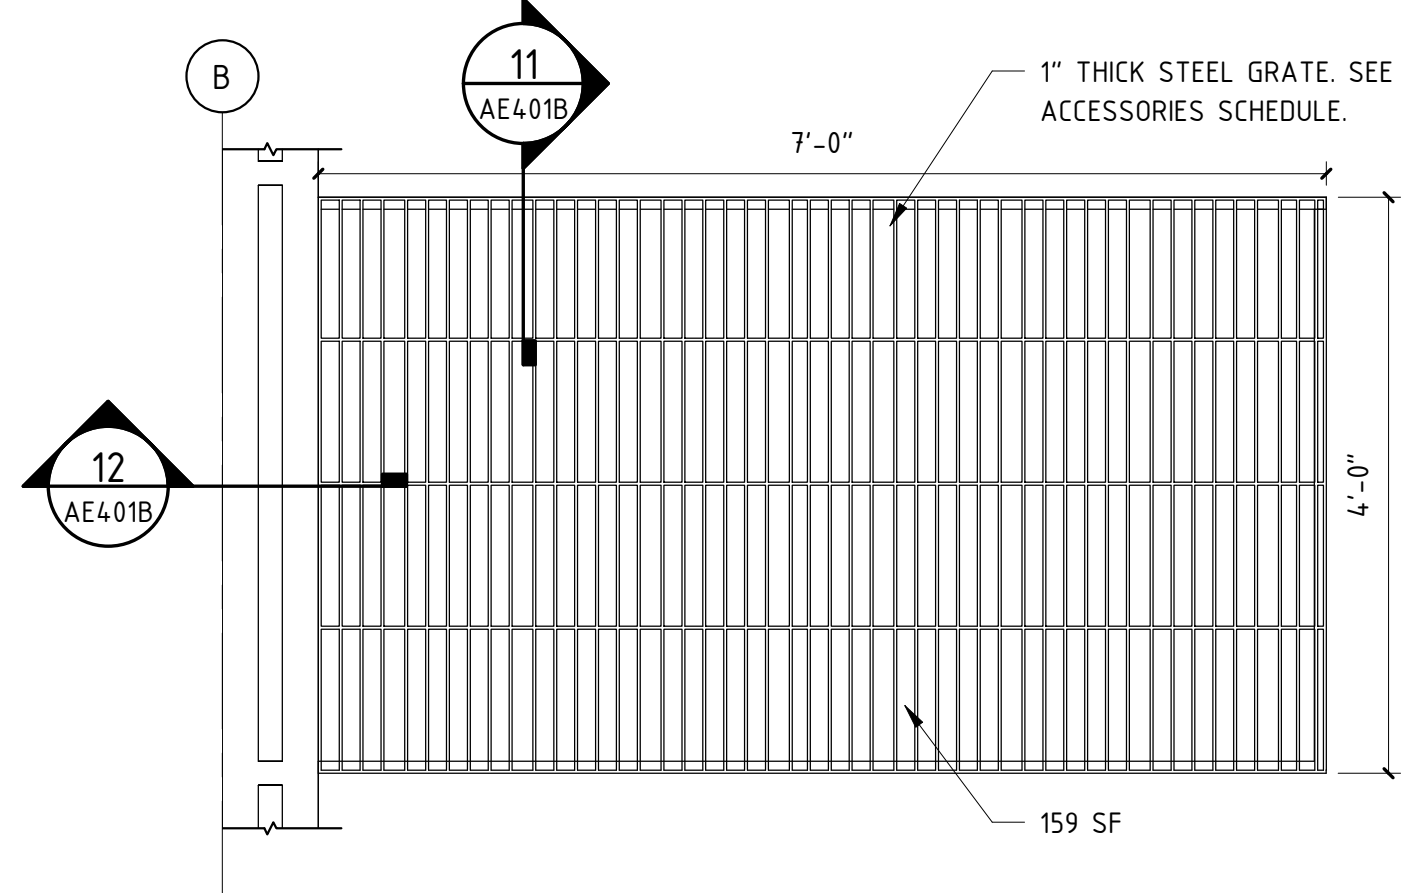

CONCRETE SUMP 10
 SCALE: 3/4" = 1'-0" AE401B




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 MAGNA, UTAH 84044

REVISIONS:

△ ASI #1	10-18-19
△	-
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△	-
△	-

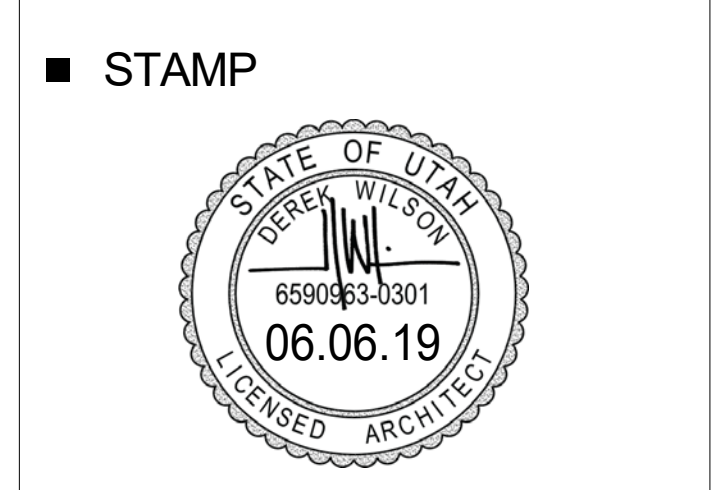

SHEET TITLE:
 EQUIP./RESTROOM BLDG.
 ENLARGED PLAN AND
 INTERIOR ELEV.

DATE: 7-22-19
 DRAWN BY: CKG
 CHECKED BY: DW
 JOB NO.: U17-021

SHEET NO:
 AE401B

CONSTRUCTION DOCUMENTS - CONFORMED SET


REVIEWED FOR CODE COMPLIANCE
 FOR COMPLIANCE WITH THE APPLICABLE CONSTRUCTION CODES IDENTIFIED BELOW:
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 BY: *[Signature]* DATE: 11/13/19
 WEST COAST CODE CONSULTANTS, INC.

DOOR & FRAME SCHEDULE

NO.	DOOR SIZE		FIRE RATING	DOOR TYPE	FRAME TYPE	HARDWARE											KEYING FUNCTION TYPE	COMMENTS
	WIDTH	HEIGHT				HINGES	EXIT DEVICES	LOCKABLE DEVICES	KICK PLATE	SILENCERS/SEALS	ACCESS CONTROL	THRESHOLD	CLOSER	MATERIAL	CUSTOM HARDWARE			
101A	3'-0"	7'-0"		A	1	01	01/02	02	02	02	-	01/03	01	01	-	01	INSULATED, SEE DOOR HARDWARE	
101B	12'-0"	10'-0"		C	-	-	-	-	-	-	-	-	-	-	-	-	POWERED OVERHEAD, INTERIOR CONTROL BUTTON. SAFETY EYE, INSULATED, PRE-FINISHED.	
101C	12'-0"	10'-0"		C	-	-	-	-	-	-	-	-	-	-	-	-	POWERED OVERHEAD, INTERIOR CONTROL BUTTON. SAFETY EYE, INSULATED, PRE-FINISHED.	
101D	3'-0"	7'-0"		A	1	01	01/02	02	02	02	-	01/03	01	01	-	01	INSULATED, SEE DOOR HARDWARE	
102	3'-0"	7'-0"		A	1	01	01	03	-	01	-	-	-	01	-	01	INSULATED, SEE DOOR HARDWARE	
103	3'-0"	7'-0"		A	3	01	01	04	-	01	-	-	-	01	-	01	SEE DOOR HARDWARE	
104	3'-0"	7'-0"		A	1	01	01	04	-	01	-	-	-	01	-	01	INSULATED, SEE DOOR HARDWARE	
201	3'-0"	7'-0"		A	1	01	01	07/09	02	01	04	-	01	01	-	01	INSULATED, SEE DOOR HARDWARE	
202	3'-0"	7'-0"		A	1	03	01	05	02	01	-	-	01	01	-	01	INSULATED, SEE DOOR HARDWARE	
203	3'-0"	7'-0"		A	1	01	01	07/09	02	01	04	-	-	01	-	01	INSULATED, SEE DOOR HARDWARE	
204	3'-8"	7'-0"		B	2	03	01	05	-	01	-	-	-	01	-	01	INSULATED, SEE DOOR HARDWARE. MIN. 3/4" GAP AT BOTTOM OF DOOR. SEE MECHANICAL.	
205	3'-8"	7'-0"		B	2	03	01	05	-	01	-	-	-	01	-	01	INSULATED, SEE DOOR HARDWARE. MIN. 3/4" GAP AT BOTTOM OF DOOR. SEE MECHANICAL.	
206	3'-8"	7'-0"		A	1	01	01	07	02	01	-	-	01	01	-	01	INSULATED, SEE DOOR HARDWARE	
207																		
208																		

DOOR HARDWARE LEGEND ALL DOORS SHALL BE LEVER HANDLE. ALL DOORS SHALL HAVE (3) SILENCERS DOOR HARDWARE MFG'S. SEE SPECIFICATIONS. DOOR HARDWARE SHALL MEET THE REQUIREMENTS OF IBC 1010.1.9.1. HARDWARE SHALL NOT REQUIRE PINCHING, TIGHT GRASPING, OR TWISTING OF THE WRIST TO OPERATE.

HINGES	KICK PLATE	MATERIAL
01 TYP. PER MFG.	01 EXTERIOR SIZE: HEIGHT: MATERIAL:	01 STAINLESS STEEL
02 CONTINUOUS.	02 INTERIOR SIZE: HEIGHT: MATERIAL:	02 POLISHED BRASS
03 NON-REMOVABLE PIN.		03 OIL RUBBED BRONZE
04 TAPERED TIPS.		04 SATIN NICKEL
		05 BLACK NICKEL
		CUSTOM HARDWARE
EXIT DEVICE	SILENCER/SEALS	KEYING FUNCTION TYPE
01 LEVER.	01 SILENCER: TYP.	01 ONE SIDE
02 PANIC BAR	02 SEAL:	02 BOTH SIDES
LOCKABLE DEVICE	ACCESS CONTROL	
01 PASSAGE	01 CARD READER	
02 KEYED CYLINDER.	02 KEYPAD	
03 CLASSROOM LOCK.	03 PROXIMITY READER	
04 RESTROOM LOCK.	04 EGRESS RELEASE BUTTON	
05 STORAGE LOCK.		
06 DEADBOLT.		
07 MORTISE LOCK. (FAIL SAFE)		
08 PUSH/PULL.	THRESHOLD	
09 MAGLOCK.	01 MODEL:	
10 ELECT. STRIKE.	02 AUTO CLOSE:	
11 ELECT. LATCH.	03 SWEEP.	
	CLOSER	
	01 MODEL:	

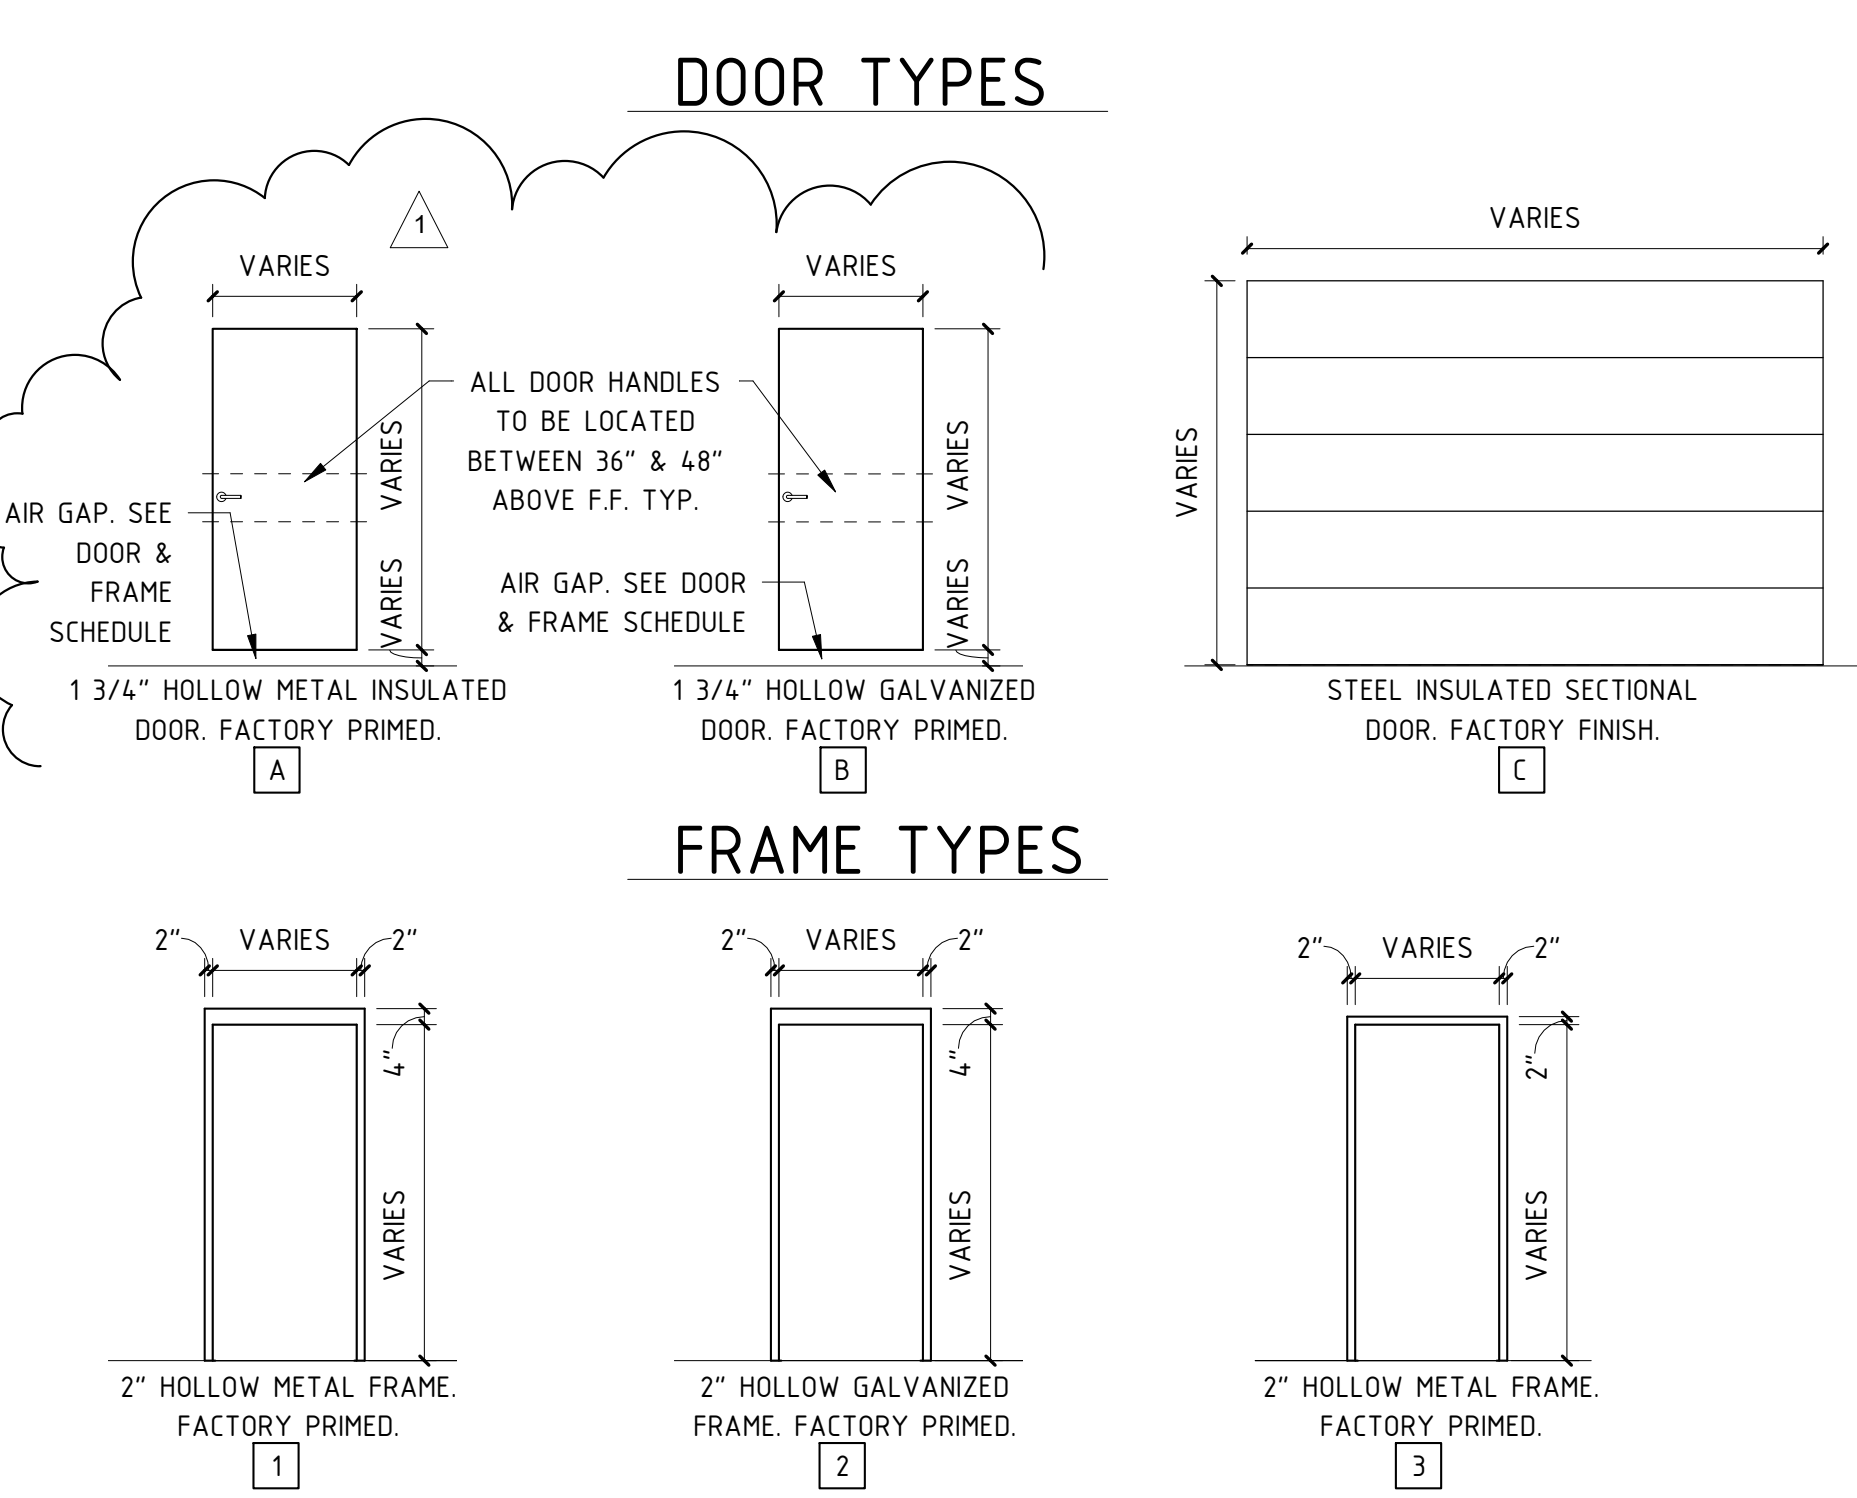

WINDOW AND FRAME SCHEDULE


TYPE MARK	WINDOW SIZE		TYPES		SOUND RATING	COMMENTS
	WIDTH	HEIGHT	GLAZING	FRAME		
A	4'-0"	2'-0"			5 OVERPRESSURE ZONE	
B	2'-0"	6'-8"			5 OVERPRESSURE ZONE	

ACCESSORY SCHEDULE

ITEM	DESCRIPTION
PARTION DOORS	DIAMOND PLATE STEEL PANEL PARTITION DOOR AND FRAME WITH 4" RADIUS ED CORNERS.
MIRROR	BOBRICK, B-293 24" X 36" FIXED/TILT MIRROR
TOILET PAPER DISP.	INSTALLED PER DETAILS ON SHEET AE302B
HAND DRYER	OWNER PROVIDED, OWNER INSTALLED
HAND SOAP DISP.	OWNER PROVIDED, OWNER INSTALLED
GRAB BARS	2" STAINLESS STEEL
CHANGING STATION	GAMCO BCS-2 36" X 4" X 20" COLOR: GRAY
ATTIC ACCESS LADDER	22"X48" ATTIC LADDER
SHOWER LINER	PLASTIC SHOWER LINER. MAKE: TBD MODEL: TBD
METAL LOCKER	18" X18"X5" MAKE: TBD MODEL: TBD
FLOOR CRANE	ABELL-HOWE® LIGHT DUTY FLOOR CRANE 450033 2000 LB. CAPACITY

FINISH SCHEDULE AND LEGEND

MARK	MATERIAL	MANUFACTURER	COLOR / MODEL #	NOTES:	
FLOOR					
F1	CONC. SEALER	-TBD	COLOR: TBD	2 COATS WITH SLIP-RESISTANT AGGREGATE.	
F2	EPOXY FLOOR COATING	-TBD	COLOR: TBD		
BASE					
B1	4" RUBBER BASE (NO-TOE)	-TBD	COLOR: TBD		
WALLS					
W1	GYPBOARD - PAINTED	-TBD	COLOR: GRAY	4" WAINSCOT. 4' X 10' INSTALLED LANDSCAPE.	
W2	GYPBOARD - EPOXY PAINTED	-TBD	COLOR: TBD		
W3	FRP	-TBD	COLOR: TBD		
W4	FRP	-TBD	COLOR: TBD		
W5	STUCCO	-TBD	COLOR: TBD		HARD COATED STUCCO.
W6	EXTERIOR PAINT	-TBD	COLOR: GRAY 1		BLOCK FILLER & PAINT ON COMMON CMU W/ANTI GRAFITTI SEALER.
W7	EXTERIOR PAINT	-TBD	COLOR: GRAY 2		BLOCK FILLER & PAINT ON SPLIT-FACE CMU W/ANTI GRAFITTI SEALER.
W8	INTERIOR PAINT	-TBD	COLOR: TBD		PAINT W/ANTI GRAFITTI SEALER.
CEILING					
C1	GYPBOARD - PAINTED	-TBD	COLOR: TBD		
C2	GYPBOARD - EPOXY PAINTED	-TBD	COLOR: TBD		
ROOFING					
R1	METAL ROOF	MCELROY METAL MEGA RIB	COLOR: PATINA GREEN KYNAR 500 COLOR	PAINT W/ANTI GRAFITTI SEALER.	
S1	METAL SOFFIT	MCELROY METAL MATRIX	COLOR: MATCH ROOF	24 GAUGE PAINT W/ANTI GRAFITTI SEALER.	
GENERAL					
P1	EXTERIOR PAINT	-TBD	COLOR: TBD	BOLLARDS.	
P2	EXTERIOR PAINT	-TBD	COLOR: TBD	WINDOW FRAMES ON MAINTIANCE BLDG.	
P3	EXTERIOR PAINT	-TBD	COLOR: TANGERINE (TO MATCH PLAYGROUND)	COLUMN, GLULAM, STEEL CHANNEL, STEEL BEAM R.R. WINDOW FRAME AND 3-FORM WINDOW (COLOR TO BE CEMENTINE 007. EXACT COLOR AND FINISH TO BE APPROVED BY LANDSCAPE ARCHITECT).	
P4	EXTERIOR PAINT	-TBD	COLOR: TBD	MAINTENANCE DOORS. SAME PAINT AS W6	
P5	EXTERIOR PAINT	-TBD	COLOR: TANGERINE (TO MATCH PLAYGROUND)	PUBLIC DOORS.	
P6	EPOXY PAINT	-TBD	COLOR: TBD	CHEM ROOM DOORS.	

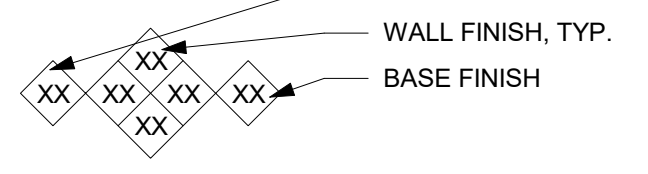


PREPARED FOR:

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REVISIONS:
 A ASI #1 10-18-19
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 C - -
 D - -
 E - -



SHEET TITLE:
 DR. SCHED., FIN. SCHED.,
 ACC. SCHED., WIN
 SCHED.

DATE: 7-22-19
 DRAWN BY: CKG
 CHECKED BY: DW
 JOB NO.: U17-021

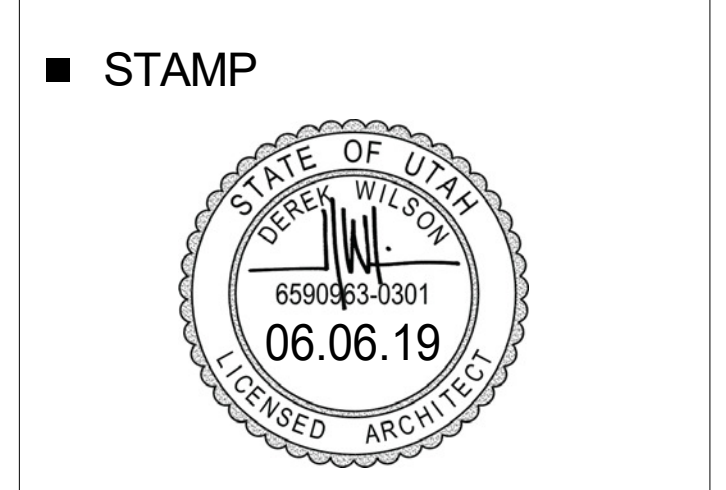SHEET NO.: AE601

CONSTRUCTION DOCUMENTS - CONFORMED SET



GENERAL STRUCTURAL NOTES:

- 1. GENERAL STRUCTURAL NOTES ARE CONSTRUCTION DOCUMENTS THAT SHALL BE INCLUDED WITH THE STRUCTURAL PLANS AND PROJECT SPECIFICATIONS.
2. TYPICAL DETAILS AND SCHEDULES SHALL APPLY WHERE SPECIFIC DETAILS ARE NOT SHOWN.
3. 'CONTRACTOR' REFERS TO THE CONTRACTOR OR SUB-CONTRACTOR RESPONSIBLE FOR THE PARTICULAR TRADE REFERRED TO IN THE NOTES.
...
22. CHECKING OF SUBMITTALS BY C.E. IS ONLY FOR GENERAL CONFORMANCE WITH THE DESIGN CONCEPT.
23. THE CONTRACTOR SHALL BE RESPONSIBLE FOR THE MEANS AND METHODS OF CONSTRUCTION.

DESIGN CODE

2015 INTERNATIONAL BUILDING CODE (IBC)

DESIGN CRITERIA

Table with 2 columns: Design Criteria and Value. Includes Snow Loading (30PSF), Wind Importance Factor (1.0), Seismic Importance Factor (1.0), etc.

DESIGN LOADS

Table with 2 columns: Design Load and Value. Includes Roof Live Load (20PSF), Roof Dead Load (15PSF), etc.

EARTHWORK:

Table with 2 columns: Design Criteria and Value. Includes Soil Bearing Pressure (1500 PSF), Coeff. of Friction (0.35), etc.

REQUIREMENTS

- 1. CONTRACTOR TO REMOVE EXISTING FOOTINGS, FOUNDATIONS, SLABS, STEP PAVING, DECKS, AND STRUCTURES AS REQUIRED.
2. CONTRACTOR SHALL STABILIZE THE BUILDING AREA FROM ALL VEGETATION, DEBRIS AND TOPSOIL.
3. CONTRACTOR SHALL LOCATE ANY REMAINING LOOSE NATURAL OR FILL SOILS TO EXPOSE COMPLETELY NATURAL SOILS.
...
14. CONTRACTOR SHALL BE RESPONSIBLE FOR THE MEANS AND METHODS OF CONSTRUCTION.

CONCRETE NOTES

- 1. ALL WORK SHALL BE IN STRICT ACCORDANCE WITH THE 2015 IBC, ACI 318, AND LOCAL ORDINANCES.
2. CONTRACTOR SHALL COORDINATE WITH MECHANICAL, ELECTRICAL, AND ARCHITECTURAL PRIOR TO PLACING CONCRETE.
3. CONTRACTOR SHALL BE RESPONSIBLE FOR PROPER PLACEMENT OF ALL ANCHOR BOLTS, SEISMIC ANCHORS OR STRAPS, ETC.
...
14. CONTRACTOR SHALL BE RESPONSIBLE FOR THE MEANS AND METHODS OF CONSTRUCTION.

FOOTINGS

- 1. ALL FOOTINGS SHALL BE 12" THICK & PROPERLY FORMED. INTERIOR FOOTINGS MAY BE MONOLITHIC WITH SLAB.
2. ALL EXTERIOR FOOTINGS SHALL BEAR BELOW FROST DEPTH (30 INCHES, FIELD VERIFY).
3. ALL FOOTINGS SHALL BEAR ON UNDISTURBED NATURAL MATERIAL OR ON PROPERLY PLACED ENGINEERED FILL.
...
14. CONTRACTOR SHALL BE RESPONSIBLE FOR THE MEANS AND METHODS OF CONSTRUCTION.

CAST-IN-PLACE CONCRETE

- 1. CAST AGAIN/PERMANENTLY EXPOSED TO EARTH.
2. FORMED CONCRETE EXPOSED TO EARTH/WEATHER.
3. #6 THRU #18 BARS.
4. #5 AND SMALLER BARS.
5. CONCRETE NOT EXPOSED EARTH/WEATHER.
6. SLAB ON WALL JOISTS (14" C, STRIPPUS).
7. FOUNDATION AND RETAINING WALLS.
8. BRACE WALLS AS REQUIRED UNTIL FLOOR SLABS AND/OR FLOOR FRAMING ARE IN PLACE.
...
14. CONTRACTOR SHALL BE RESPONSIBLE FOR THE MEANS AND METHODS OF CONSTRUCTION.

STEEL NOTES:

- 1. ALL WORK TO BE IN STRICT ACCORDANCE WITH THE 2015 IBC, LOCAL ORDINANCES, AWS STRUCTURAL WELDING CODE, AND THE FOLLOWING AISC PUBLICATIONS.
2. STANDARD PRACTICE, SPECIFICATION FOR STRUCTURAL JOINTS USING ASTM A325 OR A490 BOLTS, AND 'SEISMIC' PROVISION FOR STRUCTURAL BUILDINGS.
3. ALL DIMENSIONS AND CONDITIONS SHALL BE VERIFIED BY THE CONTRACTOR PRIOR TO FABRICATION AND ERECTION.
...
14. EXPOSED STEEL SHALL HAVE PROTECTIVE GROUND SMOOTH.

MATERIALS

- 1. WIDE FLANGE SECTIONS: ASTM A992 (50 KSI).
2. OTHER SHAPES AND PLATES: ASTM A58.
3. TUBULAR COLUMNS: ASTM A500 GRADE B (46 KSI).
4. PIPE COLUMNS: ASTM A513 (36 KSI) OR A53 GRADE B.
5. DEFORMED BAR ANCHORS: ASTM A496.
6. HEADED STUD ANCHORS: ASTM A108.
7. ANCHOR BOLTS: ASTM A307 WITH ASTM A563 HEAVY HEX NUTS WITH HARDENED WASHERS GRADE 4 (U.N.O.).
8. BOLTED CONNECTIONS: ASTM A325-N (3/4" DIAMETER MIN.).
9. WELDS: E70 XX AT ALL JOISTS E80 XX AT ALL BEAMS E70 XX AT ALL OTHER LOCATIONS.

CONSTRUCTION

- 1. ALL WELDS AND BOLTING TO MEET APPROVAL OF SPECIAL INSPECTOR AS REQUIRED BY BUILDING OFFICIAL.
2. ALL WELDING AND CUTTING SHALL BE PERFORMED BY AWS CERTIFIED WELDERS.
3. ALL INTERSECTING STEEL SHAPES WHICH ARE NOT BOLTED SHALL BE CONNECTED BY A FILLET WELD ALL AROUND, UNLESS NOTED OTHERWISE.
4. FOR THICKNESSES 1/4" AND LARGER, WELD SIZES SHALL BE 1/16" LESS THAN THE THINNEST CONNECTED PART, UNLESS NOTED OTHERWISE.
...
14. CONTRACTOR SHALL BE RESPONSIBLE FOR THE MEANS AND METHODS OF CONSTRUCTION.

WOOD FRAMING NOTES:

- 1. ALL WORK TO BE IN STRICT ACCORDANCE WITH THE 2015 IBC, NDS, AND LOCAL ORDINANCES.
2. GLU-LAMINATED LUMBER FOR SIMPLE SPANS SHALL BE 24F-V4 OR D/F OR GLU-LAMINATED BEAMS FOR CONTINUOUS SPANS AND CANTILEVERS SHALL BE 24F-V8 D/F/D.
3. DO NOT INSTALL GLU-LAMINATED BEAMS UPSIDE DOWN.
4. LAMINATED VENEER LUMBER AND THE LIKE SHALL BE INSTALLED PER MANUFACTURER'S RECOMMENDATIONS AND SPECIFICATIONS.
...
14. CONTRACTOR SHALL BE RESPONSIBLE FOR THE MEANS AND METHODS OF CONSTRUCTION.

DIMENSIONAL LUMBER

- 1. DIMENSIONAL LUMBER USED AS STRUCTURAL FRAMING (I.e. JOISTS, RAFTERS, AND HEADERS) SHALL BE DOUGLAS FIR-LARCH NO.2 OR EQUAL.
2. DIMENSIONAL LUMBER USED FOR STUD GRADE SHALL BE STUD GRADE 2x6 UNLESS NOTED OTHERWISE.
3. ALL SILL PLATES ARE TO BE BOLTED TO FOUNDATION W/ 8" DIA. X 10" J-BOLTS @ 3' O.C. MAXIMUM, UNLESS NOTED OTHERWISE ON THE STRUCTURAL DRAWINGS AND SHEARWALL SCHEDULE.
...
14. CONTRACTOR SHALL BE RESPONSIBLE FOR THE MEANS AND METHODS OF CONSTRUCTION.

FLOOR, ROOF AND WALL SHEATHING

- 1. ALL ROOF SHEATHING SHALL BE A MINIMUM OF 5/8" APA EXP. 1 RATED SHEATHING OR EQUAL WITH 10x COMMON NAILS AT 6" O.C. PERIMETER, 6" O.C. PANEL EDGES AND 4" O.C. IN THE FIELD UNLESS NOTED OTHERWISE.
2. PROVIDE 2 X SHAPED BLOCKING AT RIDGES UNLESS A CONTINUOUS MEMBER EXISTS.
3. ROOF AND FLOOR DECK SUPPORT ANGLES AS NEEDED, ROOF AND FLOOR DIAPHRAGM CHORDS, CLIP ANGLES, ETC. AS NEEDED.
4. REINFORCE DECK OPENINGS FOR SKYLIGHTS, ACCESS HATCHES, MECHANICAL EQUIPMENT, ETC. WITH 14x4x3/8" OR 16x4x5/16" U.N.O., ON ALL EDGES.
...
14. CONTRACTOR SHALL BE RESPONSIBLE FOR THE MEANS AND METHODS OF CONSTRUCTION.

WOOD TRUSS DESIGN

- 1. THE TRUSSES SHALL ALSO BE DESIGNED PER THE 2015 IBC AND LOCAL ORDINANCES. THE TRUSS MANUFACTURER SHALL BE RESPONSIBLE FOR THE DESIGN AND FABRICATION OF THE PRE-ENGINEERED TRUSSES PER THE DESIGN CRITERIA ABOVE.
2. DESIGN SHALL TAKE INTO ACCOUNT UNBALANCED SNOW LOADS, SNOW DRIFTING, INDESIGNED SNOW LOADS ON EAVES AND IN VALLEYS, IMPACT LOADS FROM TRUCKS, SNOW AND ICE, ETC.
3. COMPASS ENGINEERING IS NOT RESPONSIBLE FOR THE DESIGN, INSTALLATION, ETC. OF THE TRUSSES. SHOP DRAWINGS FOR ALL WOOD TRUSSES SHALL BE SUBMITTED TO THE ARCHITECT/ENGINEER FOR REVIEW AND APPROVAL PRIOR TO FABRICATION AND INSTALLATION.
...
14. CONTRACTOR SHALL BE RESPONSIBLE FOR THE MEANS AND METHODS OF CONSTRUCTION.

TRUSS BRACING AND BLOCKING

- 1. THE TRUSS MANUFACTURER SHALL SPECIFY PROPER BRACING OF COMPRESSION CHORD MEMBERS 6'-0" LONG (OR LONGER), AS WELL AS BRACING REQUIRED FOR TRUSS ERECTION AND ANY OTHER BRACING.
2. THE TRUSS MANUFACTURER SHALL SPECIFY ALL REQUIRED TRUSS BLOCKING.
3. BOTTOM CHORD OF TRUSSES TO BE SHEATHED W/ 5/8" GYPSUM WALL BOARD OR BRACED WITH CONT. 2x4 @ 6'-0" TRUSS MANUFACTURER TO VERIFY.
4. BRACE WITH CONT. 2x4 @ 6'-0" O.C.
5. METAL GUSSET PLATES.
6. GUSSET PLATES SHALL BE SPECIFIED FOR GREATER OF EITHER THE MEMBER FORCES SHOWN ON DRAWINGS OR THE MEMBER FORCES DERIVED FROM STRUCTURAL ANALYSIS.
...
14. CONTRACTOR SHALL BE RESPONSIBLE FOR THE MEANS AND METHODS OF CONSTRUCTION.

VENEER:

- 1. ATTACH TO STEEL AND WOOD STUD WALLS WITH DWR-Q-WAL DA 213 SEISMIC VENEER ANCHORS OR HORMANN & BARNARD DW-10 OR DW-10HS SEISMIC VENEER ANCHORS SPACED AT 16" O.C. EACH WAY.
2. PROVIDE STEEL ANGLE LINTELS AT ALL OPENINGS. SEE THE STEEL ANGLE LINTEL SCHEDULE FOR SIZE AND REQUIREMENTS.
3. BRICK VENEER.
4. ATTACH TO CONCRETE WALLS WITH DWR-Q-WAL DA 213 SEISMIC VENEER ANCHORS OR HORMANN & BARNARD DW-10 OR DW-10HS SEISMIC VENEER ANCHORS SPACED AT 16" O.C. EACH WAY.
...
14. CONTRACTOR SHALL BE RESPONSIBLE FOR THE MEANS AND METHODS OF CONSTRUCTION.



PREPARED FOR:




CONSULTANTS:

MAGNA REGIONAL PARK PHASE ONE
4042 SOUTH 7200 WEST MAGNA, UTAH 84044

REVISIONS:

Table with 2 columns: Revision Number and Description. Shows three revision entries.

STAMP

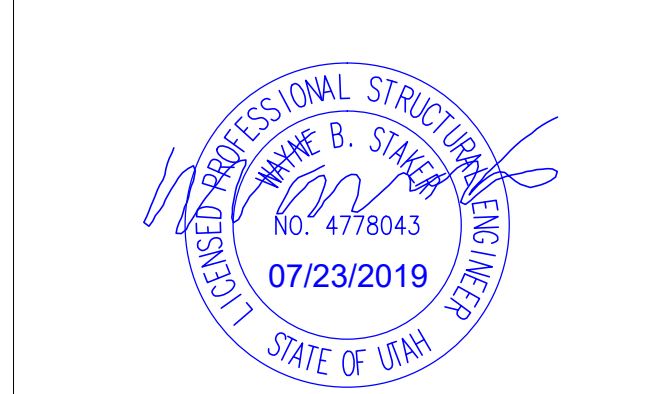

SHEET TITLE

GENERAL NOTES

- DATE: 7-22-19
DRAWN BY: MP
CHECKED BY: SP
JOB NO.: 19038

SHEET NO:

1

REVIEWED FOR CODE COMPLIANCE
 FOR COMPLIANCE WITH THE APPLICABLE CONSTRUCTION CODES IDENTIFIED BELOW
 BUILDING STRUCTURAL
 MECHANICAL PLUMBING
 ELECTRICAL ENERGY
 ACCESSIBILITY FIRE
 PLAN REVIEW ACCEPTANCE OF DOCUMENTS DOES NOT AUTHORIZE CONSTRUCTION TO PROCEED IN VIOLATION OF ANY FEDERAL, STATE, OR LOCAL REGULATIONS.
 BY: *[Signature]* DATE: 11/13/19
 WEST COAST CODE CONSULTANTS, INC.

LINTEL MARK	LINTEL WIDTH	LINTEL DEPTH	REINFORCING		NOTES
			HORIZONTAL	STIRRUPS	
ML-1	8"	2'-0"	(2) #5 TOP & BOTTOM	#3 @ 24" O.C.	GROUT SOLID
ML-2	8"	1'-4"	(2) #4 TOP & BOTTOM		GROUT SOLID


MASONRY LINTEL NOTES:

- LINTEL SHALL MATCH WALL WIDTH AND MATERIAL TYPE, U.N.O.
- SOLID GROUT MASONRY LINTELS MONOLITHICALLY WITH THE WALL OR COLUMN AT EACH END.
- SHORE AS REQUIRED.
- CONSULT THE STRUCTURAL ENGINEER FOR LINTELS NOT SHOWN ON THE PLANS THAT ARE LOCATED DIRECTLY BELOW / ROOF BEAMS OR GIRDERS.
- EXTEND ALL HORIZONTAL REINFORCING 48 BAR DIAMETERS MINIMUM BEYOND THE EDGE OF ALL OPENINGS. PROVIDE 90° STANDARD HOOK. IF HORIZONTAL REINFORCING CANNOT EXTEND 48 BAR DIAMETERS BEYOND EDGE OF OPENING.
- SPLICE TOP BARS AT MIDSPAN OF LINTEL ONLY AND BOTTOM BARS OVER SUPPORTS ONLY.
- CONTINUE HORIZONTAL WALL REINFORCING THRU MASONRY LINTELS. USE LARGER REINFORCING WHERE BOTH HORIZONTAL WALL REINFORCING AND LINTEL REINFORCING OCCUR IN THE SAME COURSE.
- DOWEL VERTICAL WALL REINFORCING TO THE FULL DEPTH OF LINTEL OR 48 BAR DIAMETERS, WHICHEVER IS LESS.
- SEE GENERAL STRUCTURAL NOTES FOR ALL OTHER REQUIREMENTS.


MARK	WIDTH	LENGTH	DEPTH	REINFORCING CROSSWISE			REINFORCING LENGTHWISE		
				NO	SIZE	SPACING	NO	SIZE	LENGTH
FC20	1'-8"	CONT.	1'-0"				3	#4	CONT.
FC36	3'-0"	CONT.	1'-0"	#5	3'-0"	14" O.C.	4	#5	CONT.
FC54	4'-6"	CONT.	1'-0"	#5	4'-0"	14" O.C.	5	#5	CONT.

ALLOWABLE SOIL BEARING PRESSURE FROM SOILS REPORT = 2000 PSF
 MINIMUM COMPRESSIVE CONCRETE STRENGTH f'_c = 3000 PSI
 ALL REINFORCING STEEL SHALL BE GRADE 60 AND BE PROPERLY TIED INTO PLACE PRIOR TO POUR
 ALL CONCRETE WORK MUST MEET THE REQUIREMENTS OF THE 2015 IBC, ACI 318 AND LOCAL ORDINANCES
 ALL BARS MUST BE 3" CLEAR FROM GRADE

- ROOF FRAMING NOTES:**
- ALL EXTERIOR WALLS SHALL BE CONSIDERED BEARING U.N.O.
 - ALL EXTERIOR BEARING WALLS SHALL BE CONSTRUCTED WITH DFL #2 2x6 STUDS @ 16" ON CENTER, U.N.O.
 - PROVIDE STANDARD CONSTRUCTION FOR ALL WINDOW AND DOOR OPENINGS (TWO KING STUDS AND ONE TRIMMER AT EACH END) U.N.O.
 - WALL SHEATHING: 7/16" APA SHEATHING @ 6" O.C. AT PANEL EDGES AND 12" O.C. IN FIELD, U.N.O.
 - PROVIDE DOUBLE TRIMMERS @ OPENINGS > 5'-0"
 - ALL POSTS AND COLUMNS MUST PROVIDE A DIRECT CONTINUOUS BEARING LINE THROUGH TO THE FOOTING/FOUNDATION, U.N.O. THE TRUSS MFG. SHALL BE RESPONSIBLE FOR ALL TRUSS RELATED CONNECTIONS.
 - TRUSS MANUFACTURER TO DESIGN FOR ALL ADD LOADS, MECHANICAL UNITS, SNOW DRIFT ETC.
 - ROOF SHEATHING: 3/8" APA 32/16 WITH 100 COMMON NAILS @ 6" O.C. AT SUPPORTED EDGES AND 12" O.C. IN FIELD, U.N.O.
 - USE 'H' CLIPS ON ROOF SHEATHING

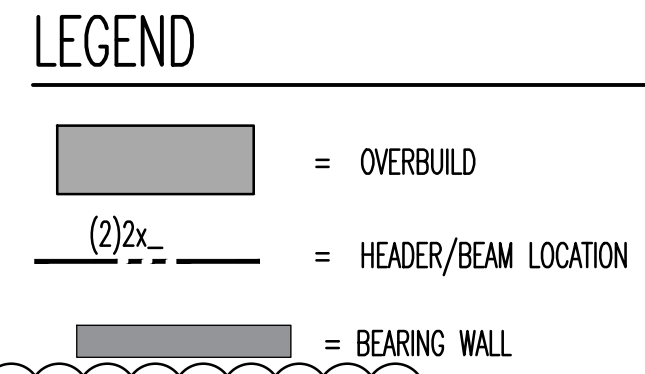


NOTE: DO NOT SCALE PLANS. SEE ARCHITECTURAL PLANS FOR WALL LOCATIONS

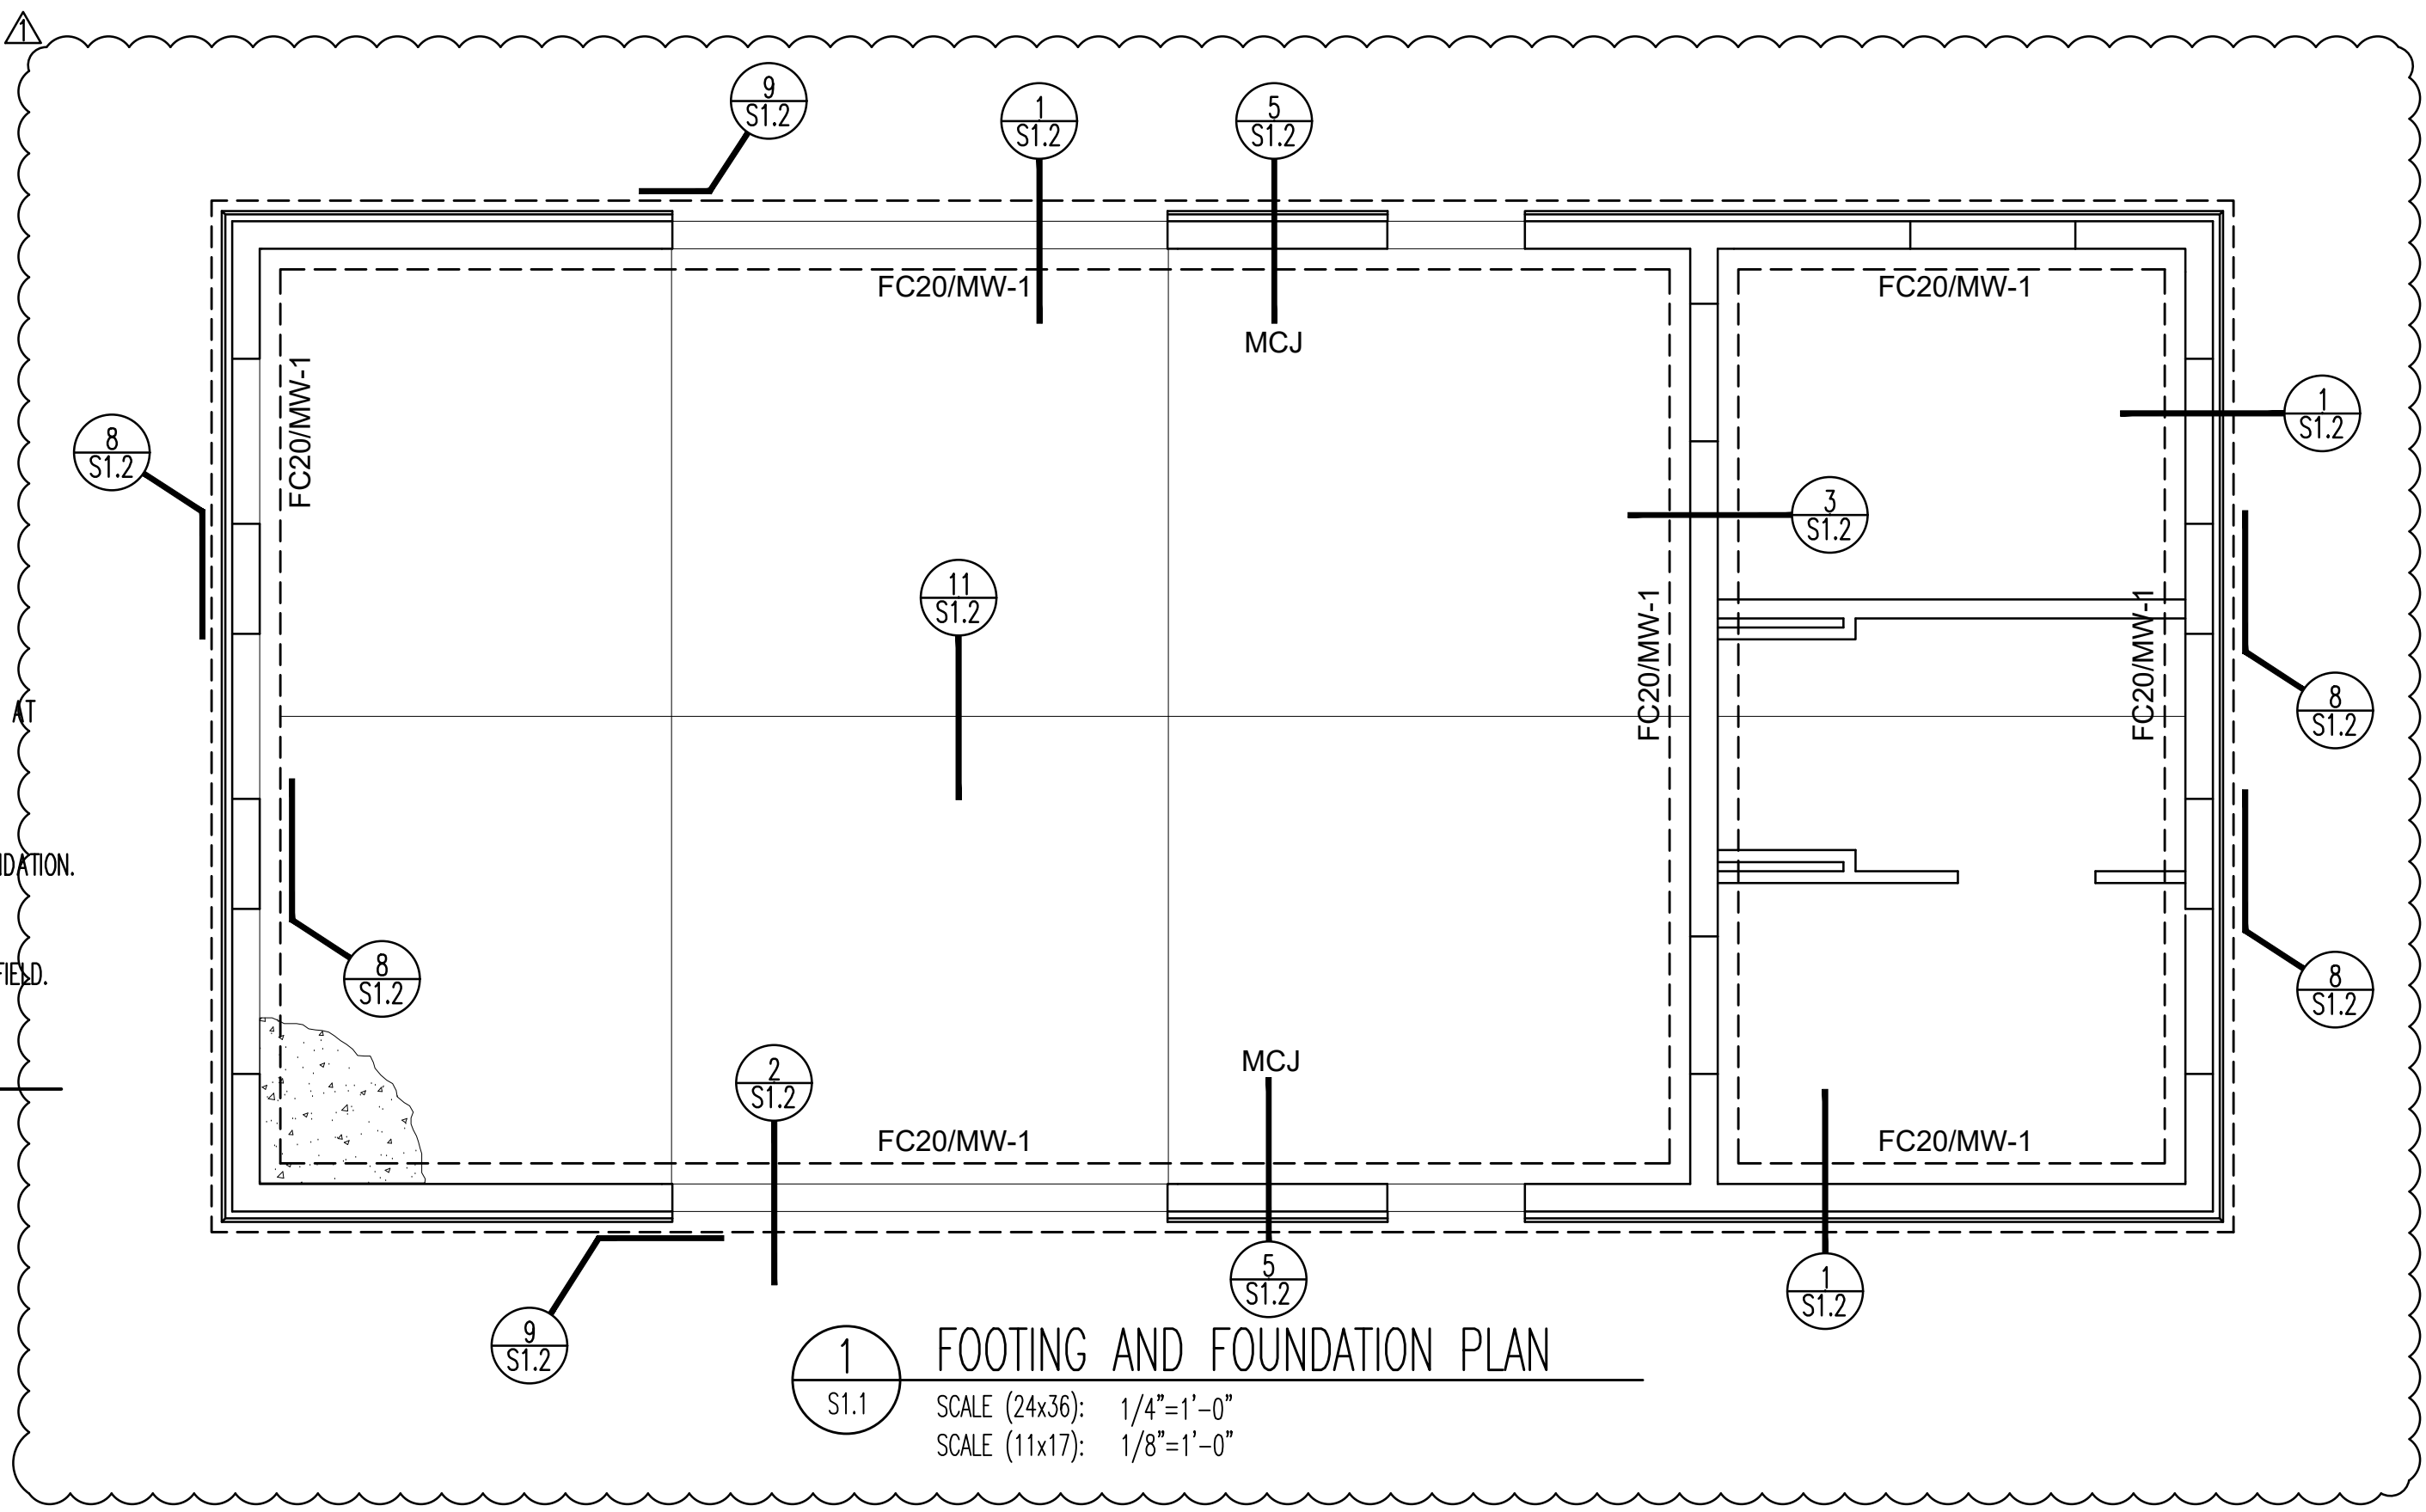


WALL MARK	THICKNESS	MATERIALS	SOLID GROUT	REINFORCING			SPECIAL INSP. REQ'D.	JAMBS & ENDS
				VERTICAL	HORIZONTAL	JOINTS		
MW-1	8"	CMU	NO	(1) #5 @ 24" O.C. E.F.	(2) #4 @ 32" O.C.	DURAWALL @ 16" O.C.	YES	(4) #5 VERT. IN TWO CELLS
MW-2	8"	CMU	NO	(1) #5 @ 24" O.C.	(2) #4 @ 48" O.C.	DURAWALL @ 16" O.C.	YES	(2) #5 VERT. IN TWO CELLS

- NOTE:**
- COORDINATE WITH ARCHITECTURAL DRAWINGS, MASONRY WALL FINISHES, TYPES OF MATERIAL, COURSING, ETC..
 - DO NOT SOLID GROUT WALLS UNLESS NOTED OTHERWISE.
 - SOLID GROUT ALL MASONRY BELOW GRADE.
 - CENTER VERTICAL REINFORCING IN THE WALL UNLESS NOTED OTHERWISE.
 - PLACE HORIZONTAL WALL REINFORCING BETWEEN VERTICAL MASONRY COLUMN REINFORCING BARS.
 - CONTINUE HORIZONTAL WALL REINFORCING THRU MASONRY LINTELS. USE LARGER REINFORCING WHERE BOTH HORIZONTAL WALL REINFORCING AND LINTEL REINFORCING OCCUR IN THE SAME COURSE.
 - SEE GENERAL STRUCTURAL NOTES FOR ALL OTHER REQUIREMENTS.
 - MASONRY WALLS NOT DESIGNATED ON THE PLANS SHALL BE REINFORCED AS FOLLOWS.
 - f_m = 2500 PSI
 - REINFORCING STEEL TO BE GRADE 60
 - CONTROL JOINTS TO BE 24'-0" MAX
-
- 5" SLAB W/ #3 BARS @ 12" O.C. EACH WAY UNDERLAIN BY 4" OF FREE DRAINING GRAVEL
- MCJ= MASONRY CONTROL JOINT

CONCRETE FOUNDATION WALL SCHEDULE						
MAX. HEIGHT	MIN. THICK	VERT. STEEL	HORZ. STEEL	TOP AND BOTTOM HORZ. REINFORCEMENT	WALL TYP.	REMARKS
4'-0"	8"	#4 @ 32" O.C.	#4 @ 12" O.C.	(2) #4	A	

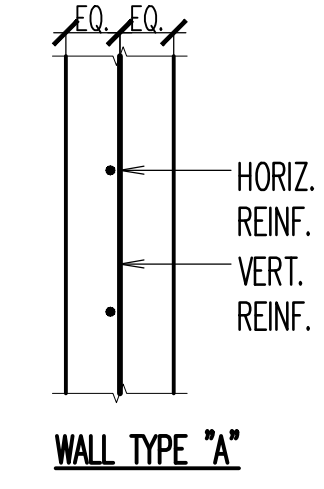

FOOTING EXCAVATIONS SHALL BE INSPECTED AND APPROVED IN WRITING BY A QUALIFIED GEOTECHNICAL ENGINEER PRIOR TO CONCRETE PLACEMENT
 Reviewed by Greg Baptist Date 11/21/2019

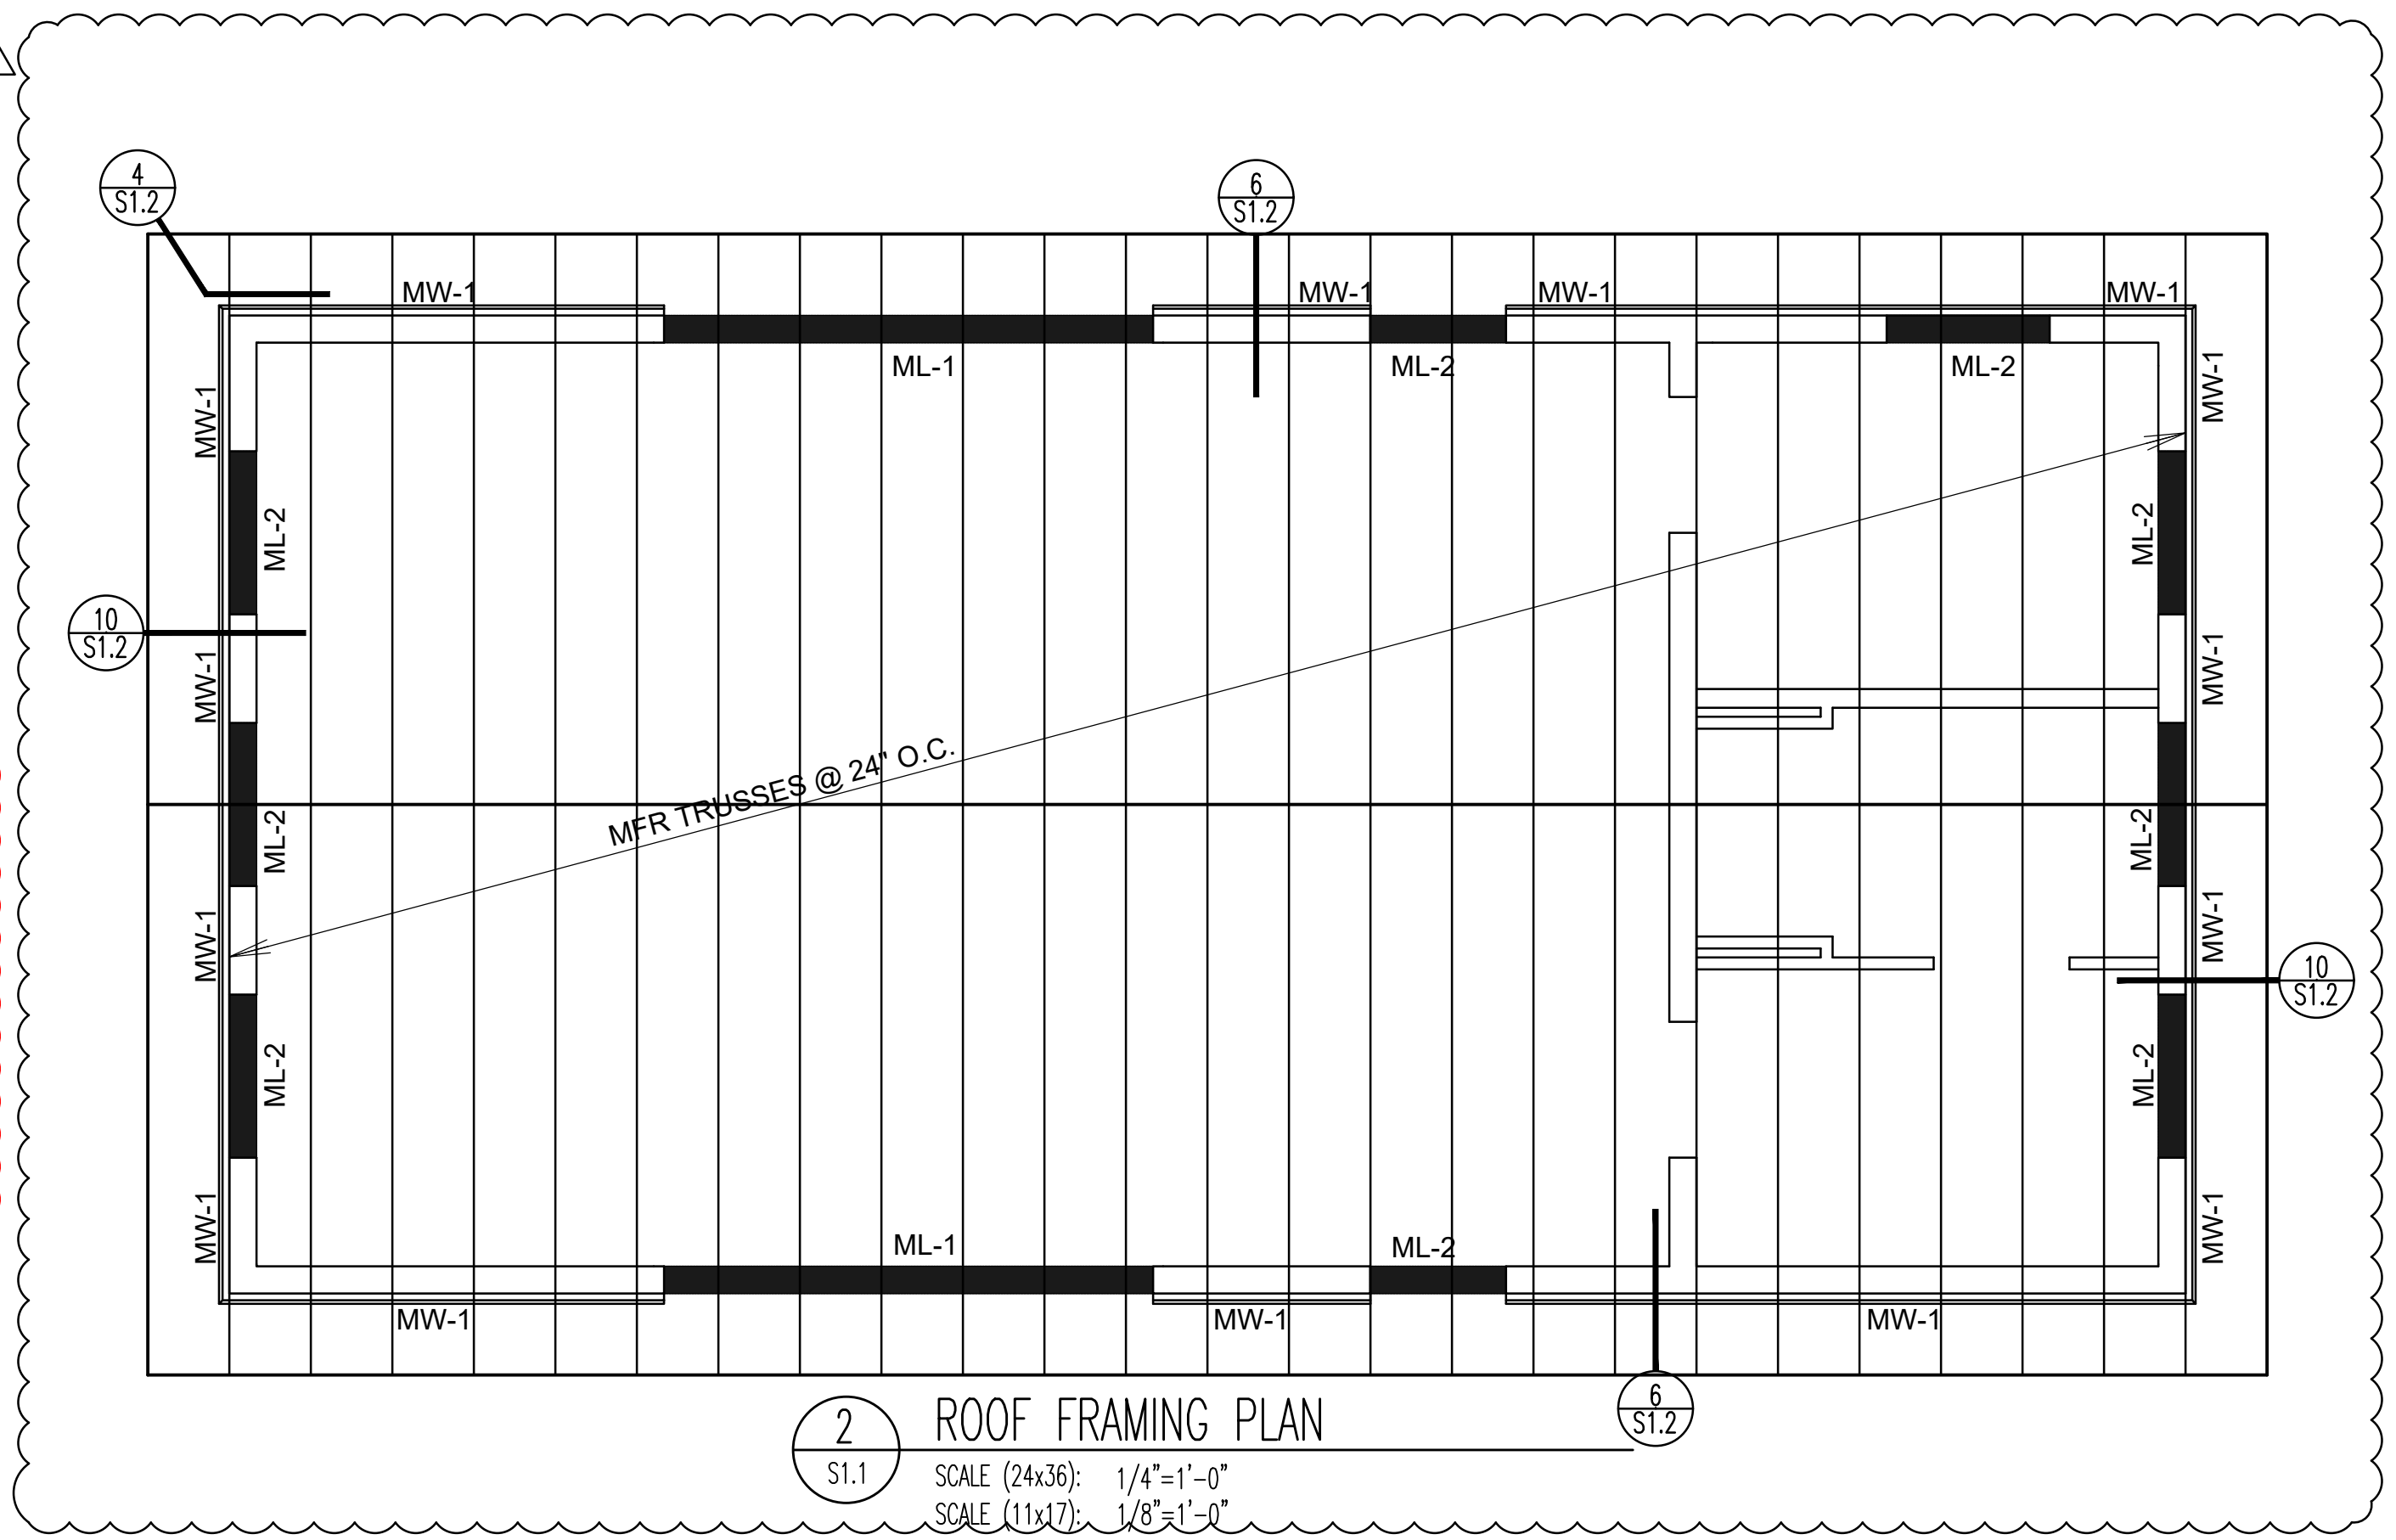

G.B.D
 G. BROWN DESIGN INC
 SITE AND LANDSCAPE ARCHITECTS
 610 East South Temple, Ste 50
 Salt Lake City, Utah 84102
 p 801.575.6066 f 801.575.6166
 www.growndesign.com

PREPARED FOR:

 SALT LAKE COUNTY
 PARKS & RECREATION
 CONSULTANTS:

**MAGNA REGIONAL PARK
 PHASE 1**
 4042 SOUTH 7200 WEST
 MAGNA, UTAH 84044

REVISIONS:

AS1 #1	10-18-19

STAMP


SHEET TITLE
 MAINTENANCE BUILDING
 FRAMING PLAN

DATE: 10-18-19
 DRAWN BY: MP
 CHECKED BY: SP
 JOB NO.: 19038


SHEET NO:

CONSTRUCTION DOCUMENTS - CONFORMED SET


REVIEWED FOR CODE COMPLIANCE
 FOR COMPLIANCE WITH THE APPLICABLE CONSTRUCTION CODES IDENTIFIED BELOW
 [X] BUILDING [X] STRUCTURAL
 [X] MECHANICAL [X] PLUMBING
 [X] ELECTRICAL [X] ENERGY
 [X] ACCESSIBILITY [X] FIRE
 PLAN REVIEW ACCEPTANCE OF DOCUMENTS DOES NOT AUTHORIZE CONSTRUCTION TO PROCEED IN VIOLATION OF ANY FEDERAL, STATE OR LOCAL REGULATIONS.
 BY: *[Signature]* DATE: 11/13/19
 WEST COAST CODE CONSULTANTS, INC.

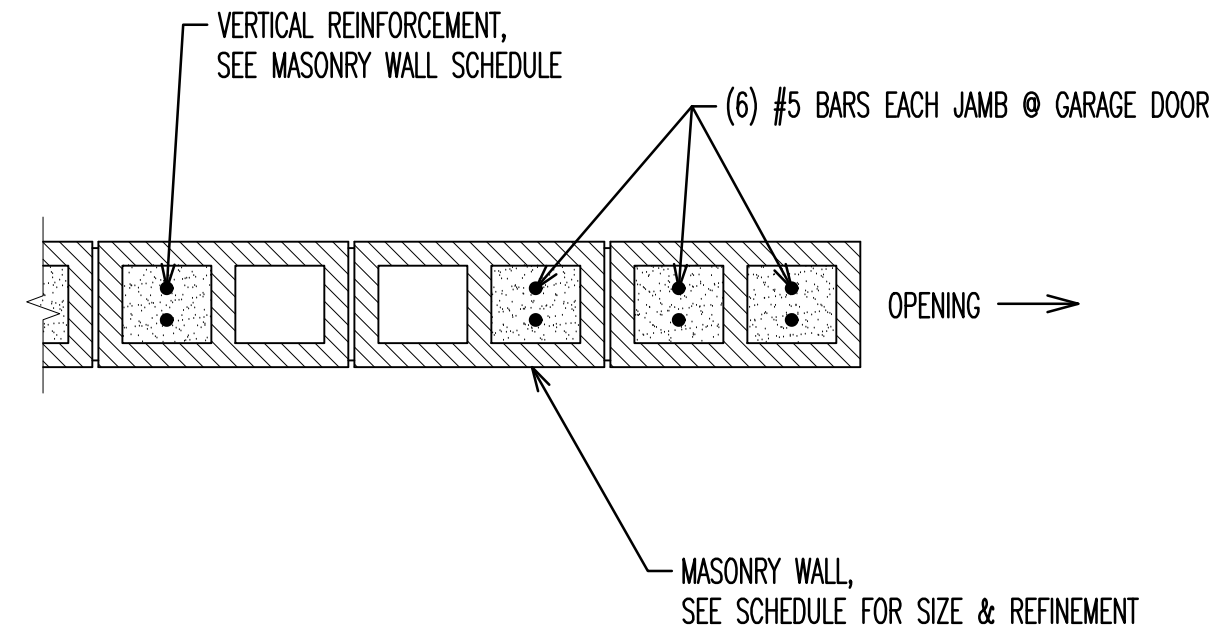


9 JAMB @ GARAGE DOOR
 S1.2 N.T.S.

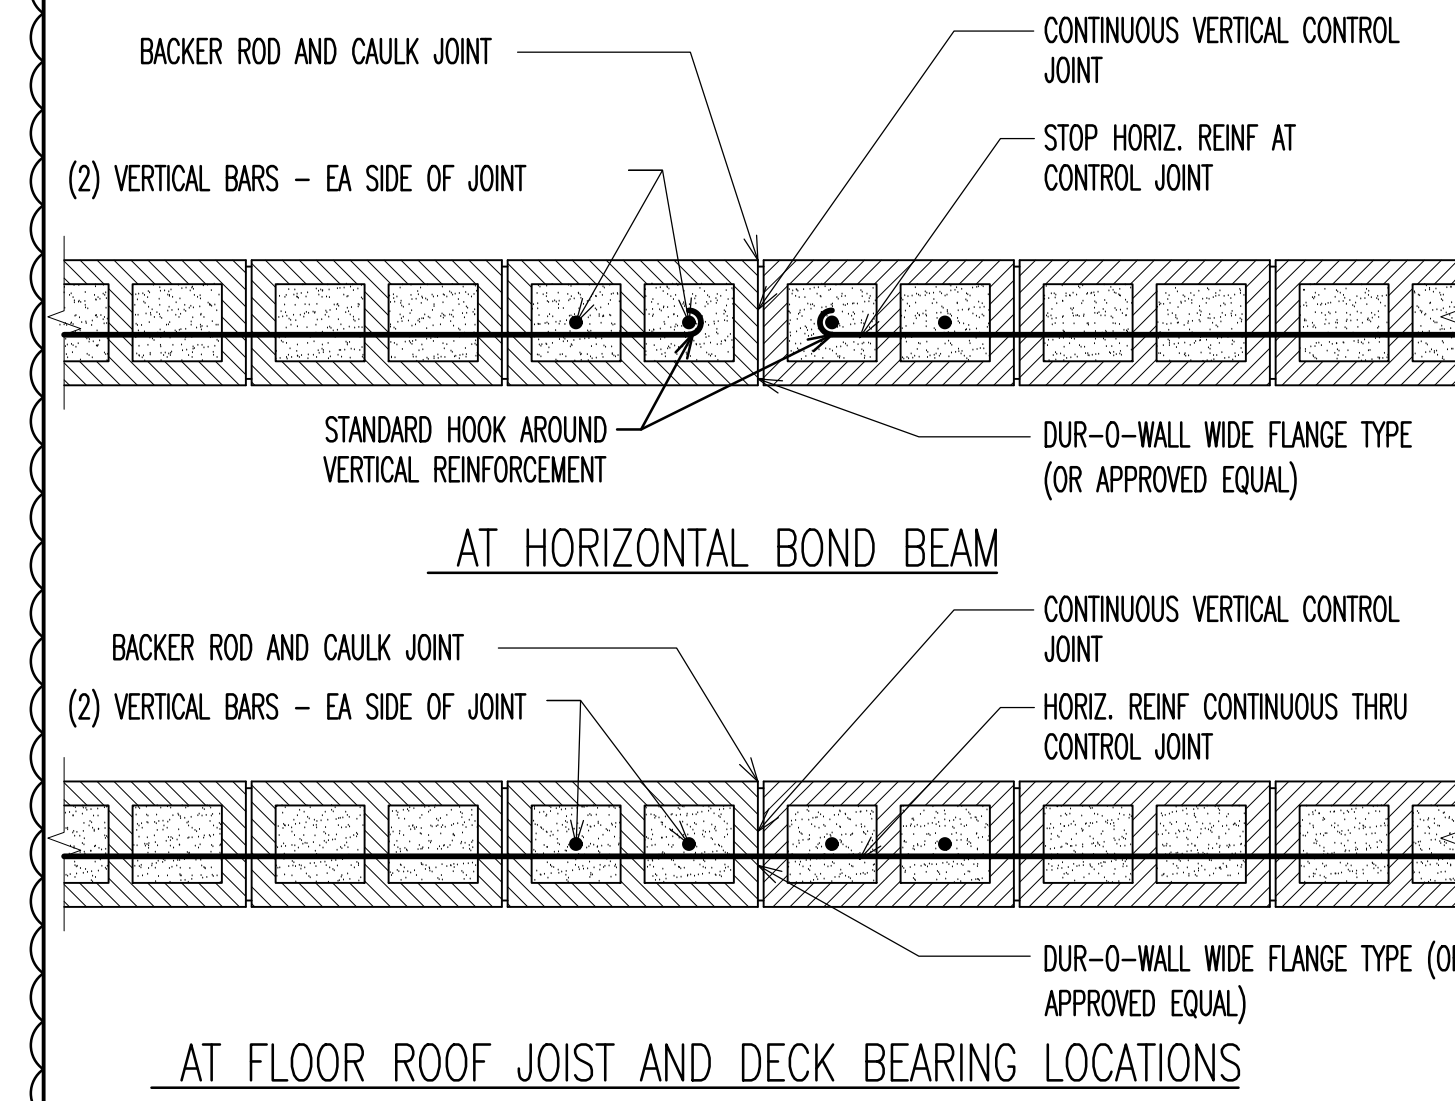


5 CONTROL JOINT FOR 8" MASONRY
 S1.2 N.T.S.

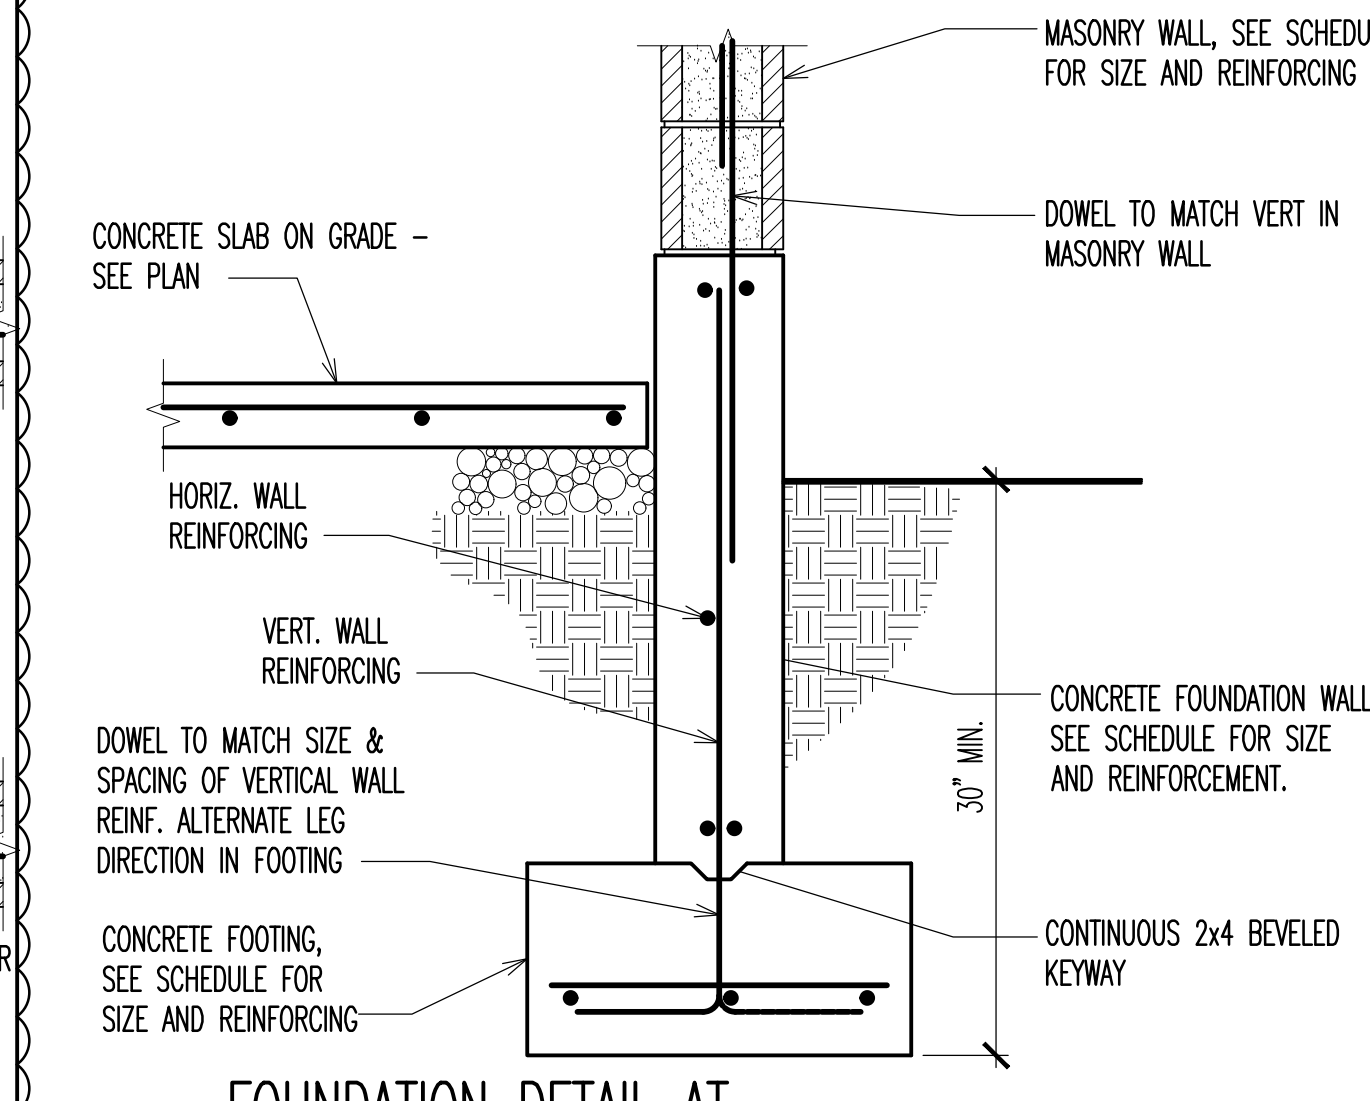


1 FOUNDATION DETAIL AT 8" MASONRY WALL
 S1.2 N.T.S.

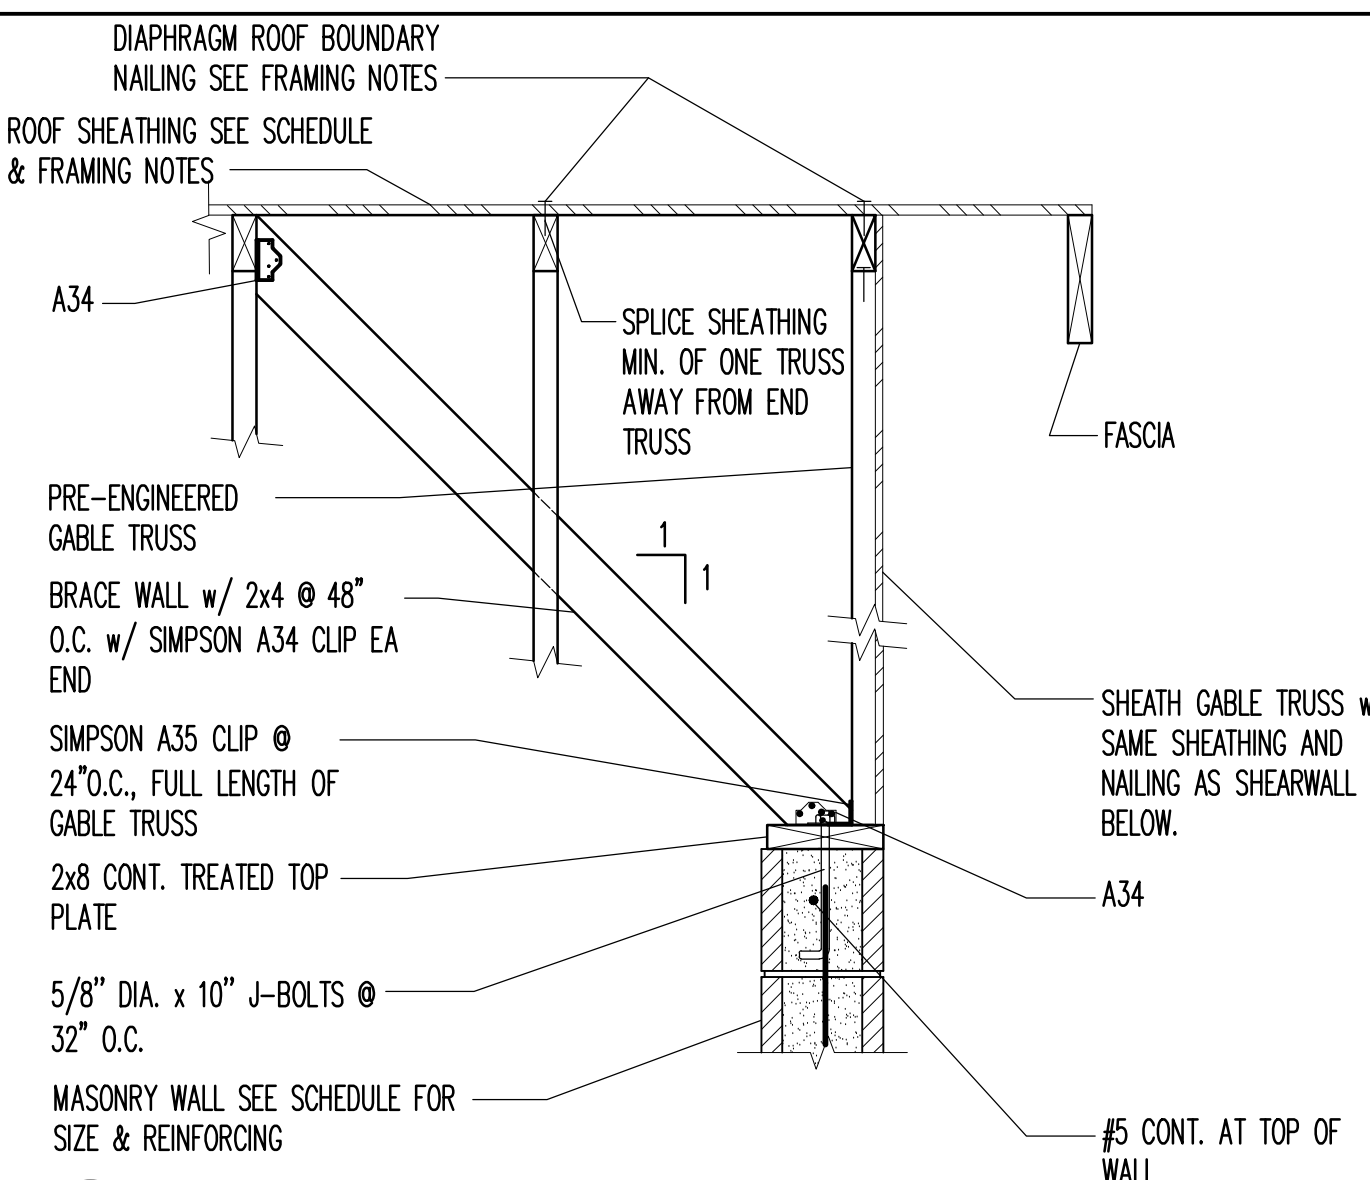


10 GABLE END TRUSS ON CMU WALL
 S1.2 N.T.S.

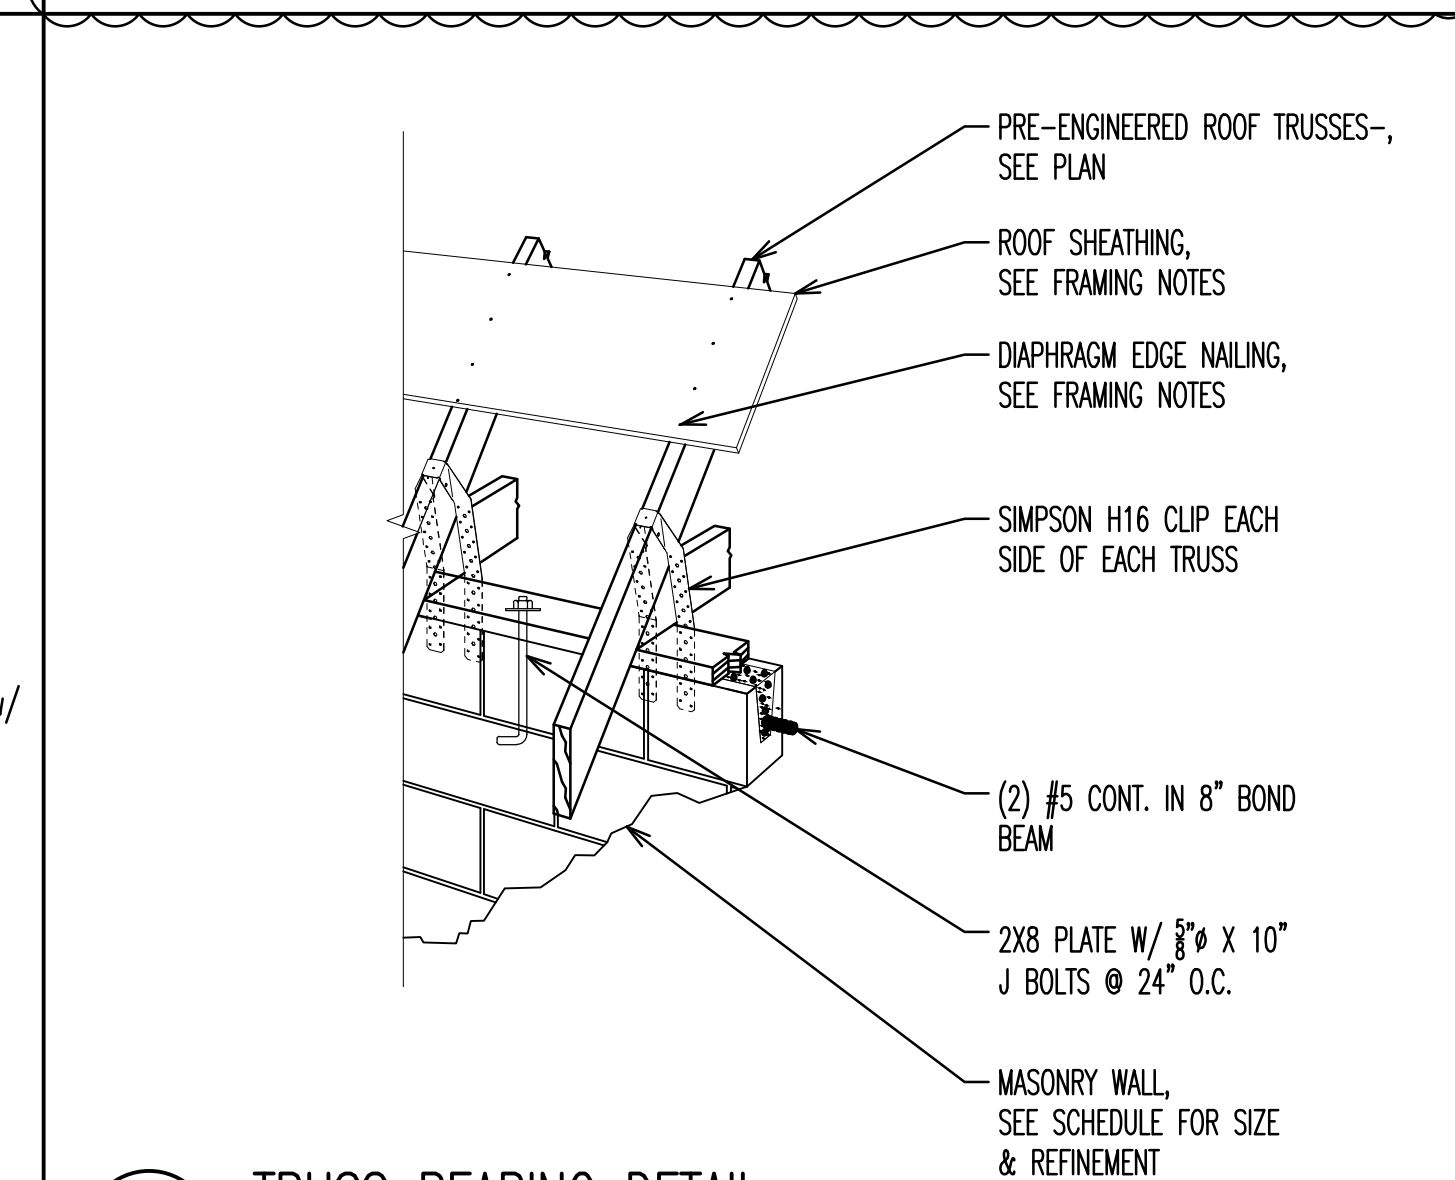

6 TRUSS BEARING DETAIL
 S1.2 N.T.S.

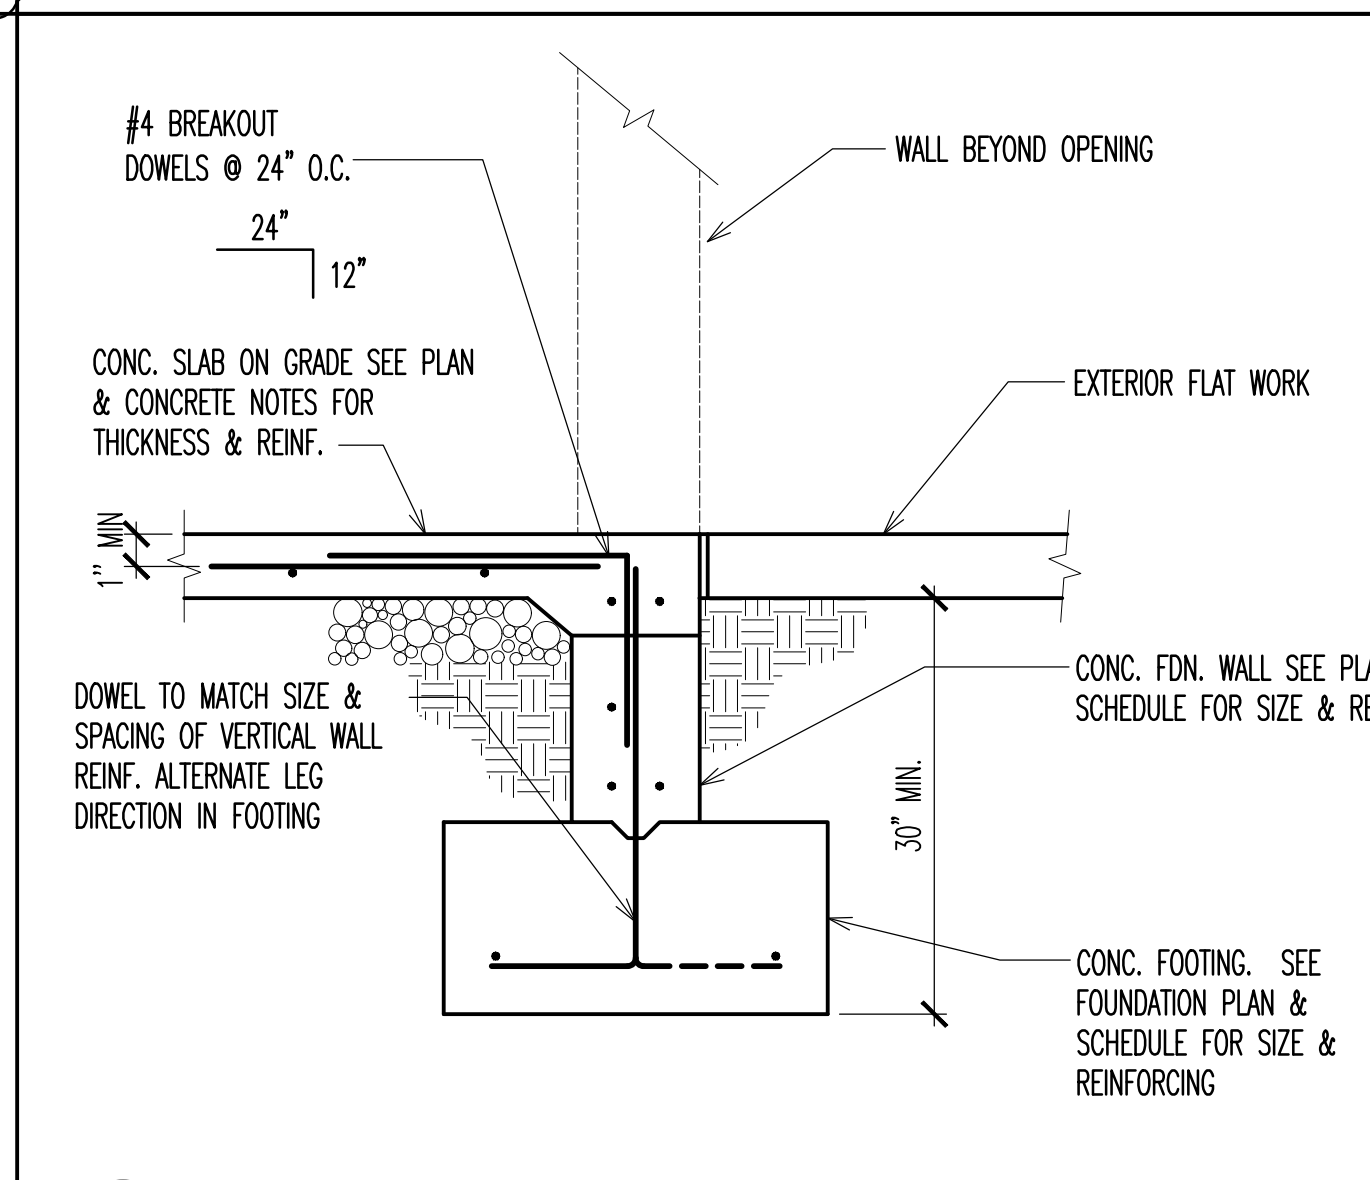


2 FOUNDATION @ OPENING DETAIL
 S1.2 N.T.S.

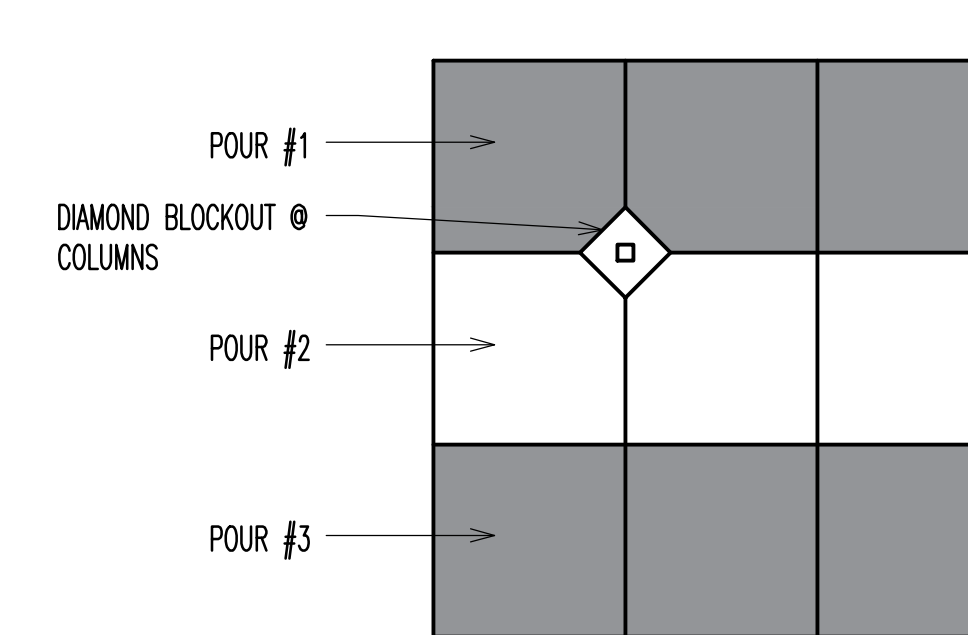


NOTES:
 1. JOINTS SHALL OCCUR AT MAIN COLUMN/GRID LINES W/ 15'-0" MAX. SPACING BETWEEN JOINTS @ 4" SLABS; 20'-0" MAX. @ 5" & 6" SLABS.
 2. SEE PLAN FOR SLAB THICKNESS "T" AND REINFORCING SIZE AND SPACING


11 CONTROL JOINT DETAIL
 S1.2 N.T.S.

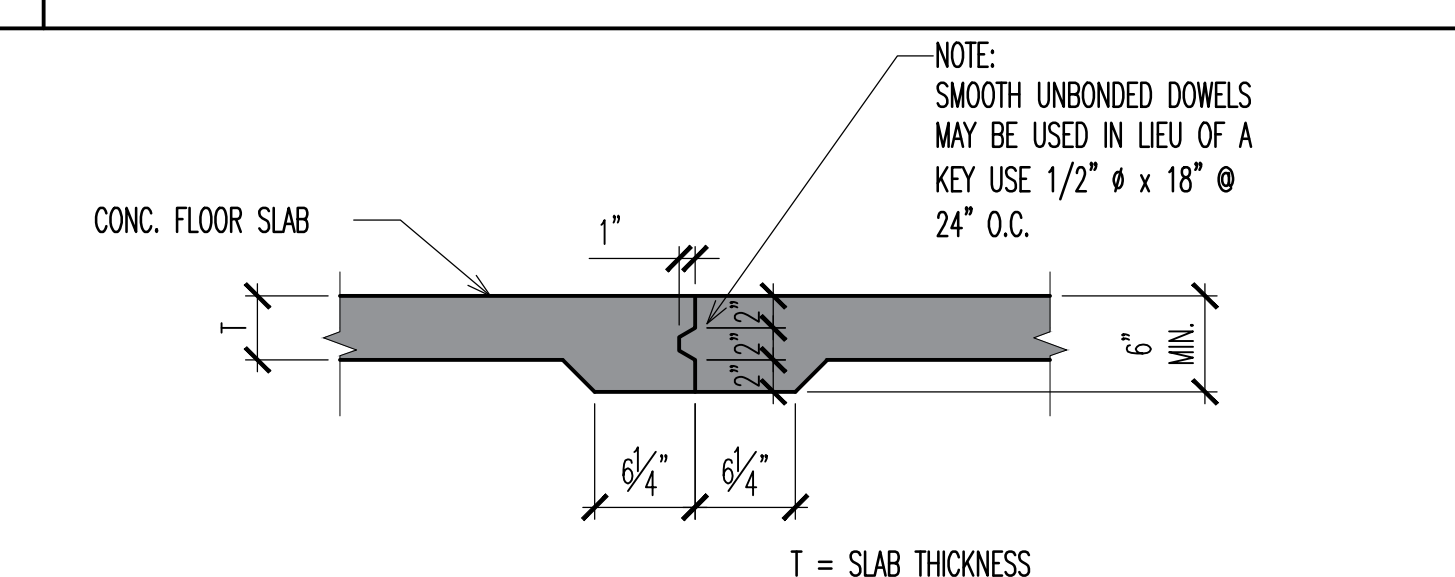


CONSTRUCTION JOINT

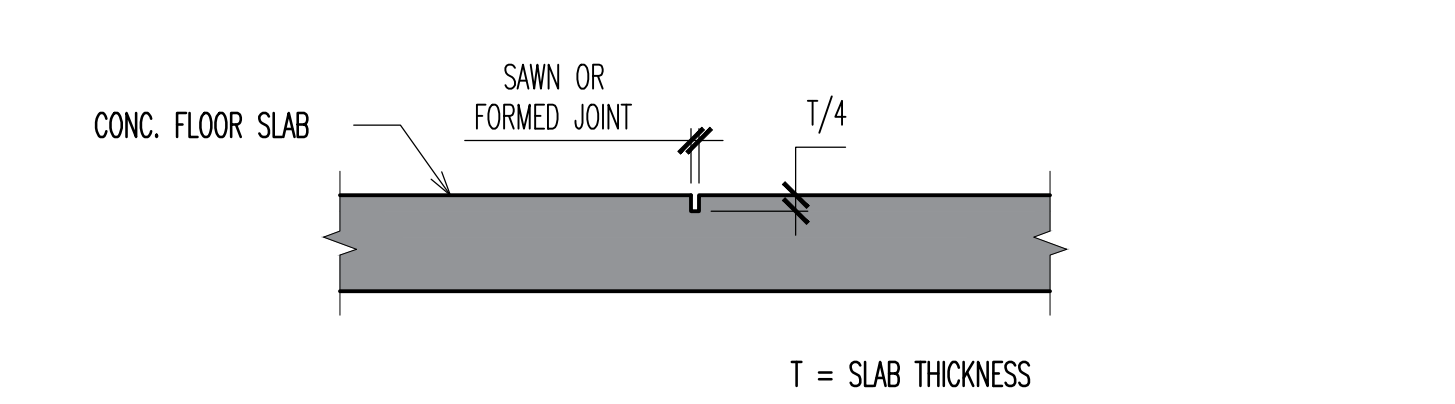


CONTROL JOINT

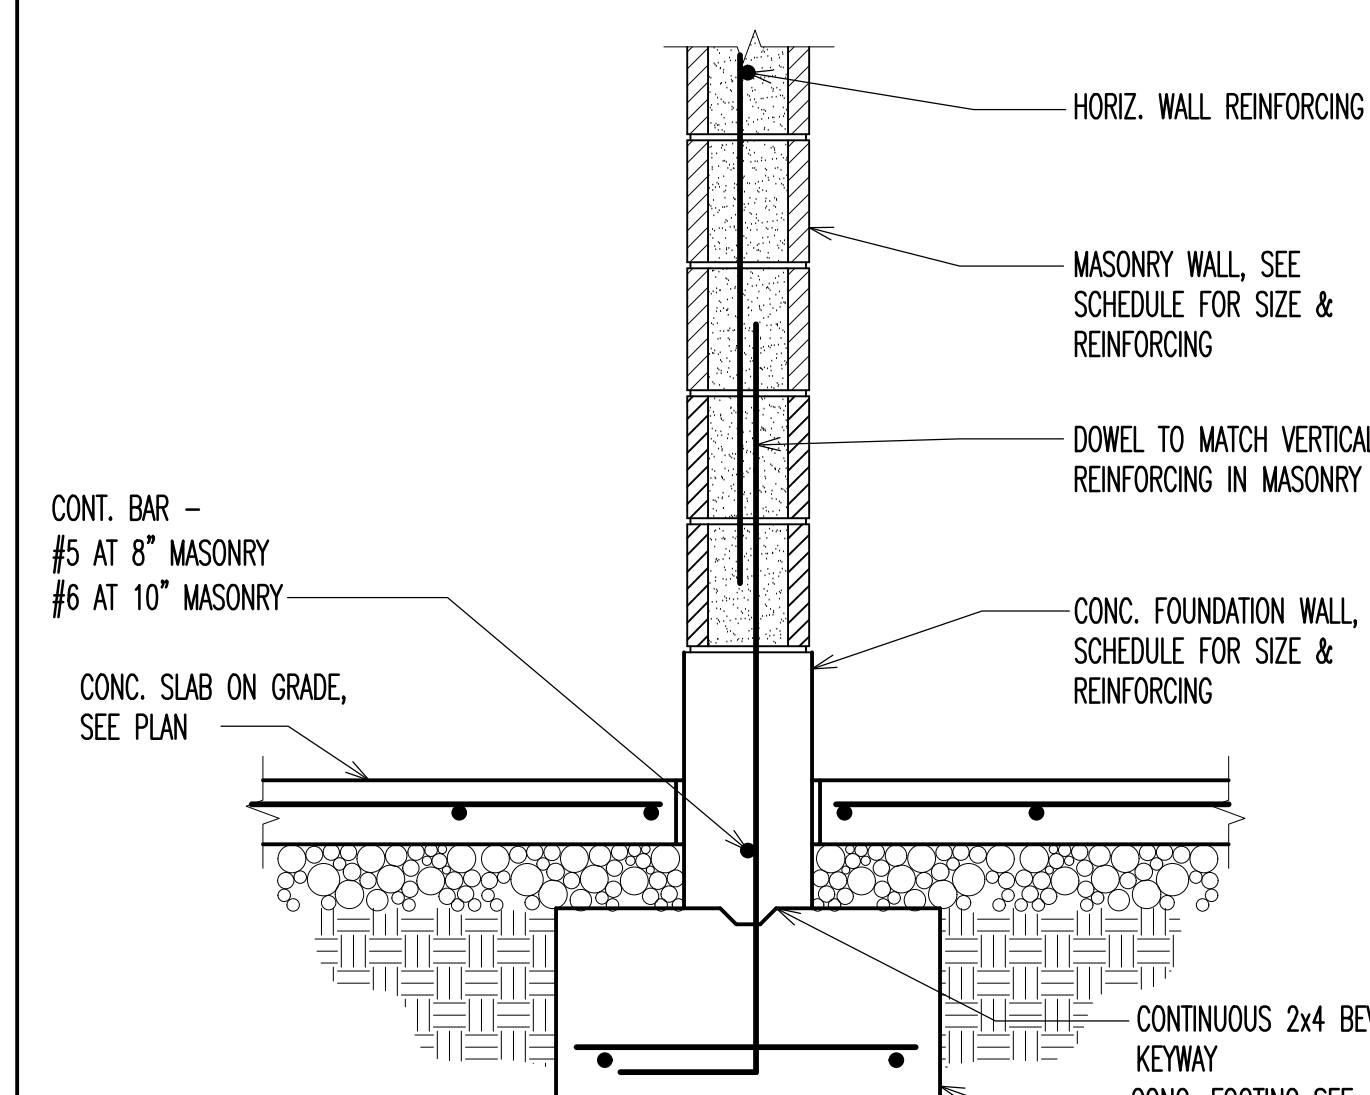

3 8" MASONRY WALL DETAIL
 S1.2 N.T.S.

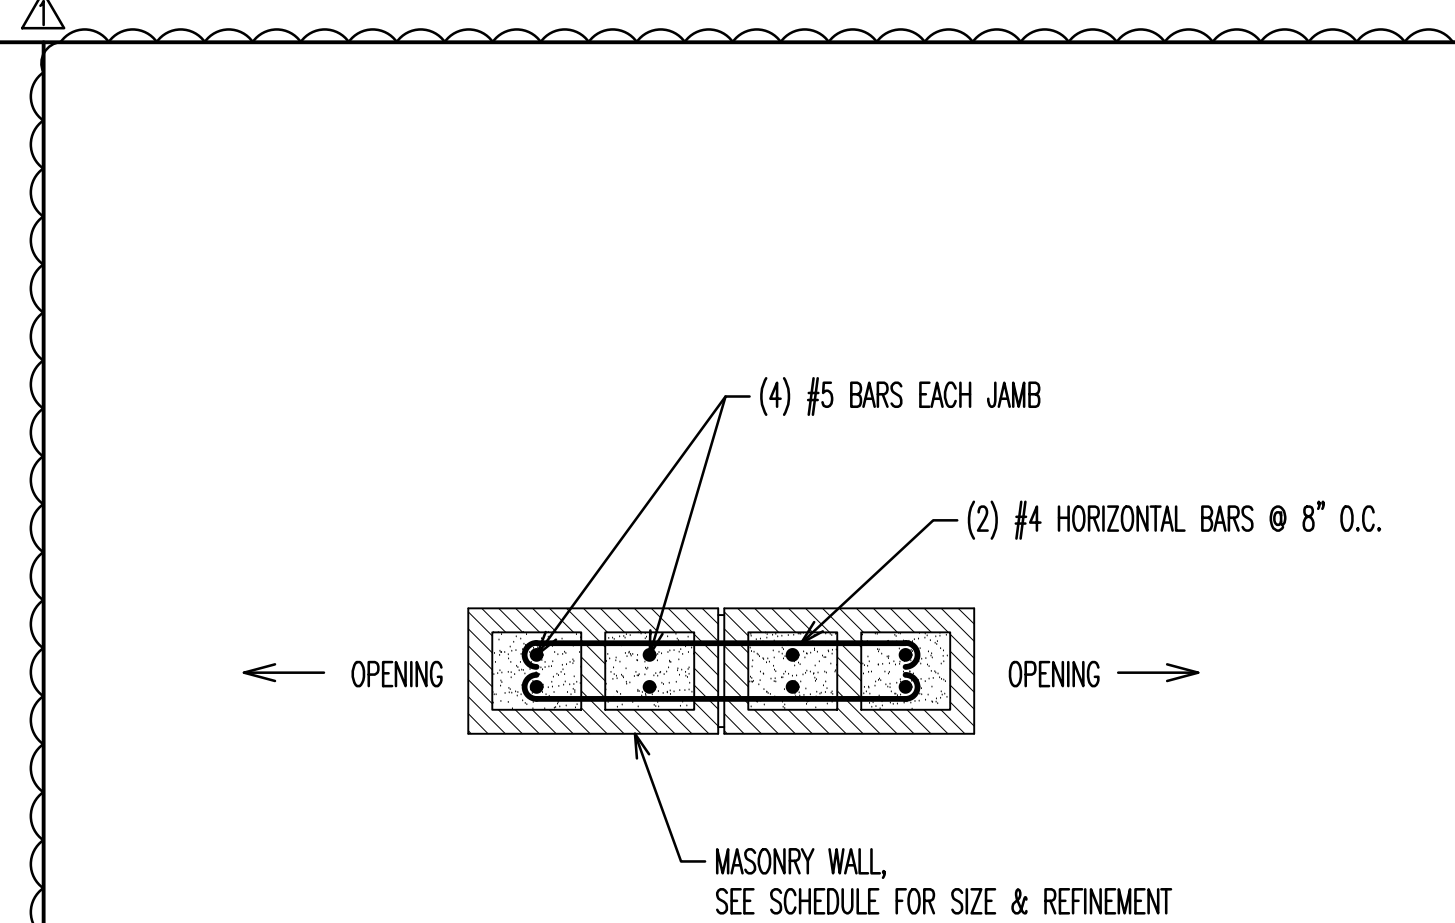

8 JAMB BETWEEN WINDOWS
 S1.2 N.T.S.

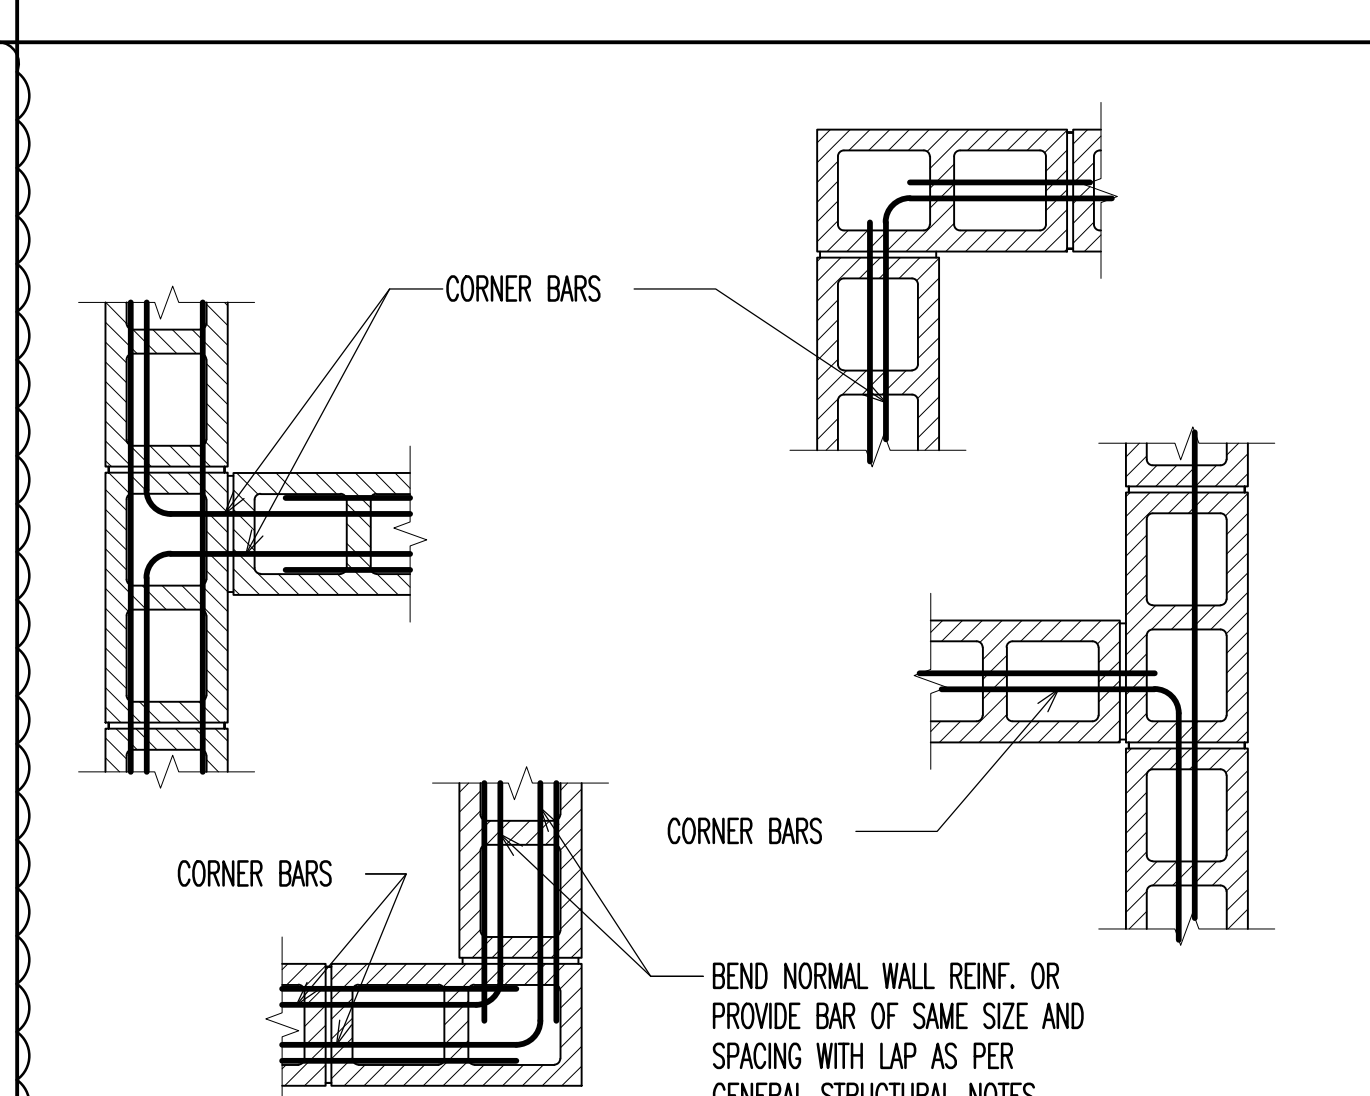

4 TYP. CORNER WALL REINF. DETAIL
 S1.2 N.T.S.

G.B.D
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 SITE AND LANDSCAPE ARCHITECTS
 610 East South Temple, Ste 50
 Salt Lake City, Utah 84102
 P 801.575.6066 F 801.575.6166
 www.gbrowndesign.com

PREPARED FOR:




CONSULTANTS:

MAGNA REGIONAL PARK
 PHASE 1
 4042 SOUTH 7200 WEST
 MAGNA, UTAH 84044

REVISIONS:

ASL #1	10-18-19

STAMP

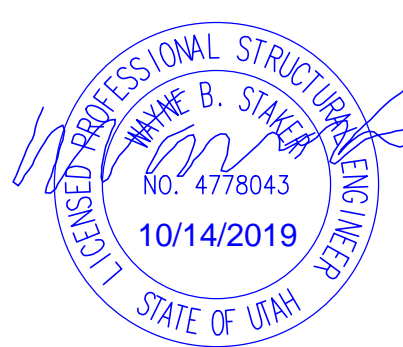

SHEET TITLE
 MAINTENANCE BUILDING
 DETAILS

DATE: 10-18-19
 DRAWN BY: MP
 CHECKED BY: SP
 JOB NO.: 19038

SHEET NO:

CONSTRUCTION DOCUMENTS - CONFORMED SET

REVIEWED FOR CODE COMPLIANCE
 FOR COMPLIANCE WITH THE UTAH BUILDING CODE (UBC) AND LOCAL ORDINANCES.
 WEST COAST CODE CONSULTANTS, INC.
 11/13/19

MASONRY LINTEL SCHEDULE					
LINTEL MARK	LINTEL WIDTH	LINTEL DEPTH	REINFORCING		NOTES
			HORIZONTAL	STIRRUPS	
ML-1	8"	2'-0"	(2) #5 TOP & BOTTOM	#3 @ 24" O.C.	GROUT SOLID
ML-2	8"	1'-4"	(2) #4 TOP & BOTTOM		GROUT SOLID

MASONRY LINTEL NOTES:

- LINTEL SHALL MATCH WALL WIDTH AND MATERIAL TYPE. U.N.O.
- SOLID GROUT MASONRY LINTELS MONOLITHICALLY WITH THE WALL OR COLUMN AT EACH END. SHORE AS REQUIRED.
- CONSULT THE STRUCTURAL ENGINEER FOR LINTELS NOT SHOWN ON THE PLANS THAT ARE LOCATED DIRECTLY BELOW FLOOR / ROOF BEAMS OR GIRDERS.
- EXTEND ALL HORIZONTAL REINFORCING 48 BAR DIAMETERS MINIMUM BEYOND THE EDGE OF ALL OPENINGS PROVIDE 90° STANDARD HOOK. IF HORIZONTAL REINFORCING CANNOT EXTEND 48 BAR DIAMETERS BEYOND EDGE OF OPENING.
- SPLICE TOP BARS AT MIDSPAN OF LINTEL ONLY AND BOTTOM BARS OVER SUPPORTS ONLY.
- CONTINUE HORIZONTAL WALL REINFORCING THRU MASONRY LINTELS. USE LARGER REINFORCING WHERE BOTH HORIZONTAL WALL REINFORCING AND LINTEL REINFORCING OCCUR IN THE SAME COURSE.
- DOWEL VERTICAL WALL REINFORCING INTO THE FULL DEPTH OF LINTEL OR 48 BAR DIAMETERS, WHICHEVER IS LESS.
- SEE GENERAL STRUCTURAL NOTES FOR ALL OTHER REQUIREMENTS.


NOTE: DO NOT SCALE PLANS. SEE ARCHITECTURAL PLANS FOR WALL LOCATIONS
NOTE: DESIGN TRUSSES WITH 72 PSF OVER PRESSURE LOAD APPLIED AS ADDITIONAL WIND LOAD

= 4" SLAB W/ #4 BARS @ 18" O.C. EACH WAY UNDERLAIN BY 4" OF FREE DRAINING GRAVEL

MCJ = MASONRY CONTROL JOINT

CONCRETE FOUNDATION WALL SCHEDULE						
MAX. HEIGHT	MIN. THICK	VERT. STEEL	HORZ. STEEL	TOP AND BOTTOM HORZ. REINFORCEMENT	WALL TYP.	REMARKS
4'-0"	8"	#4 @ 32" O.C.	#4 @ 12" O.C.	(2) #4	A	

WALL TYPE "A"

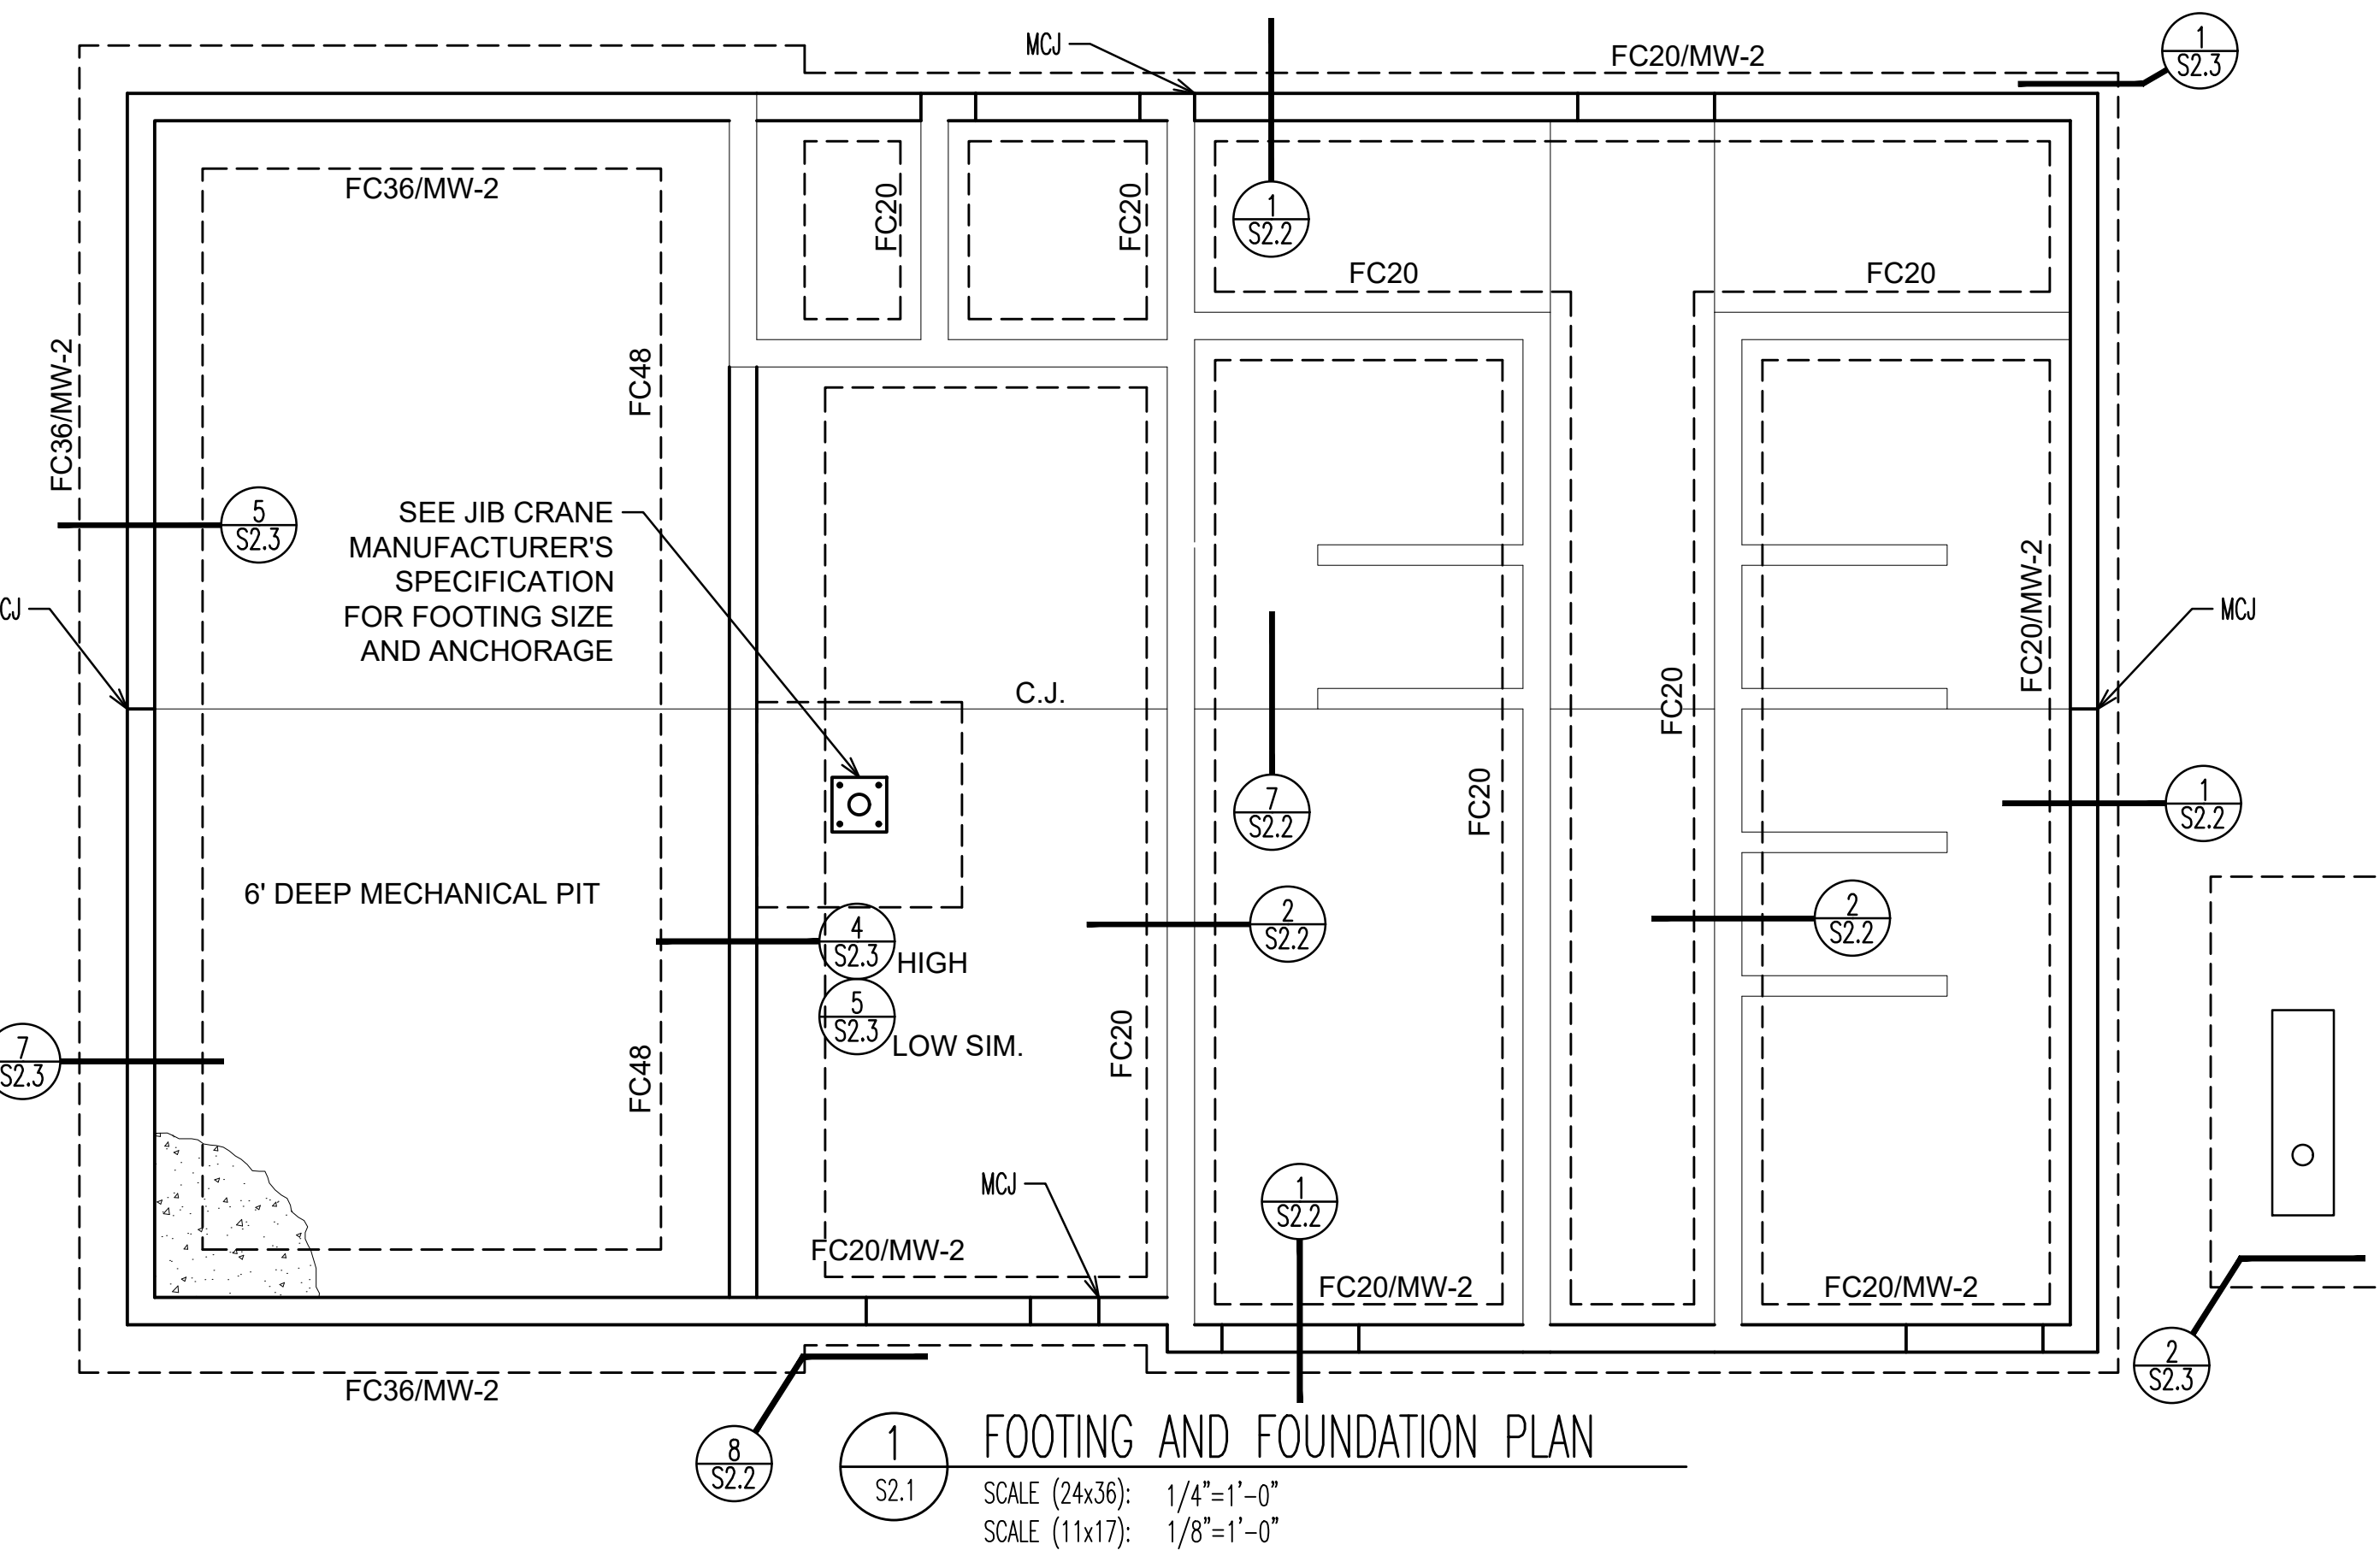

MASONRY WALL SCHEDULE										
WALL MARK	THICKNESS	MATERIALS	SOLID GROUT	REINFORCING			SPECIAL INSP. REQ'D.	JAMBS & ENDS		
				VERTICAL	HORIZONTAL	JOINTS				
MW-1	8"	CMU	NO	(1) #5 @ 24" O.C. E.F.	(2) #4 @ 32" O.C.	DURAWALL @ 16" O.C.	YES	(4) #5 VERT. IN TWO CELLS		
MW-2	8"	CMU	NO	(1) #5 @ 24" O.C.	(2) #4 @ 48" O.C.	DURAWALL @ 16" O.C.	YES	(2) #5 VERT. IN TWO CELLS		

NOTE:

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- DO NOT SOLID GROUT WALLS UNLESS NOTED OTHERWISE.
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- CONTINUE HORIZONTAL WALL REINFORCING THRU MASONRY LINTELS. USE LARGER REINFORCING WHERE BOTH HORIZONTAL WALL REINFORCING AND LINTEL REINFORCING OCCUR IN THE SAME COURSE.
- SEE GENERAL STRUCTURAL NOTES FOR ALL OTHER REQUIREMENTS.
- MASONRY WALLS NOT DESIGNATED ON THE PLANS SHALL BE REINFORCED AS FOLLOWS:
- $f_m = 2500$ PSI
- REINFORCING STEEL TO BE GRADE 60
- CONTROL JOINTS TO BE 24'-0" MAX

ROOF FRAMING NOTES:


- ALL EXTERIOR WALLS SHALL BE CONSIDERED BEARING U.N.O.
- ALL EXTERIOR BEARING WALLS SHALL BE CONSTRUCTED WITH DFL#2 2x6 STUDS @ 16" ON CENTER, U.N.O.
- PROVIDE STANDARD CONSTRUCTION FOR ALL WINDOW AND DOOR OPENINGS (TWO KING STUDS AND ONE TRIMMER AT EACH END) U.N.O.
- WALL SHEATHING: 7/16" APA SHEATHING @ 6" O.C. AT PANEL EDGES AND 12" O.C. IN FIELD, U.N.O.
- PROVIDE DOUBLE TRIMMERS @ OPENINGS > 5'-0"
- ALL POSTS AND COLUMNS MUST PROVIDE A DIRECT CONTINUOUS BEARING LINE THROUGH TO THE FOOTING/FOUNDATION.
- U.N.O. THE TRUSS MFG. SHALL BE RESPONSIBLE FOR ALL TRUSS RELATED CONNECTIONS.
- TRUSS MANUFACTURER TO DESIGN FOR ALL ADD LOADS; MECHANICAL UNITS, SNOW DRIFT ETC.
- ROOF SHEATHING: 3/8" APA 32/16 WITH 100 COMMON NAILS @ 6" O.C. AT SUPPORTED EDGES AND 12" O.C. IN FIELD, U.N.O.
- USE "H" CLIPS ON ROOF SHEATHING

LEGEND

- [Symbol] = OVERBUILD
- (2) [Symbol] = HEADER/BEAM LOCATION
- [Symbol] = BEARING WALL

FOOTING SCHEDULE										
MARK	WIDTH	LENGTH	DEPTH	REINFORCING CROSSWISE			REINFORCING LENGTHWISE			
				NO	SIZE	LENGTH	SPACING	NO	SIZE	LENGTH
FC20	1'-8"	CONT.	1'-0"				3	#4	CONT.	EQUAL
FC36	3'-0"	CONT.	1'-0"	#5	3'-0"	14" O.C.	4	#5	CONT.	EQUAL
FC48	4'-0"	CONT.	1'-0"	#5	3'-6"	14" O.C.	4	#5	CONT.	EQUAL
FC54	4'-6"	CONT.	1'-0"	#5	4'-0"	14" O.C.	5	#5	CONT.	EQUAL

ALLOWABLE SOIL BEARING PRESSURE FROM SOILS REPORT = 2000 PSF
 MINIMUM COMPRESSIVE CONCRETE STRENGTH $f_c = 3000$ PSI
 ALL REINFORCING STEEL SHALL BE GRADE 60 AND BE PROPERLY TIED INTO PLACE PRIOR TO POUR
 ALL CONCRETE WORK MUST MEET THE REQUIREMENTS OF THE 2015 IBC, ACI 318 AND LOCAL ORDINANCES
 ALL BARS MUST BE 3" CLEAR FROM GRADE

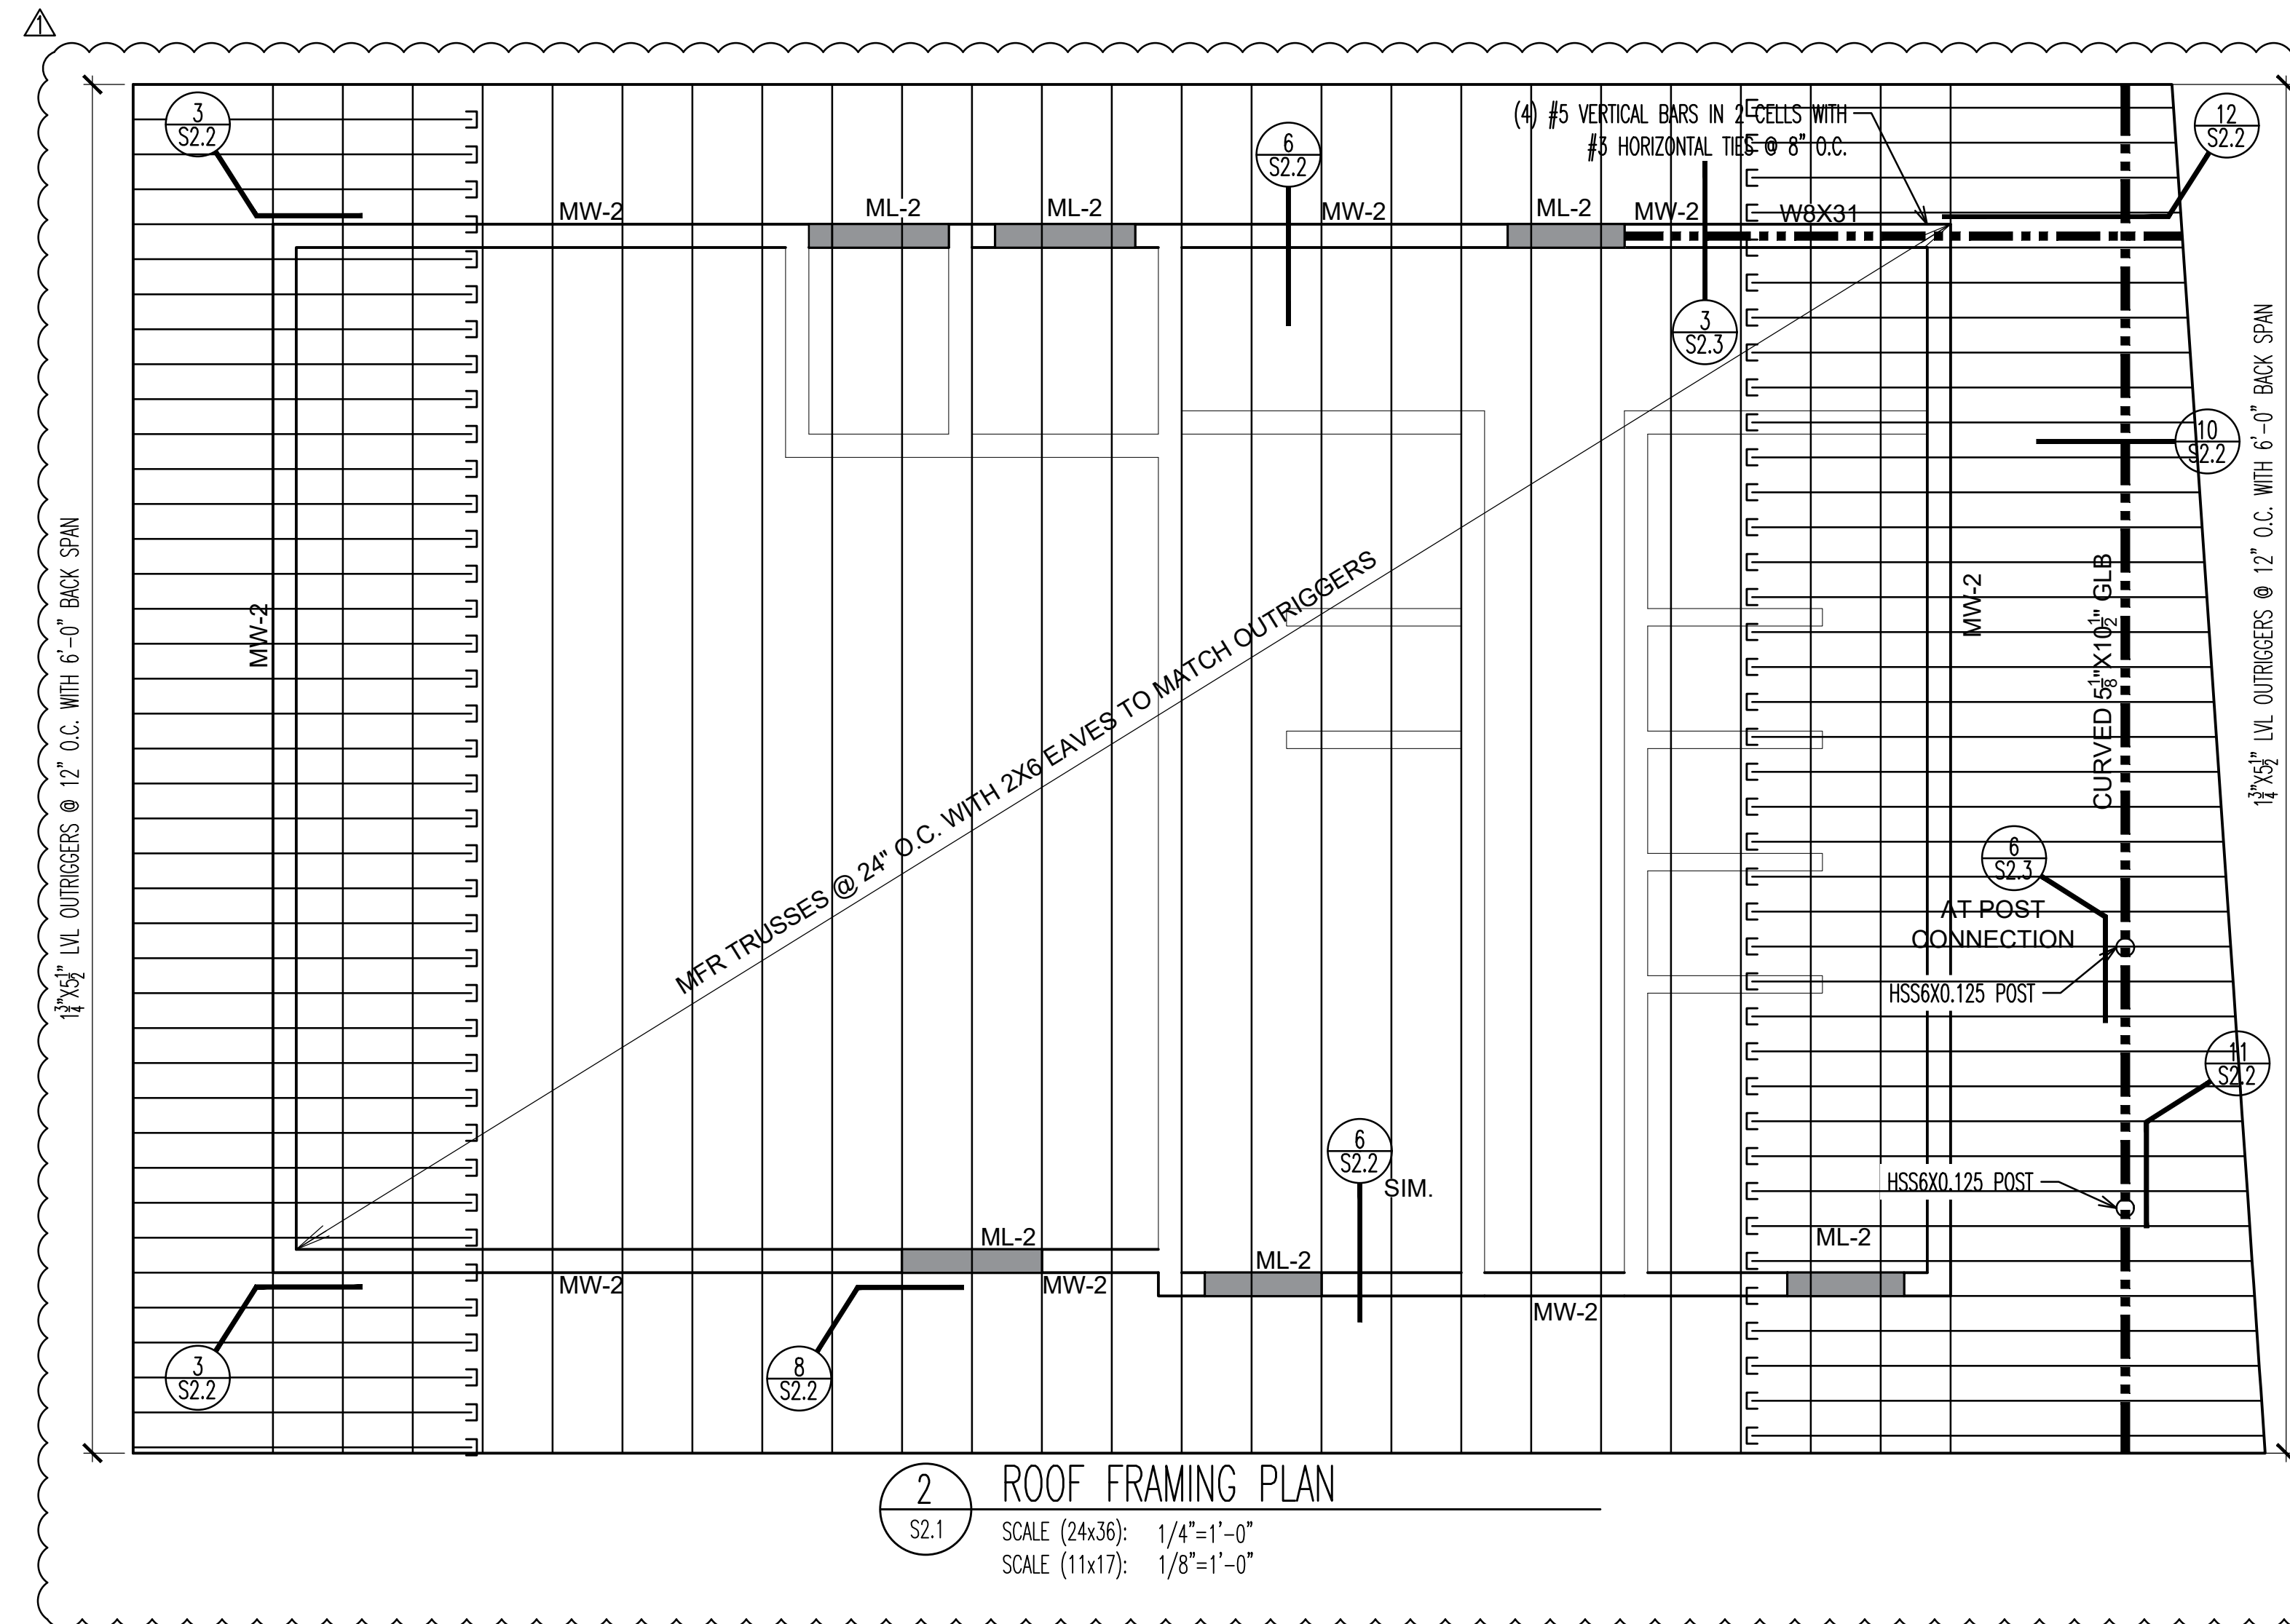

FOOTING EXCAVATIONS SHALL BE INSPECTED AND APPROVED IN WRITING BY A QUALIFIED GEOTECHNICAL ENGINEER PRIOR TO CONCRETE PLACEMENT

Reviewed by Greg Baptist Date 11/21/2019

PREPARED FOR:



CONSULTANTS:

**MAGNA REGIONAL PARK
 PHASE 1**
 4042 SOUTH 7200 WEST
 MAGNA, UTAH 84044

REVISIONS:

NO.	DESCRIPTION	DATE
1	AS# #1	10-18-19

STAMP



SHEET TITLE
 RESTROOM BUILDING
 FRAMING PLAN

DATE: 10-18-19
 DRAWN BY: MP
 CHECKED BY: SP
 JOB NO.: 19038


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CONSTRUCTION DOCUMENTS - CONFORMED SET


REVIEWED FOR CODE COMPLIANCE
 FOR COMPLIANCE WITH THE APPLICABLE CONSTRUCTION CODES IDENTIFIED BELOW:
 () BUILDING () STRUCTURAL
 () MECHANICAL () PLUMBING
 () ELECTRICAL () ENERGY
 () ACCESSIBILITY () FIRE

PLAN REVIEW ACCEPTANCE OF DOCUMENTS DOES NOT AUTHORIZE CONSTRUCTION TO PROCEED IN VIOLATION OF ANY FEDERAL, STATE, OR LOCAL REGULATIONS.


11/13/19
 WEST COAST CODE CONSULTANTS, INC.

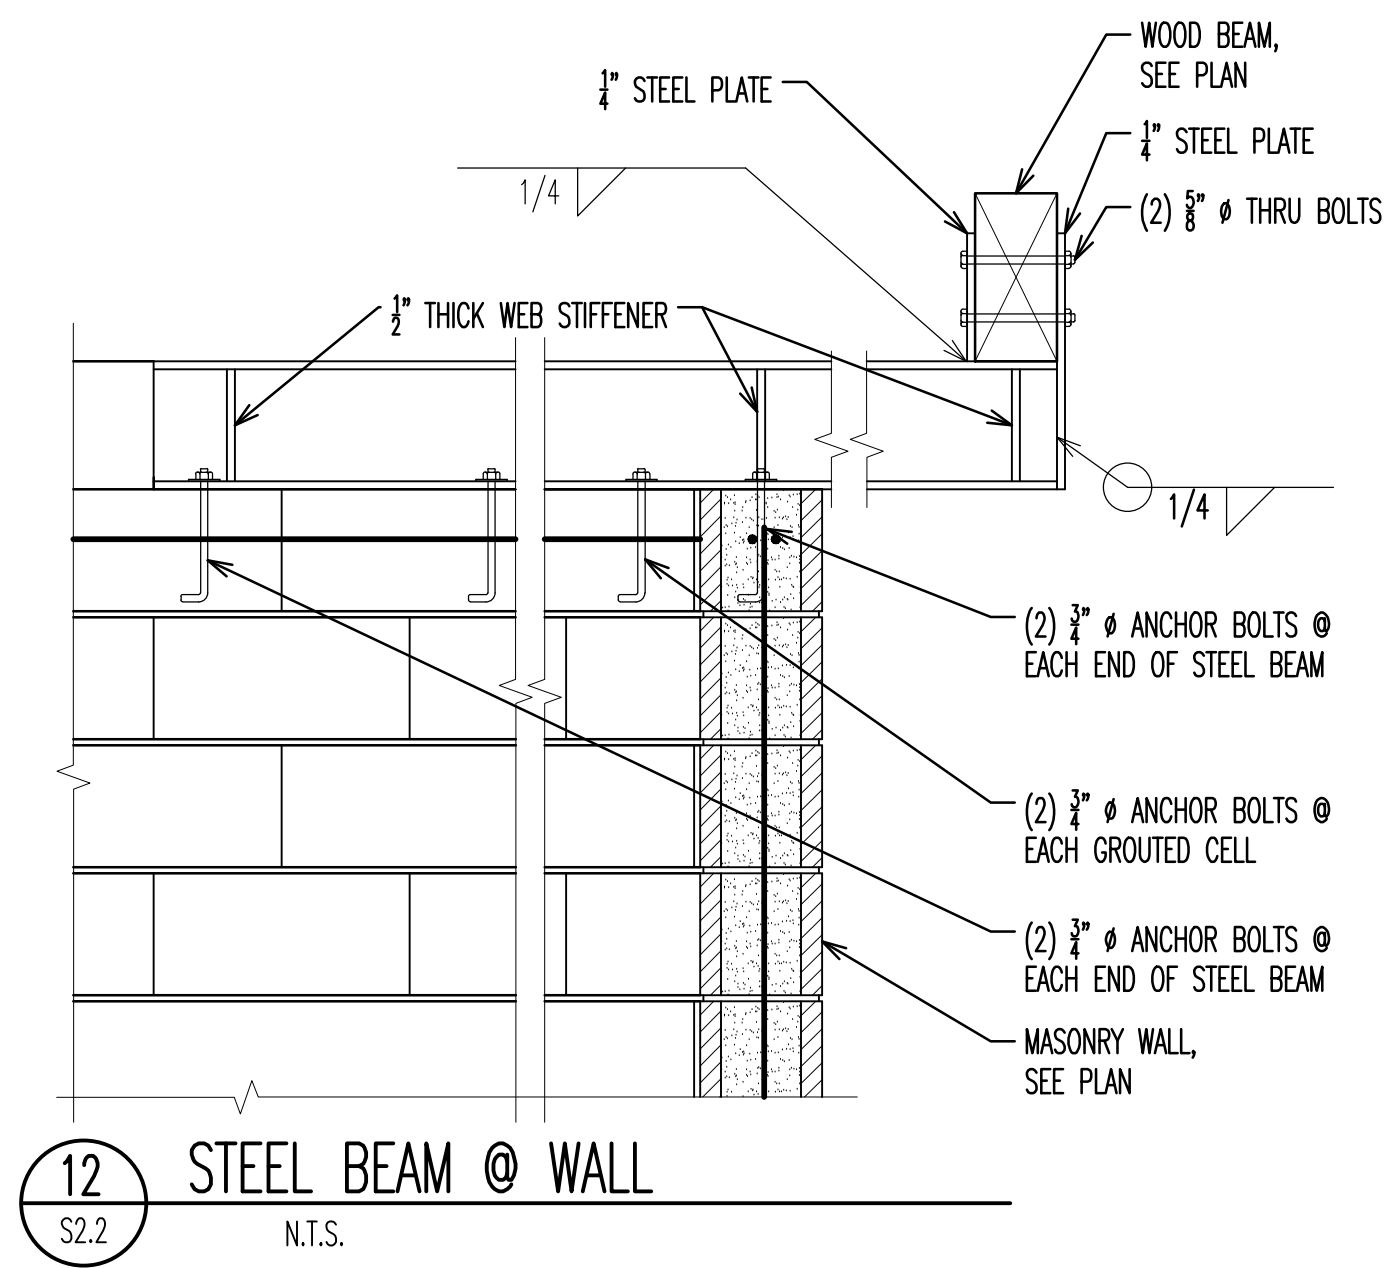


12 STEEL BEAM @ WALL
 S2.2 N.T.S.

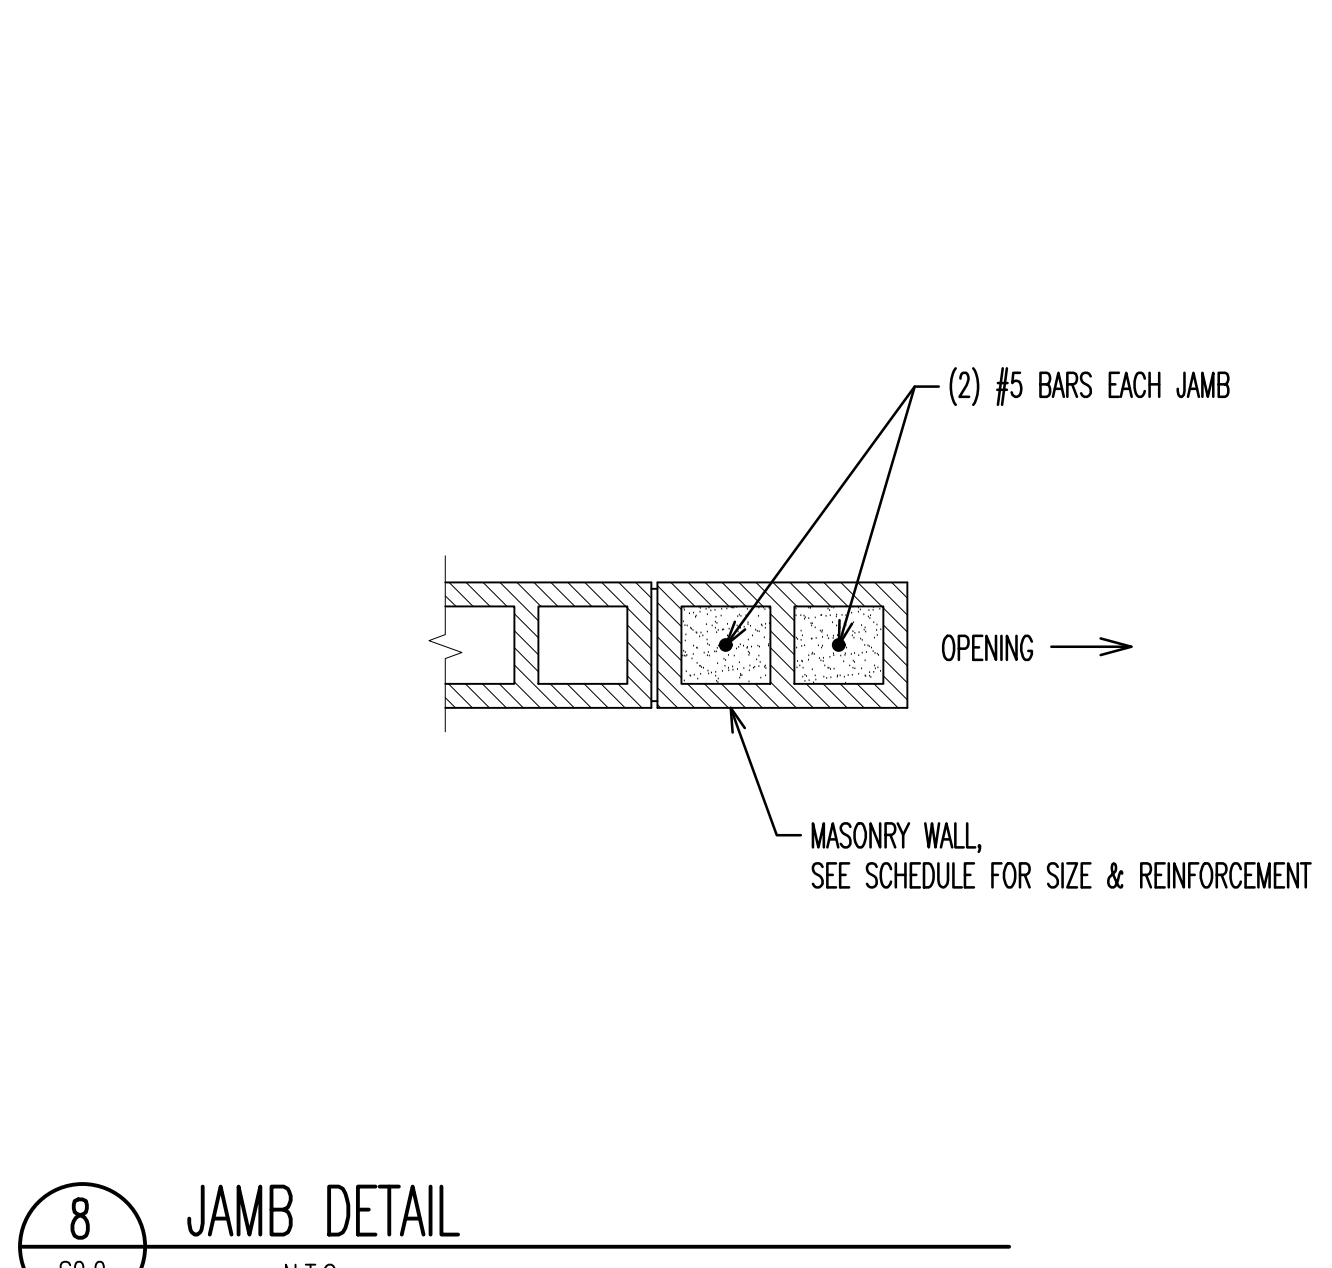

8 JAMB DETAIL
 S2.2 N.T.S.

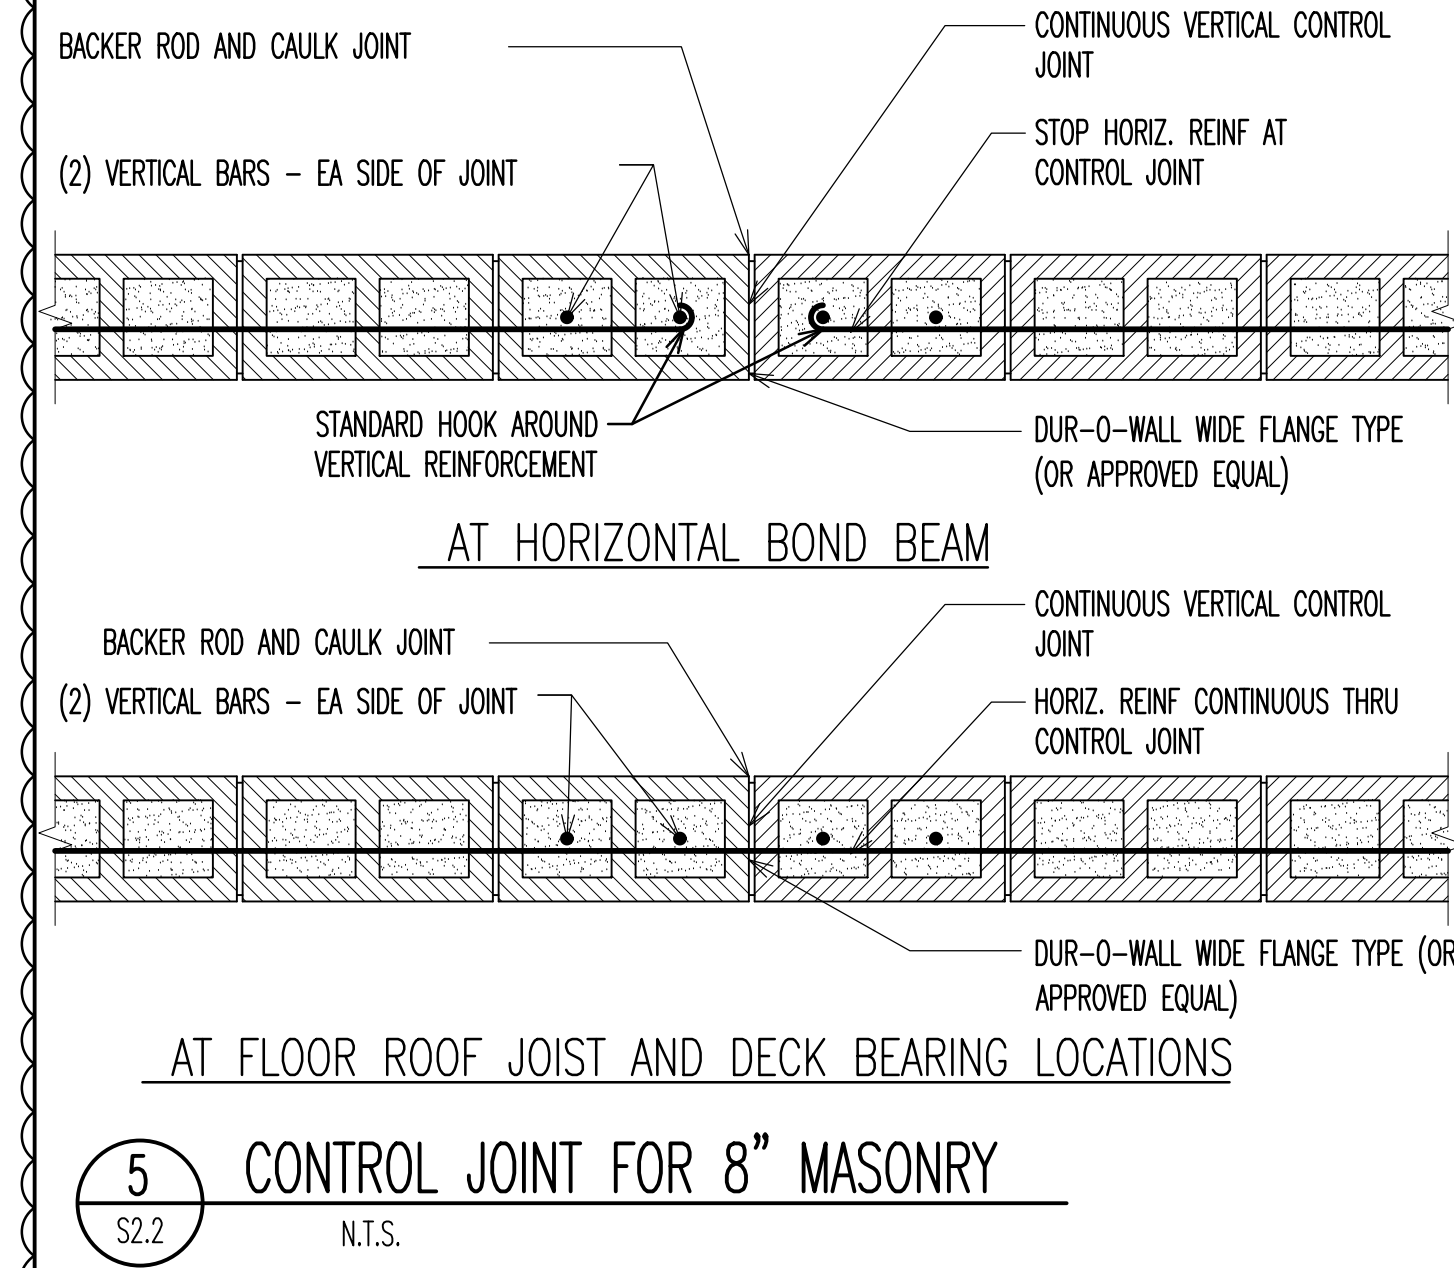


5 CONTROL JOINT FOR 8" MASONRY
 S2.2 N.T.S.

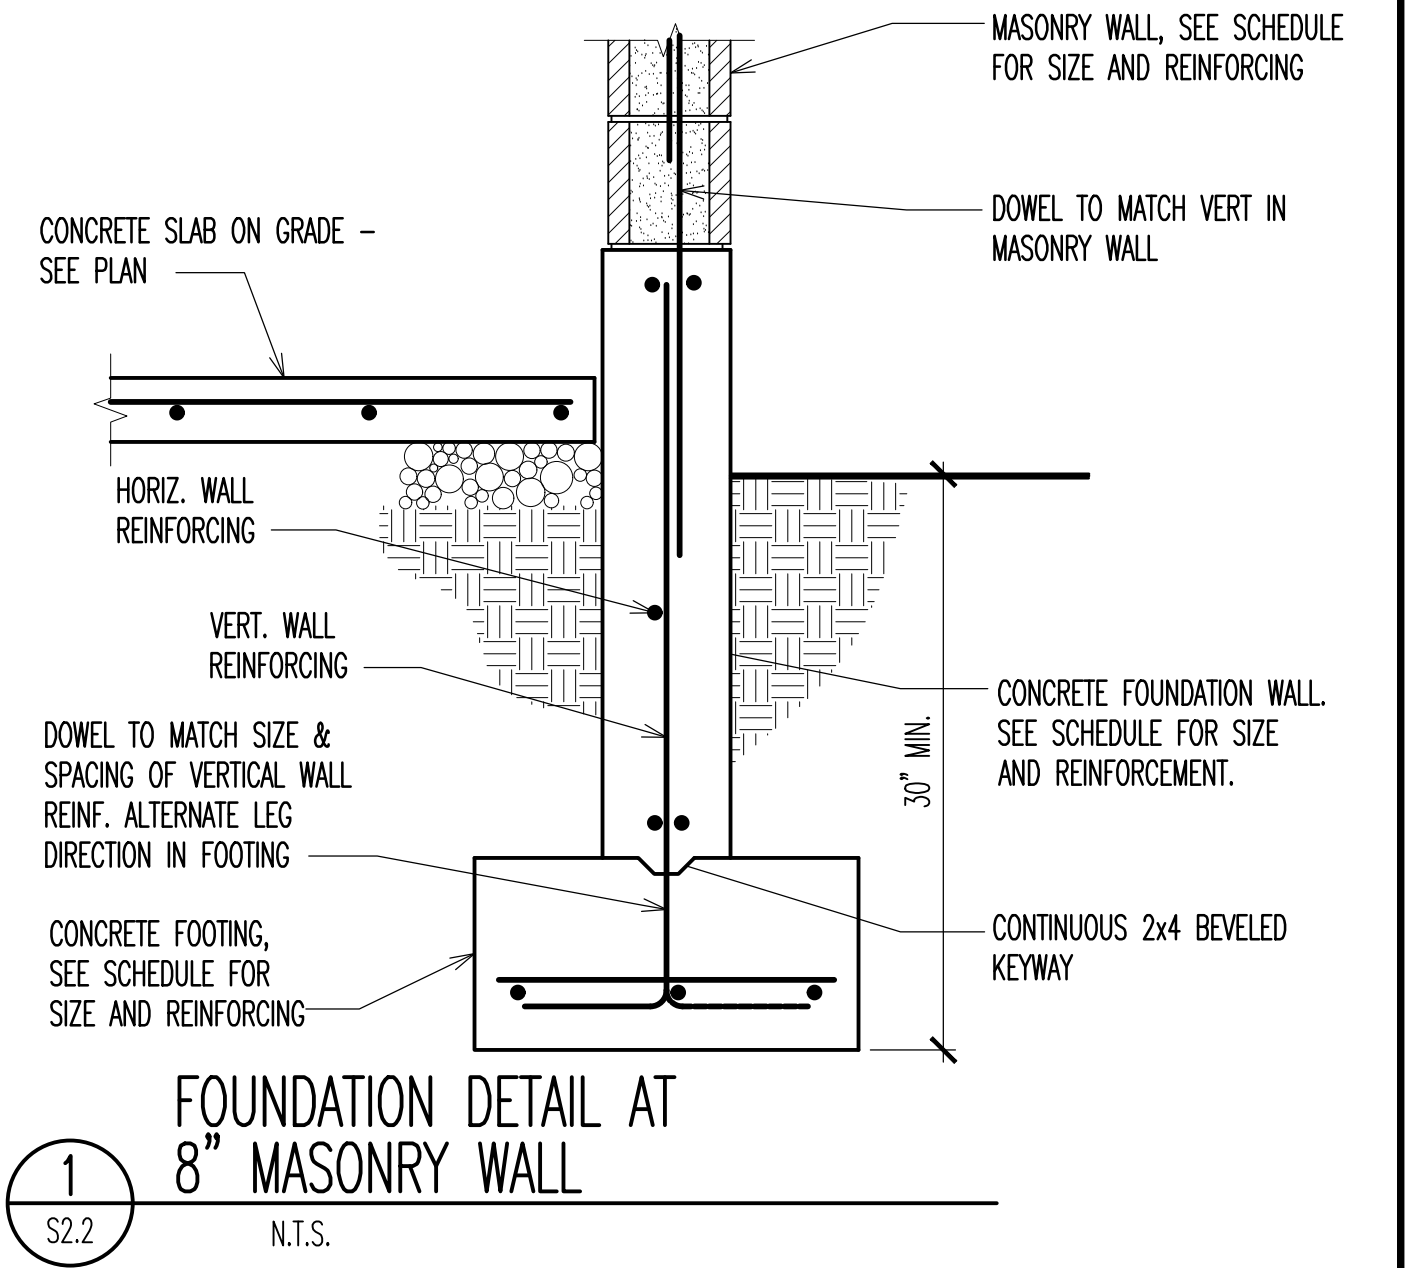


1 FOUNDATION DETAIL AT 8" MASONRY WALL
 S2.2 N.T.S.




9 GABLE END TRUSS ON CMU WALL
 S2.2 N.T.S.

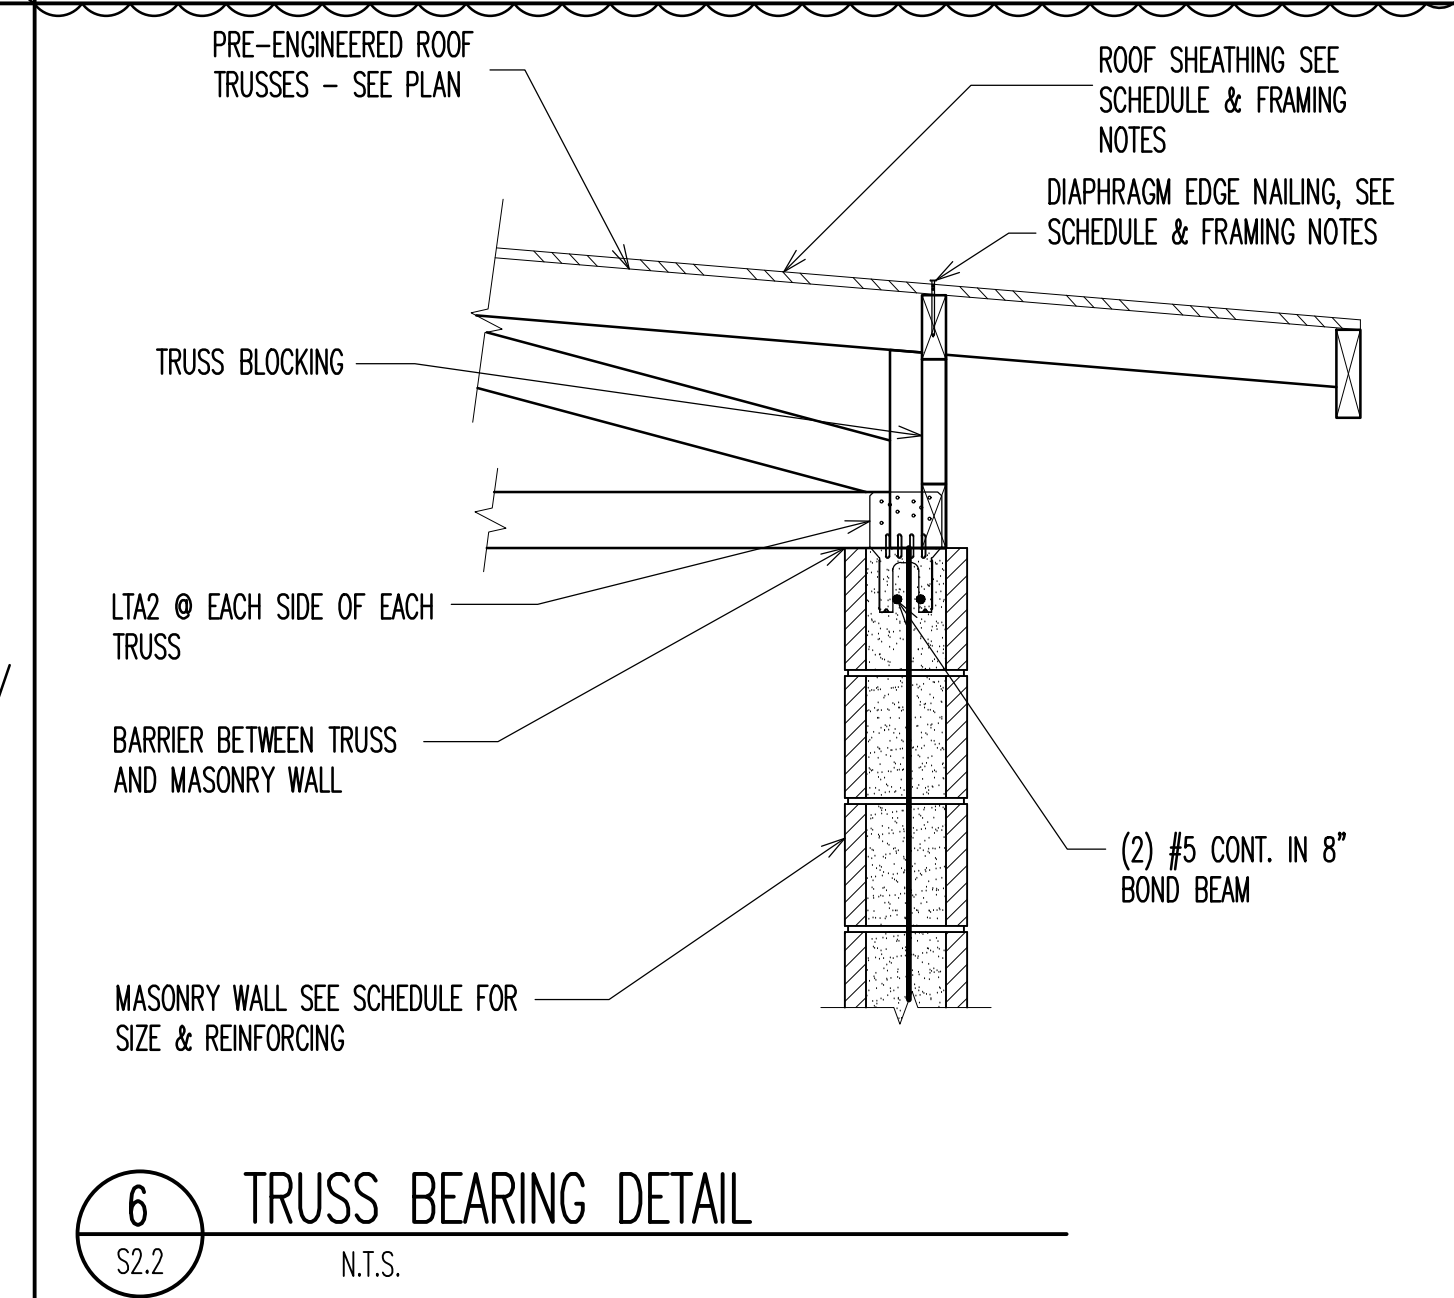


6 TRUSS BEARING DETAIL
 S2.2 N.T.S.

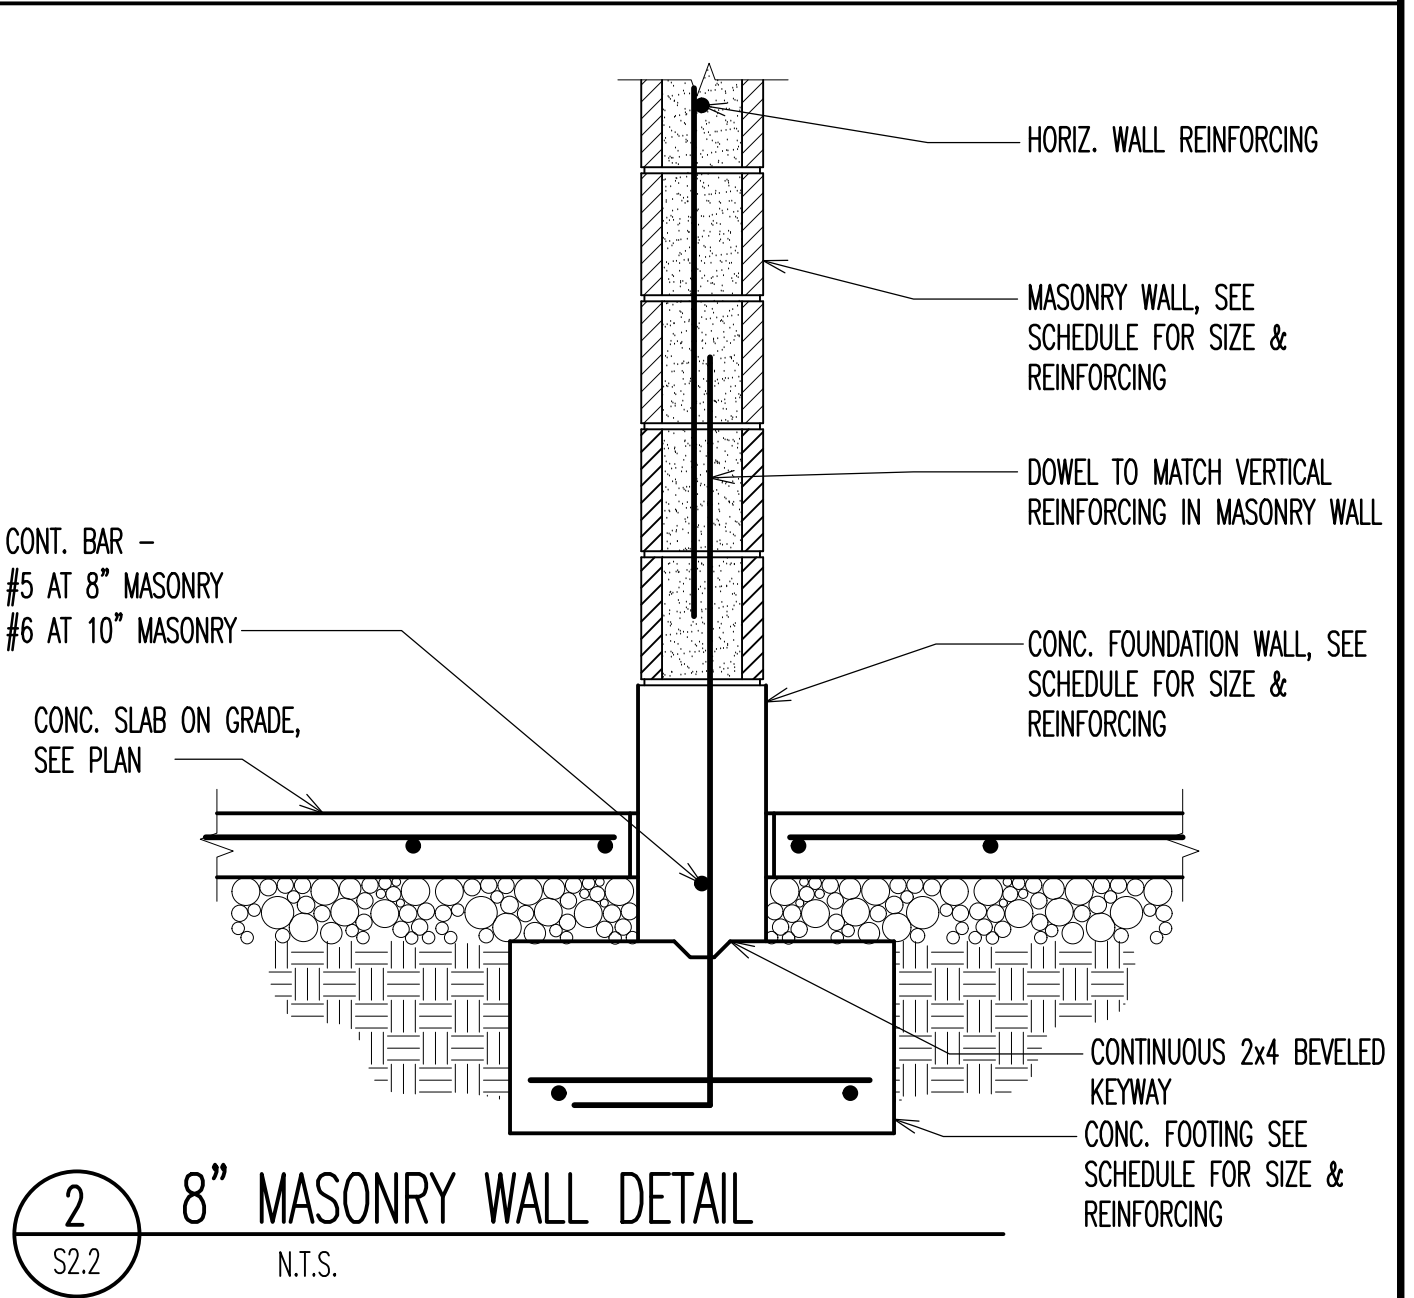

2 8" MASONRY WALL DETAIL
 S2.2 N.T.S.

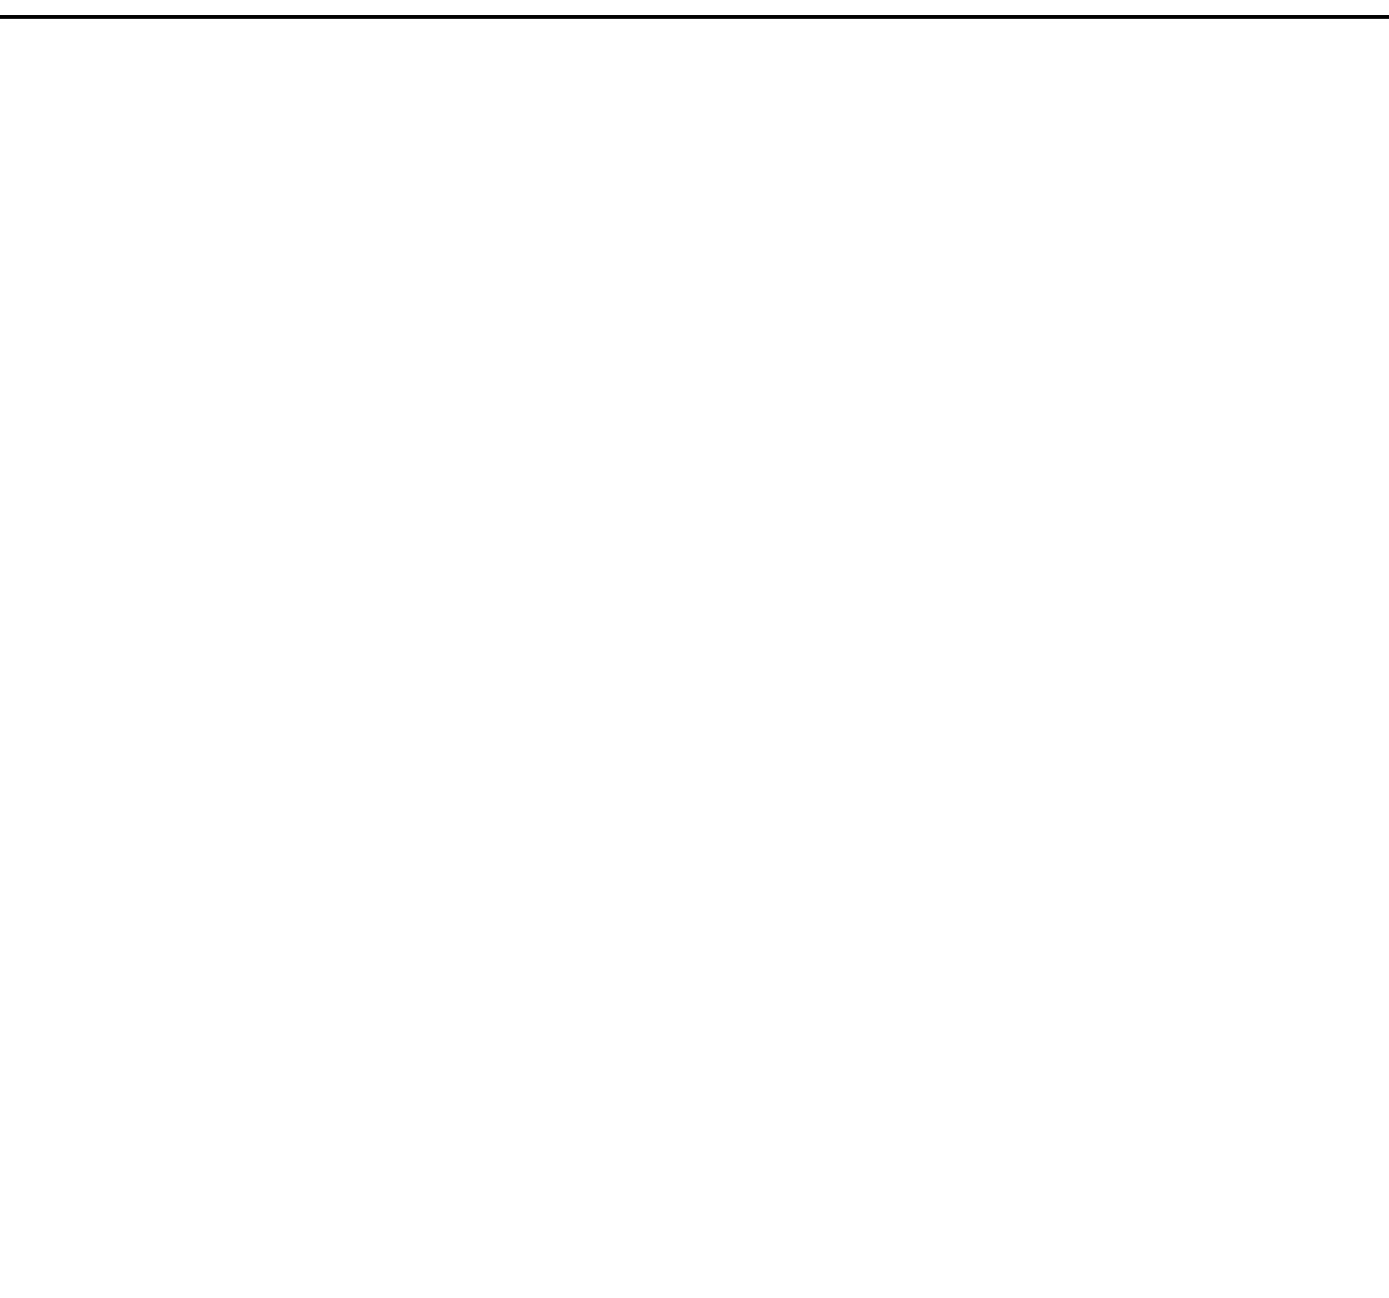


10 ROOF FRAMING DETAIL
 S2.2 N.T.S.

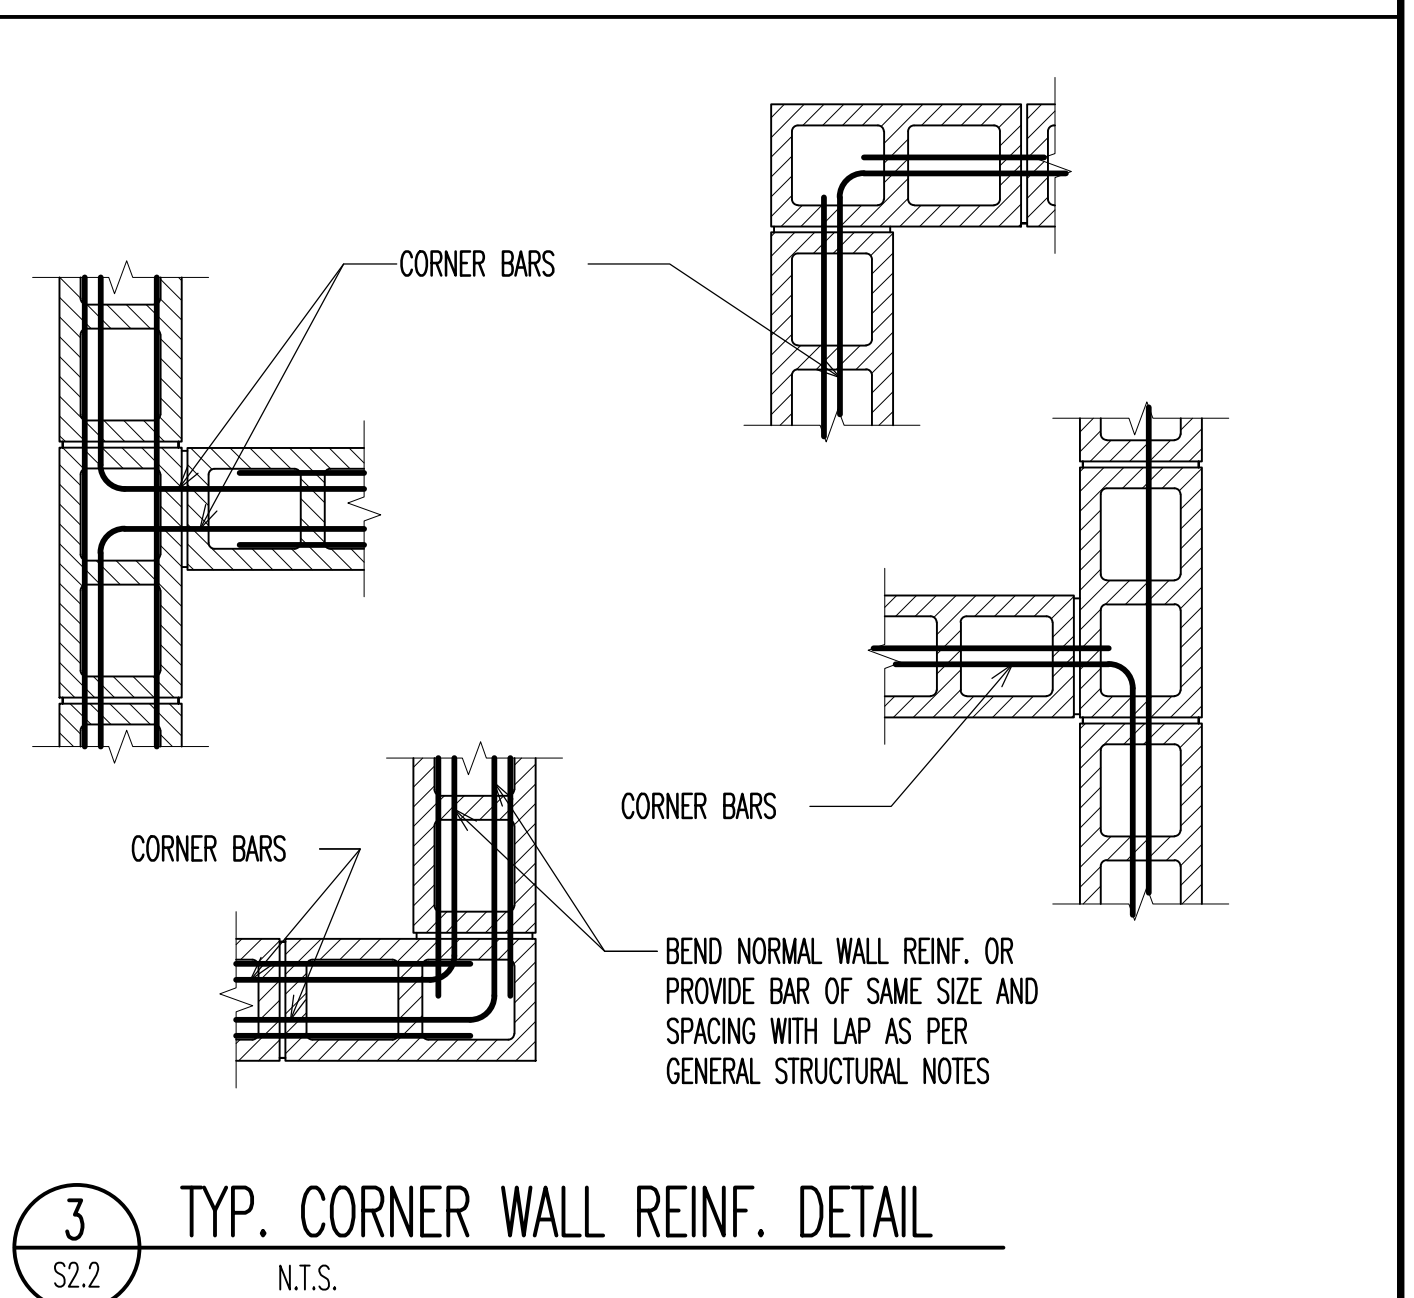


3 TYP. CORNER WALL REINF. DETAIL
 S2.2 N.T.S.



11 BEAM TO COLUMN DETAIL
 S2.2 N.T.S.

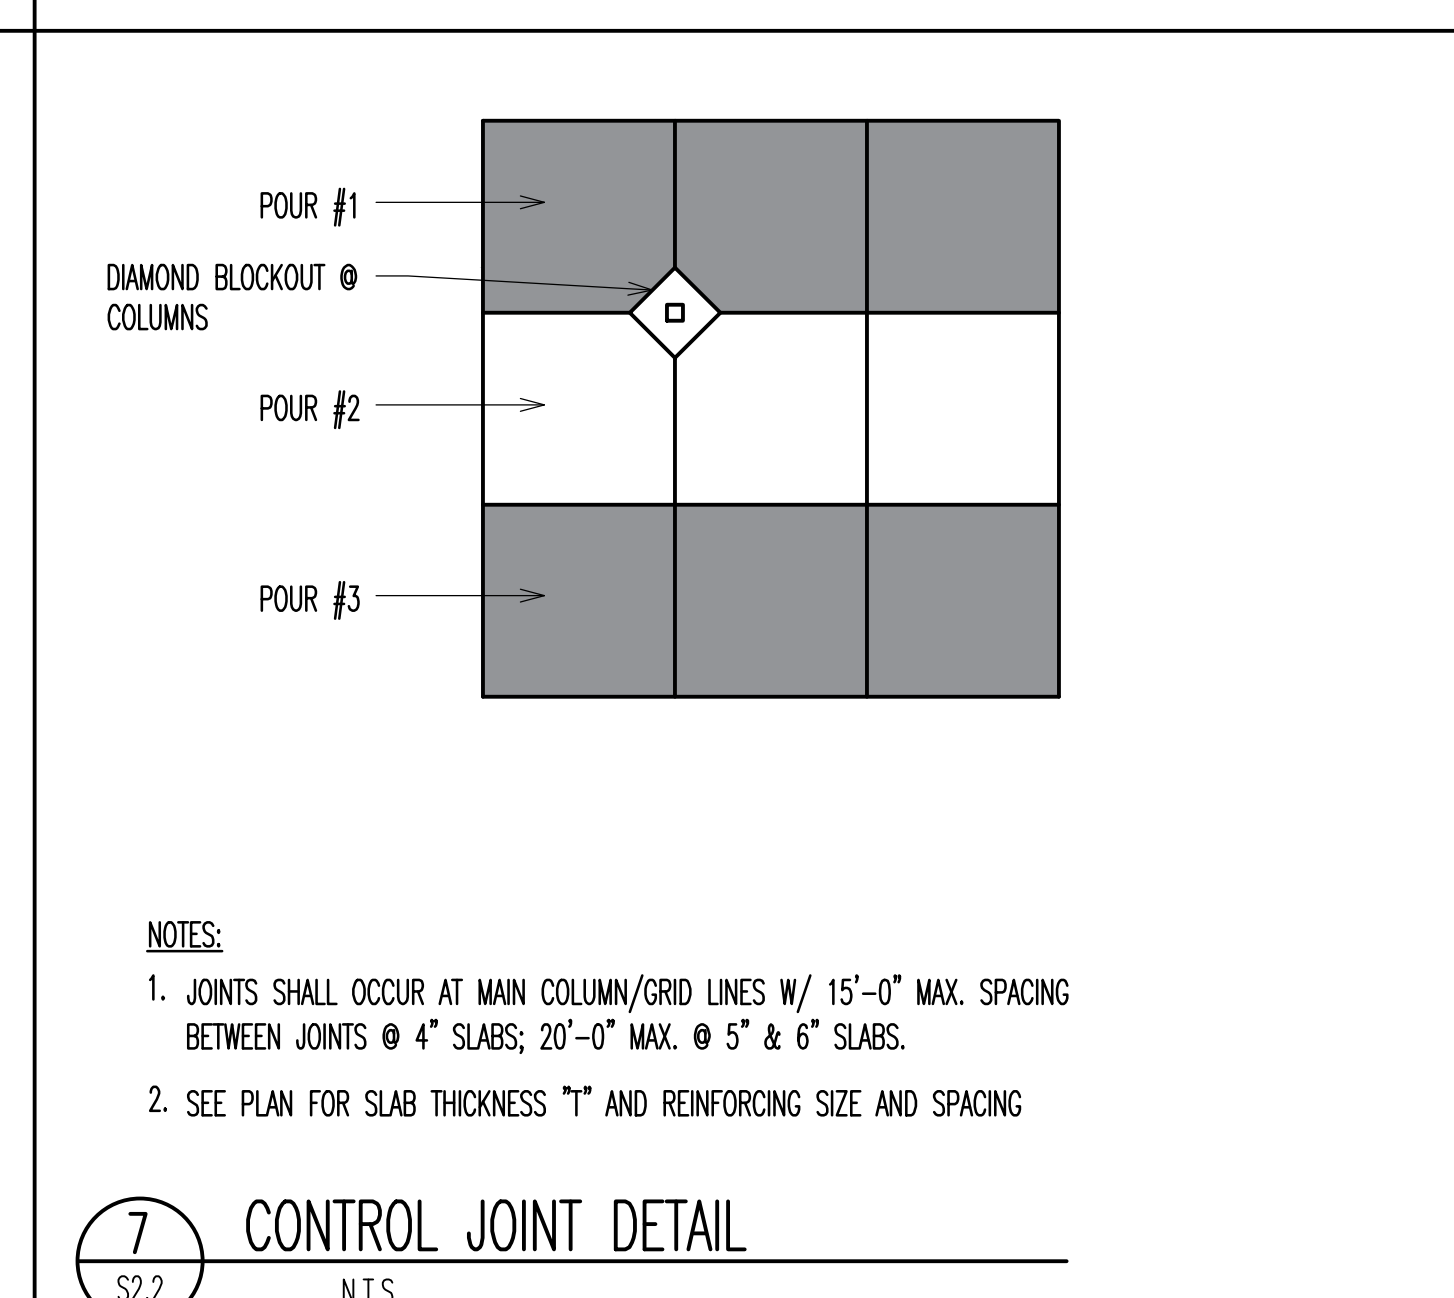

7 CONTROL JOINT DETAIL
 S2.2 N.T.S.

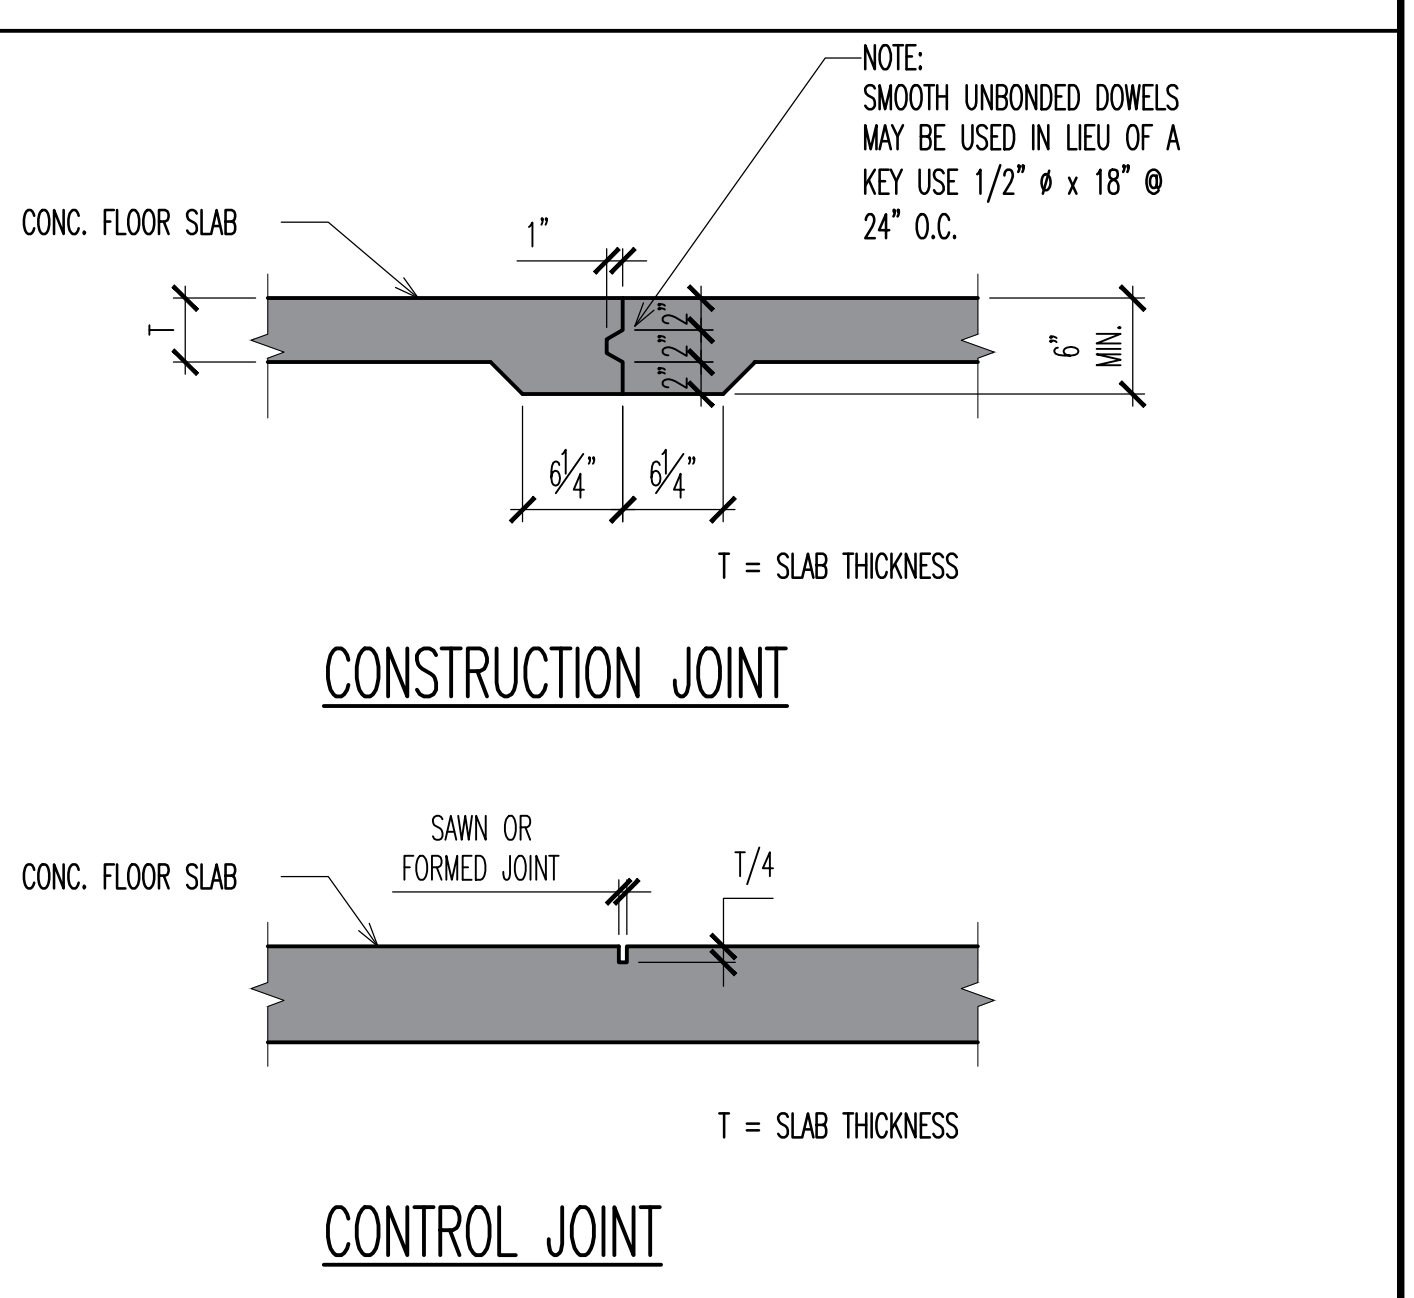

CONSTRUCTION JOINT
 CONTROL JOINT
 S2.2 N.T.S.

REVISIONS:

△ ASI #1	10-18-19
△	
△	
△	

STAMP


SHEET TITLE
 RESTROOM BUILDING
 DETAILS

DATE: 10-18-19
 DRAWN BY: MP
 CHECKED BY: SP
 JOB NO.: 19038


SHEET NO:

CONSTRUCTION DOCUMENTS - CONFORMED SET


REVIEWED FOR CODE COMPLIANCE
 FOR COMPLIANCE WITH THE APPLICABLE CONSTRUCTION CODES IDENTIFIED BELOW
 BUILDING STRUCTURAL
 MECHANICAL PLUMBING
 ELECTRICAL ENERGY
 ACCESSIBILITY FIRE
 PLAN REVIEW ACCEPTANCE OF DOCUMENTS DOES NOT AUTHORIZE CONSTRUCTION TO PROCEED IN VIOLATION OF ANY FEDERAL, STATE, OR LOCAL REGULATIONS.
 BY: *[Signature]* DATE: 11/13/19
 WEST COAST CODE CONSULTANTS, INC.

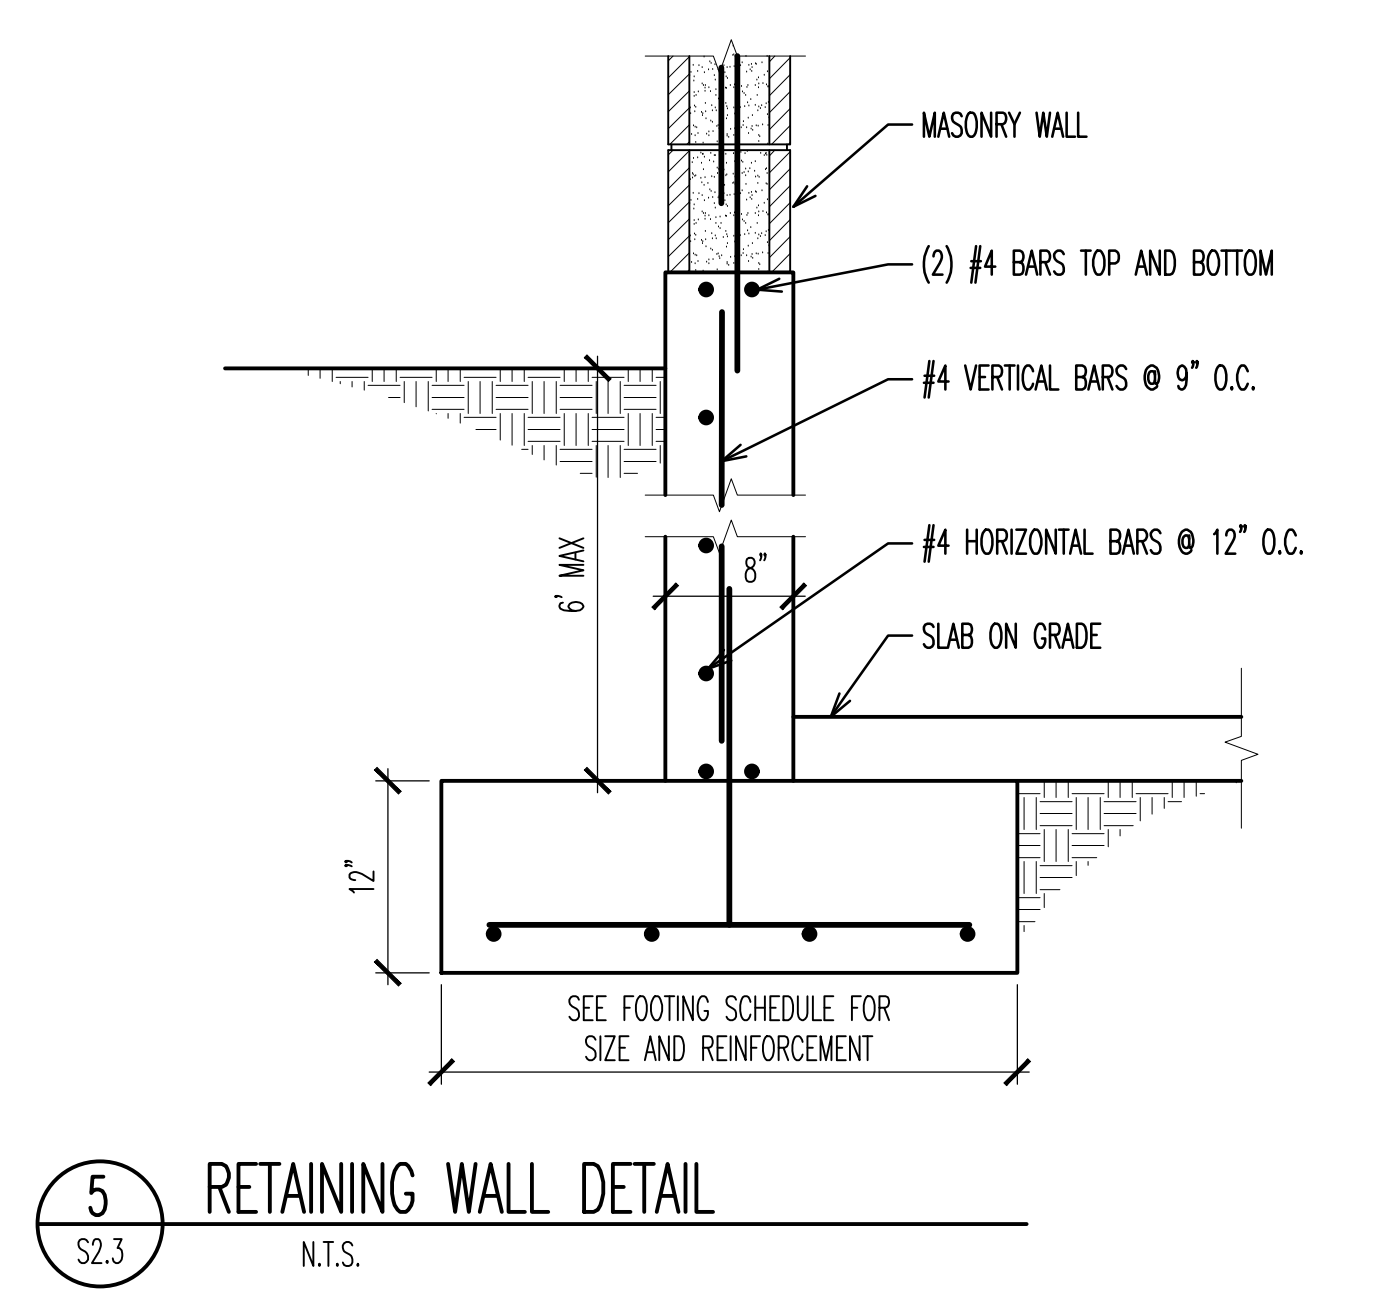


5 RETAINING WALL DETAIL
 S2.3 N.T.S.

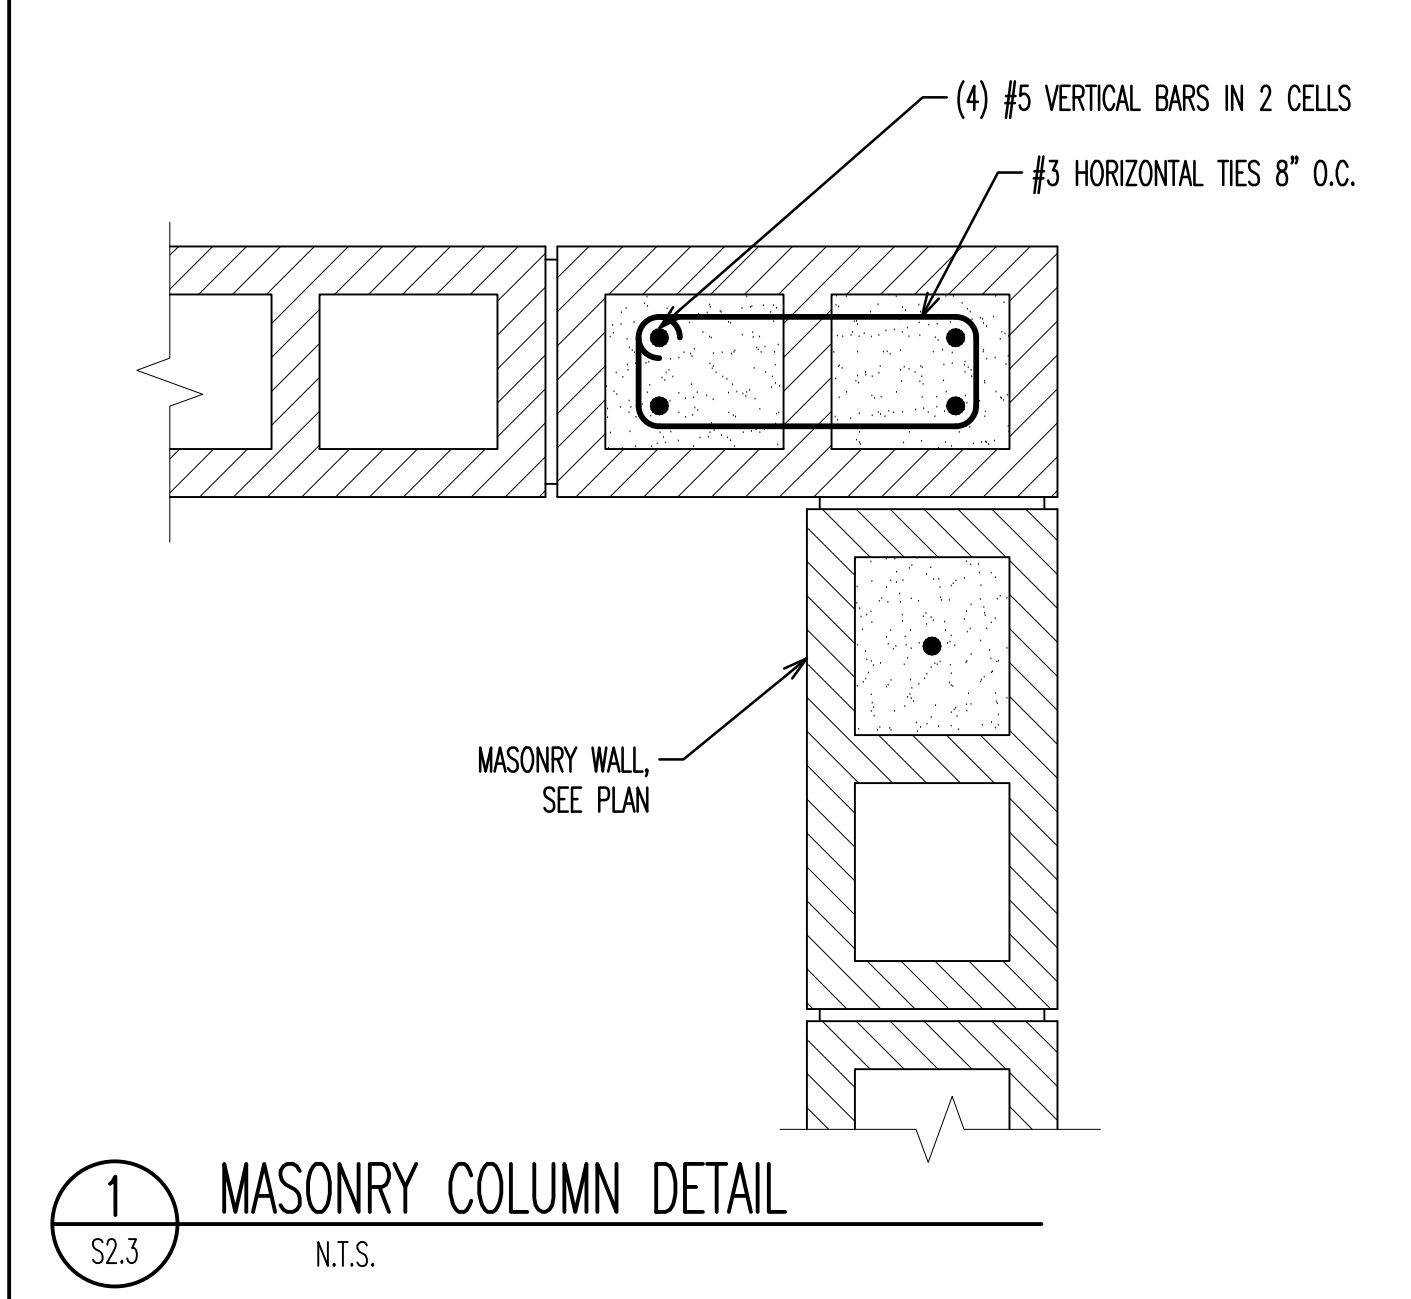


1 MASONRY COLUMN DETAIL
 S2.3 N.T.S.

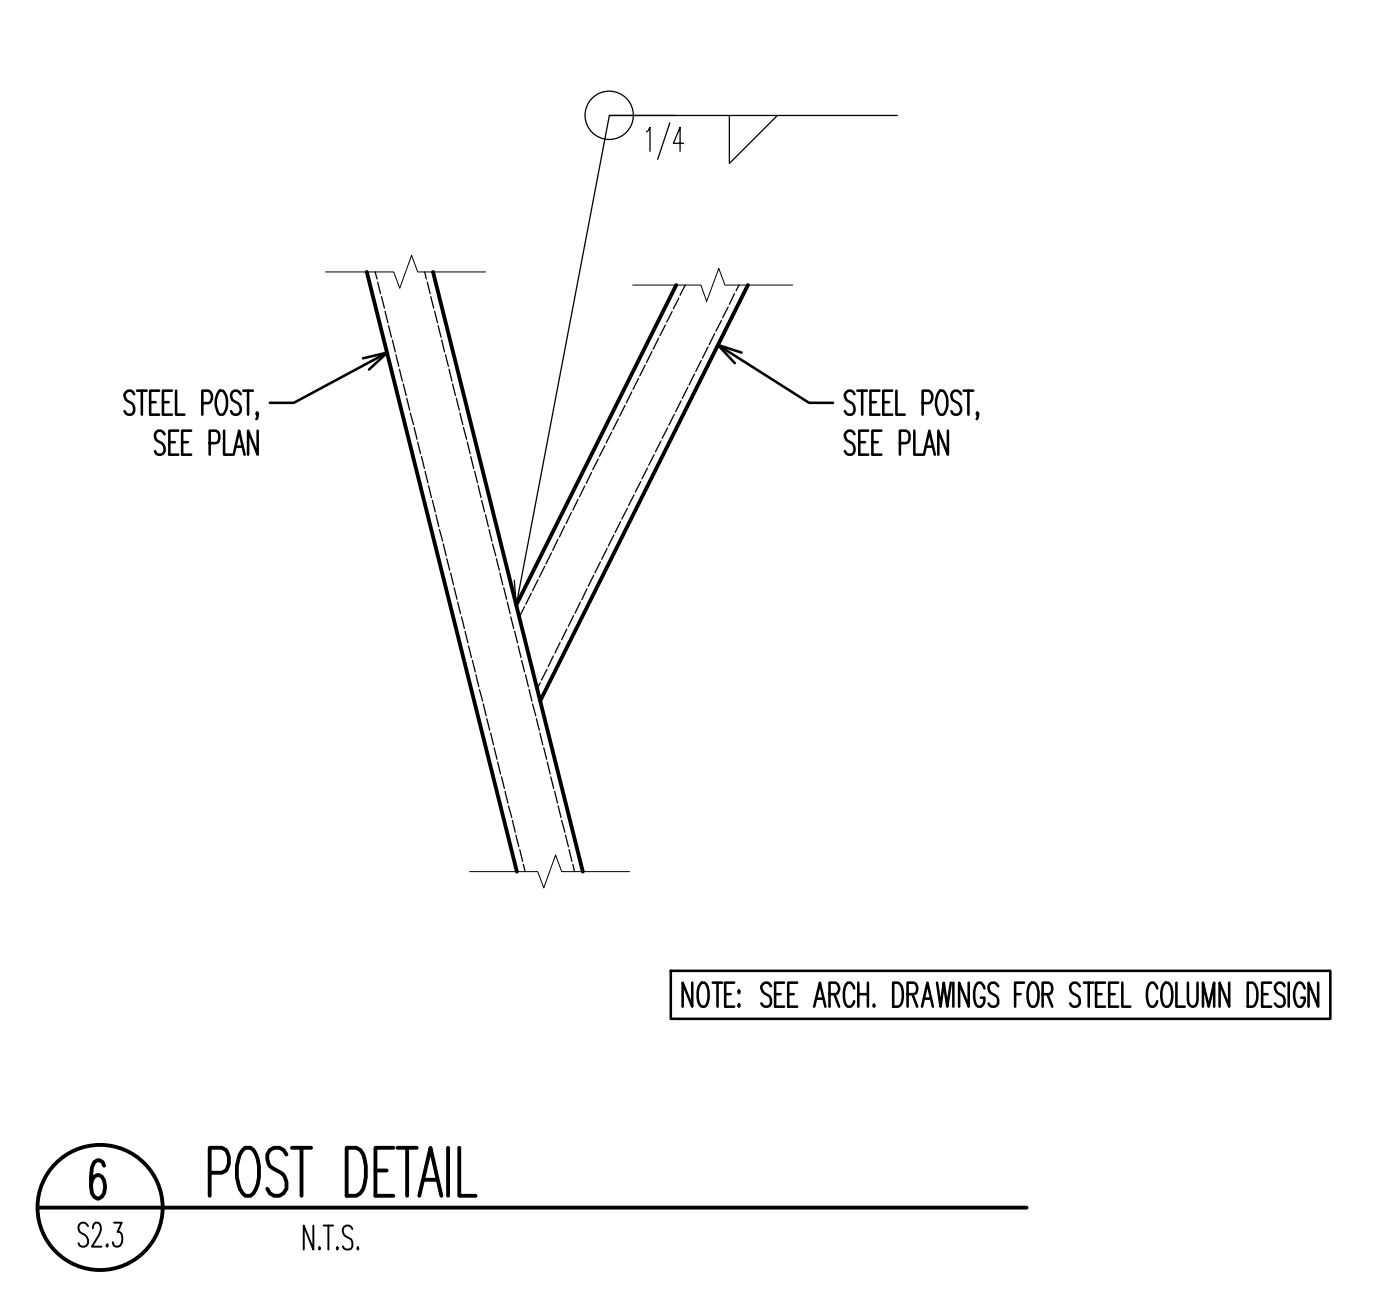


6 POST DETAIL
 S2.3 N.T.S.

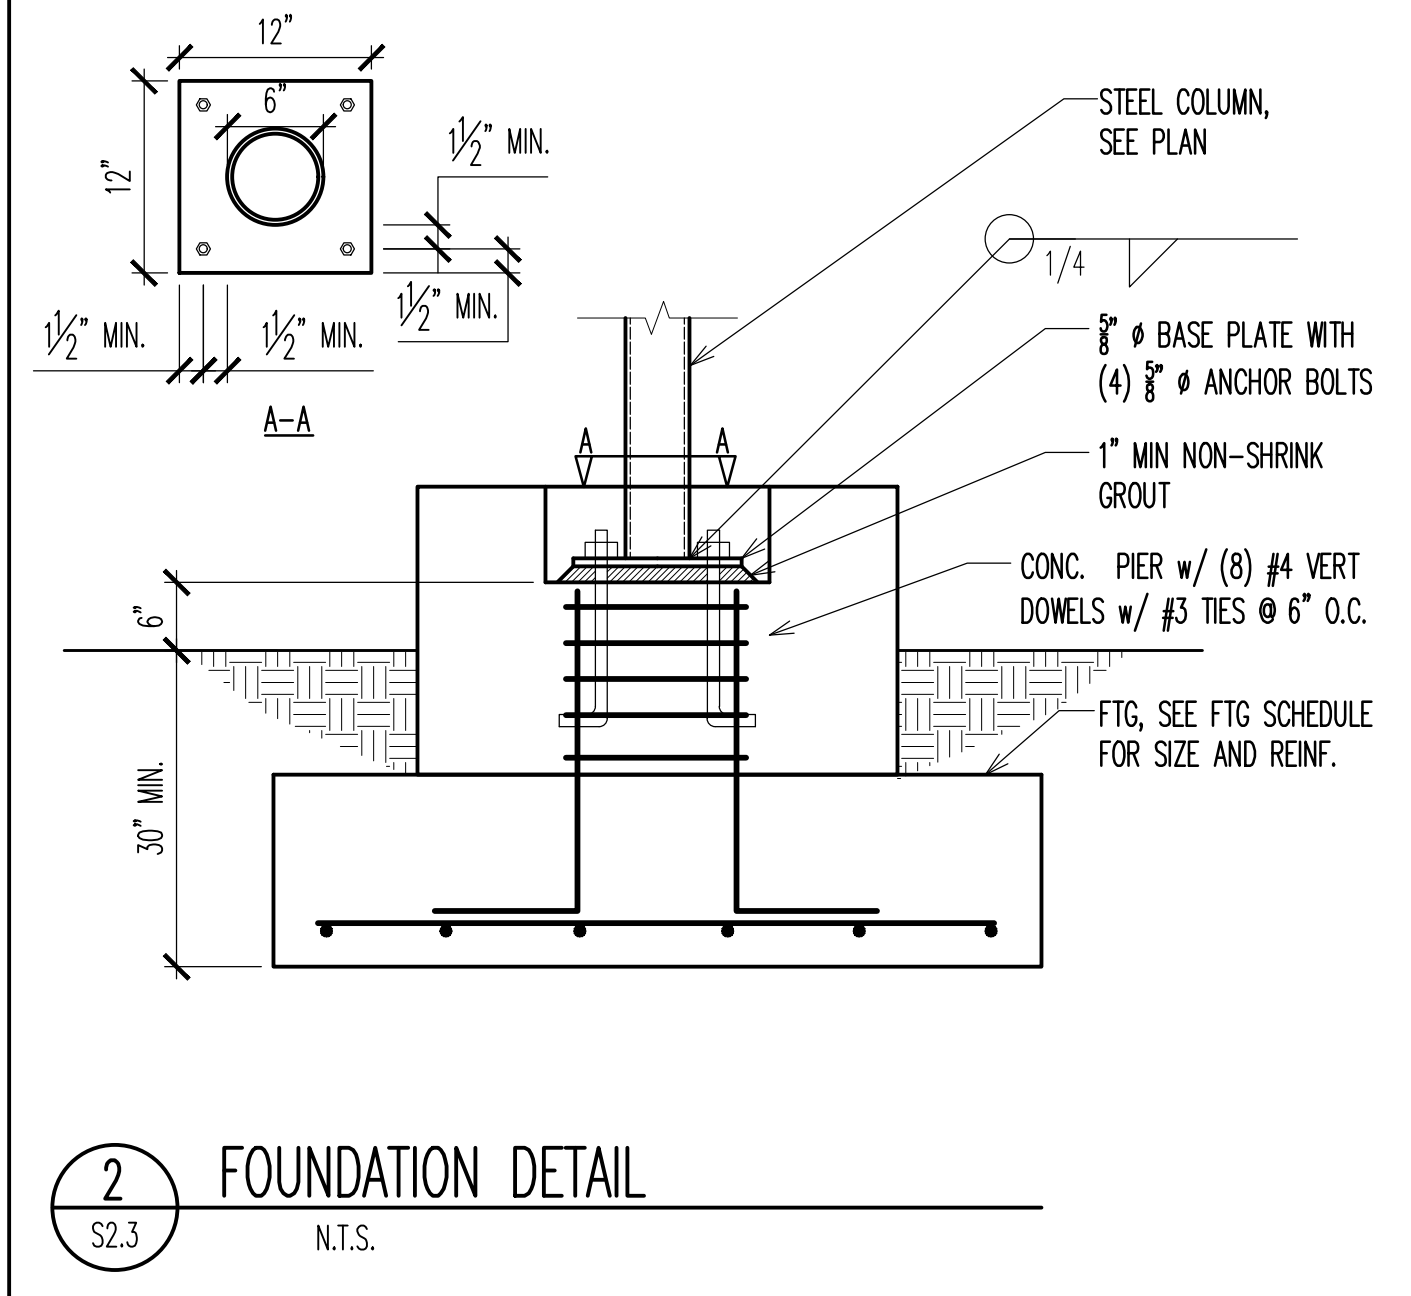

2 FOUNDATION DETAIL
 S2.3 N.T.S.

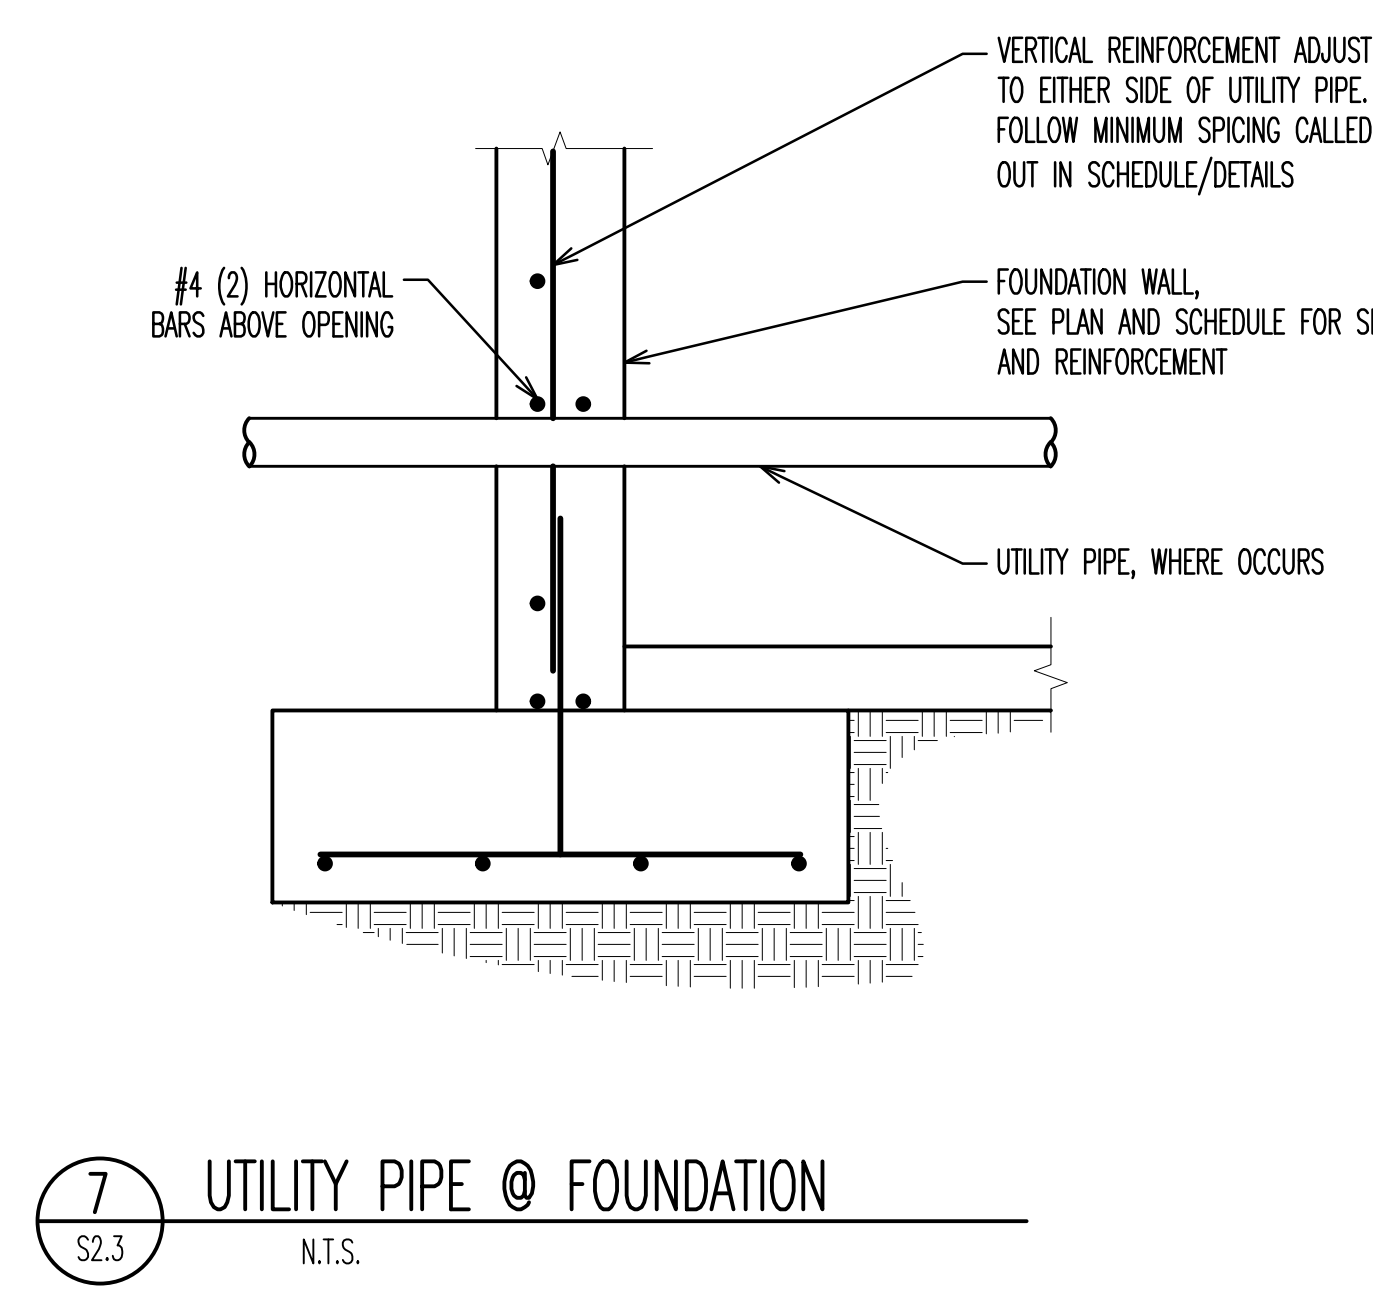

7 UTILITY PIPE @ FOUNDATION
 S2.3 N.T.S.

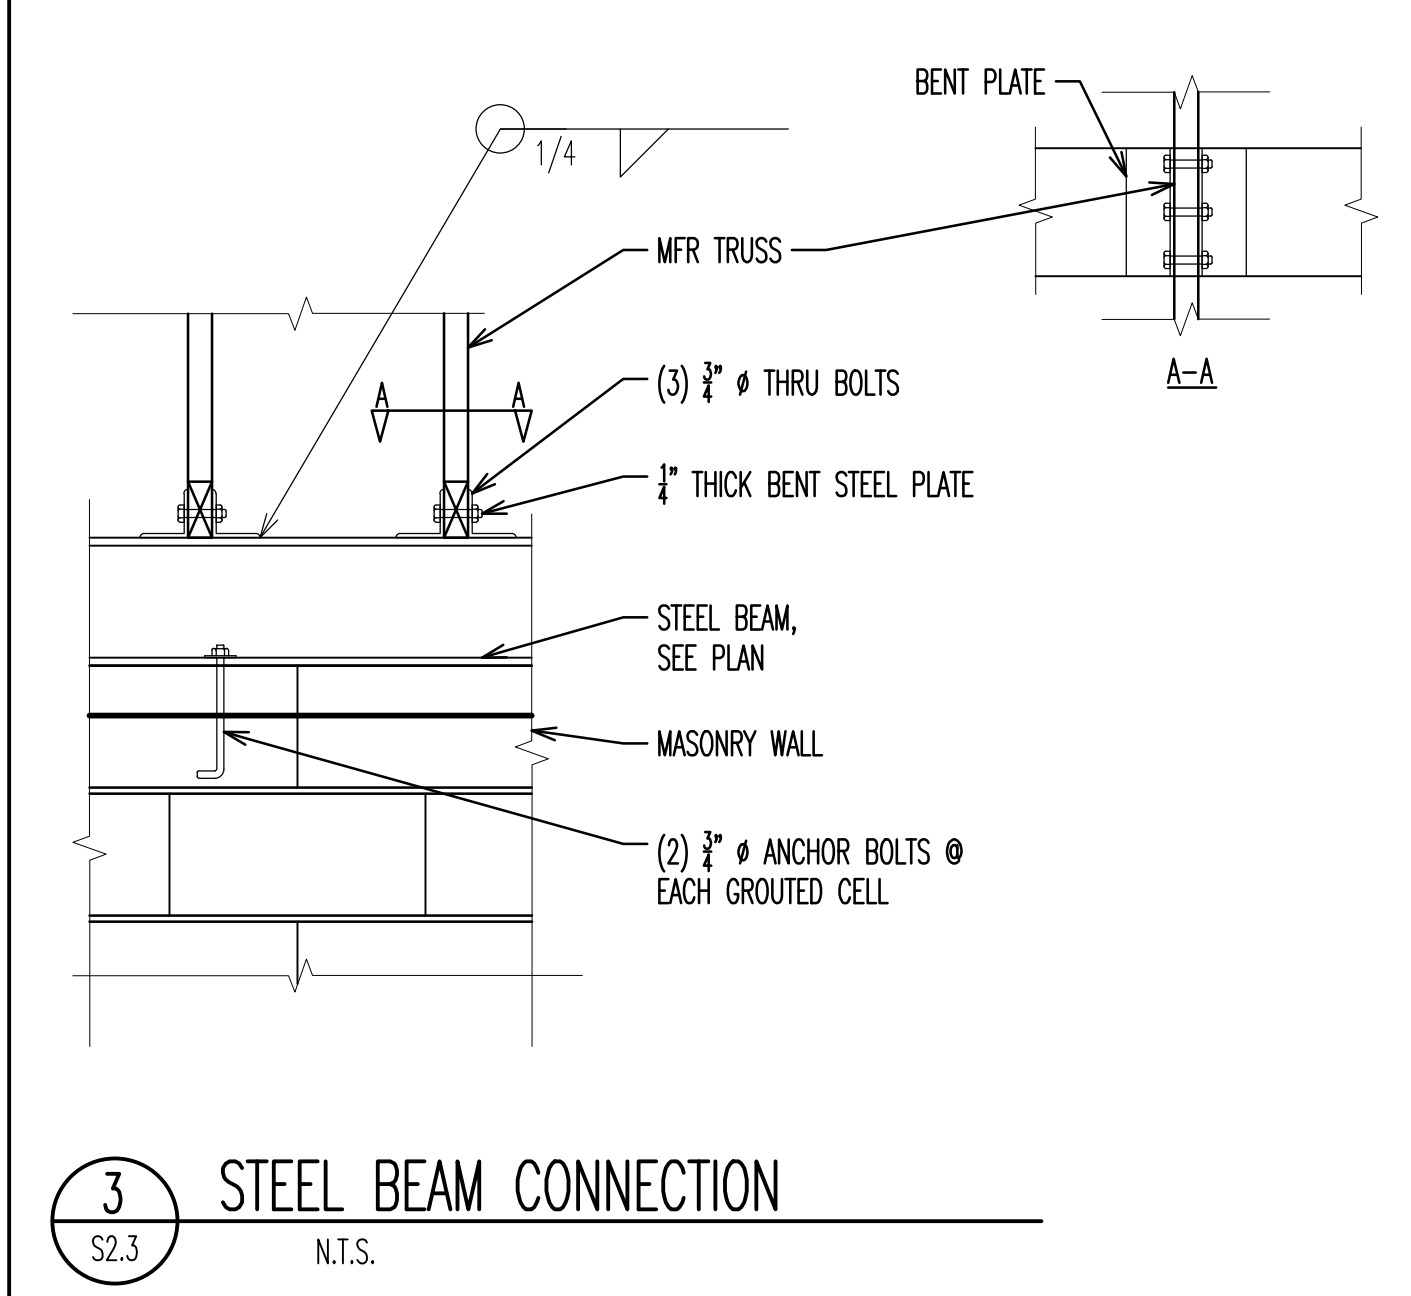

3 STEEL BEAM CONNECTION
 S2.3 N.T.S.



4 CURB DETAIL
 S2.3 N.T.S.

G.B.D
 G. BROWN DESIGN INC
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 610 East South Temple, Ste 50
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 SALT LAKE COUNTY
 PARKS & RECREATION
 CONSULTANTS:

MAGNA REGIONAL PARK
 PHASE ONE
 4042 SOUTH 7200 WEST
 MAGNA, UTAH 84044

REVISIONS:
 △ _____
 △ _____
 △ _____
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STAMP

SHEET TITLE
 RESTROOM BUILDING
 DETAILS

DATE: 7-22-19
 DRAWN BY: MP
 CHECKED BY: SP
 JOB NO.: 19038

SHEET NO:
 S2.3

CONSTRUCTION DOCUMENTS - CONFORMED SET