AMERICAN FORK FAMILY SERVICES

435 SOUTH 500 EAST - AMERICAN FORK, UT

OWNER:

DESCRIPTION

*ELECTRONIC BALLAST SEE SPEC.

LOW PROFILE WRAPAROUND FIXTURE WITH 0.125 ACRYLIC PRISMATIC LENSE

THE CHURCH OF JESUS CHRIST OF LATTER-DAY SAINTS TOM HOWELL, PROJECT MANAGER

AMERICAN FORK PROJECT MANAGEMENT OFFICE P.O. BOX 268 AMERICAN FORK, UT 84003

PH. # (801) 763-4520 FAX# (801) 763-4548

Lithonia

ARCHITECT:

RVA ARCHITECTS, INC. TRAVIS DANCE, PROJECT ARCHITECT

32 W. CENTER ST., SUITE 203 PROVO, UTAH 84601

PH. # (801) 374-2100

LAMP LAMP TEMP ELECTRICAL DATA

64W T8 3000 K 120 V/1-50 VA

CODE INFORMATION


2015 IBC, 2014 NEC EXISTING BUILDING

OCCUPANCY OF REMODEL AREA: B CONSTRUCTION TYPE: II-B FIRE PROTECTION: AUTOMATIC SPRINKLERS AREA OF REMODEL: 265 S.F.


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	ARCHITECTURAL
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A102	DETAILS, ALTERNATE BID

AMERICAN FORK
FAMILY SERVICES
SSOUTH 500 EAST - AMERICAN FORK, UT

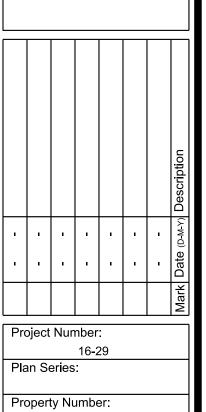

COVER SHEET

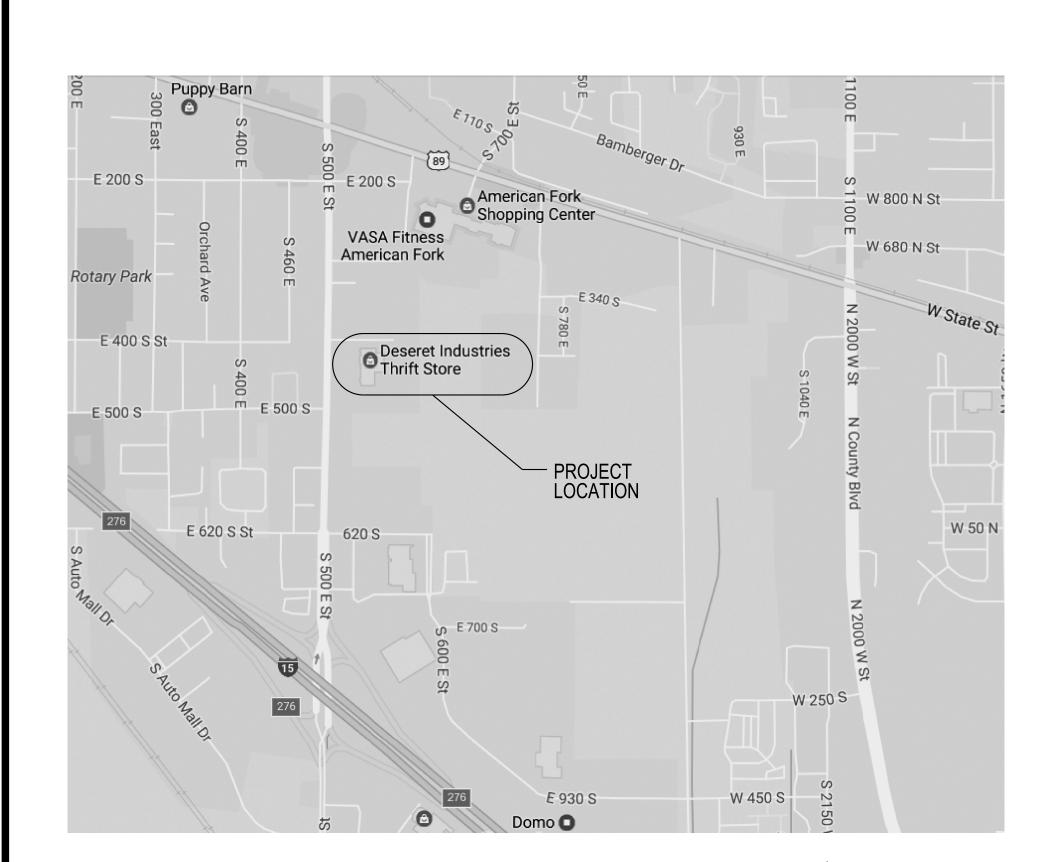

LIGHT FIXTURE SCHEDULE


OWN232-UNV-1/2EB WN232A-UNV-EB81*


WNA10-232-SSOL-UE

SB232-MVOLT-OS10IXSL


17-4-232-A-LDS-EBLH2*-AD-B-D-UNV

AMERICAN FORK VICINITY MAP

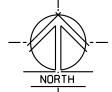

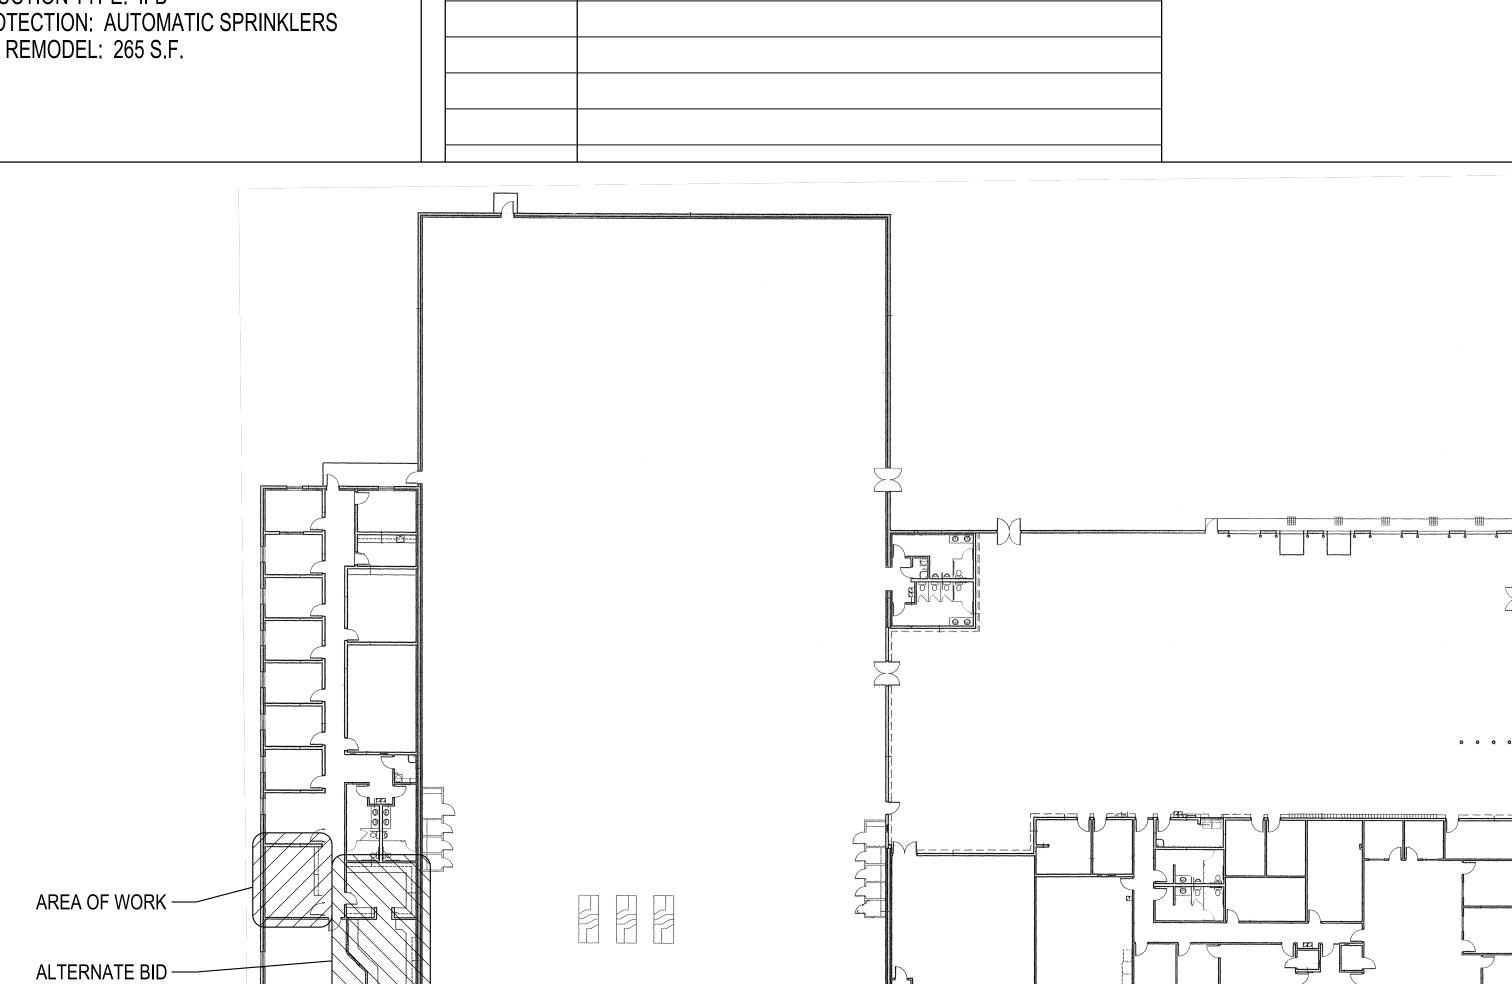


KEY PLAN

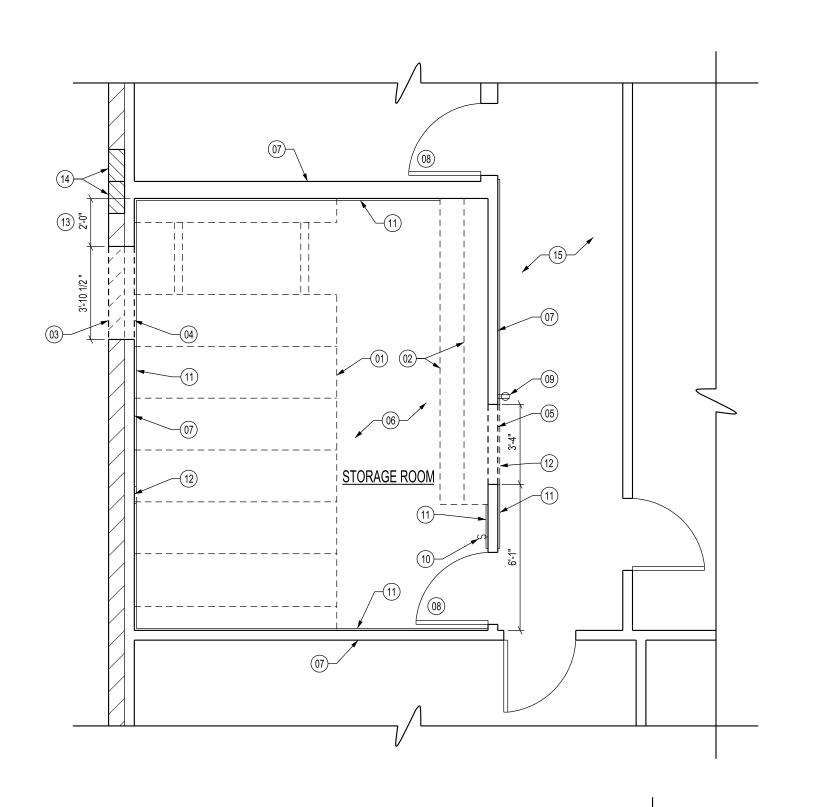

DEMOLITION FLOOR PLAN
SCALE: 1/4" = 1'-0"

KEYED NOTES:

- (01) REMOVE AND DISPOSE EXISTING OPERABLE STORAGE RACK SYSTEM, INCLUDING FLOOR TRACK.
- (02) REMOVE AND DISPOSE EXISTING OVERHEAD CABINET, BASE CABINET, AND COUNTER TOP.
- (03) SAWCUT OPENING IN EXISTING REINFORCED CMU WALL
- FOR NEW WINDOW. (04) REMOVE PORTION OF EXISTING METAL STUD WALL FURRING FOR NEW WINDOW.
- (05) REMOVE PORTION OF EXISTING METAL STUD WALL
- FOR NEW DOOR. (06) REMOVE AND DISPOSE EXISTING CARPET.
- (07) EXISTING WALL TO REMAIN.
- (08) EXISTING DOOR TO REMAIN.
- (09) EXISTING ELECTRICAL OUTLET TO REMAIN.
- (10) EXISTING LIGHT SWITCH TO REMAIN.
- (11) EXISTING CHAIR RAIL TO REMAIN. 12) REMOVE PORTION OF EXISTING CHAIR RAIL FOR NEW
- (13) APPROXIMATE DIMENSION. PERFORM SAWCUT AT
- NEAREST MORTAR JOINT.
- (14) EXISTING 16" WIDE MASONRY COLUMN WITH CONTROL JOINT BETWEEN TO REMAIN.
- (15) EXISTING CARPET TO REMAIN. PROTECT FROM DAMAGE.

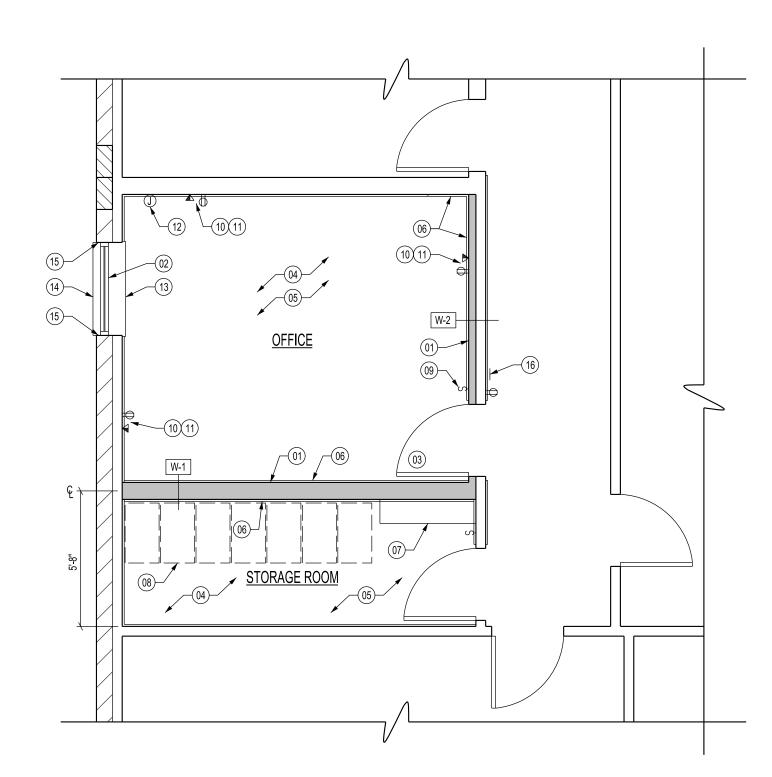

KEYED NOTES:

- (01) NEW WALL. SEE WALL TYPES ON SHEET A102.
- (02) NEW WINDOW TO MATCH EXISTING. SEE DETAIL A/A102. PROVIDE NEW VERTICAL BLINDS TO MATCH EXISTING.
- 03) NEW 3070 SOLID CORE WOOD DOOR AND HOLLOW METAL FRAME. SEE DETAIL 4/A102.
- (04) NEW CARPET & CARPET BASE.
- 05) PAINT WALLS.
- (06) NEW CHAIR RAIL TO MATCH EXISTING.
- (07) NEW 12" X 48" SHELVING. SEE DETAIL 3/A102.
- 08) FILE CABINETS (N.I.C.).
- (09) NEW OCCUPANCY SENSOR LIGHT SWITCH. MATCH EXISTING.
- (10) NEW ELECTRICAL OUTLET. CONNECT TO EXISTING CIRCUIT.
- (11) NEW VOICE/DATA OUTLET. CONNECT TO EXISTING SYSTEM.
- (12) JUNCTION BOX FOR PUSH BUTTON. MOUNT AT SWITCH HEIGHT. ROUTE 3/4" CONDUIT TO ACCESSIBLE CEILING SPACE.
- 13) NEW SOLID SURFACE WINDOW SILL TO MATCH EXISTING. (14) NEW PAINTED PRECAST WINDOW SILL TO MATCH EXISTING.
- (15) GROUT SOLID ANY EXPOSED CELLS AT SAWCUT OPENING. TOUCH UP EXTERIOR WALL PAINT AS NECESSARY.
- (16) INSTALL NEW OWNER-PROVIDED ROOM SIGN.

KEYED NOTES:

SHEET G101.

(01) NEW 12" X 12" GLUE-UP CEILING TILE OVER 5/8" TYPE X

SUSPENDED DRYWALL. CEILNG HEIGHT TO BE DETERMINED BY EXISTING FIRE SPRINKLERS (APPROXIMATELY 9'-0" A.F.F.).

SEE DETAIL 1/A102. INSTALL NEW BATT INSULATION ABOVE CEILING.


(02) INSTALL SALVAGED RECESSED LIGHT FIXTURE. CLEAN AND RELAMP.

03) NEW 1' X 4' SURFACE-MOUNT LIGHT FIXTURE. SEE SCHEDULE ON

(04) ADJUST EXISTING SUPPLY AND RETURN GRILLE AS NECESSARY

TO ACCOMMODATE NEW CEILING. CLEAN TO LIKE-NEW CONDITION.



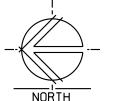


Project Number:

Property Number: 559-7609

05/05/17 SHEET TITLE:


DEMOLITION AND REMODEL FLOOR PLANS

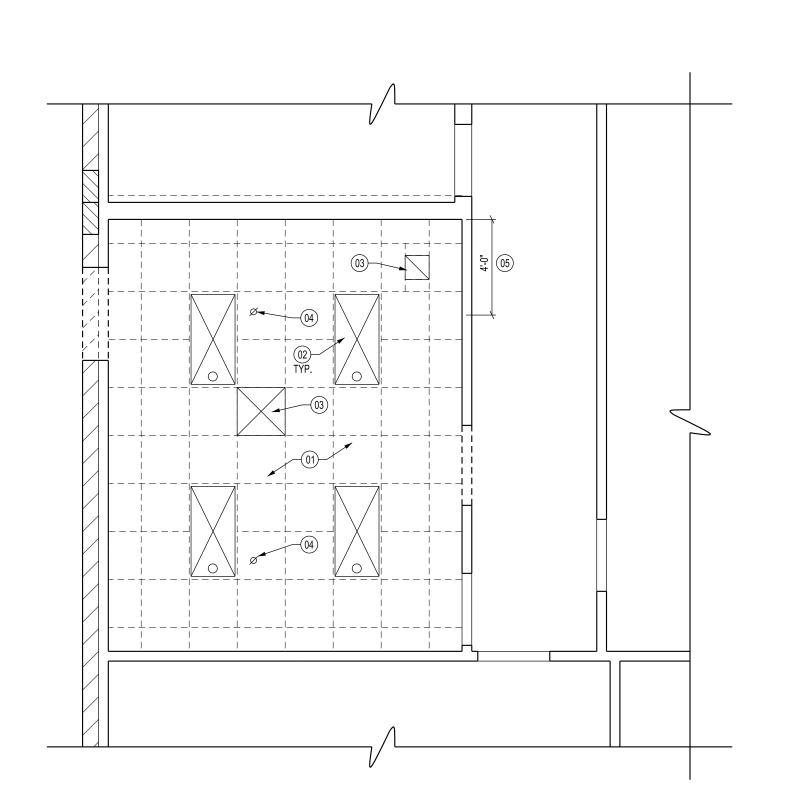

DEMOLITION CEILING PLAN

KEYED NOTES:

- (01) REMOVE AND DISPOSE EXISTING SUSPENDED ACOUSTIC TILE CEILING AND GRID.
- 02) REMOVE EXISTING RECESSED LIGHT FIXTURE. SALVAGE
- (03) EXISTING SUPPLY AND RETURN GRILLE TO REMAIN.
- (04) EXISTING FIRE SPRINKLER TO REMAIN.
- (05) REMOVE AND DISPOSE EXISTING BATT INSULATION ABOVE CEILING.

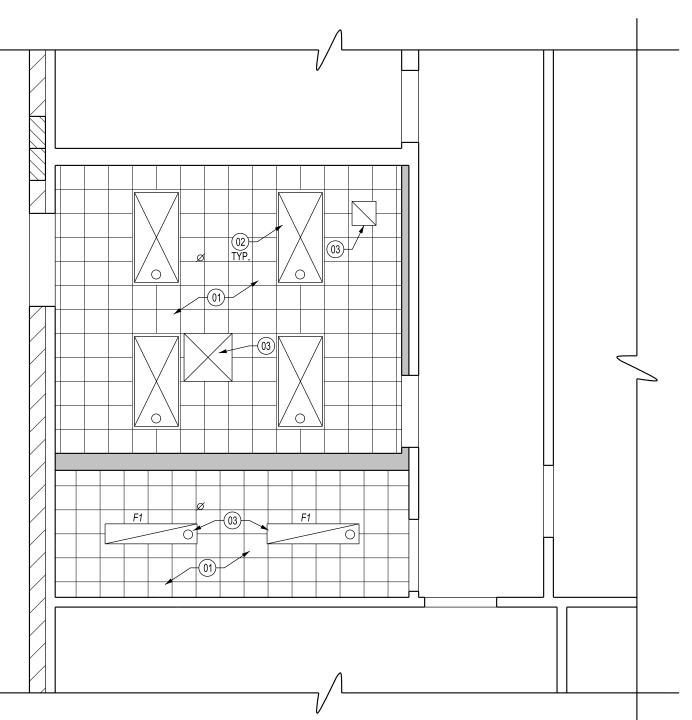

REMODEL CEILING PLAN

